PROJECT INFORMATION

OWNER: ADDRESS: ZONING: LEGAL DESCRIPTION: USE:

DESCRIPTION: TREE REMOVAL:

JOHN AND KELLY RAINEY LINCOLN 5 SW OF 10TH CARMEL-BY-THE-SEA, CA 93923 APN 010-082-004 SINGLE FAMILY RESIDENTIAL NEW TWO STORY RESIDENCE NO TREES TO BE REMOVED

PROJECT TEAM

DESIGNER: JOBE CORRAL ARCHITECTS ADA CORRAL, AIA 505 W. 38TH ST, STE B AUSTIN, TX 78705 512.499.1591

CONTRACTOR: STOCKER & ALLAIRE DAVID STOCKER 21 MANDEVILLE COURT MONTEREY, CA 93940 831.375.1890

LANDSCAPE ARCHITECT: JMLA JESSICA M. NEAFSEY 3345 7TH AVE CARMEL, CA 93923 734.904.9152

CIVIL ENGINEER: BENJAMINI, INC AVI BENJAMINI 720 YORK ST #114 SAN FRANCISCO. CA 94110 415.550.2600

STRUCTURAL ENGINEER: STRANDBERG ENGINEERING DAVID STRANDBERG 1511 15TH STREET SAN FRANCISCO, CA 94103 415.778.8726x101

ENERGY CONSULTANT: MONTEREY ENERGY GROUP, INC. ABE STALLCUP 26465 CARMEL RANCHO BLVD. SUITE CARMEL, CA 93923 831.372.8328

LIGHTING DESIGNER: STUDIO LUMINA CHRISTINA BROWN 9411 CHAPEL DOWN STREET AUSTIN, TX 78729 512.382.1656

GENERAL NOTES

1. ALL WORK TO CONFORM TO THE REQUIREMENTS OF THE APPLICABLE BUILDING CODES. 2. CONTRACTOR SHALL VERIFY ALL CONDITIONS AND DIMENSIONS AT THE JOB SITE BEFORE COM DESIGNER.

3. ALL SYMBOLS AND ABBREVIATIONS USED ON THE DRAWINGS ARE CONSIDERED TO BE CONST EXACT MEANING, THE ARCHITECT/DESIGNER SHALL BE NOTIFIED FOR CLARIFICATION.

4. STRUCTURAL, MECHANICAL AND/OR ELECTRICAL DRAWINGS ARE SUPPLEMENTARY TO THE AR CONTRACTOR TO CHECK WITH THE ARCHITECTURAL DRAWINGS BEFORE THE INSTALLATION OF DISCREPANCY BETWEEN THE ARCHITECTURAL DRAWINGS AND THE CONSULTING ENGINEERS' D BROUGHT TO THE ARCHITECT/DESIGNER'S ATTENTION FOR CLARIFICATION PRIOR TO THE INSTAIL ARCHITECTURAL DRAWINGS SHALL BE CORRECTED BY THE CONTRACTOR AT HIS/HER EXPENSE

5. STRUCTURAL DRAWINGS GOVERN SIZES, SPACING AND CONNECTIONS OF ALL STRUCTURAL ARCHITECT/DESIGNER BEFORE COMMENCEMENT OF WORK.

6. FINAL LOCATIONS OF ALL MECHANICAL AND ELECTRICAL EQUIPMENT PANEL BOARDS, METERS PRIOR TO INSTALLATION. 7. DO NO SCALE DRAWINGS. WRITTEN DIMENSIONS SHALL ALWAYS TAKE PRECEDENCE OVER SC

STUD WALL UNLESS OTHERWISE NOTED OR INDICATED.

8. EXAMINATION OF THE SITE AND PORTIONS THEREOF WHICH WILL AFFECT THIS WORK SHALL SATISFY HIMSELF/HERSELF AS TO CONDITIONS UNDER WHICH WORK IS TO BE PERFORMED. TH EXISTING STRUCTURES OR EQUIPMENT WHICH MAY AFFECT THE WORK. NO ALLOWANCE SHAL SHE MAY BE PUT INTO DUE TO FAILURE OR NEGLECT ON HIS/HER PART TO MAKE SUCH AN EXAM ARCHITECT/DESIGNER PRIOR TO COMMENCEMENT OF CONSTRUCTION. NO EXTRA CHARGE OR MEASUREMENT AND DIMENSIONS INDICATED ON THE DRAWINGS.

9. THE CONTRACTOR IS CAUTIONED THAT THE WORK INCLUDES ALTERATION TO EXISTING FACILI COMPLETELY OPERABLE INSTALLATION WITHIN THE SCOPE OF WORK, BUT WHICH IS NOT SPECIF INCLUDED ON HIS/HER WORK AT NO ADDITIONAL COST TO THE OWNER.

10. ITEMS OF WORK INDICATED ON THE DRAWINGS AS N.I.C. (NOT IN CONTRACT) SHALL BE PERFO CONTRACTOR SHALL COORDINATE HIS/HER WORK ACCORDINGLY AS REQUIRED FOR A SMOOTH 11. IT SHALL BE CONSTRUED THAT EACH SUBCONTRACT IS AN INTEGRAL PART OF THE GENERAL OPERATION AT ALL TIMES DURING THE PERFORMANCE OF THE CONTRACT A SUFFICIENT CREW C

12. THE CONTRACTOR SHALL ARRANGE FOR THE PREMISES TO BE MAINTAINED IN AN ORDERLY CLEANLINESS THROUGHOUT AND CONTROL ANY DUST CAUSED BY THE WORK, AS WELL AS, PRO TO PROTECT THE PUBLIC DURING THE PERIOD OF CONSTRUCTION.

13. THE CONTRACTOR SHALL BE RESPONSIBLE FOR REMOVING ALL LEFTOVER MATERIALS, DEBF CONCLUSION OF THE INSTALLATION. ALL FIXTURES AND REUSABLE MATERIALS TO BE REMOVED 14. THE CONTRACTOR SHALL PROVIDE ALL INSURANCE PRIOR TO COMMENCEMENT OF ANY WOR

INDEMNIFY THE ARCHITECTS/DESIGNERS AND THE OWNERS FROM ALL CLAIMS WHICH ARISE FR

DEMOLITION NOTES

DISPATCH

1. ALL PREPARATION, DEMOLITION, REMOVAL AND DISPOSAL IS TO BE PERFORMED IN ACCORDANCE AUTHORITIES HAVING JURISDICTION.

2. ALL WORK SHALL BE PERFORMED IN ACCORDANCE WITH THE BEST SAFETY PRACTICES. USE EXISTING UTILITY SERVICES (ELECTRICAL, PLUMBING, GAS, ETC.) TO BE DONE BY LICENSED TRAD EXERCISED FOR ALL WORK RELATED TO THIS CONTRACT TO PREVENT PERSONAL INJURIES, DAM/

3. DEMOLITION PLAN IS TO BE USED IN CONJUNCTION WITH ALL ARCHITECTURAL AND ENGINEER'S 4. THE CONTRACTOR SHALL CAREFULLY INSPECT ALL EXISTING CONDITIONS PRIOR TO BIDDING A CONSTRUCTION. THE PLAN IS TO DESIGNATE THE GENERAL SCOPE OF REMOVALS.

5. THE CONTRACTOR SHALL ISOLATE WORK AREAS, SO AS TO PROVIDE A DUST-FREE ENVIRONME VICINITY OF WORK ARE TO BE PROPERLY PROTECTED PRIOR TO THE COMMENCEMENT OF ANY W THROUGHOUT COURSE OF WORK, AND REMOVE AND DISPOSE OF THESE UPON COMPLETION OF I AND BROOM SWEPT. ANY DAMAGE RESULTING FROM CONTRACTOR'S IMPROPER PROTECTION OF REPAIRED OR REPLACED (AS REQUIRED) BY THE CONTRACTOR AT NO EXPENSE TO THE OWNER.

6. ALL DEBRIS RESULTING FROM THE OPERATION UNDER THIS CONTRACT SHALL BE IMMEDIATELY ACCUMULATE ON THE SITE.

7. THROUGHOUT THE COURSE OF DEMOLITION AND CONSTRUCTION, ALL AREAS OF NEW CONSTR DEBRIS, UNUSED EQUIPMENT, DISCARDED MATERIALS, AND GARBAGE.

8. REPAIR ALL SURFACES AT POINTS OF REMOVAL, DEMOLITION OR NEW CONSTRUCTION, INCLUD MATCH THE EXISTING FINISH TO THE SATISFACTION OF THE ARCHITECT/DESIGNER. THE CONTRACT



RAINEY RESIDENCE

ABBREVIATIONS

OMMENCING WORK AND REPORT ANY DISCREPANCIES TO THE ARCHITECT/
TRUCTION STANDARDS. IF THE CONTRACTOR HAS QUESTIONS REGARDING THEIR
ARCHITECTURAL DRAWINGS. IT SHALL BE THE RESPONSIBILITY OF THE F STRUCTURAL, MECHANICAL AND ELECTRICAL WORK. SHOULD THERE BE A DRAWINGS THAT WOULD CAUSE AN AWKWARD INSTALLATION, IT SHOULD BE ALLATION OF SAID WORK. ANY WORK INSTALLED IN CONFLICT WITH THE E AND AT NO ADDITIONAL EXPENSE TO THE OWNER OR ARCHITECT/DESIGNER.
MATERIALS AND MEMBERS. IN CASE OF DISCREPANCIES, CONSULT WITH THE
RS, FIXTURES, FLUES, VENTS, ETC., SHALL BE APPROVED BY ARCHITECT/DESIGNER
SCALED DIMENSIONS. DIMENSIONS SHOWN ON FLOOR PLANS ARE TO FACE OF
BE MADE BY THE CONTRACTOR WHO SHALL COMPARE IT WITH THE DRAWINGS AND HE CONTRACTOR SHALL, AT SUCH TIME, ASCERTAIN AND CHECK LOCATION OF LL SUBSEQUENTLY BE MADE IN HIS/HER BEHALF FOR ANY EXPENSE TO WHICH HE/ MINATION. ANY CONFLICTS OR OMISSIONS, ETC., SHOULD BE REPORTED TO THE R COMPENSATION WILL BE ALLOWED DUE TO VARIATION BETWEEN ACTUAL
ILITIES. WORK WHICH IS OBVIOUSLY REQUIRED TO BE PERFORMED TO PROVIDE A CIFICALLY INCLUDED ON THE PLANS, SHALL BE PERFORMED BY HIM /HER AND
RFORMED, FURNISHED, OR LED UNDER SEPARATE CONTRACT BY THE OWNER. THE H WORK SCHEDULE.
AL CONTRACT AND THE CONTRACTOR SHALL PROVIDE AND MAINTAIN IN FULL / OF LABORERS, MECHANICS AND FOREMAN TO PROSECUTE THE WORK WITH
/ MANNER THROUGHOUT THE COURSE OF THE JOB. HE/SHE SHALL MAINTAIN OVIDE AND MAINTAIN TEMPORARY BARRICADES, CLOSE WALLS, ETC., AS REQUIRED
BRIS, TOOLS AND EQUIPMENT INVOLVED IN HIS/HER OPERATIONS AT THE ED ARE TO BE STORED OR DISPOSED OF AS PER OWNER INSTRUCTIONS.
ORK, AS REQUIRED BY OWNER AND ALL INSURANCE TO CLEARLY AND COMPLETELY ROM THE PERFORMANCE OF ALL WORK RELATED TO THIS CONTRACT.
NCE WITH REQUIREMENTS OF THE APPLICABLE BUILDING CODES AND THE
ONLY LABORERS EXPERIENCED IN THIS WORK. ALL REMOVALS AND CAPPING OF ADESMAN. THE HIGHEST DEGREE OF CARE AND PRECAUTION SHALL BE MAGES TO PROPERTY AND DAMAGES TO EXISTING ACTIVE UTILITY SERVICES.
R'S DRAWINGS. ALL WORK IS TO BE COORDINATED WITH THE RESPECTIVE TRADES.
AND INCLUDE ALL REMOVALS AS NECESSARY TO ACCOMPLISH THE NEW
IENT IN OCCUPIED AREAS. ALL FURNITURE AND FIXTURES IN THE IMMEDIATE WORK. CONTRACTOR TO PROVIDE AND MAINTAIN NECESSARY COVERINGS F EACH PHASE OF CONSTRUCTION, WHEREIN THE SITE SHALL BE LEFT ORDERLY OF EXISTING OR NEW CONSTRUCTION, FIXTURES OR FURNITURE IS TO BE
LY REMOVED FROM THE SITE AND SHALL NOT BE STORED OR PERMITTED TO
TRUCTION, AS WELL AS THE PATH OF ACCESS, SHALL BE KEPT CLEAN AND FREE OF
IDING FLOORING, BASE, PAINT, ETC. WHERE IT IS POSSIBLE CONTRACTOR SHALL ACTOR SHALL PROVIDE NEW FINISHES IN DESIGNATED AREAS.

9. ALL MEASUREMENTS ARE TO BE VERIFIED IN FIELD AND ANY DISCREPANCIES THEREOF BROUGHT TO THE ATTENTION OF THE ARCHITECT/DESIGNER.

@	AT	LIN
ABV	ABOVE	LIN L.P.
A/C		LT
ADJ ADDN	ADJUSTABLE ADDITIONAL	MAS
A.F.F.	ABOVE FINISH FLOOR	MATL
A.H.U. ALUM	AIR HANDLING UNIT ALUMINUM	MAX MECH
APPROX	APPROXIMATE	MFR
ARCH	ARCHITECT OR ARCHITECTURAL	MIN MIR
BD	BOARD	MISC
B.L.	BUILDING LINE	MTD
BLDG BLK	BUILDING BLOCK	MTL
BLKG	BLOCKING	(N)
BLW BM	BELOW BEAM	N N.I.C.
В.О.	BOTTOM OF	NOM
BRG BTM	BEARING BOTTOM	NO/# N.T.S.
BTWN	BETWEEN	N.1.0.
B.U.R.	BUILT UP ROOF	0.C. 0.E.
CAB	CABINET	0.H.
CANT	CANTILEVER	OPER
C.J. C.L.	CONTROL JOINT CENTER LINE	OPNG OPP
CLG	CEILING	OPP. H.
CLR C.M.U.	CLEAR CONCRETE MASONRY UNIT	PERF
COL	COLUMN	PL
COND CONC	CONDITION CONCRETE	P.LAM. PLBG
CONST	CONSTRUCTION	PLYWD
CONTR	CONTRACTOR	PNLG
COORD C.R.Z.	COORDINATE CRITICAL ROOT ZONE	PNT POL
CTR	CENTER	P.P.
D	DRYER	PROJ PROP
DBL	DOUBLE	PROT
DIA DIAG	DIAMETER DIAGONAL	P.T. PTD
D.L.	DIMENSION LINE	TID
DIM DISP	DIMENSION DISPENSER	QTY
DISP	DOWN	R
DS	DOWNSPOUT	R.C.P.
DTL D.W.	DETAIL DISH WASHER	RE: REC
DWG	DRAWING	REF
(E)	EXISTING	REINF REQ'D
ÉÁ	EACH	REQMT
E.J. ELEC	EXPANSION JOINT ELECTRICAL	RESIL RET
ELEV	ELEVATION	REV
ENCL	ENCLOSURE	RM
EQ EQUIP	EQUAL EQUIPMENT	R.O.
EXH	EXHAUST FAN	S
EXIST EXP	EXISTING EXPANSION	SC SCHED
EXT.	EXTERIOR	S.D.
F.F.	FINISH FLOOR	SECT S.F.
FIN	FINISH	SHTG
FIXT FLR	FIXTURE FLOOR	SHWR SIM
FLR FLUOR	FLOOR FLUORESCENT	SPEC
F.O.C.	FACE OF CONCRETE	S.S.
F.O.F. F.O.M.	FACE OF FINISH FACE OF MASONRY	STD STL
F.O.S.	FACE OF STUD	STN
FRZ FT	FREEZER FOOT OR FEET	STRUC SYM
FTG	FOOTING	SYS
FURR	FURRING	тнк
GA	GAUGE	THLD
GALV G.C.	GALVANIZED	TL
G.C. GEN	GENERAL CONTRACTOR GENERAL	T.O. T.O.C.
GL	GLASS OR GLAZED	T.O.S.
GYP/GWB	GYPSUM WALL BOARD	T.O.W. T.P.
H.B.	HOSE BIB	TR
HDWD HDWR	HARDWOOD HARDWARE	TYP
HORIZ	HORIZONTAL	U/C
H.P. H.R.	HIGH POINT HAND RAIL	U/CAB U.O.N.
н.к. HT	HEIGHT	0.0.N.
H.V.A.C.	HEATING, VENTING, AIR COND.	VEN
INCL	INCLUDE	VERT VEST
INFO	INFORMATION	V.I.F.
INSUL INT	INSULATE OR INSULATION INTERIOR	W
		W/
JT	JOINT	W.C. WD
KIT	KITCHEN	WDW
LAV	LAVATORY	W.H. W/O
LAV L.F.	LINEAR FEET	WP

LINEAR LOW POINT		0
LIGHT		
MASONRY MATERIAL MAXIMUM MECHANICAL MANUFACTUR(ER) MINIMUM MIRROR MISCELLANEOUS		
MOUNTED METAL NEW	SHEET #	TITLE
NORTH NOT IN CONTRACT	ARCHI	FECTURAL
NOMINAL	A0.00	TITLE PAC
NUMBER NOT TO SCALE	A1.00	SITE PLAN
ON CENTER	A1.01	EXISTING
OVERHEAD ELECTRICAL	D1.01	SITE DEM
OVERHEAD OPERABLE	A2.10	FLOOR PL
OPENING	A2.11	FLOOR PL
OPPOSITE OPPOSITE HAND	A2.12	ROOF PLA
	A2.13	AREA CAL
PERFORATED PLATE	A3.00	EXISTING
PLASTIC LAMINATE	A3.01	EXISTING
PLUMBING PLYWOOD	A3.10	EXTERIO
PANELING PAINT	A3.11	EXTERIO
POLISHED	A3.12	STREETS
POWER POLE PROJECT	A6.00	WINDOW
PROPERTY	A6.01	WINDOW
PROTECTION PRESSURE TREATED	A7.01	ARCHITE
PAINTED	A8.00	FRONT FE
QUANTITY	A9.00	MATERIAL
RADIUS	L1.0	SCAPE
REFLECTED CEILING PLAN	L2.0	LANDSCA
REFER RECESSED	L3.0	SITE PLAN
REFRIGERATOR REINFORCEMENT	L4.0	PLANTING
REQUIRED	L4.1	PLANTING
REQUIREMENT RESILIENT	L5.0	LANDSCA
RETAINING	CIVIL	ENGINEER
REVISION ROOM	C0.1	PROJECT
ROUGH OPENING	C1.0	GRADING
SOUTH	C1.1	LOWER LI
SCALE SCHEDULE	C2.0	SECTIONS
SMOKE DETECTOR	C3.0	EROSION
SECTION SQUARE FEET	C3.1	GRADING
SHEATHING SHOWER	03.1	EROSION
SIMILAR SPECIFICATIONS STAINLESS STEEL STANDARD STEEL STONE STRUCTURAL SYMMETRICAL SYSTEM		
THICK THRESHOLD TILE TOP OF TOP OF CONCRETE TOP OF SLAB TOP OF WALL TOILET PAPER TREAD TYPICAL		
UNDER COUNTER UNDER CABINET UNLESS OTHERWISE NOTED		



VENEER

WEST WITH

VERTICAL

VESTIBULE

VERIFY IN FIELD

WATER CLOSET WOOD WINDOW WATER HEATER WITHOUT

WATERPROOF

CONCEPT PROJECT REVIEW 01.29.2021

DRAWING INDEX

NEW	O NO CHANGE O REVISED	\otimes delete
SHEET #	TITLE	CONCEPT PROJECT REVIEW 01.29.2021
ARCHI	TECTURAL	
A0.00	TITLE PAGE & GENERAL NOTES	
A1.00	SITE PLAN	
A1.01	EXISTING SITE PLAN	•
D1.01	SITE DEMOLITION PLAN	Ó
A2.10	FLOOR PLAN MAIN LEVEL	
A2.11	FLOOR PLAN LOWER LEVEL	
A2.12	ROOF PLAN	
A2.13	AREA CALCULATIONS	
A3.00	EXISTING EXTERIOR ELEVATIONS	
A3.01	EXISTING EXTERIOR ELEVATIONS	
A3.10	EXTERIOR ELEVATIONS	
A3.11	EXTERIOR ELEVATIONS	
A3.12	STREETSCAPE ELEVATION	
A6.00	WINDOW SCHEDULE	
A6.01	WINDOW & DOOR SCHEDULE	
A7.01	ARCHITECTURAL EXTERIOR LIGHTING PLAN	
A8.00	FRONT FENCE ELEVATIONS	
A9.00	MATERIAL DETAILS	
LAND	SCAPE	
L1.0	TREE PROTECTION PLAN	
L2.0	LANDSCAPE MATERIALS	
L3.0	SITE PLAN	
L4.0	PLANTING PLAN	
L4.1	PLANTING LIST + NOTES	
L5.0	LANDSCAPE LIGHTING PLAN	
CIVIL	ENGINEER	
C0.1	PROJECT INFORMATION & NOTES	
C1.0	GRADING & DRAINAGE PLAN	
C1.1		
C2.0	SECTIONS & DETAILS	
C3.0	EROSION AND SEDIMENT CONTROL (1 OF 2)/ GRADING AND OPERATION PLAN	





RAINEY RESIDENCE

ADA CORRAL, AIA 505 W. 38TH ST, STE B AUSTIN, TX 78705 512.499.1591 CONTRACTOR:

DESIGNER:

NOTES:

STOCKER & ALLAIRE DAVID STOCKER 21 MANDEVILLE COURT MONTEREY, CA 93940 831.375.1890

STRUCTURAL ENGINEER: ENERGY CONSULTANT: JOBE CORRAL ARCHITECTS STRANDBERG ENGINEERING DAVID STRANDBERG 1511 15TH STREET SAN FRANCISCO, CA 94103 415.778.8726x101

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LEGEND

CONCEPT PROJECT REVIEW

PROJECT

1914

SCALE

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TITLE PAGE &

GENERAL NOTES

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RAINEY RESIDENCE

JOHN AND KELLY RAINE LINCOLN 5 SW OF 10TH

CARMEL-BY-THE-SEA, CA 93923

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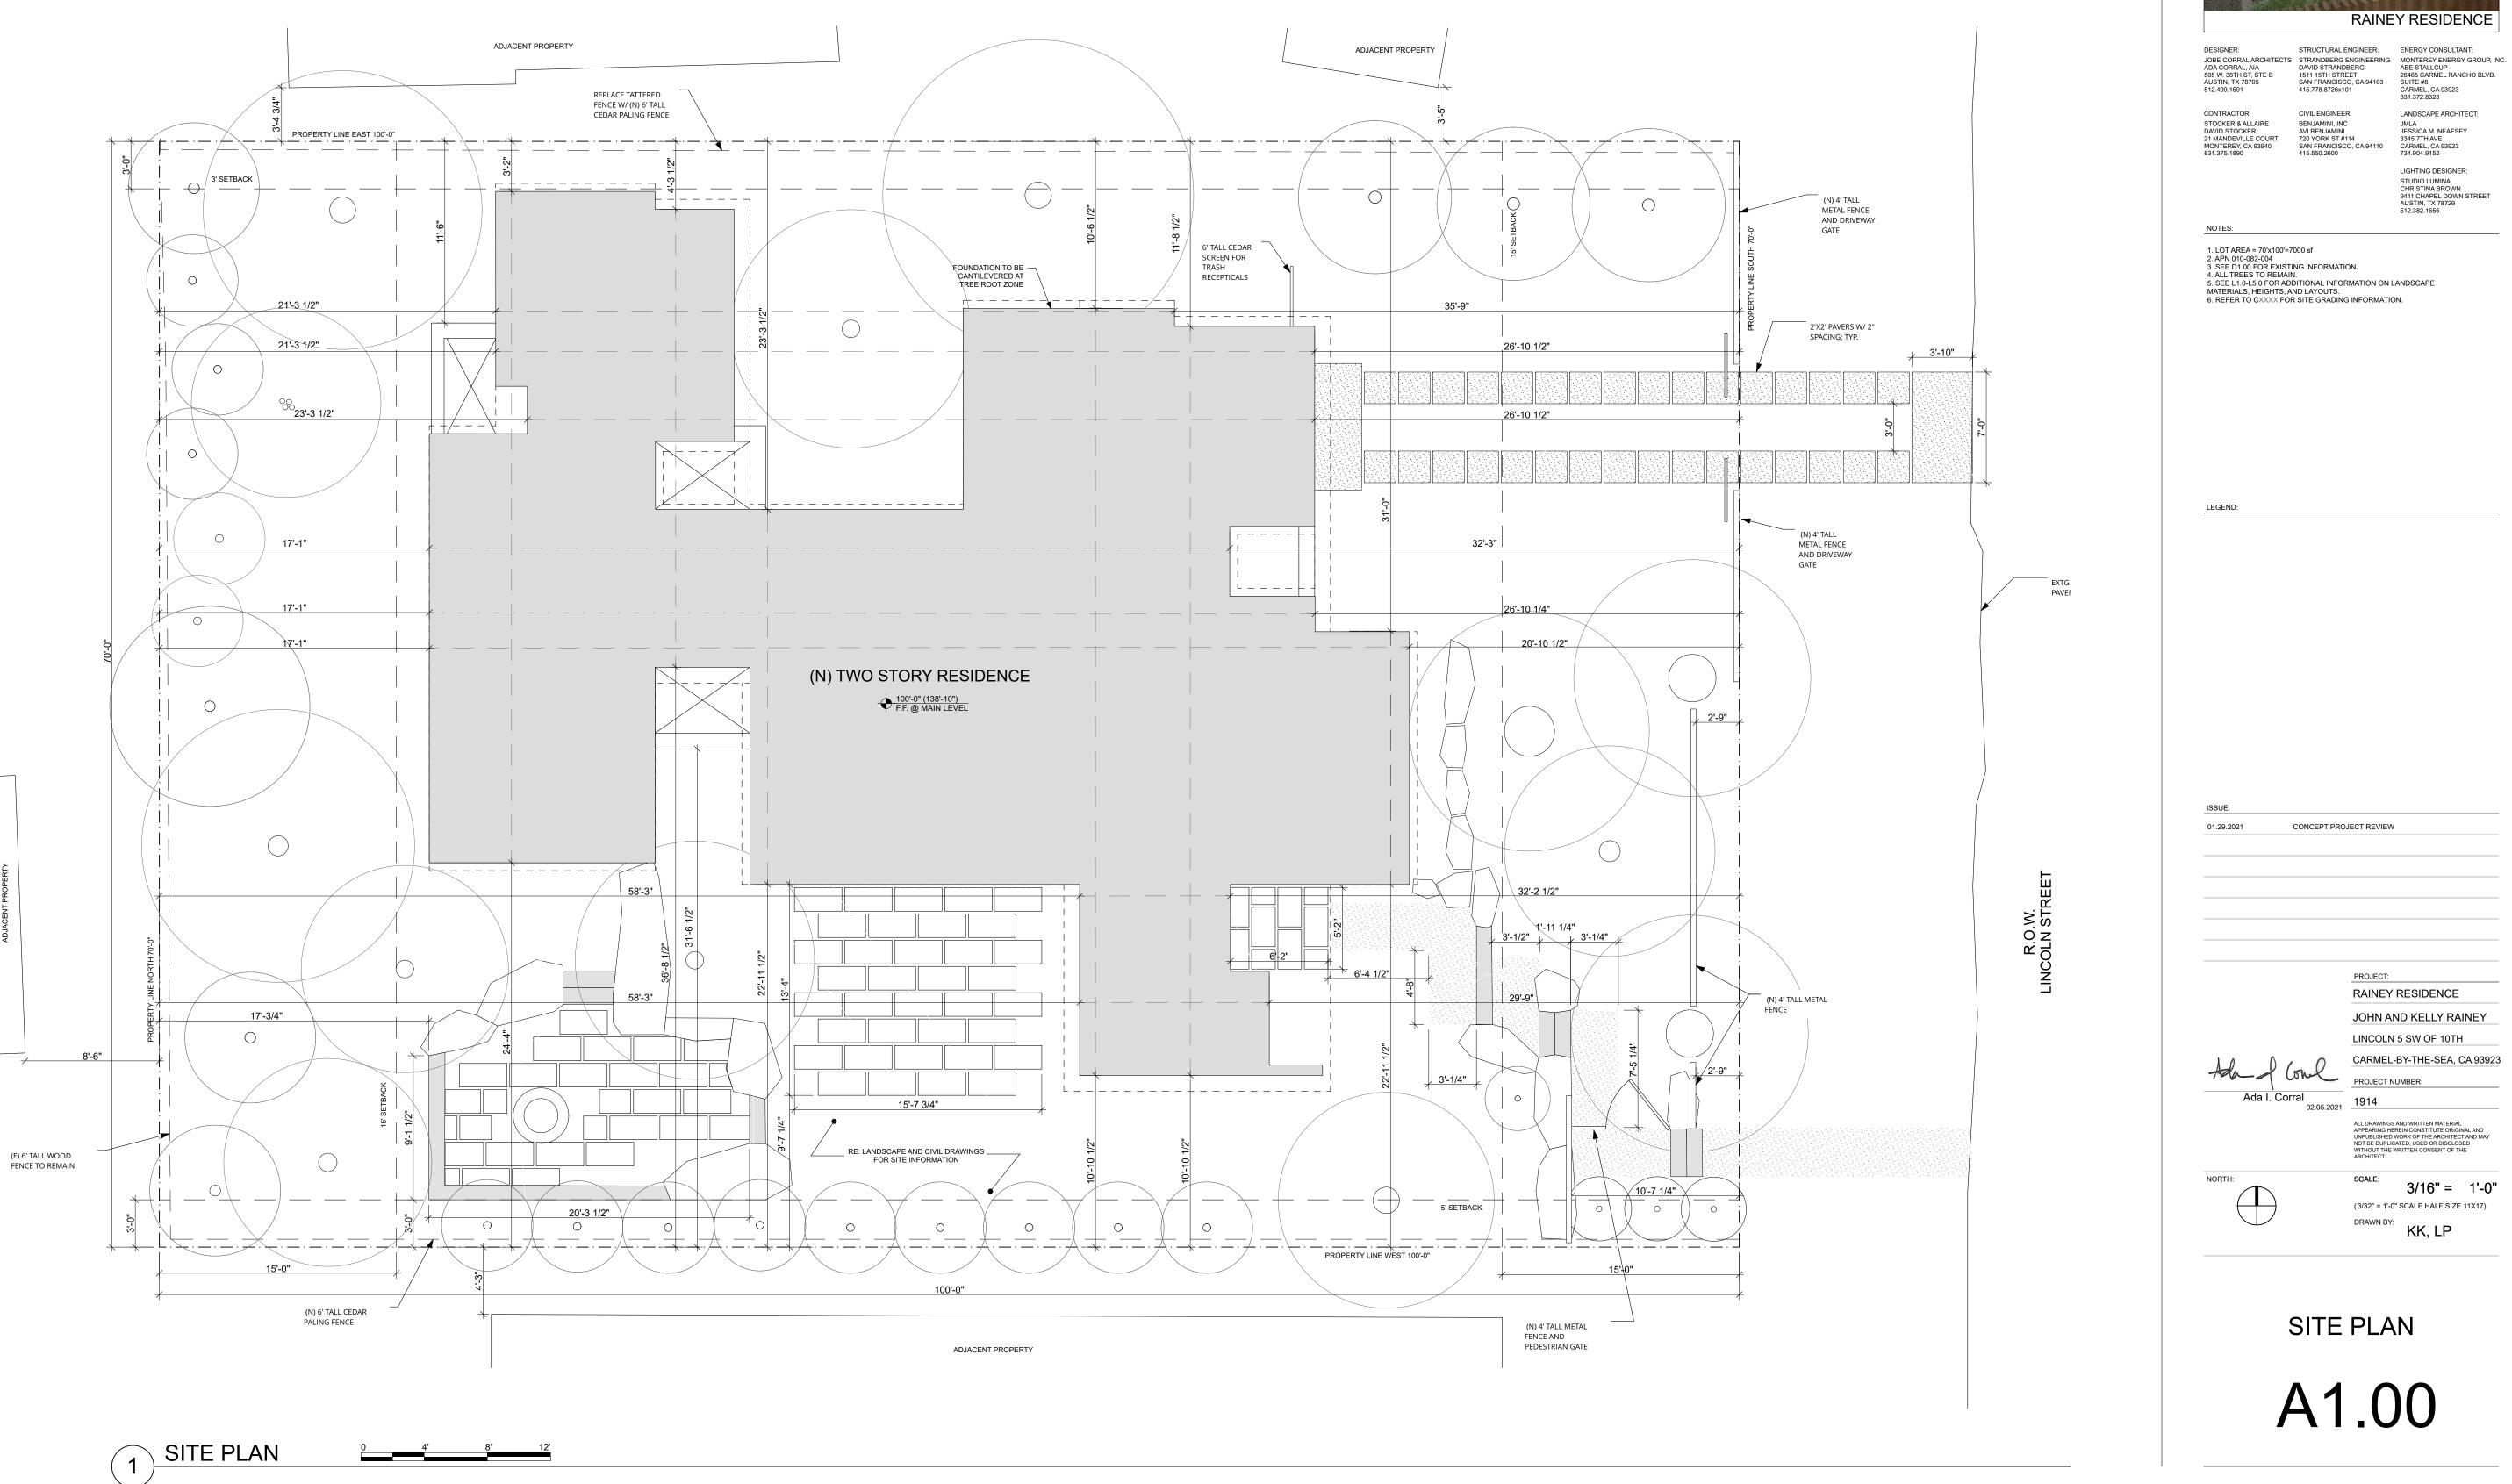
KK, LP

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Ada I. Corral

NORTH

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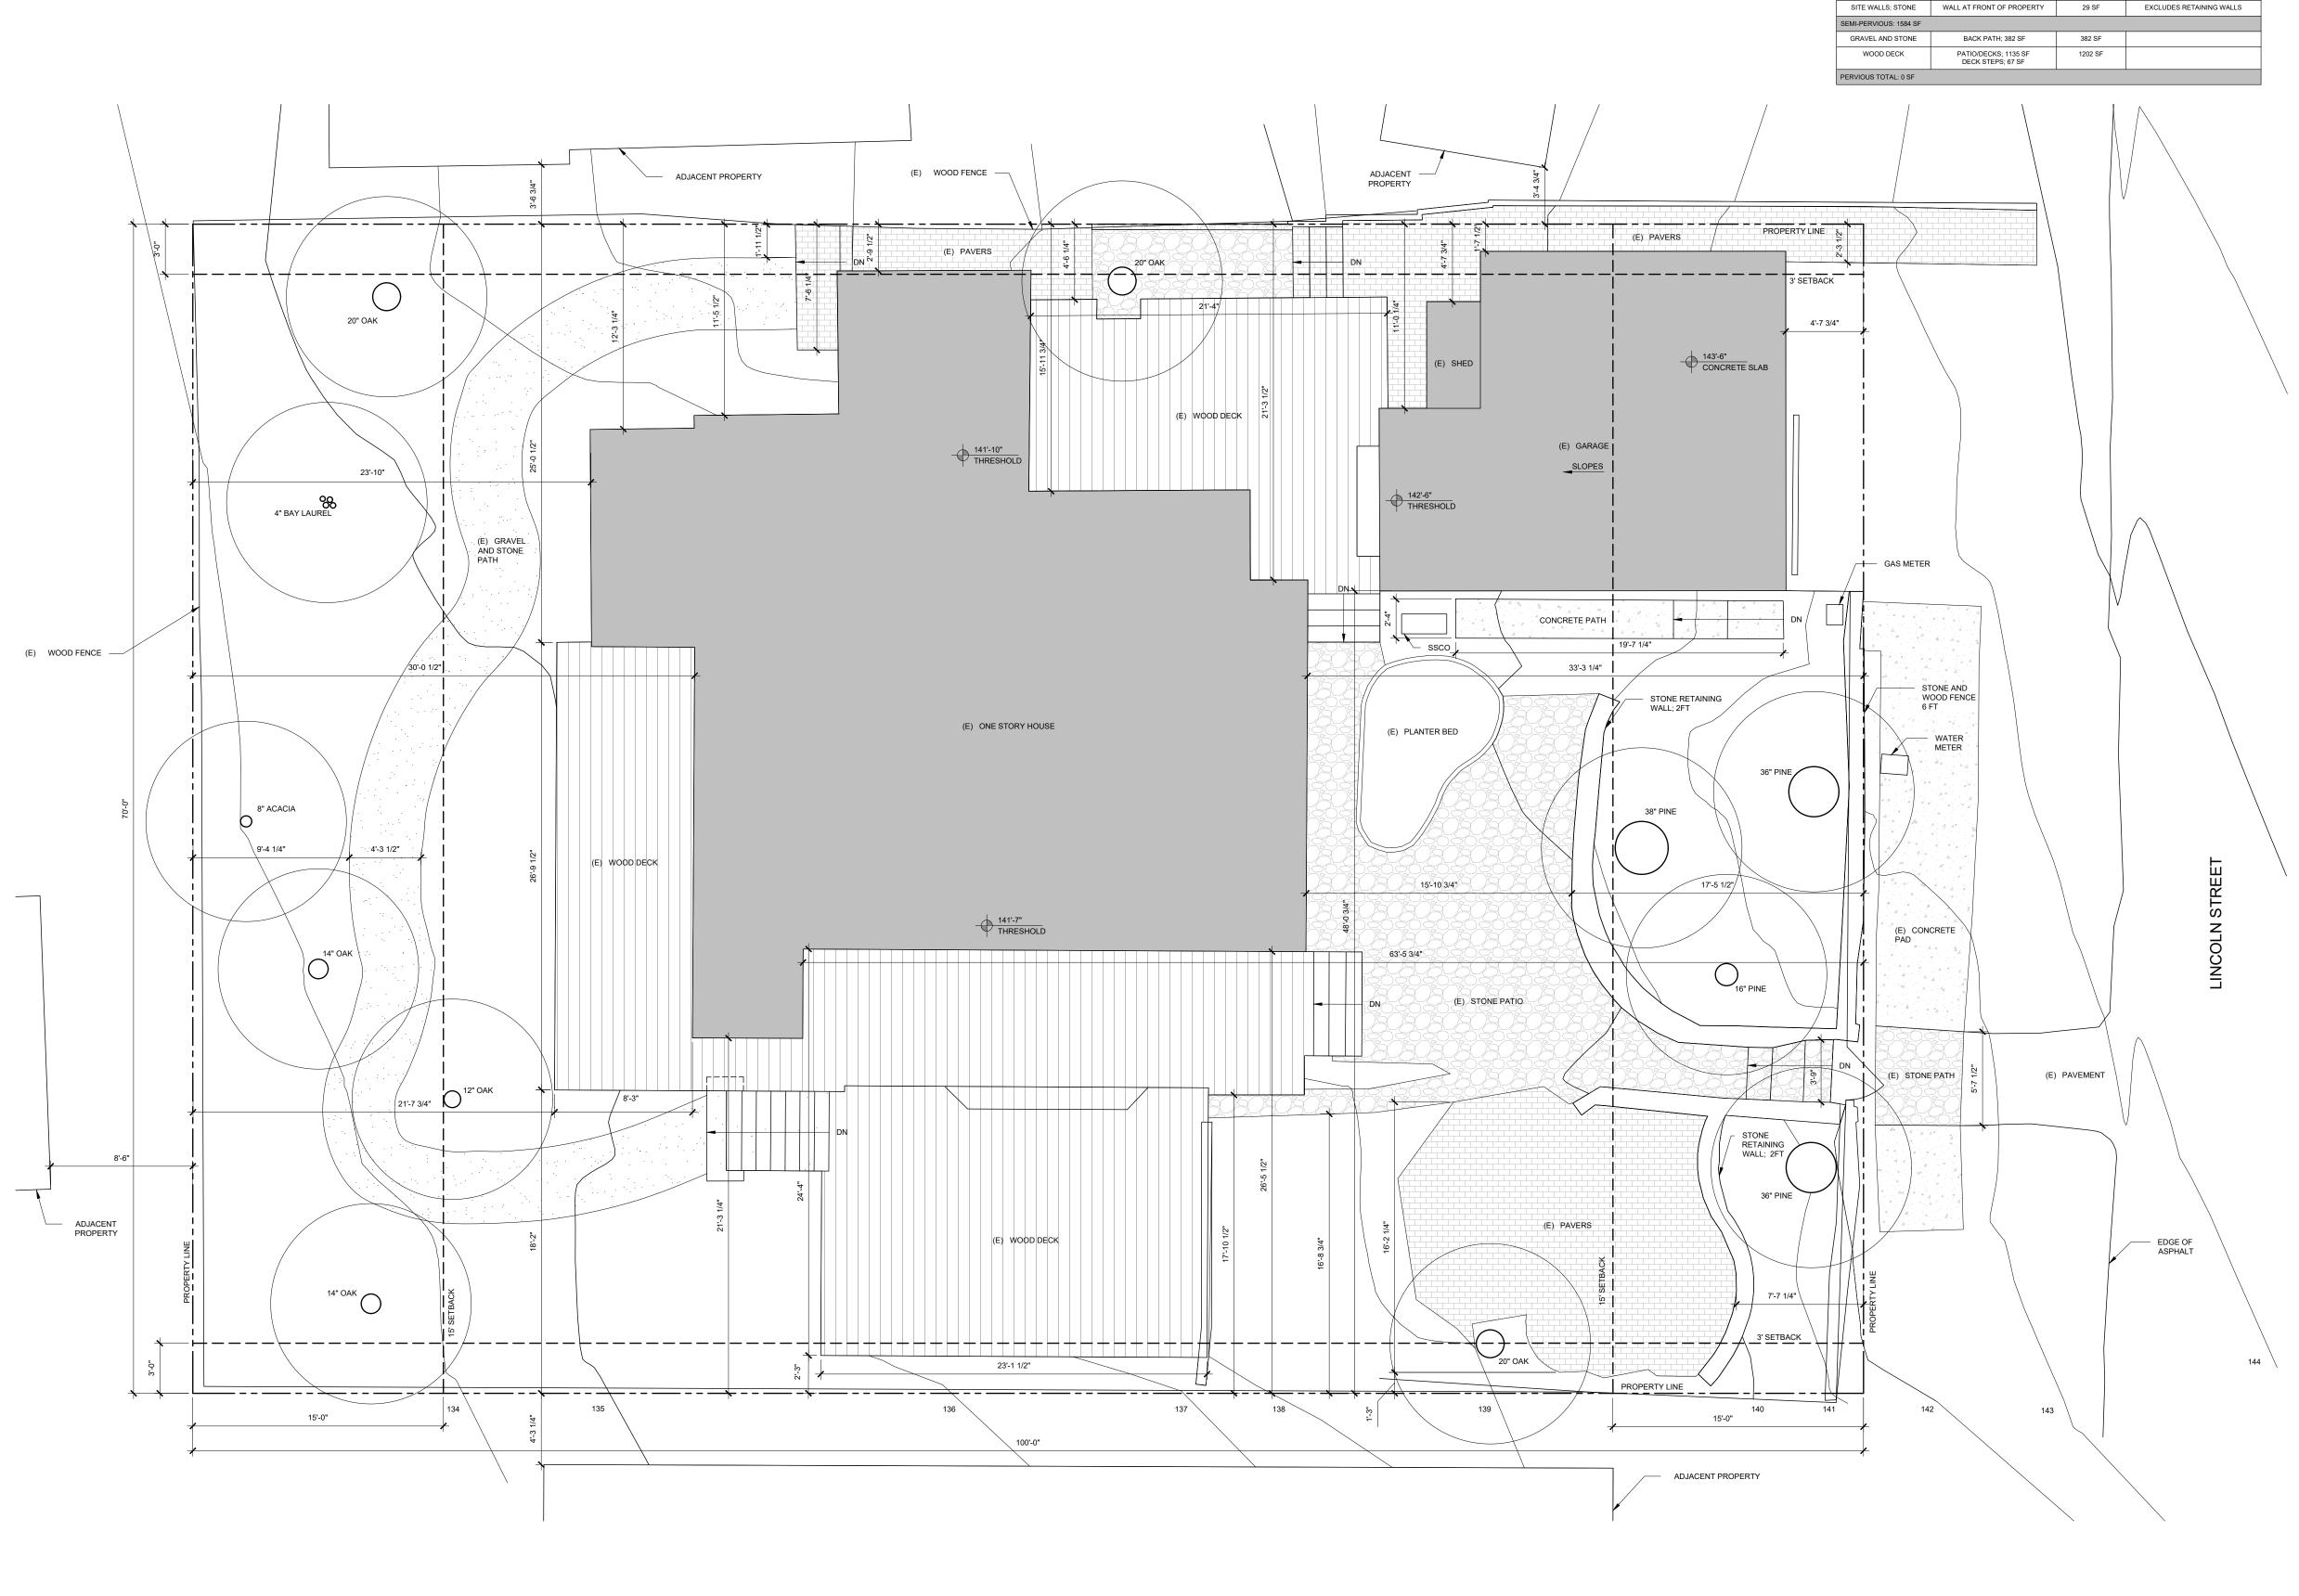








1 EXISTING SITE PLAN



EXISTING SITE	COVERAG	E
LOCATION	TOTAL AREA	NOTES
	1752 SF	
FRONT PATH; 389 SF SIDE PATIO; 56 SF	445 SF	
GARAGE PATH+STEPS; 109 SF FRONT PATIO; 270 SF PATH AT SIDE OF HOUSE; 64 SF	443 SF	
PATH, STEPS AT SIDE OF GARAGE	46 SF	
WALL AT FRONT OF PROPERTY	29 SF	EXCLUDES RETAINING WALLS
BACK PATH; 382 SF	382 SF	
PATIO/DECKS; 1135 SF DECK STEPS; 67 SF	1202 SF	

MATERIAL EXISTING BUILDING AREA IMPERVIOUS: 963 SF STONE PAVERS; MORTARED

CONCRETE





RAINEY RESIDENCE

CONTRACTOR:

DESIGNER:

CIVIL ENGINEER:

GIVIL ENGINEER: BENJAMINI, INC AVI BENJAMINI 720 YORK ST #114 SAN FRANCISCO, CA 94110 415.550.2600

 JOBE CORRAL ARCHITECTS
 STRAUDBERG ENGINEER:
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NOTES:

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PROJECT:

RAINEY RESIDENCE

JOHN AND KELLY RAINEY

CARMEL-BY-THE-SEA, CA 93923

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(3/32" = 1'-0" SCALE HALF SIZE 11X17)

DRAWN BY: KK, LP

3/16" = 1'-0'

LINCOLN 5 SW OF 10TH

PROJECT NUMBER:

SCALE:

EXISTING SITE PLAN

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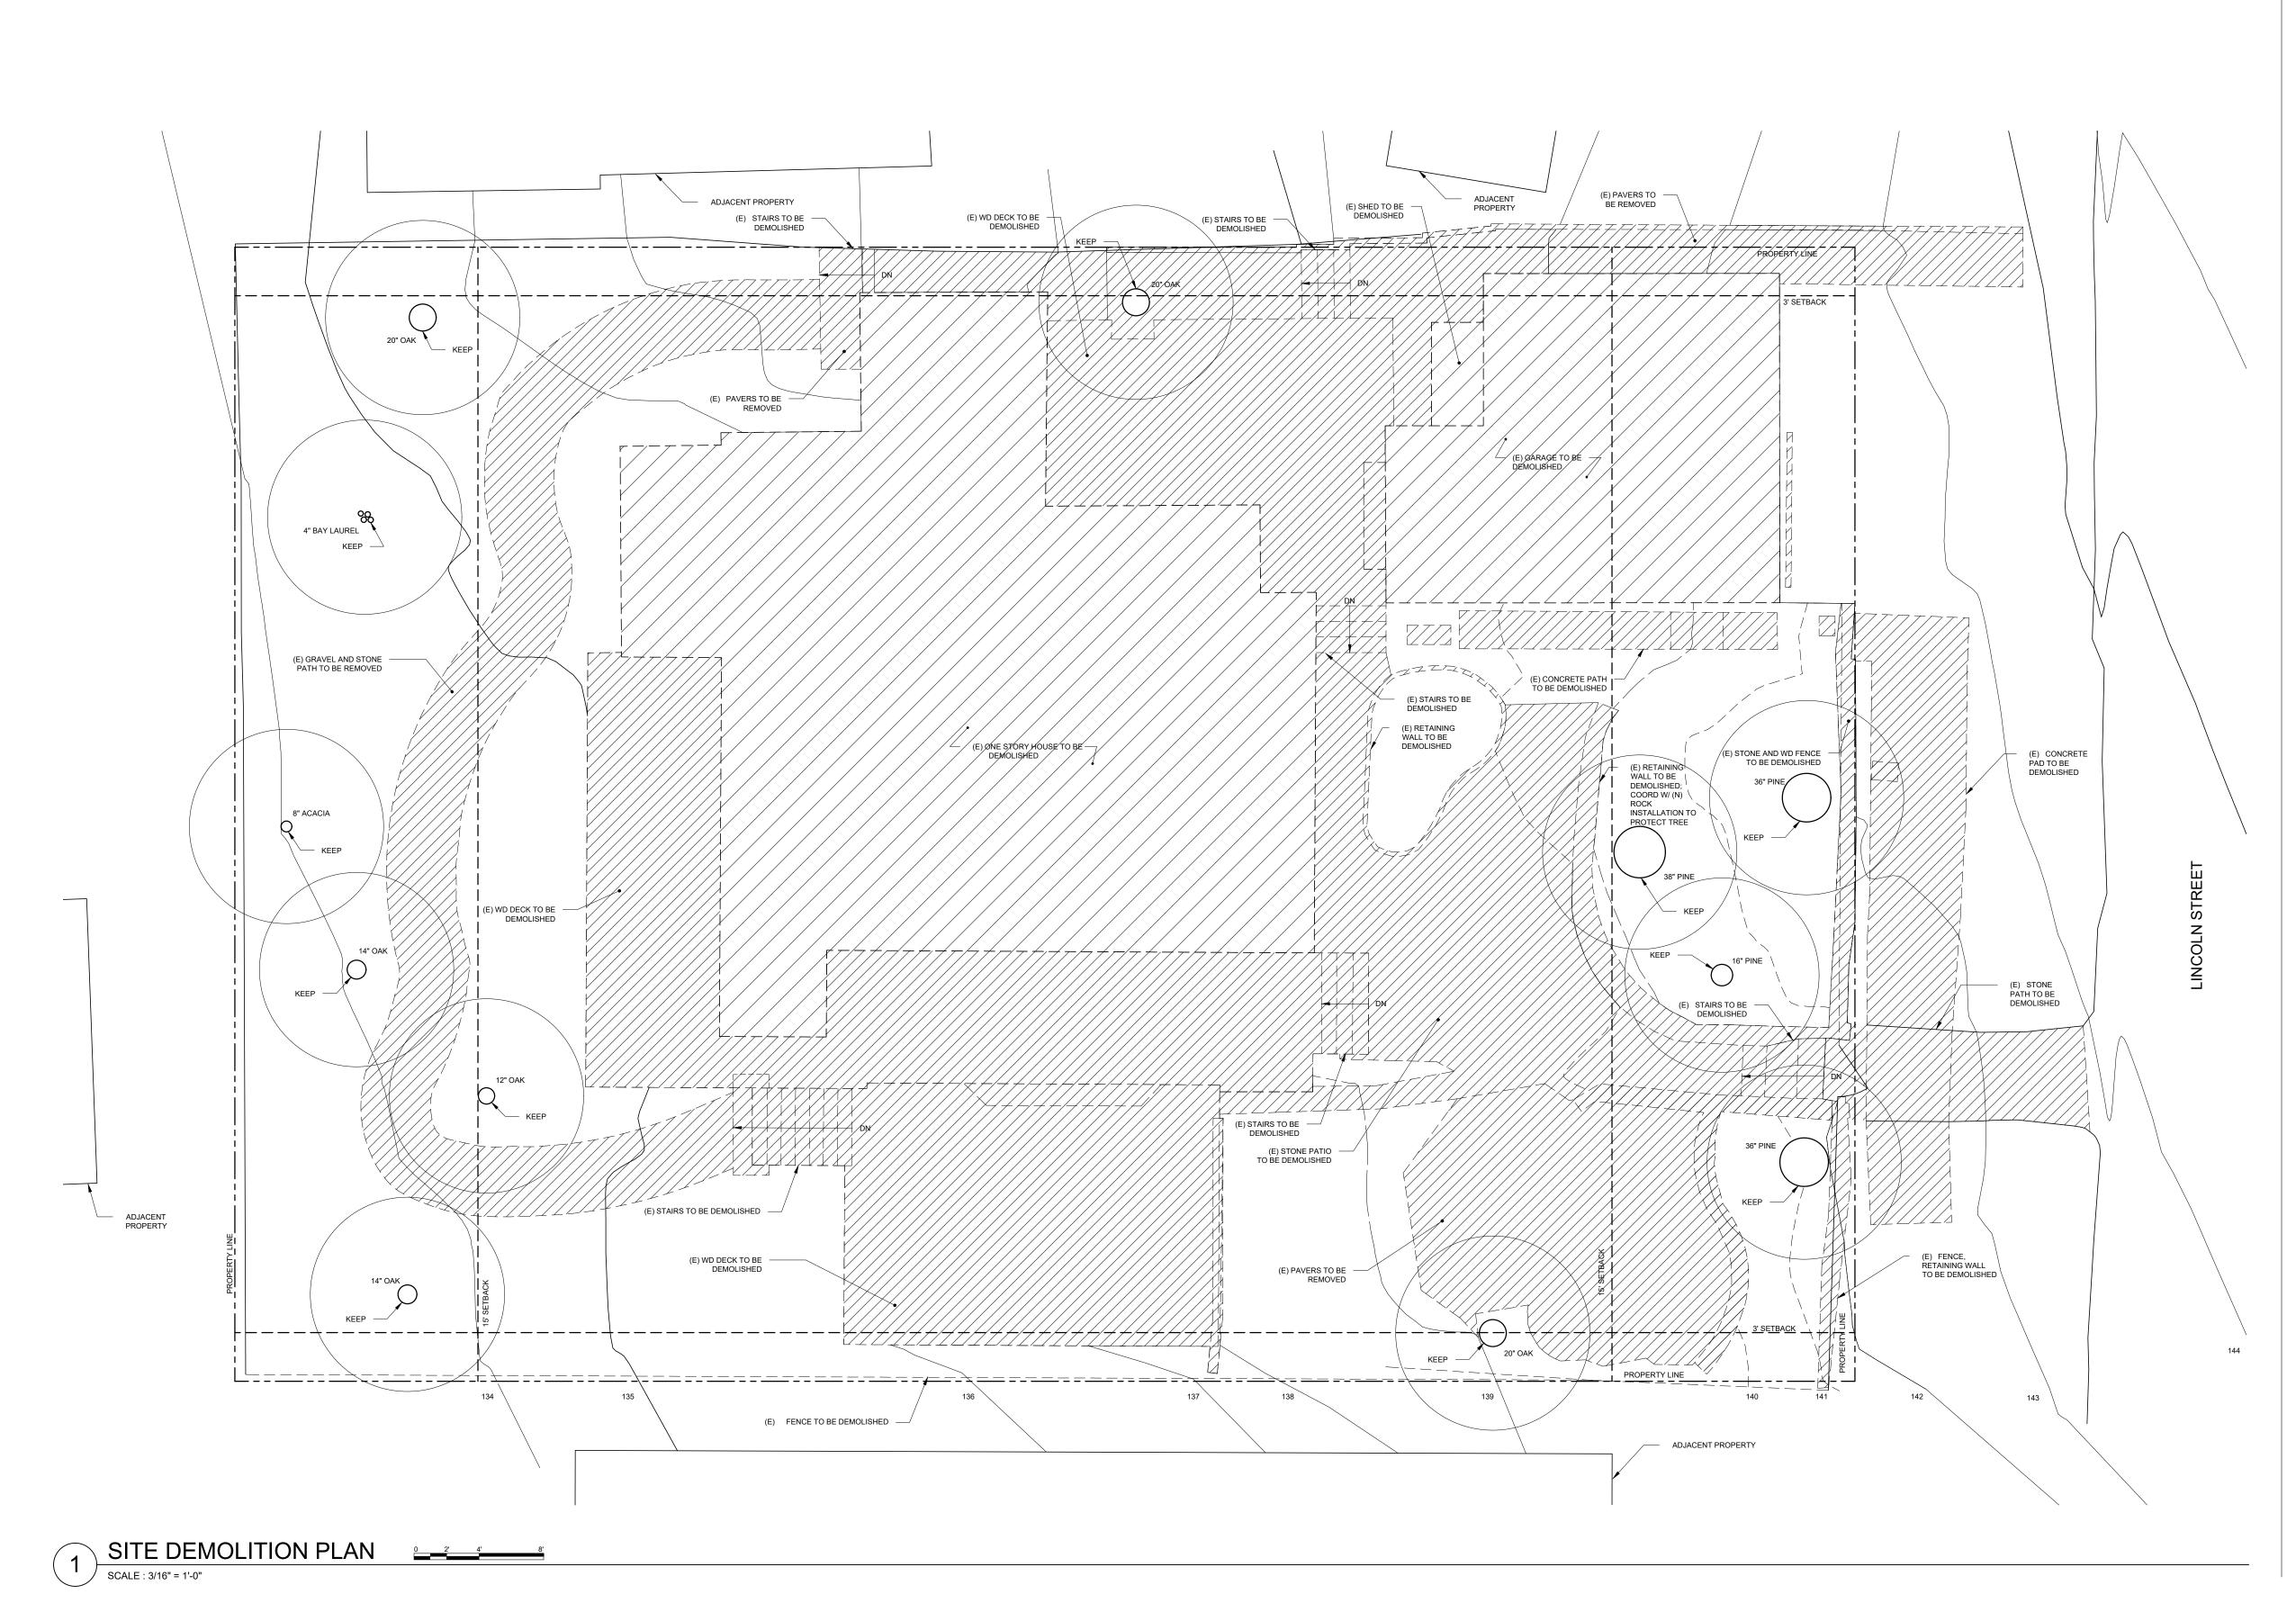
NORTH:

Ada I. Corral

ISSUE:

STOCKER & ALLAIRE DAVID STOCKER 21 MANDEVILLE COURT MONTEREY, CA 93940 831.375.1890









RAINEY RESIDENCE

CONTRACTOR:

DESIGNER:

STRUCTURAL ENGINEER: ENERGY CONSULTANT:

CIVIL ENGINEER: CIVIL ENGINEER: BENJAMINI, INC AVI BENJAMINI 720 YORK ST #114 SAN FRANCISCO, CA 94110 415.550.2600

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 STRAUDBERG ENGINEER:
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LIGHTING DESIGNER: STUDIO LUMINA CHRISTINA BROWN 9411 CHAPEL DOWN STREET AUSTIN, TX 78729 512.382.1656

LEGEND

CONCEPT PROJECT REVIEW

PROJECT:

RAINEY RESIDENCE

JOHN AND KELLY RAINEY

CARMEL-BY-THE-SEA, CA 93923

(3/32" = 1'-0" SCALE HALF SIZE 11X17)

3/16" = 1'-0", 3/16" =

LINCOLN 5 SW OF 10TH

PROJECT NUMBER:

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DRAWN BY: KK, LP

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SITE DEMOLITION

PLAN

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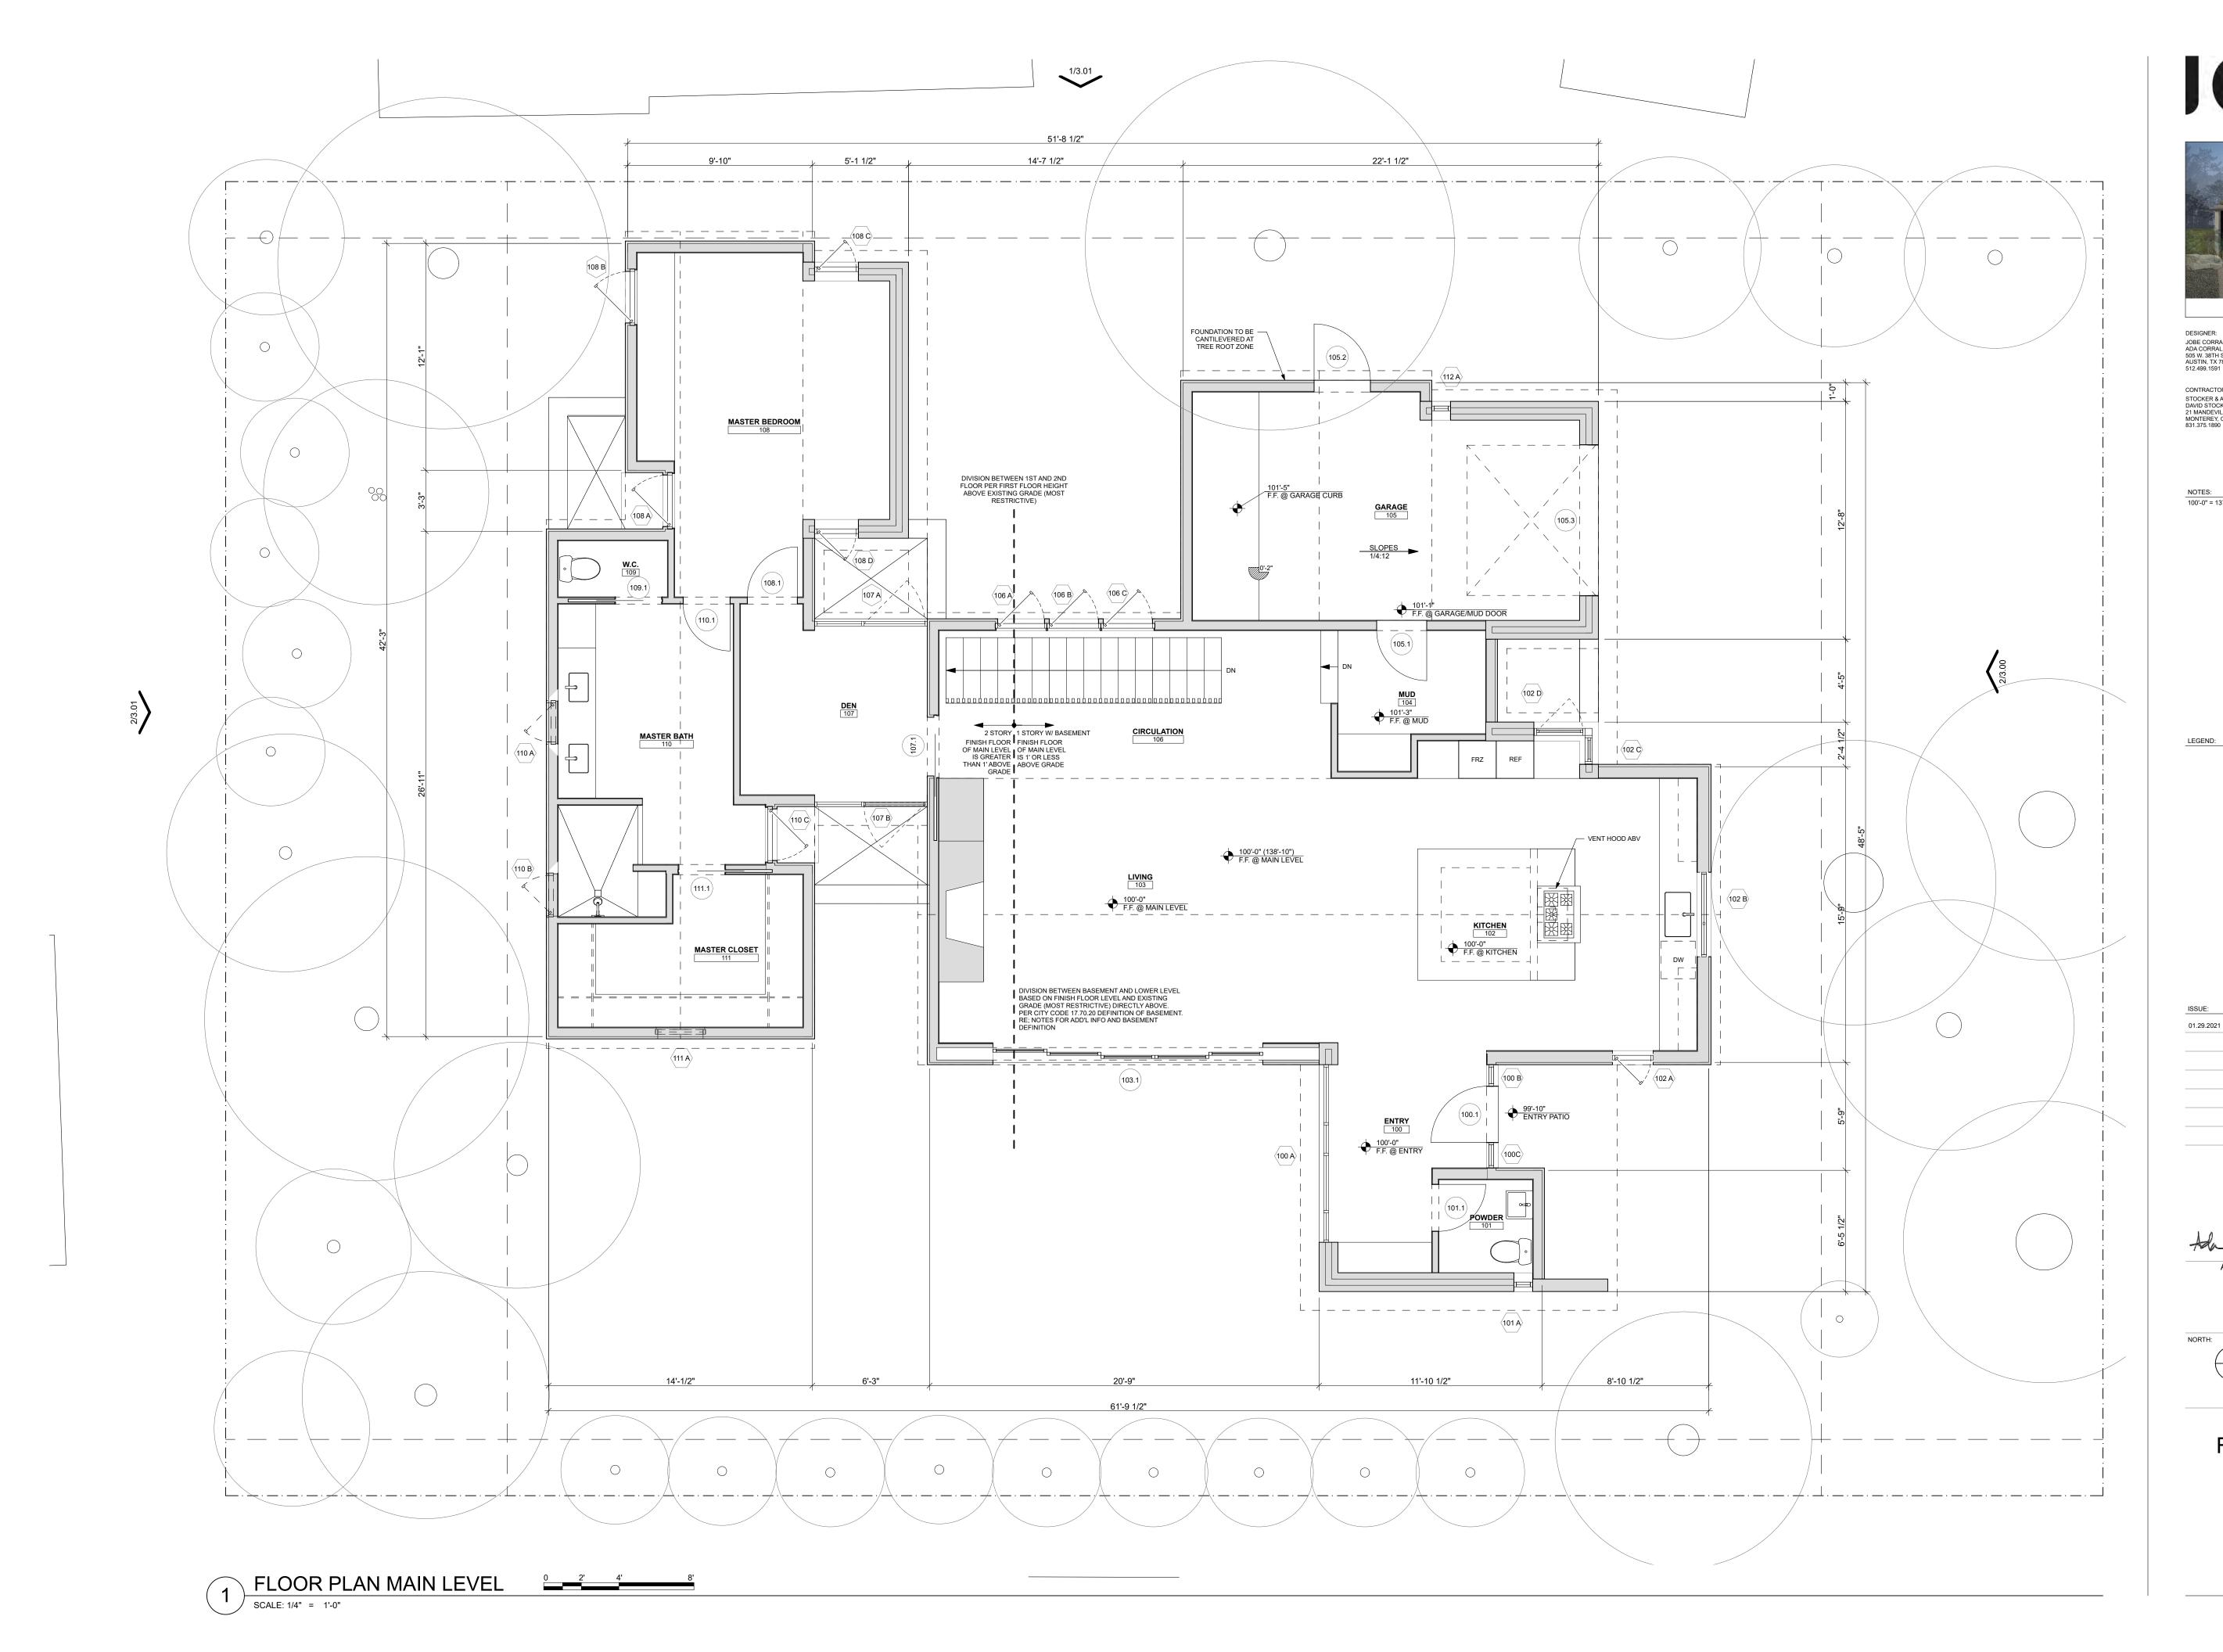
NORTH:

Ada I. Corral

ISSUE:

NOTES:

STOCKER & ALLAIRE DAVID STOCKER 21 MANDEVILLE COURT MONTEREY, CA 93940 831.375.1890







RAINEY RESIDENCE

STRUCTURAL ENGINEER: ENERGY CONSULTANT:

 JOBE CORRAL ARCHITECTS
 STRUCTORAL ENGINEER:
 ENERGY CONSULTANT:

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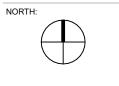
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LIGHTING DESIGNER: STUDIO LUMINA CHRISTINA BROWN 9411 CHAPEL DOWN STREET AUSTIN, TX 78729 512.382.1656

NOTES: 100'-0" = 137'-6" ABV SEA LEVEL


ISSUE: CONCEPT PROJECT REVIEW 01.29.2021 PROJECT: RAINEY RESIDENCE JOHN AND KELLY RAINEY LINCOLN 5 SW OF 10TH CARMEL-BY-THE-SEA, CA 93923 the -Come PROJECT NUMBER: Ada I. Corral 02.05.2021 1914 ALL DRAWINGS AND WRITTEN MATERIAL APPEARING HEREIN CONSTITUTE ORIGINAL AND UNPUBLISHED WORK OF THE ARCHITECT AND MAY NOT BE DUPLICATED, USED OR DISCLOSED WITHOUT THE WRITTEN CONSENT OF THE ARCHITECT.

SCALE: 1/4" = 1'-0" (1/8" = 1'-0" SCALE HALF SIZE 11X17) drawn by: KK, LP



FLOOR PLAN MAIN LEVEL

A2.10

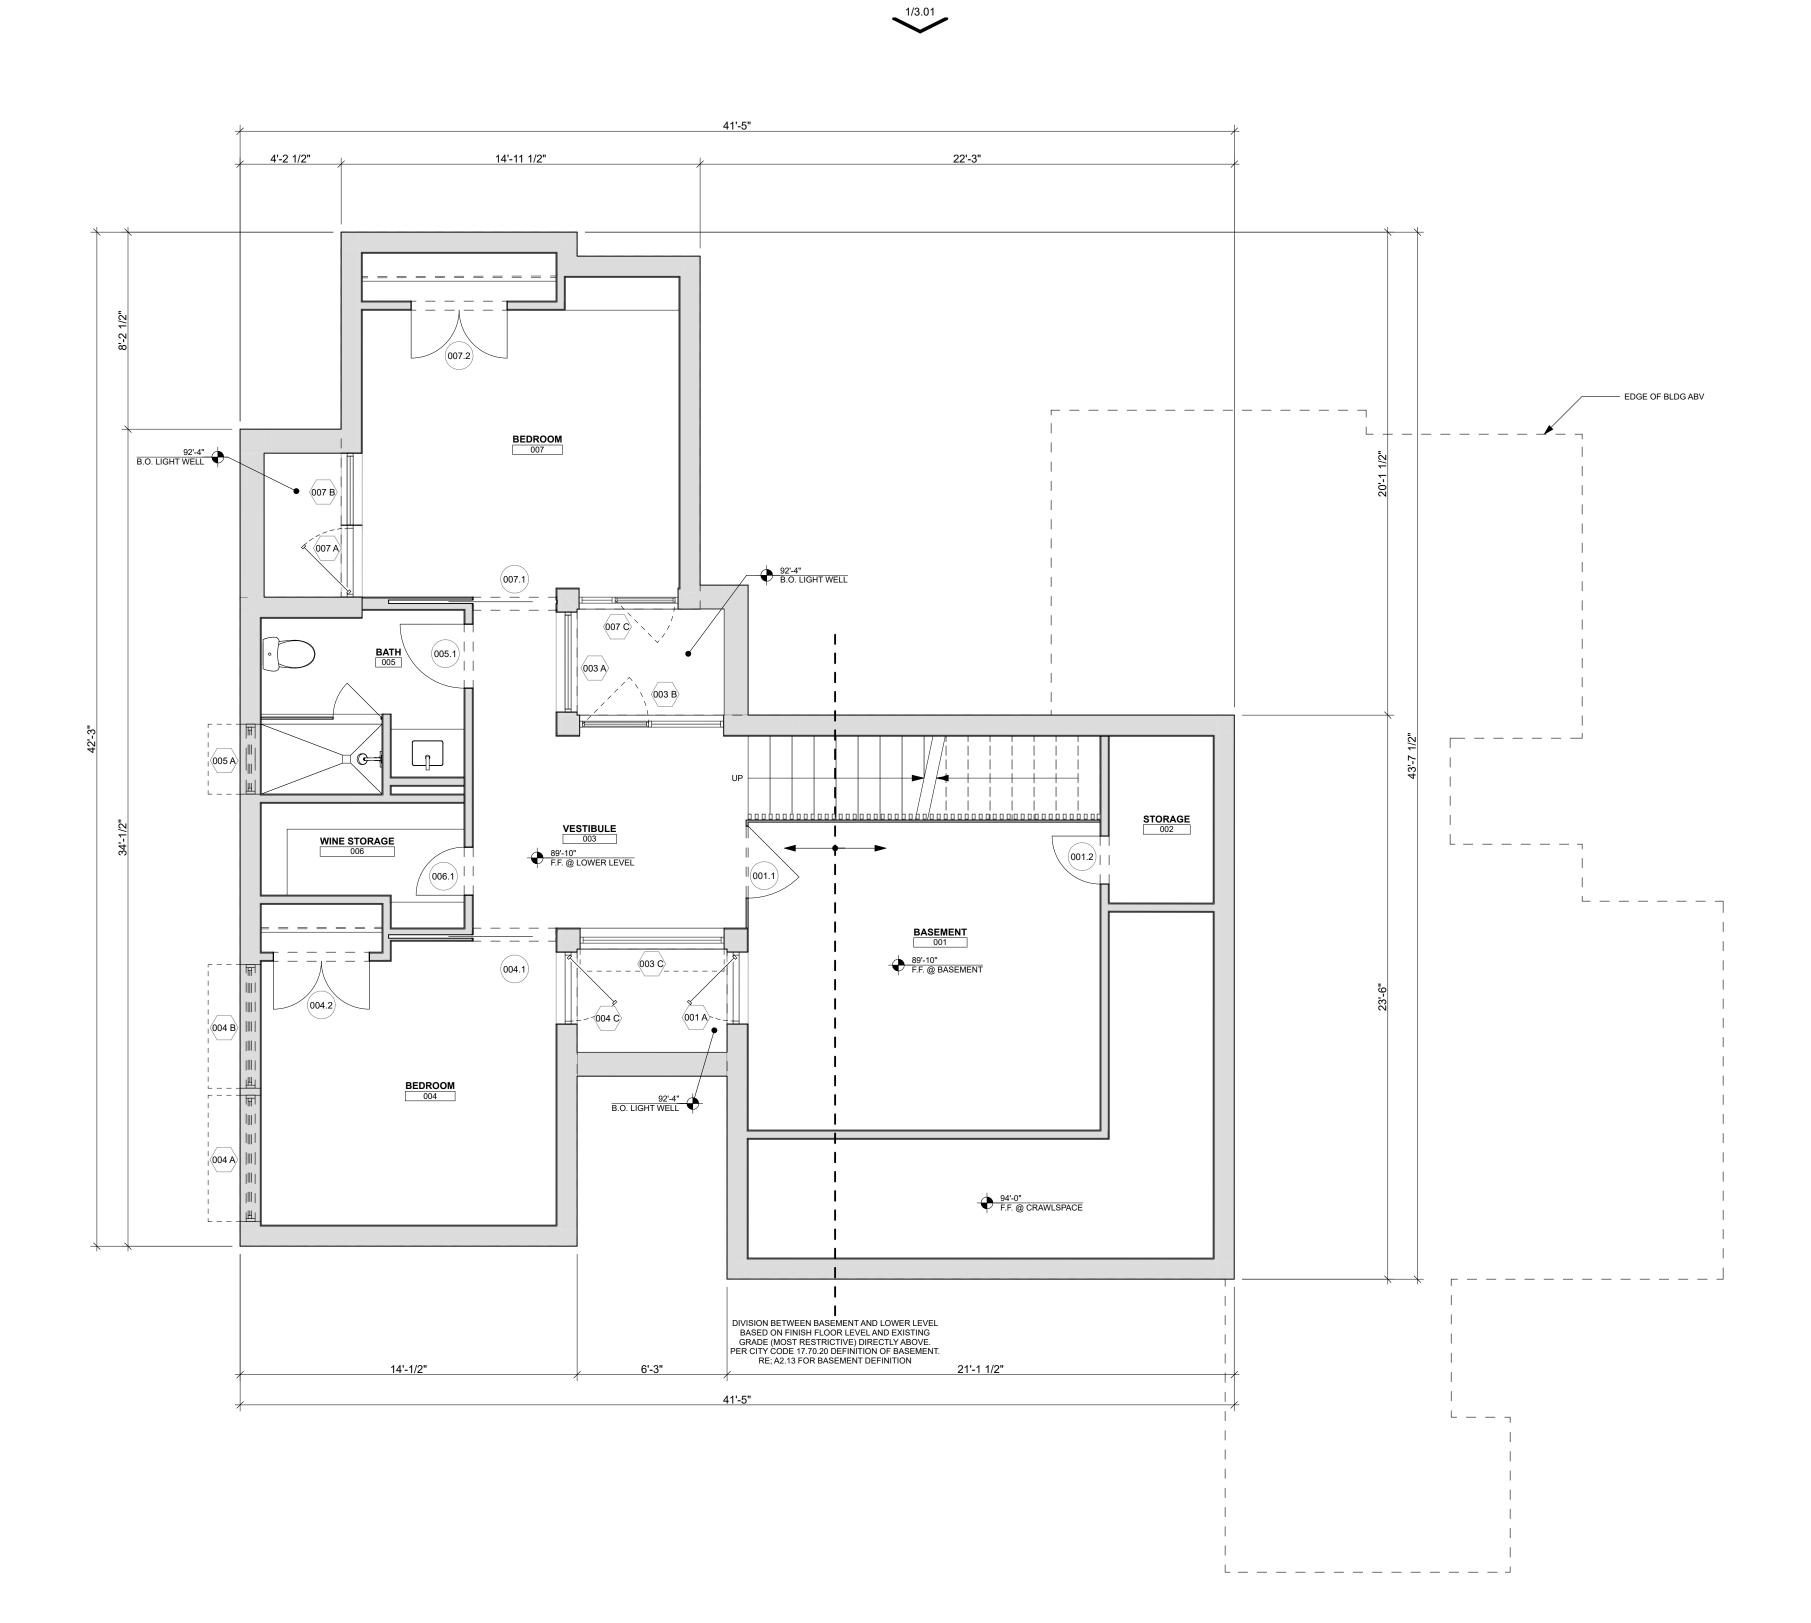



1/3.00





RAINEY RESIDENCE

CONTRACTOR:

CIVIL ENGINEER: GIVIL ENGINEER: BENJAMINI, INC AVI BENJAMINI 720 YORK ST #114 SAN FRANCISCO, CA 94110 415.550.2600

 JOBE CORRAL ARCHITECTS
 STRAUDBERG ENGINEER:
 ENERGY CONSULTANT:

 JOBE CORRAL ARCHITECTS
 STRANDBERG ENGINEERING
 MONTEREY ENERGY GROUP, INC.

 ADA CORRAL, AIA
 DAVID STRANDBERG
 ABE STALLCUP

 505 W. 38TH ST, STE B
 1511 15TH STREET
 26465 CARMEL RANCHO BLVD.

 AUST, TX 78705
 SAN FRANCISCO, CA 94103
 SUITE #8

 512.499.1591
 415.778.8726x101
 CARMEL, CA 93923

 831.372.8328
 831.372.8328
 LANDSCAPE ARCHITECT:

JMLA JESSICA M. NEAFSEY 3345 7TH AVE CARMEL, CA 93923 734.904.9152 LIGHTING DESIGNER

STUDIO LUMINA CHRISTINA BROWN 9411 CHAPEL DOWN STREE AUSTIN, TX 78729 512.382.1656

NOTES:

DESIGNER:



01.29.2021 CONCEPT PROJECT REVIEW PROJECT: RAINEY RESIDENCE JOHN AND KELLY RAINEY LINCOLN 5 SW OF 10TH Ada CARMEL-BY-THE-SEA, CA 93923 Coul PROJECT NUMBER: Ada I. Corral al ______1914

ALL DRAWINGS AND WRITTEN MATERIAL APPEARING HEREIN CONSTITUTE ORIGINAL AND UNPUBLISHED WORK OF THE ARCHITECT AND MAY NOT BE DUPLICATED, USED OR DISCLOSED WITHOUT THE WRITTEN CONSENT OF THE ARCHITECT. SCALE: 1/4" = 1'-0" (1/8" = 1'-0" SCALE HALF SIZE 11X17)



DRAWN BY: KK, LP

FLOOR PLAN


LOWER LEVEL

A2.11

ISSUE:

STOCKER & ALLAIRE DAVID STOCKER 21 MANDEVILLE COURT MONTEREY, CA 93940 831.375.1890

STRUCTURAL ENGINEER: ENERGY CONSULTANT:

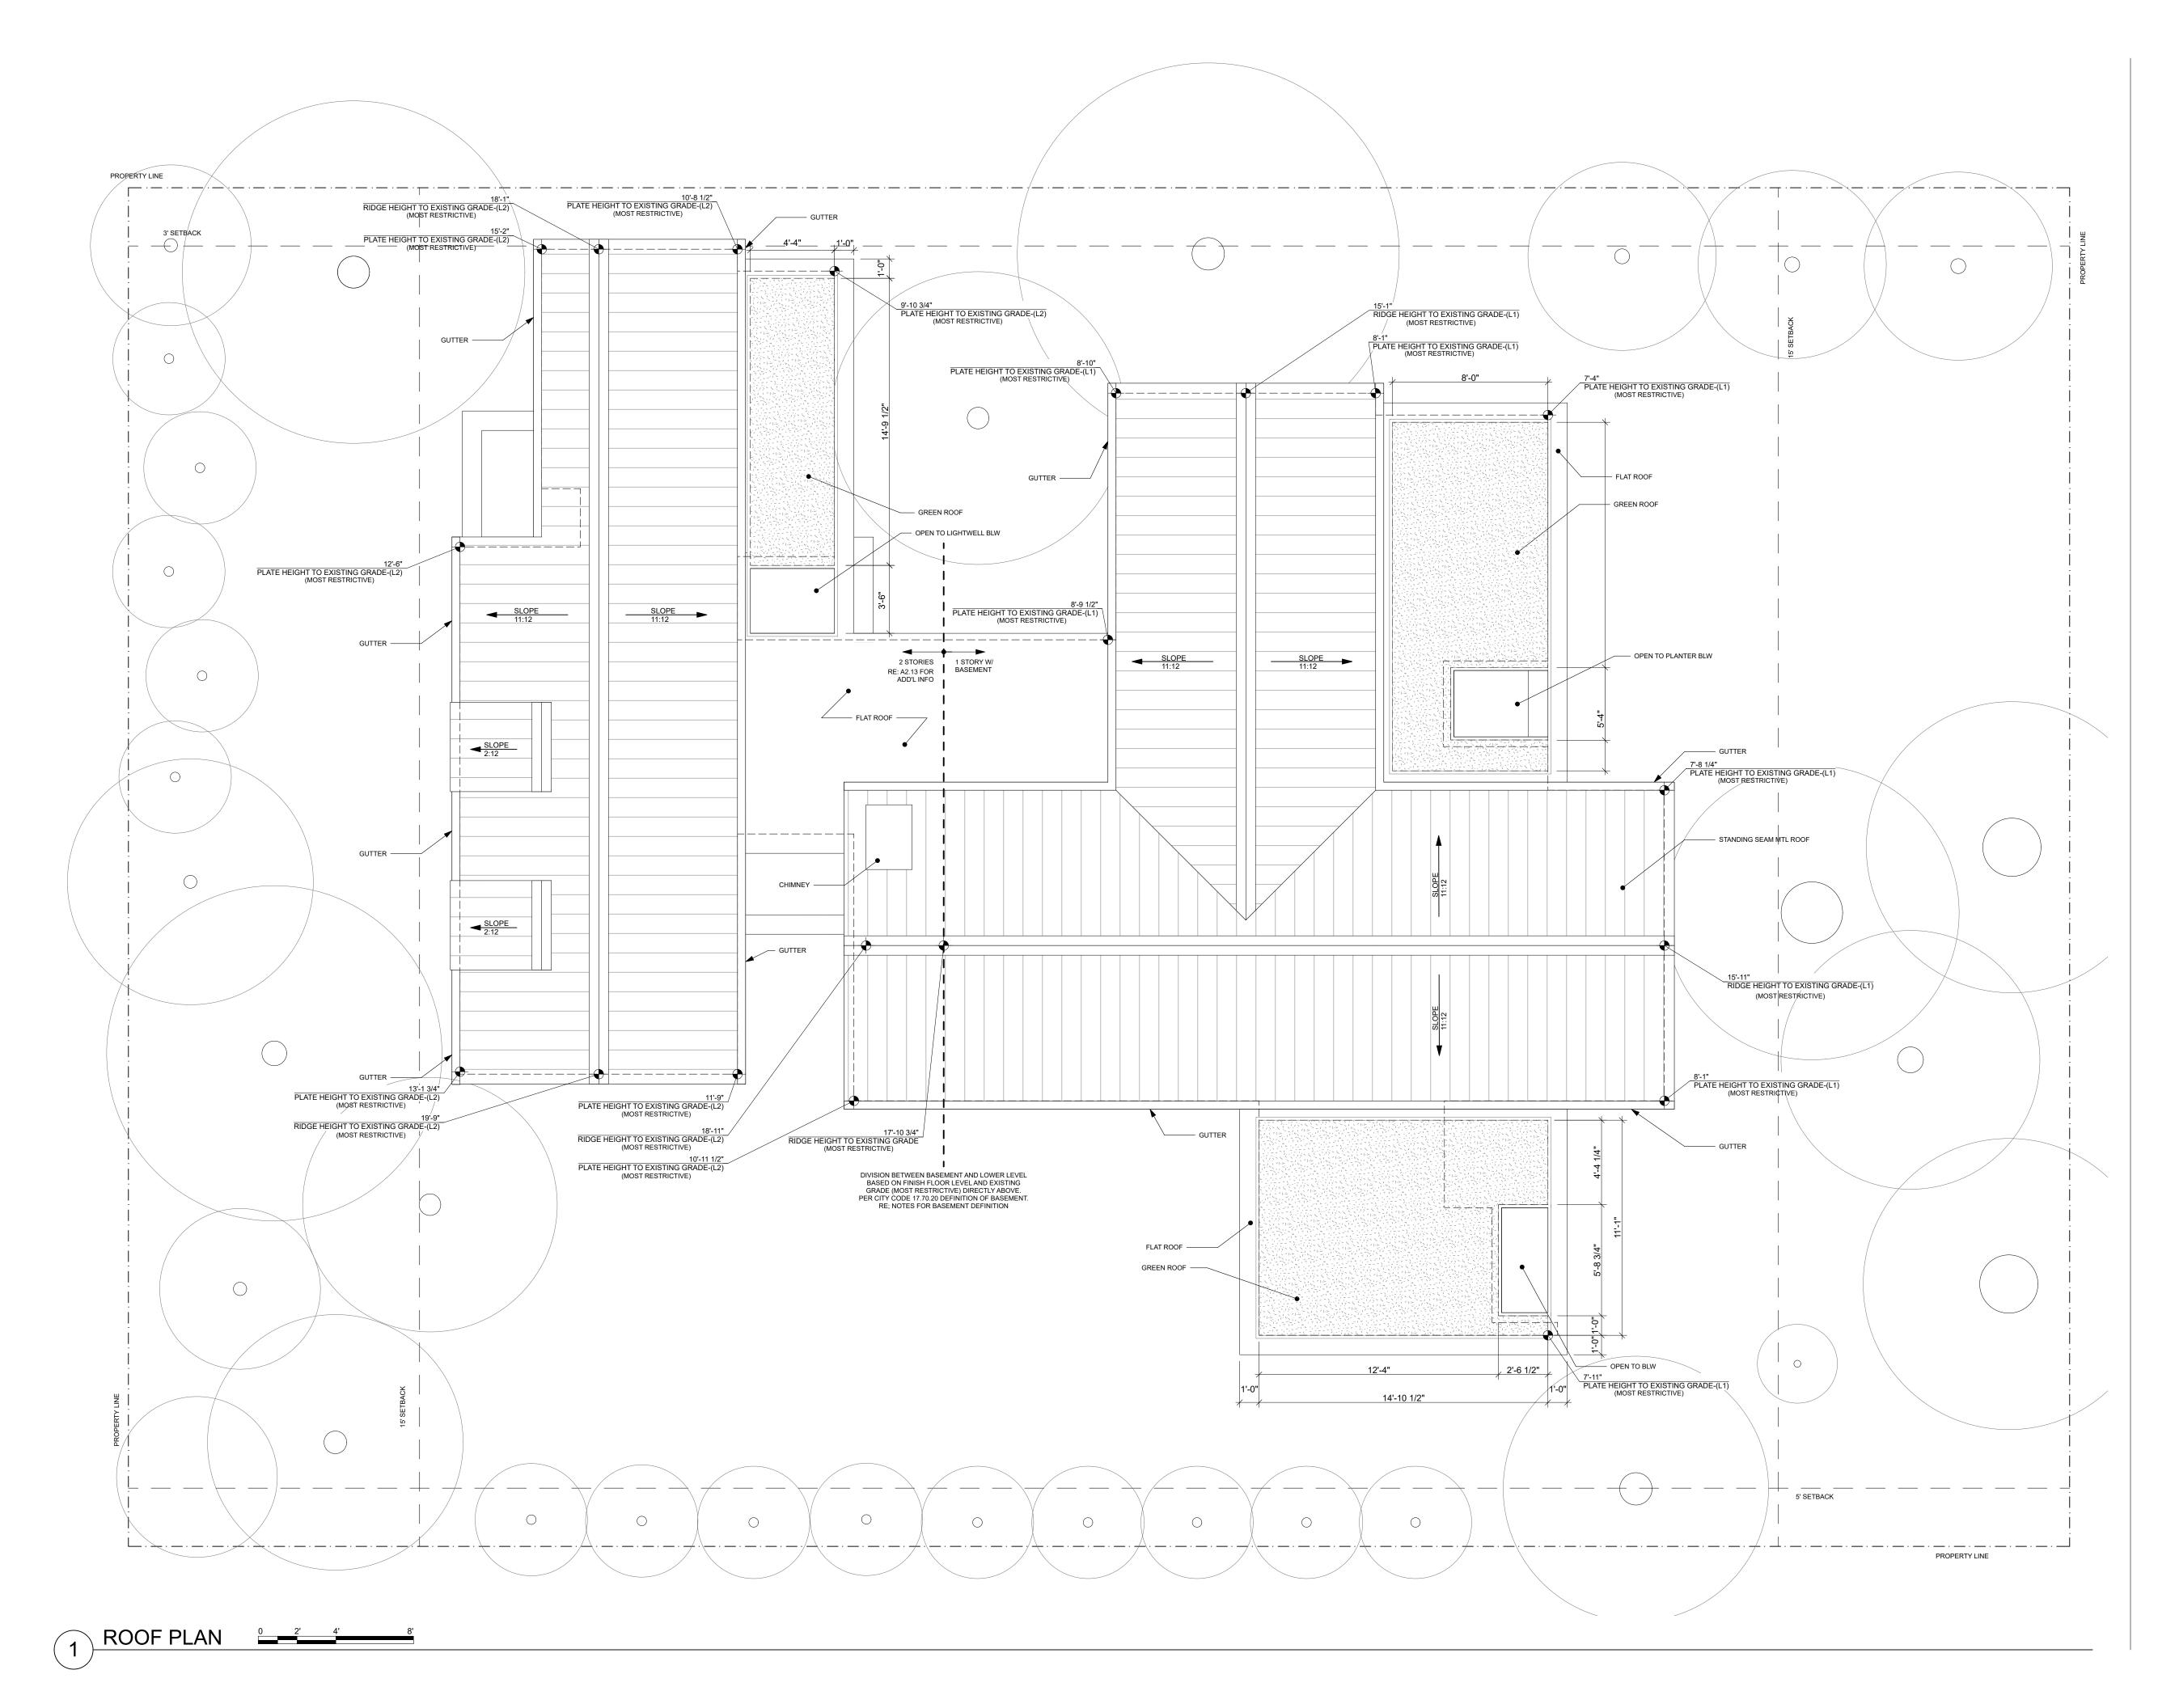





RAINEY RESIDENCE

CONTRACTOR:

DESIGNER:

NOTES:

SEE A2.13 FOR ADD'L INFO

CIVIL ENGINEER: BENJAMINI, INC AVI BENJAMINI 720 YORK ST #114 SAN FRANCISCO, CA 94110 415.550.2600 STOCKER & ALLAIRE DAVID STOCKER 21 MANDEVILLE COURT MONTEREY, CA 93940 831.375.1890

 DESIGNER:
 STRUCTURAL ENGINEER:
 ENERGY CONSULTANT:

 JOBE CORRAL ARCHITECTS
 STRANDBERG ENGINEERING
 MONTEREY ENERGY GROUP, INC.

 ADA CORRAL, AIA
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 LANDSCAPE ARCHITECT:

JMLA JESSICA M. NEAFSEY 3345 7TH AVE CARMEL, CA 93923 734.904.9152 LIGHTING DESIGNER:

STUDIO LUMINA CHRISTINA BROWN 9411 CHAPEL DOWN STREET AUSTIN, TX 78729 512.382.1656

I EGEND

CONCEPT PROJECT REVIEW PROJECT: RAINEY RESIDENCE JOHN AND KELLY RAINEY

Come

Ada I. Corral

02.05.2021 1914

LINCOLN 5 SW OF 10TH

PROJECT NUMBER:

SCALE:

DRAWN BY:

ROOF PLAN

A2.12

CARMEL-BY-THE-SEA, CA 93923

ALL DRAWINGS AND WRITTEN MATERIAL APPEARING HEREIN CONSTITUTE ORIGINAL AND UNIPUBLISHED WORK OF THE ARCHITECT AND MAY NOT BE DUPLICATED, USED OR DISCLOSED WITHOUT THE WRITTEN CONSENT OF THE ARCHITECT.

(1/8" = 1'-0" SCALE HALF SIZE 11X17)

KK, LP

1/4" = 1'-0"

01.29.2021

ISSUE:

tan


NORTH:

(L1) SINGLE STORY W/ BASEMENT HEIGHT MARKER (L2) 2 STORY HEIGHT MARKER

STRUCTURAL ENGINEER: ENERGY CONSULTANT:





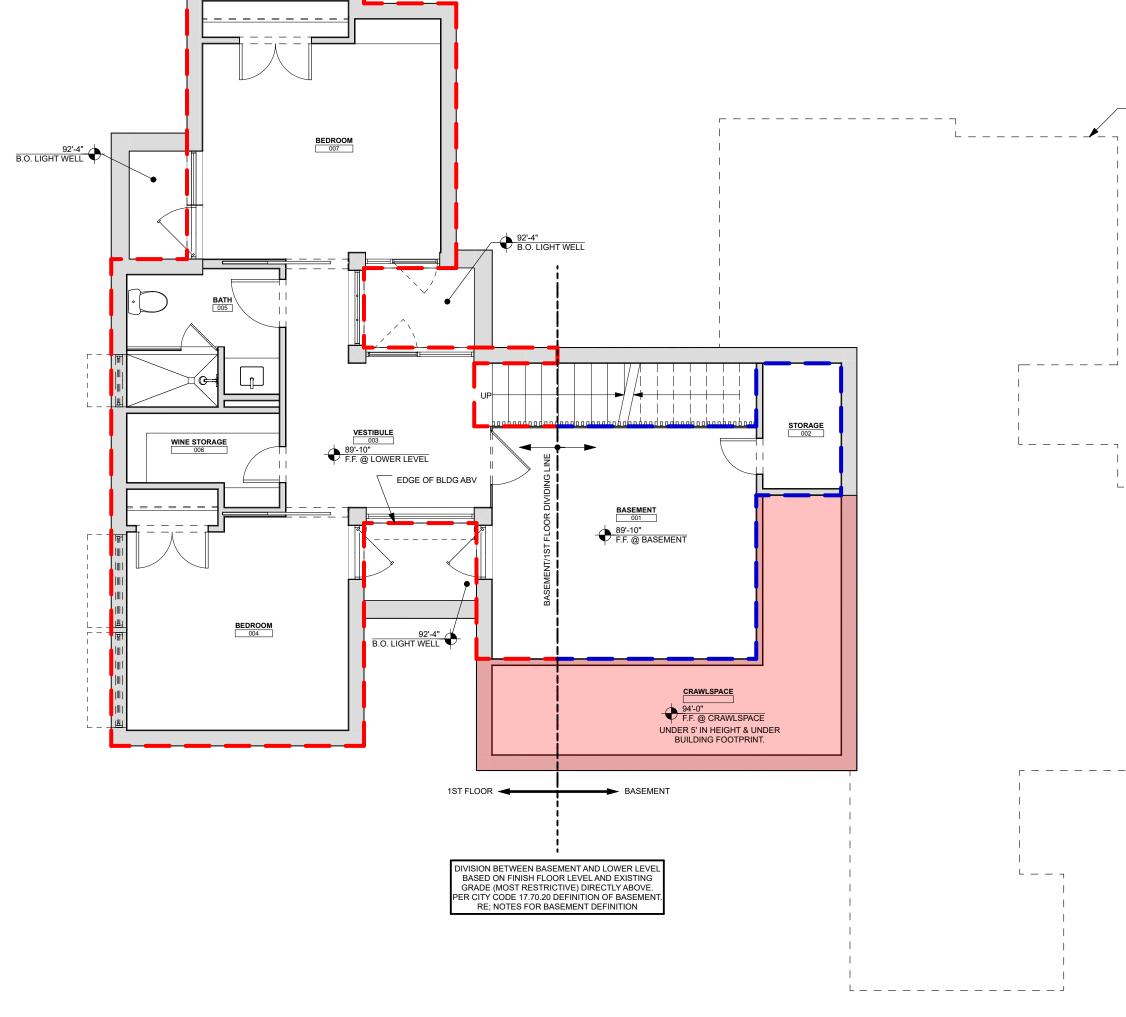


LEVEL 1 LEVEL 2


BASE FLOOR AREA IN BASEMENT


BONUS BASEMENT FLOOR AREA (BASE X 2)

EXEMPT BASEMENT BONUS



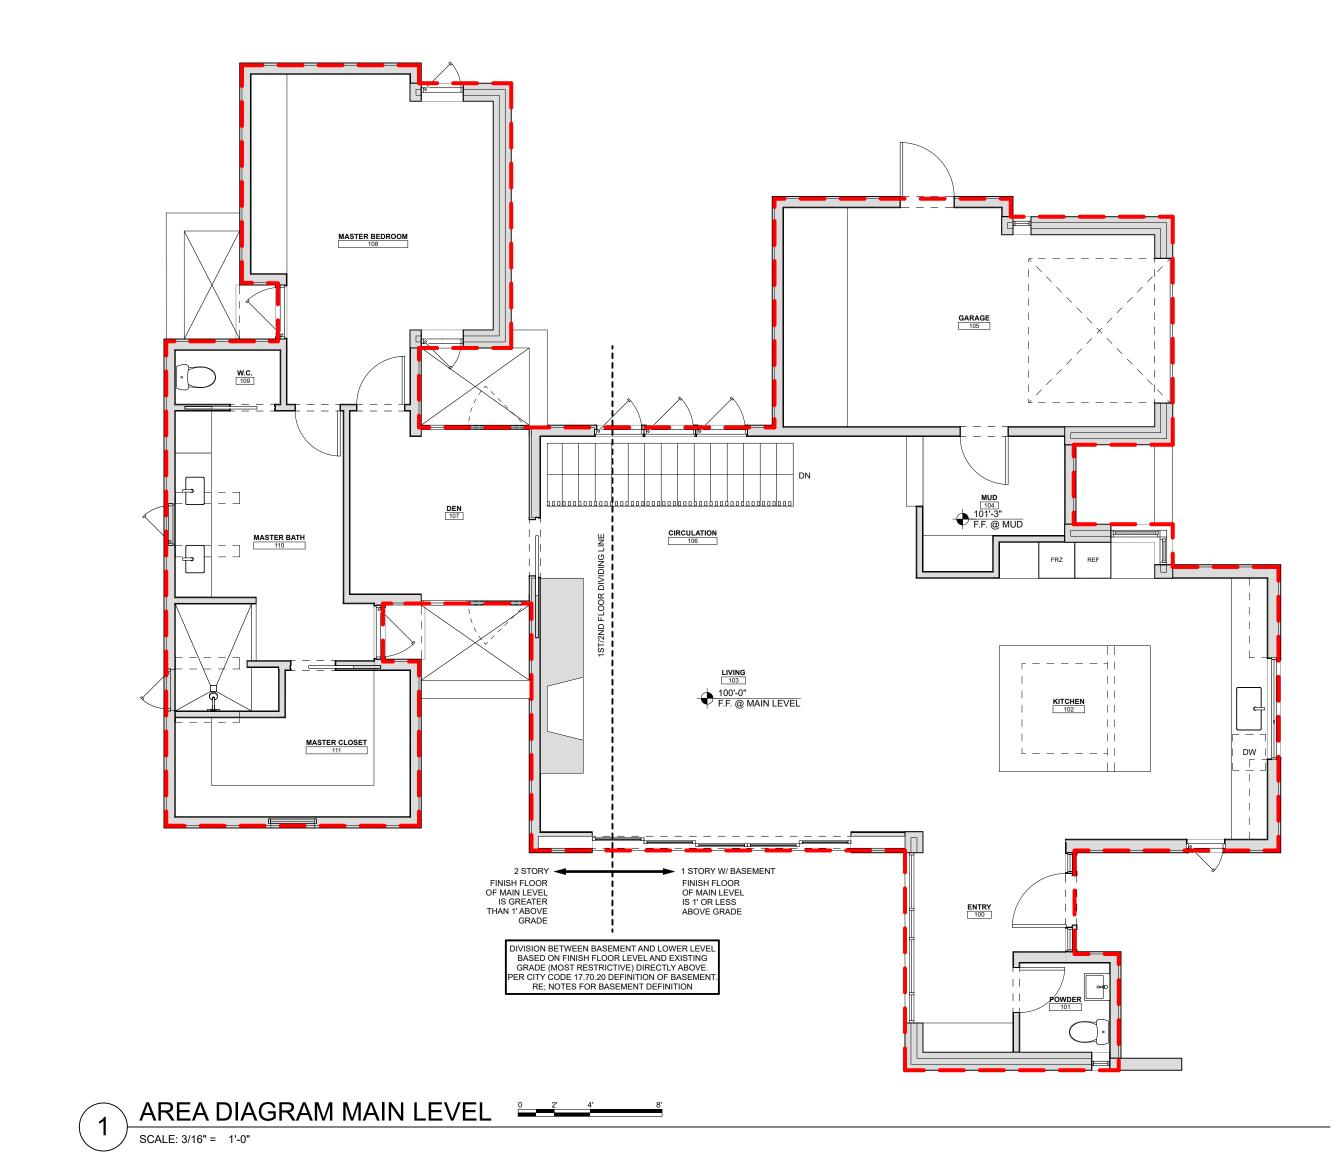

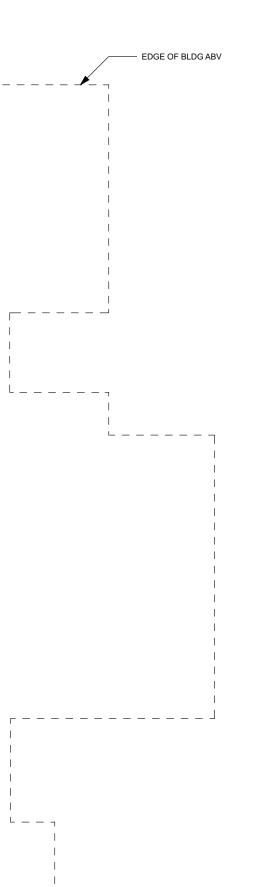

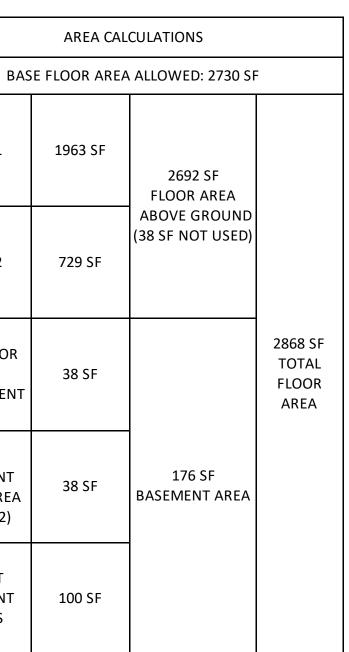

AREA CALCULATIONS





RAINEY RESIDENCE

CONTRACTOR:

DESIGNER:

STRUCTURAL ENGINEER: ENERGY CONSULTANT:

CIVIL ENGINEER: BENJAMINI, INC AVI BENJAMINI 720 YORK ST #114 SAN FRANCISCO, CA 94110 415.550.2600 STOCKER & ALLAIRE DAVID STOCKER 21 MANDEVILLE COURT MONTEREY, CA 93940 831.375.1890

 JOBE CORRAL ARCHITECTS
 STRANDBERG ENGINEER.
 ENERGY GONSDELTANT.

 JOBE CORRAL ARCHITECTS
 STRANDBERG ENGINEERING
 MONTEREY ENERGY GROUP, INC.

 ADA CORRAL, AIA
 DAVID STRANDBERG
 ABE STALLCUP

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 SUITE #8

 512.499.1591
 415.778.8726x101
 CARMEL, CA 93923

 831.372.8328
 Santerent Control (Santerent Control (San

LANDSCAPE ARCHITECT: JMLA JESSICA M. NEAFSEY 3345 7TH AVE CARMEL, CA 93923 734.904.9152

LIGHTING DESIGNER: STUDIO LUMINA CHRISTINA BROWN 9411 CHAPEL DOWN STREET AUSTIN, TX 78729 512.382.1656

NOTES:


1. BASEMENT DEFINITION PER CARMEL BY THE SEA MUNICIPAL CODE 17.70: 1. BASEMENT DEFINITION PER CARMEL BY THE SEA MUNICIPAL CODE 17.70: An underground room or excavated space between five and nine feet of interior height, finished or unfinished where the finished floor level directly above the space is not more than one foot above both the existing or final grade. Any subgrade space where the finished floor elevation directly above the space is more than one foot above existing or finished grade shall be considered above-ground space. All areas where the finished floor elevation directly above a subgrade space is more than five feet above either existing or final grade shall also be considered a story. (Note: In calculating the floor area of a basement it may be necessary to count part of the area in a floor level as basement and part of the area in a floor level as above-ground space.) Basement spaces may be used for any residential occupancy allowed by the Uniform Building Code such as bathrooms, family rooms, hobby rooms, offices, mechanical equipment, storage and, if equipped with window wells, bedrooms.

LEGEND:


ISSUE: CONCEPT PROJECT REVIEW 01.29.2021 PROJECT: RAINEY RESIDENCE JOHN AND KELLY RAINEY LINCOLN 5 SW OF 10TH CARMEL-BY-THE-SEA, CA 93923 when PROJECT NUMBER: Ada I. Corral 1914 02.05.2021 ALL DRAWINGS AND WRITTEN MATERIAL APPEARING HEREIN CONSTITUTE ORIGINAL AND UNPUBLISHED WORK OF THE ARCHITECT AND MAY NOT BE DUPLICATED, USED OR DISCLOSED WITHOUT THE WRITTEN CONSENT OF THE ARCHITECT. NORTH: SCALE: 3/16" = 1'-0" (3/32" = 1'-0" SCALE HALF SIZE 11X17) DRAWN BY: KK, LP



A2.13

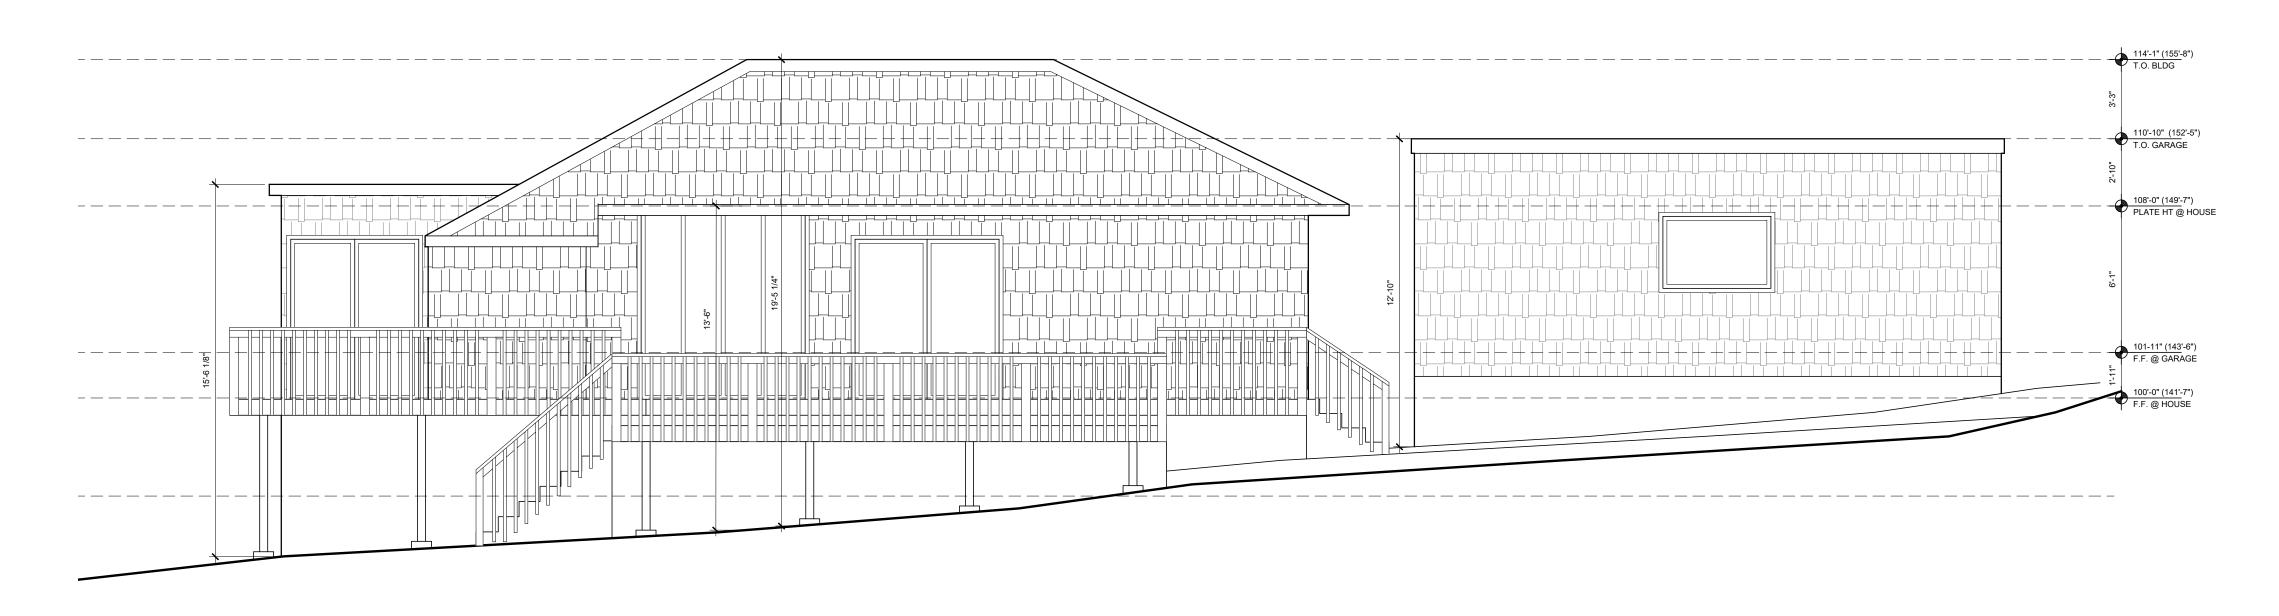



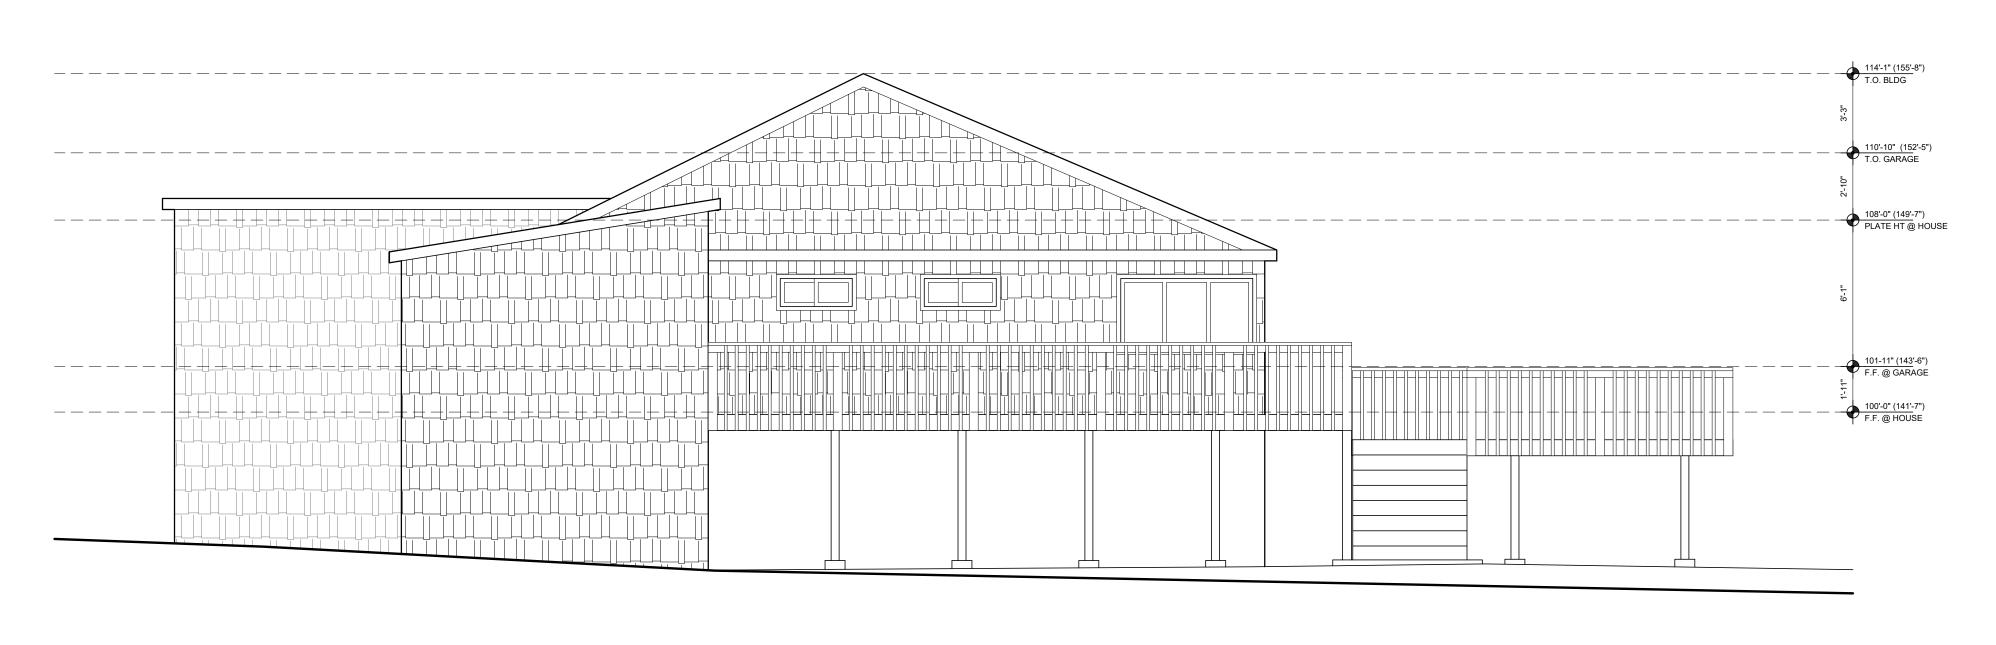





RAINEY RESIDENCE

CONTRACTOR: STOCKER & ALLAIRE DAVID STOCKER 21 MANDEVILLE COURT MONTEREY, CA 93940 831.375.1890

DESIGNER:

STRUCTURAL ENGINEER: ENERGY CONSULTANT:

CIVIL ENGINEER:

 JOBE CORRAL ARCHITECTS
 STRANDBERG ENGINEER.
 ENERGY GOODERATIONAL ENGINEERING

 JOBE CORRAL ARCHITECTS
 STRANDBERG ENGINEERING
 MONTEREY ENERGY GROUP, INC.

 ADA CORRAL, AIA
 DAVID STRANDBERG
 ABE STALLCUP

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 AUSTIN, TX 78705
 SAN FRANCISCO, CA 94103
 SUITE #8

 512.499.1591
 415.778.8726x101
 CARMEL, CA 93923

LANDSCAPE ARCHITECT:
 Civit Engineer.
 LANDSCAPE ARCHITEC

 BENJAMINI, INC
 JMLA

 AVI BENJAMINI
 JSSICA M. NEAFSEY

 720 YORK ST #114
 3345 7TH AVE

 SAN FRANCISCO, CA 94110
 CARMEL, CA 93923

 415.550.2600
 734.904.9152
 LIGHTING DESIGNER

STUDIO LUMINA CHRISTINA BROWN 9411 CHAPEL DOWN STREET AUSTIN, TX 78729 512.382.1656

NOTES: 1. 100'-0" FINISH FLOOR AT HOUSE = 141'-7" ABOVE SEA LEVEL

LEGEND:

CONCEPT PROJECT REVIEW

ISSUE:

01.29.2021

NORTH:

Ada I. Corral

PROJECT:

PROJECT NUMBER:

ALL DRAWINGS AND WRITTEN MA APPEARING HEREIN CONSTITUTE UNPUBLISHED WORK OF THE ARC NOT BE DUPLICATED, USED OR D

(1/8" = 1'-0" SCALE HALF SIZE 11X17)

KK, LP

1914

SCALE:

DRAWN BY:

EXISTING EXTERIOR

ELEVATIONS

A3.00


02.05.2021

RAINEY RESIDENCE

JOHN AND KELLY RAINEY LINCOLN 5 SW OF 10TH


CARMEL-BY-THE-SEA, CA 93923


1/4" = 1'-0", 1/4" =

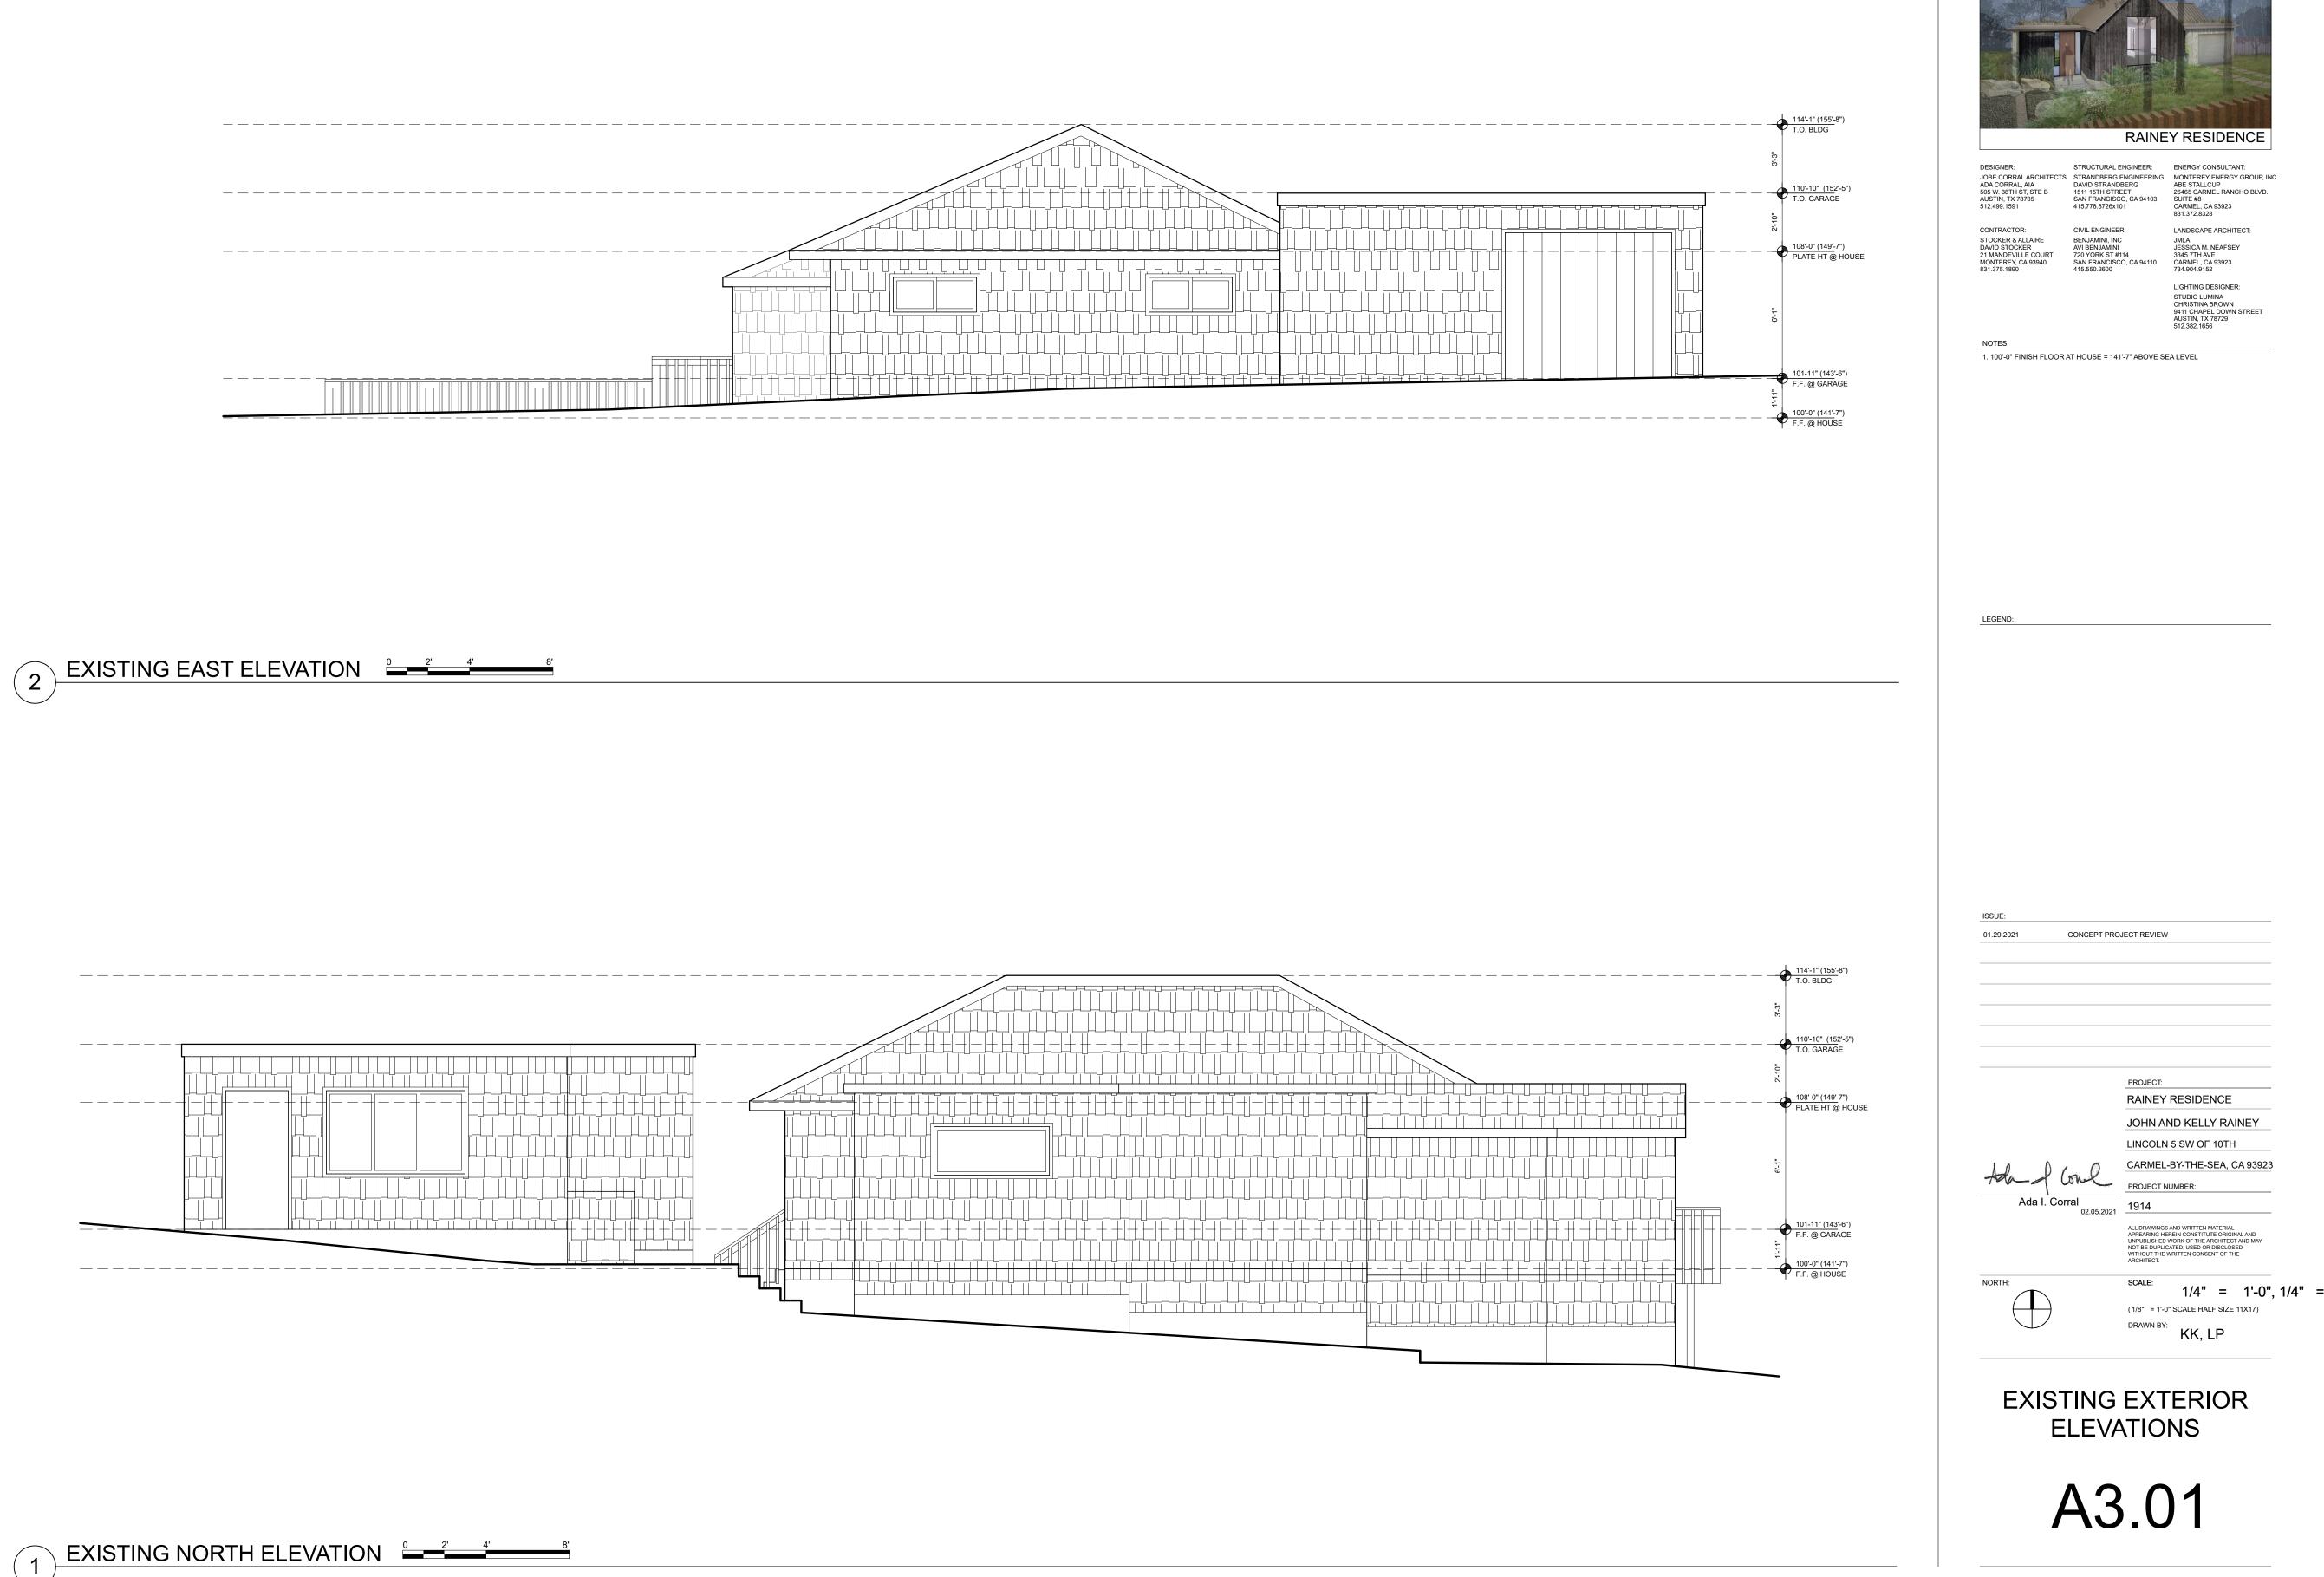


Architects



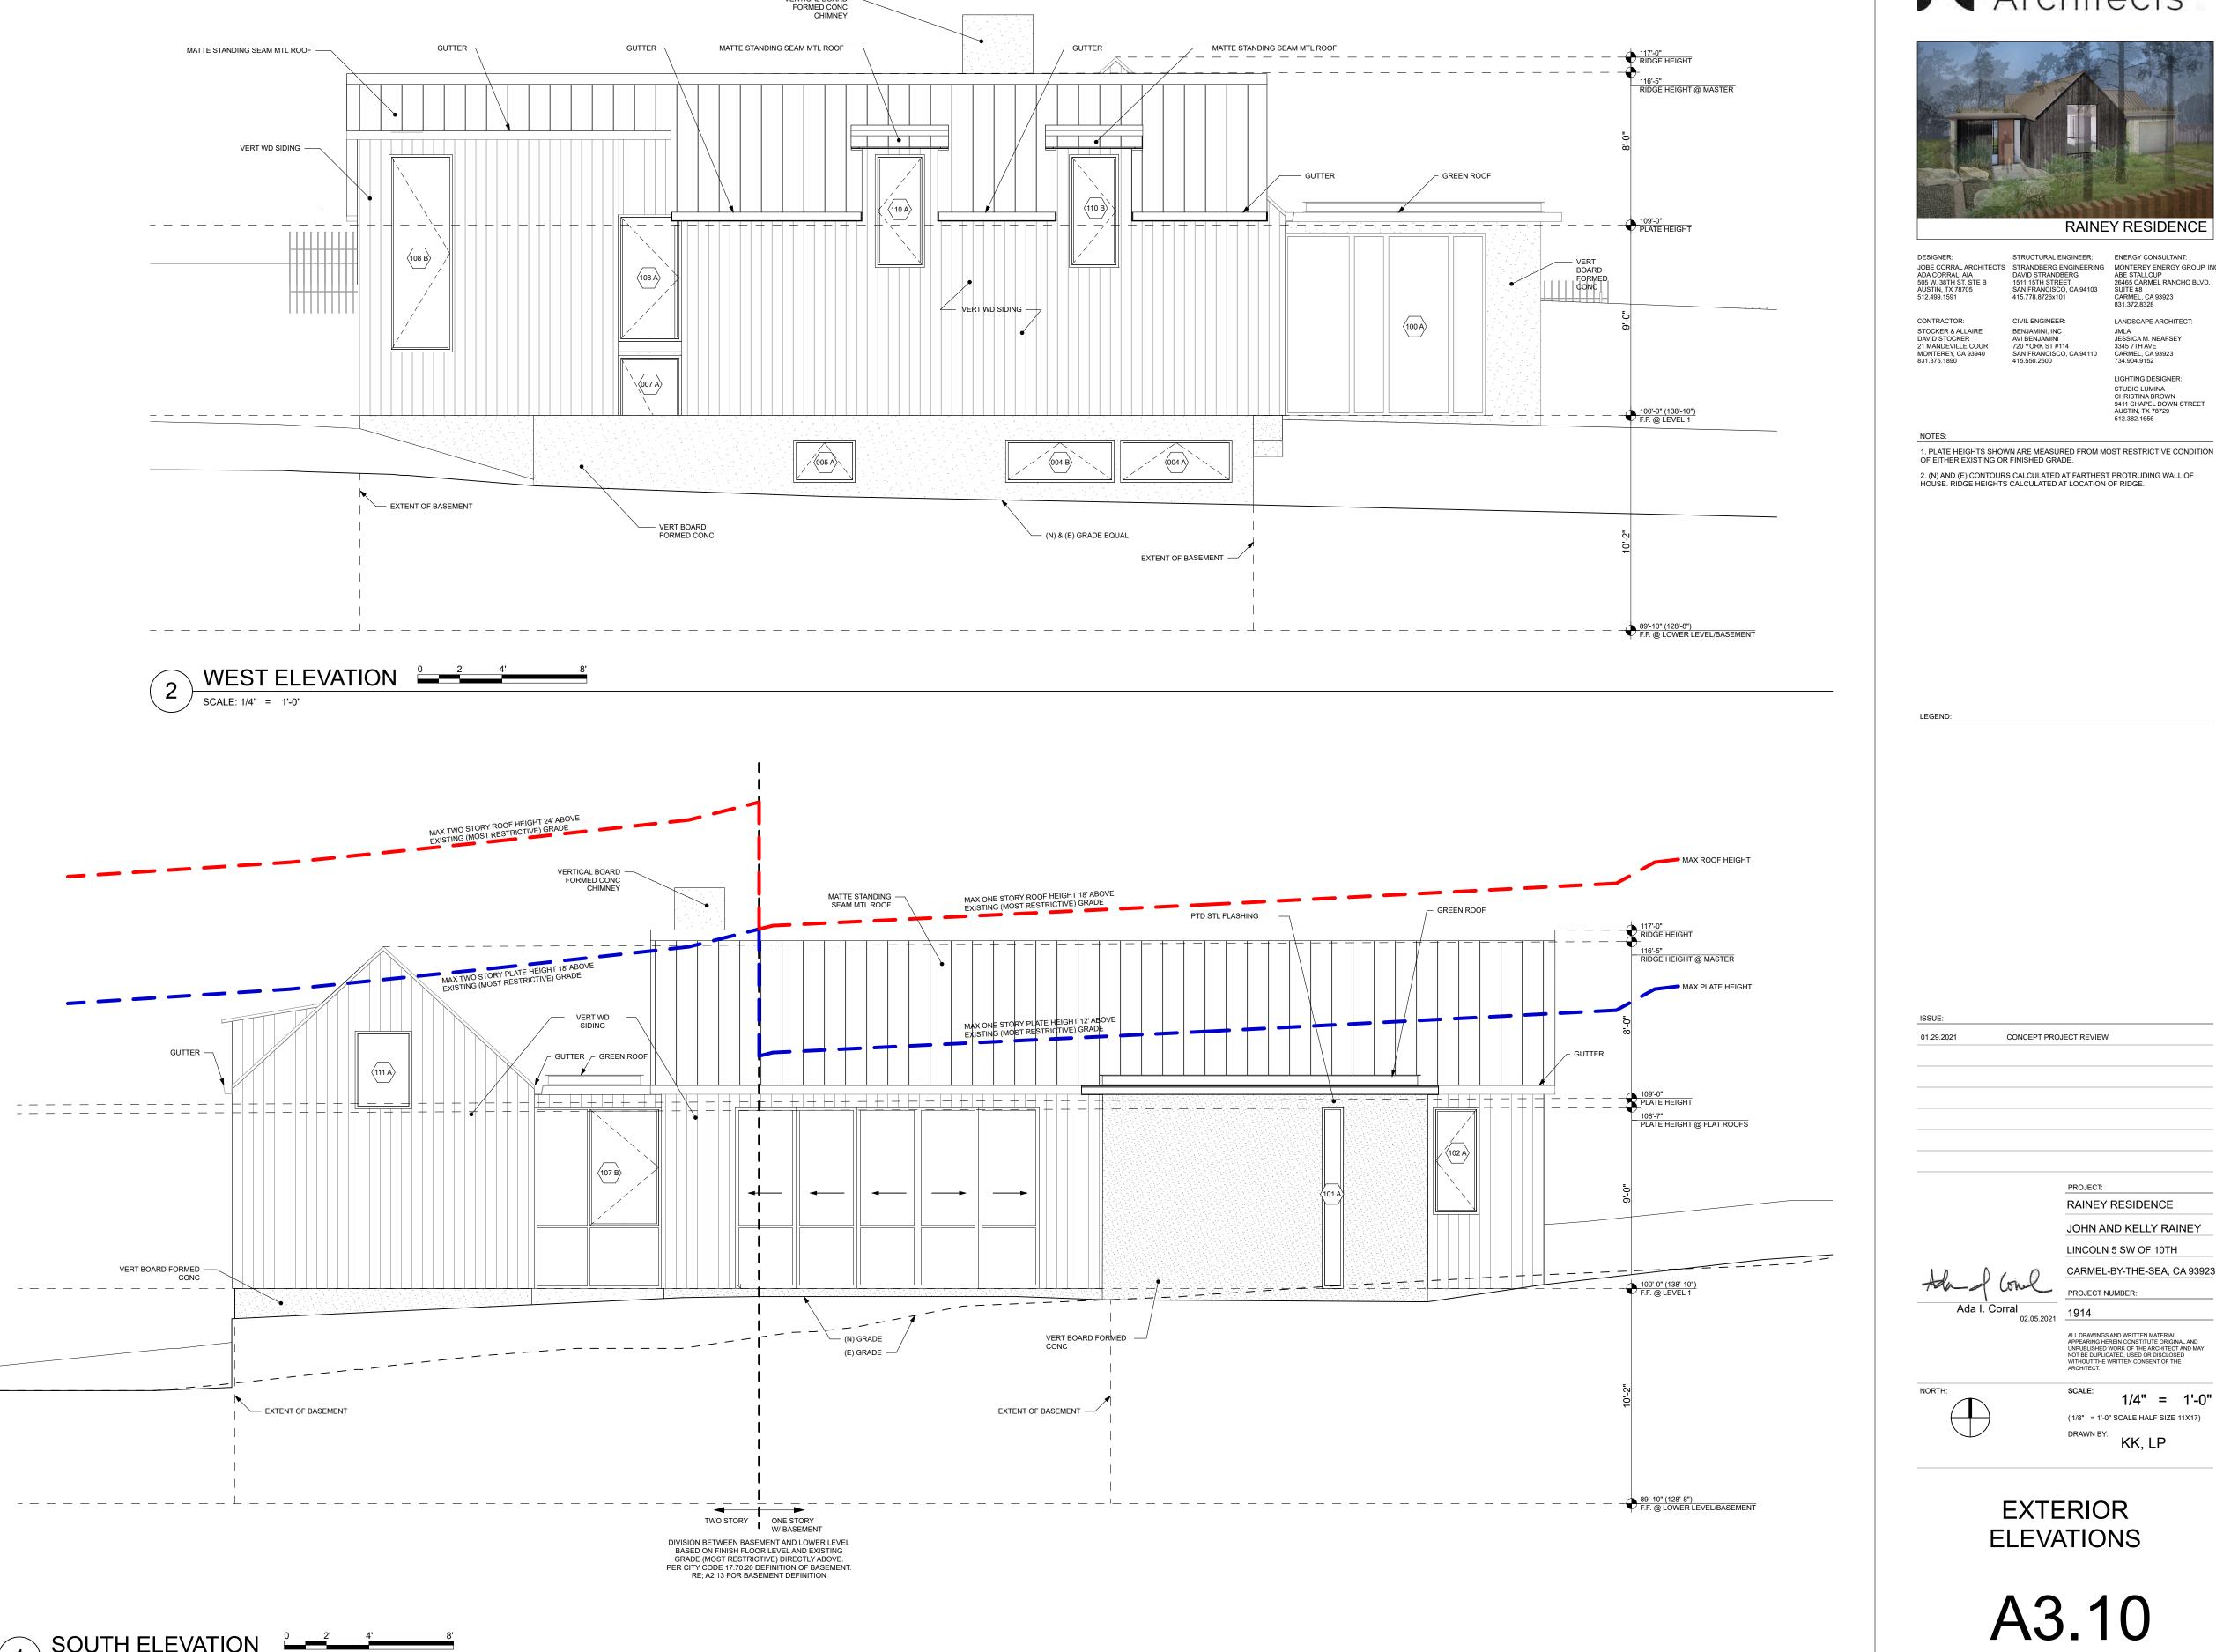

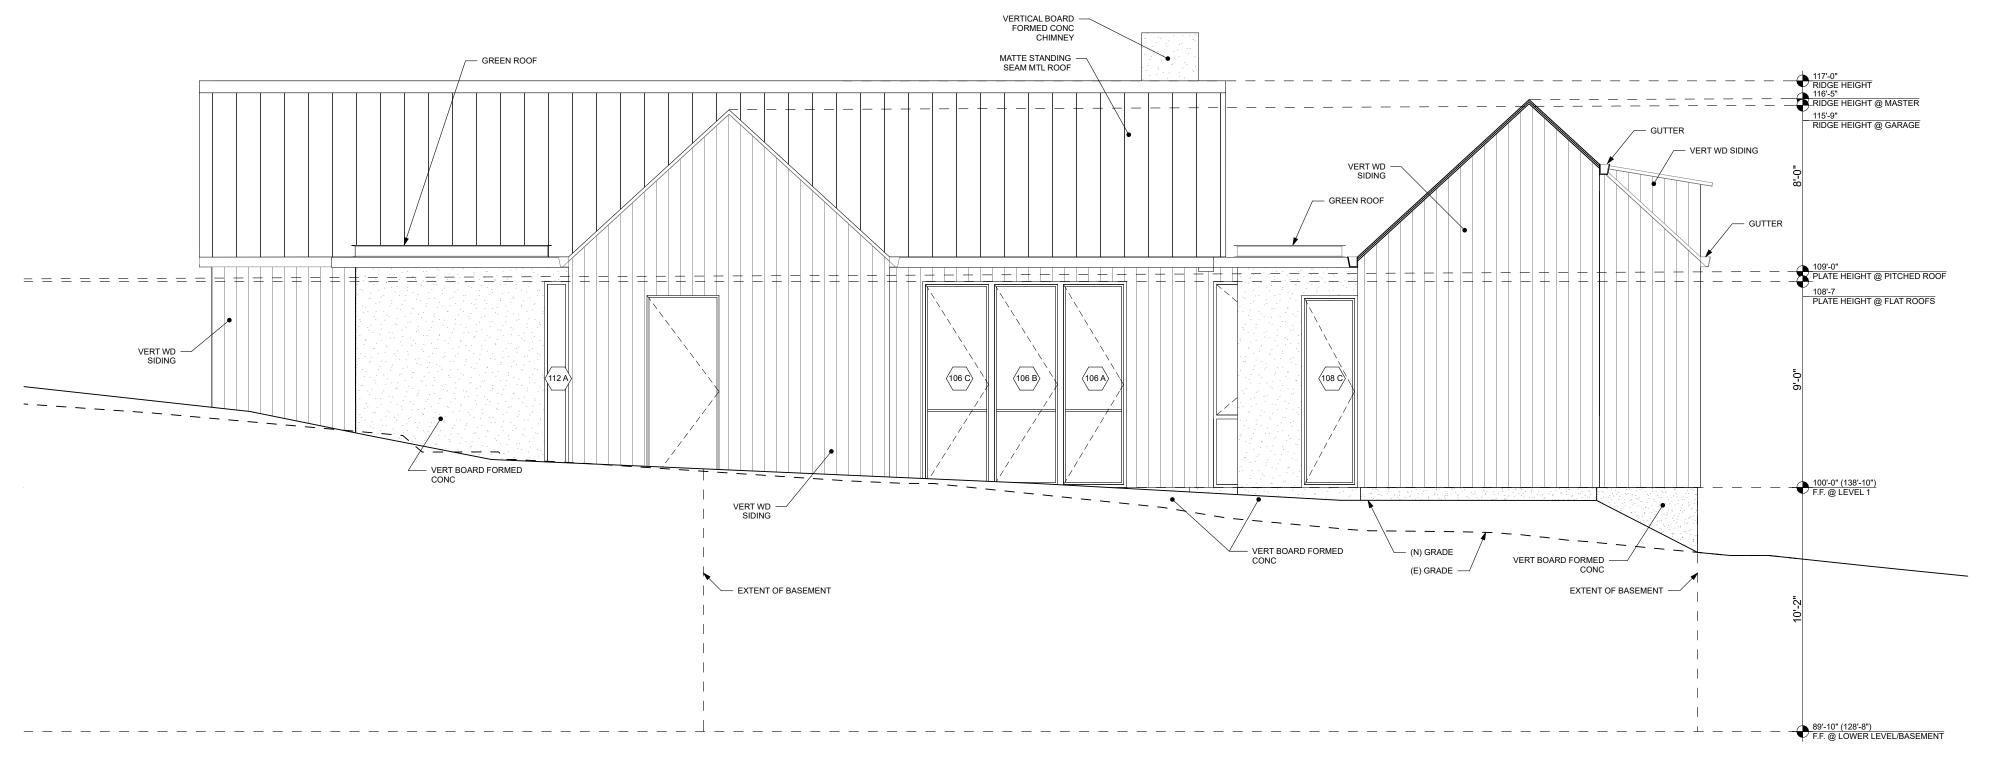



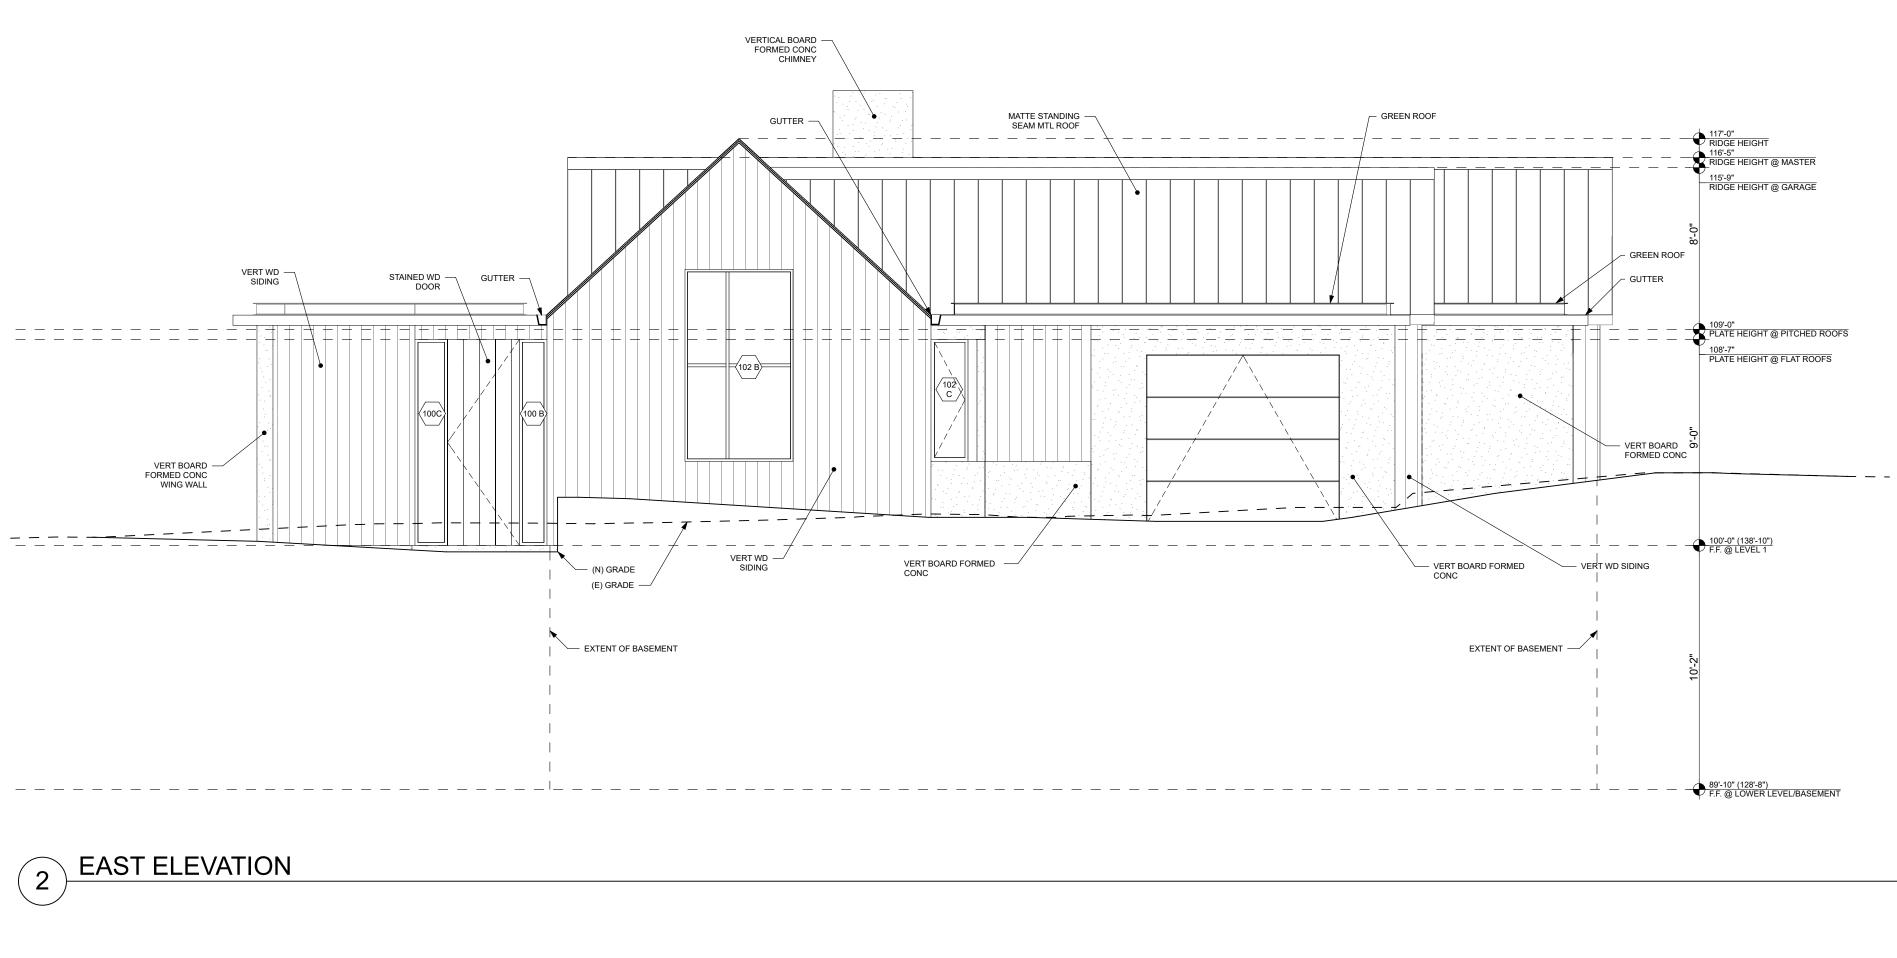





RAINEY RESIDENCE

DESIGNER:

CONTRACTOR:

CIVIL ENGINEER: BENJAMINI, INC AVI BENJAMINI 720 YORK ST #114 SAN FRANCISCO, CA 94110 415.550.2600 STOCKER & ALLAIRE DAVID STOCKER 21 MANDEVILLE COURT MONTEREY, CA 93940 831.375.1890

STRUCTURAL ENGINEER: ENERGY CONSULTANT:
 DESIGNER:
 STRUCTURAL ENGINEER:
 ENERGY CONSULTANT:

 JOBE CORRAL, ARCHITECTS
 STRANDBERG ENGINEERING
 MONTEREY ENERGY GROUP, INC.

 ADA CORRAL, AIA
 DAVID STRANDBERG
 ABE STALLCUP

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 AUST, TX 78705
 SAN FRANCISCO, CA 94103
 SUITE #8

 512.499.1591
 415.778.8726x101
 CARMEL, CA 93923

 831.372.8328

> LANDSCAPE ARCHITECT: JMLA JESSICA M. NEAFSEY 3345 7TH AVE CARMEL, CA 93923 734.904.9152 LIGHTING DESIGNER:

STUDIO LUMINA CHRISTINA BROWN 9411 CHAPEL DOWN STREET AUSTIN, TX 78729 512.382.1656

NOTES:

1. PLATE HEIGHTS SHOWN ARE MEASURED FROM MOST RESTRICTIVE CONDITION OF EITHER EXISTING OR FINISHED GRADE. 2. (N) AND (E) CONTOURS CALCULATED AT FARTHEST PROTRUDING WALL OF HOUSE. RIDGE HEIGHTS CALCULATED AT LOCATION OF RIDGE.

LEGEND:

ISSUE: 01.29.2021 CONCEPT PROJECT REVIEW PROJECT: RAINEY RESIDENCE JOHN AND KELLY RAINEY LINCOLN 5 SW OF 10TH CARMEL-BY-THE-SEA, CA 93923 Ada-s. Conel PROJECT NUMBER: Ada I. Corral 1914 02.05.2021 ALL DRAWINGS AND WRITTEN MATE APPEARING HEREIN CONSTITUTE O UNPUBLISHED WORK OF THE ARCH NOT BE DUPLICATED, USED OR DIS WITHOUT THE WRITTEN CONSENT NORTH: SCALE: 1/4" = 1'-0" (1/8" = 1'-0" SCALE HALF SIZE 11X17) DRAWN BY: KK, LP




EXTERIOR ELEVATIONS

A3.11





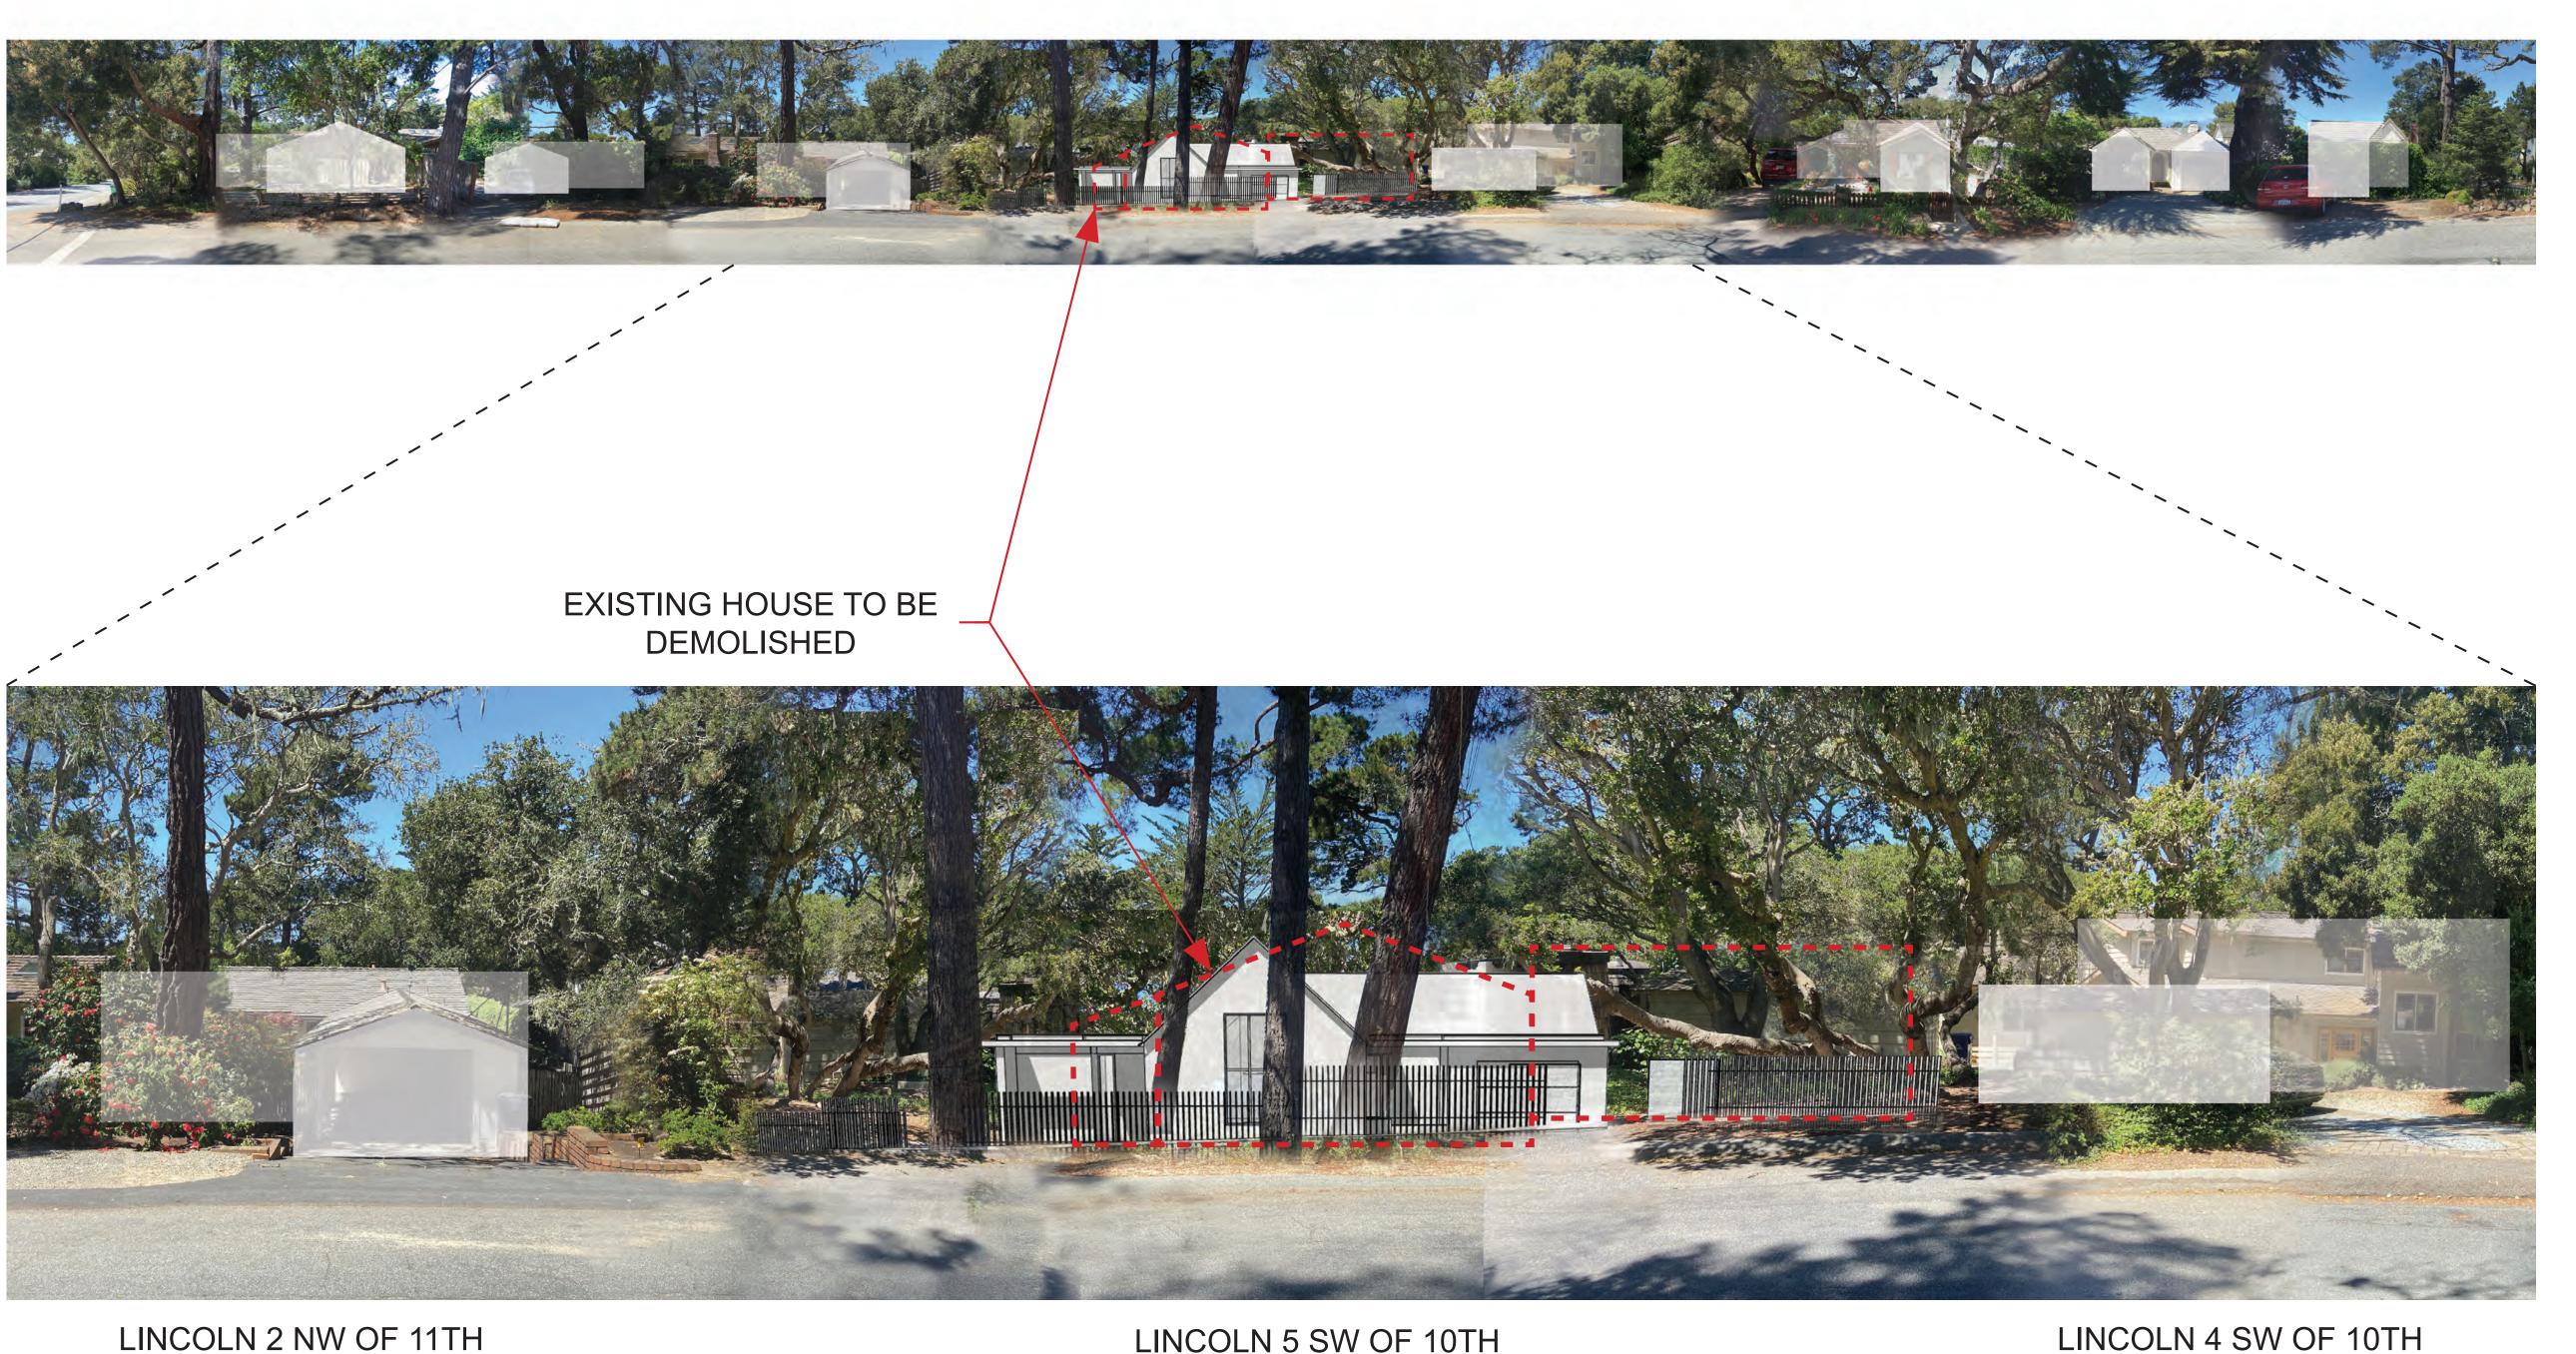

LINCOLN 5 SW OF 10TH

LINCOLN 4 SW OF 10TH





RAINEY RESIDENCE

CONTRACTOR: STOCKER & ALLAIRE DAVID STOCKER 21 MANDEVILLE COURT MONTEREY, CA 93940 831.375.1890

DESIGNER:

STRUCTURAL ENGINEER: JOBE CORRAL ARCHITECTS STRANDBERG ENGINE ADA CORRAL, AIA DAVID STRANDBERG 505 W. 38TH ST, STE B 1511 15TH STREET AUSTIN, TX 78705 SAN FRANCISCO, CA 94 512,499,1591 415.778.8726x101 1511 15TH STREET SAN FRANCISCO, CA 94103

> CIVIL ENGINEER: BENJAMINI, INC AVI BENJAMINI 720 YORK ST #114 SAN FRANCISCO, CA 94110 415.550.2600

ENERGY CONSULTANT MONTEREY ENERGY GROUP, IN ABE STALLCUP 26465 CARMEL RANCHO BLVD SUITE #8 CARMEL, CA 93923 831.372.8328

LANDSCAPE ARCHITECT JMLA JESSICA M. NEAFSEY 3345 7TH AVE CARMEL, CA 93923 734.904.9152

LIGHTING DESIGNE

NOTES:

ISSUE

01.29.2021

Ada I. Corral

NORTH:

CONCEPT PROJECT REVIEW

PROJECT:

RAINEY RESIDENCE

LINCOLN 5 SW OF 10TH

PROJECT NUMBER

1914

SCALE:

DRAWN BY:

STREETSCAPE

ELEVATION

A3.12

02.05.2021

JOHN AND KELLY RAINEY

CARMEL-BY-THE-SEA, CA 93923

N.T.S.

KK, LP



STUDIO LUMINA CHRISTINA BROWN 9411 CHAPEL DOWN S AUSTIN, TX 78729 512.382.1656





				4	\	N	Ν		×	Ν	,/
ID	001 A	003 A	003 B	003 C	004 A	Δ	004 B	004 C	00	05 A	
TYPE	CASEMENT	FIXED	FIXED	FIXED	AWNIN		AWNING	CASEMENT		NING	
١٨/	3'-0"	4'-2"	6'-0"	6'-0"	5'-3 1/-		5'-1 3/4"	3'-0"		-11"	
SIZE HT	6'-0"	6'-0"	6'-0"	6'-0"	2'-0"	"	2'-0"	6'-0"	2'	'-0"	
MATL	PTD STL	PTD STL	PTD STL	PTD STL	PTD S		PTD STL	PTD STL		D STL	
SILL HT ABV F.F.	3'-0"	3'-0"	0"	3'-0"	7'-0"	"	7'-0"	3'-0"	7'	'-0"	
NOTES											
VIEW FROM EXT.		9'-5 1/2" 3'-1 3/4" 1'-7 1/4" 3'-1" 1				4'-6" 1'-10" 2'-		5 1/2"	2'-8 3/4"	2'-9"	
ID	007 C	100 A	100 B	100C 101 A		102 B		02 C	102 D	106 A	
TYPE	FIXED	FIXED	FIXED	FIXED FIXED		FIXED			CASEMENT	CASEMENT	<u> </u>
SIZE W	4'-1 1/2"	<u>9'-5 1/2"</u> 8'-7"	<u> </u>	1'-4 1/4" 1'-0" 8'-7" 8'-7"		<u>4'-6"</u> 8'-0"		6 1/4"	2'-8 1/2"	2'-9" 8'-7"	
MATL	6'-0" PTD STL	PTD STL	PTD STL	8'-7" 8'-7" PTD STL PTD S		PTD STI		5'-1" D STL	5'-1" PTD STL	PTD STL	
SILL HT ABV F.F.	0"	0"	0"	0" 0"		3'-6"		3'-6"	3'-6"	0"	
NOTES				FROSTED							
				I							I
VIEW FROM EXT.	2'-10 1/2"	6'-0" 3'-4 1/2" 2'-7 1/2" "b'[8]-5 "b'[8]-5 "b'[<u>6'-0"</u> <u>2'-6"</u> <u>3'-6"</u> <u>5'1017</u> <u>8-1</u> <u>8-1</u>		3'-0"	2'-4"		2'-4" 10 10	2'-4"	3'-0"	
ID	106 C	107 A	107 B	108 A	108 B	108 C	108 D	110 A	110 B	110 C	
TYPE	CASEMENT	FIXED	FIXED	CASEMENT	FIXED	CASEMENT	CASEMENT	CASEMENT	CASEMENT	CASEMENT	
SIZE W	2'-10 1/2"	6'-0"	6'-0"	3'-0"	3'-0"	2'-4"	2'-4"	2'-4"	2'-4"	3'-0"	
HI HI	8'-7"	8'-7"	8'-7"	6'-0"	9'-4"	8'-0"	8'-0"	5'-4"	5'-4"	5'-7"	
MATL	PTD STL	PTD STL	PTD STL	PTD STL	PTD STL	PTD STL	PTD STL	PTD STL	PTD STL	PTD STL	
SILL HT ABV F.F.	0"	0"	0"	3'-6"	3'-0"	0"	0"	7'-0"	7'-0"	3'-6"	
NOTES											

					**		N	Ν		×	Ν
ID	001 A	003 A	003 B	003		004 A		004 B	004 C		005 A
TYPE	CASEMENT	FIXED	FIXED	FIXE		AWNING		AWNING	CASEMENT		WNING
SIZE W HT	3'-0"	<u>4'-2"</u> 6'-0"	6'-0" 6'-0"	6'-(5'-3 1/4	."	5'-1 3/4" 2'-0"	3'-0"		2'-11" 2'-0"
MATL	PTD STL	PTD STL	PTD STL	PTD		PTD ST	1	PTD STL	PTD STL		TD STL
SILL HT ABV F.F.	3'-0"	3'-0"	0"	3'-(7'-0"		7'-0"	3'-0"		7'-0"
NOTES											
VIEW FROM EXT. ID TYPE	4'-1 1/2" 1'-6" + 2'-7 1/2" 50 50 50 50 50 50 50 50 50 50	9'-5 1/2" 3'-1 3/4" 1'-7 1/4" 3'-1" 1'- 100 A FIXED 0' 5 1/2"	100 B FIXED	1'-4 1/4" 1'-4 1/4" 1'-4 1/4" 1'-4 1/4" 1'-4 1/4" 100C FIXED	1'-0" + + - - - - - - - - - - - - -	102 A CASEMENT	4'-6" 1'-10" 2'-8" 102 B FIXED 4' 6"			102 D CASEMENT	2'-9" 106 A CASEMENT 2' 0"
SIZE W HT	<u>4'-1 1/2"</u> 6'-0"	<u>9'-5 1/2"</u> 8'-7"	1'-1 3/4" 8'-7"	<u>1'-4 1/4"</u> 8'-7"	1'-0" 8'-7"	2'-2" 5'-1"	<u>4'-6"</u> 8'-0"		6 1/4" 5'-1"	2'-8 1/2" 5'-1"	2'-9" 8'-7"
MATL	PTD STL	PTD STL	PTD STL	PTD STL	PTD STL	PTD STL	PTD STL		D STL	PTD STL	PTD STL
SILL HT ABV F.F.	0"	0"	0"	0"	0"	3'-6"	3'-6"		3'-6"	3'-6"	0"
NOTES					FROSTED GLA						
VIEW FROM EXT.	2'-10 1/2" 	6'-0" 3'-4 1/2" 2'-7 1/2" "b[2-3] "b[2-3] "b[2		8	<u>3'-0"</u>	3'-0"	2'-4"	2'-4"	2'-4" 1 7'5	2'-4"	3'-0"
ID	106 C	107 A	107 B	1	08 A	108 B	108 C	108 D	110 A	110 B	110 C
TYPE	CASEMENT	FIXED	FIXED		EMENT	FIXED	CASEMENT	CASEMENT	CASEMENT	CASEMENT	CASEMENT
SIZE W	2'-10 1/2"	6'-0"	6'-0"		3'-0"	3'-0"	2'-4"	2'-4"	2'-4"	2'-4"	3'-0"
HI	8'-7"	8'-7"	8'-7"		6'-0"	9'-4"	8'-0"	8'-0"	5'-4"	5'-4"	5'-7"
MATL	PTD STL	PTD STL 0"	PTD STL 0"		D STL	PTD STL	PTD STL	PTD STL	PTD STL	PTD STL	PTD STL
SILL HT ABV F.F. NOTES	0"	U	U		3'-6"	3'-0"	0"	0"	7'-0"	7'-0"	3'-6"
				1	1		1	1	1	1	1

6'-0"

VI	EW FROM EXT.	3'-0" [0-9]	4'-2" , , , , , , , , , , , , ,		
	ID	001 A	003 A	003 B	
	TYPE	CASEMENT	FIXED	FIXED	
SIZE	_ W	3'-0"	4'-2"	6'-0"	
SIZE	HT	6'-0"	6'-0"	6'-0"	
	MATL	PTD STL	PTD STL	PTD STL	
SILL	. HT ABV F.F.	3'-0"	3'-0"	0"	
	NOTES				

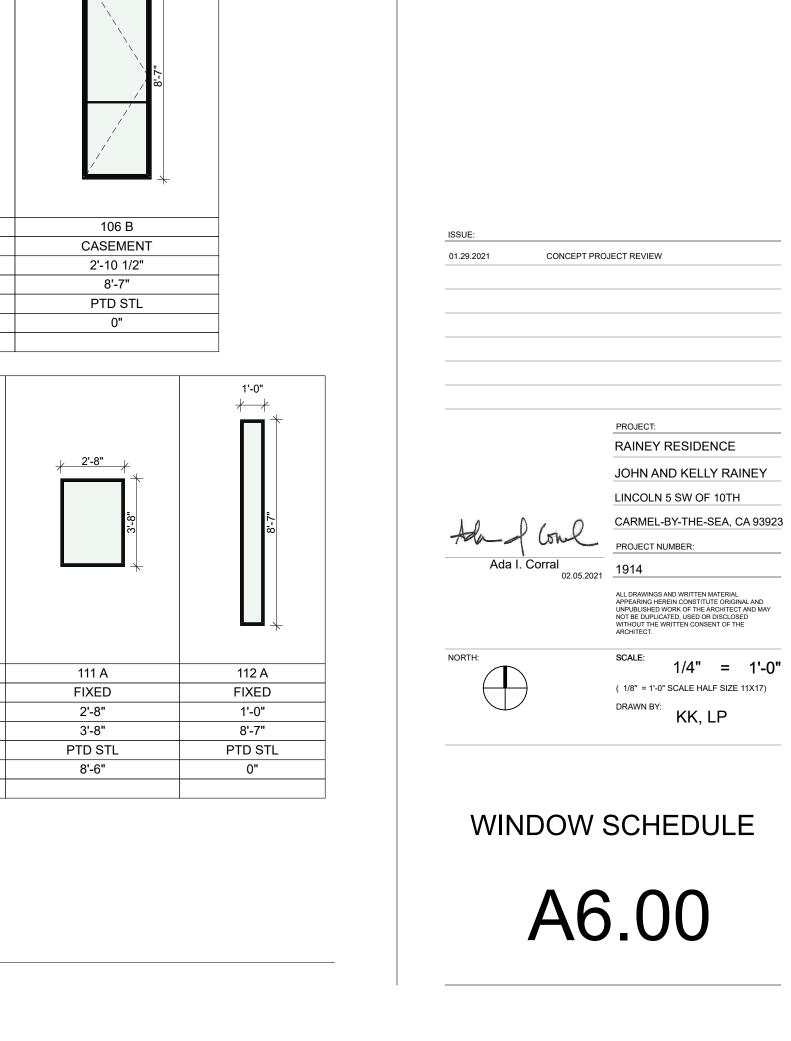

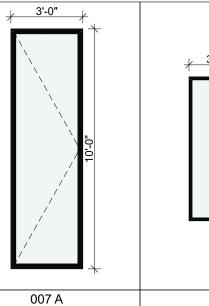


<u>+ 2'-10 1/2"</u>

<u>} 3'-0"</u>


<mark>+ 2'-11"</mark>

5'-1 3/4"

5'-3 1/4"

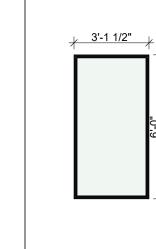

007 A	007 B
FIXED	FIXED
3'-0"	3'-1 1/2"
10'-0"	6'-0"
PTD STL	PTD STL
3'-0"	3'-0"

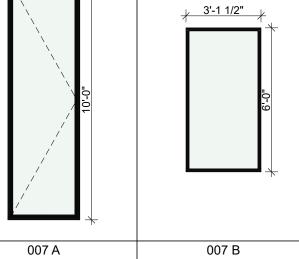

Jobe Cor	ra
Architects	



RAINEY RESIDENCE

LANDSCAPE ARCHITECT:
 CIVIL ENGINEER:
 LANDSCAPE ARCHITECT

 BENJAMINI, INC
 JMLA

 AVI BENJAMINI
 JESSICA M. NEAFSEY

 720 YORK ST #114
 3345 7TH AVE

 SAN FRANCISCO, CA 94110
 CARMEL, CA 93923

 415.550.2600
 734.904.9152

LIGHTING DESIGNER: STUDIO LUMINA CHRISTINA BROWN 9411 CHAPEL DOWN STREET AUSTIN, TX 78729 512,382,1656

NOTES:

LEGEND:

CONTRACTOR:


STOCKER & ALLAIRE DAVID STOCKER 21 MANDEVILLE COURT MONTEREY, CA 93940 831.375.1890


CIVIL ENGINEER:


DESIGNER:STRUCTURAL ENGINEER:ENERGY CONSULTANT:JOBE CORRAL ARCHITECTSSTRANDBERG ENGINEERING
DAVID STRANDBERGMONTEREY ENERGY GROUP, INC.605 W. 38TH ST, STE B1511 15TH STREET26465 CARMEL RANCHO BLVD.AUSTIN, TX 78705SAN FRANCISCO, CA 94103S11E #8512.499.1591415.778.8726x101CARMEL, CA 93923
831.372.8328

DOOR SCHEDULE $(\mathbf{1})$

			DOOR SCHEDULE						
NUMBER	TYPE	NUMBER OF PANELS	SIZE	INT/EXT	OPERATION	DOOR MATERIAL	NOTES		
001.1	A	1	3'-0"×9'-0"	INT	SWING	GLASS			
001.2	A	1	2'-0"×8'-0"	INT	SWING	PTD WD			
004.1	A	1	3'-6"×6'-8"	INT	POCKET	PTD WD			
004.2	A	2	4'-0"×8'-0"	INT	SWING	PTD WD			
005.1	A	1	2'-8"×8'-0"	INT	SWING	PTD WD			
006.1	A	1	2'-0"×8'-0"	INT	SWING	PTD WD			
007.1	A	1	3'-6"×6'-8"	INT	POCKET	PTD WD			
007.2	A	2	4'-0"×8'-0"	INT	SWING	PTD WD			
100.1	В	1	3'-0"×8'-7"	EXT	SWING	STAINED WD			
101.1	A	1	2'-6"×8'-0"	INT	SWING	PTD WD			
103.1	С	5	14'-4 1/2"×8'-7"	EXT	MULTISLIDE POCKET	STL/GLASS			
105.1	A	1	2'-8"×6'-8"	INT	SWING	PTD WD			
105.2	D	1	3'-0"×8'-0"	EXT	SWING	STL/GLASS			
105.3	E	1	8'-0"×7'-0"	EXT	OVERHEAD	ALUM			
107.1	A	1	3'-4"×6'-8"	INT	POCKET	PTD WD			
108.1	A	1	2'-8"×8'-0"	INT	SWING	PTD WD			
109.1	A	1	2'-6"×6'-8"	INT	POCKET	PTD WD			
110.1	A	1	2'-6"×8'-0"	INT	SWING	PTD WD			
111.1	A	1	2'-6"×6'-8"	INT	POCKET	PTD WD			

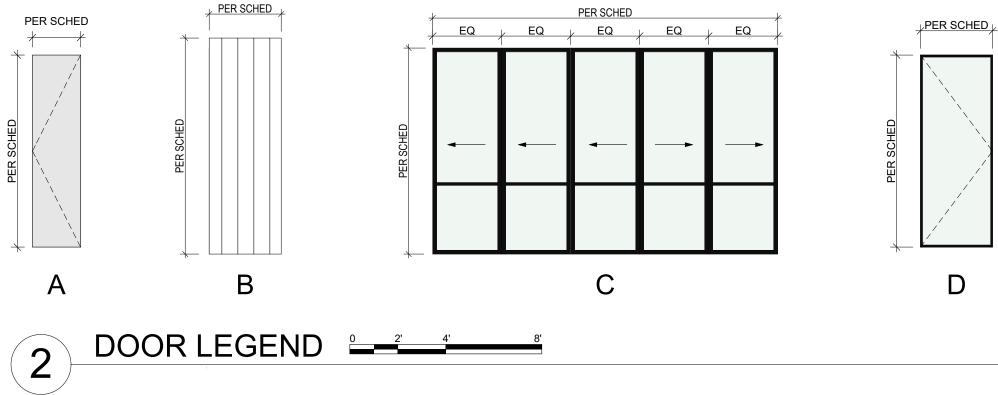

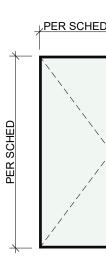

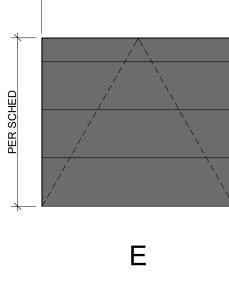

PER SCHED

RAINEY RESIDENCE STRUCTURAL ENGINEER: ENERGY CONSULTANT:
 JOBE CORRAL ARCHITECTS
 STRAUDBERG ENGINEER:
 ENERGY CONSULTANT:

 JOBE CORRAL ARCHITECTS
 STRANDBERG ENGINEERING
 MONTEREY ENERGY GROUP, INC.

 ADA CORRAL, AIA
 DAVID STRANDBERG
 ABE STALLCUP

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CIVIL ENGINEER: CONTRACTOR: STOCKER & ALLAIRE DAVID STOCKER 21 MANDEVILLE COURT MONTEREY, CA 93940 831.375.1890

LANDSCAPE ARCHITECT:
 OTVIL ENGINEER:
 LANDSCAPE ARCHIEC

 BENJAMINI, INC
 JMLA

 AVI BENJAMINI
 JESSICA M. NEAFSEY

 720 YORK ST #114
 3345 7TH AVE

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 CARMEL, CA 93923

 415.550.2600
 734.904.9152

LIGHTING DESIGNER: STUDIO LUMINA CHRISTINA BROWN 9411 CHAPEL DOWN STREET AUSTIN, TX 78729 512.382.1656

NOTES:

LEGEND:

ISSUE: 01.29.2021

Ada-1

NORTH:

Ada I. Corral

Coul

al ______1914

CONCEPT PROJECT REVIEW

PROJECT:

PROJECT NUMBER:

SCALE:

WINDOW & DOOR

SCHEDULE

A6.01

RAINEY RESIDENCE

JOHN AND KELLY RAINEY LINCOLN 5 SW OF 10TH

CARMEL-BY-THE-SEA, CA 93923

ALL DRAWINGS AND WRITTEN MATERIAL APPEARING HEREIN CONSTITUTE ORIGINAL AND UNPUBLISHED WORK OF THE ARCHITECT AND MAY NOT BE DUPLICATED, USED OR DISCLOSED WITHOUT THE WRITTEN CONSENT OF THE ARCHITECT.

(1/8" = 1'-0" SCALE HALF SIZE 11X17)

DRAWN BY: KK, LP

1/4" = 1'-0"


DESIGNER:

CONTRACTOR:








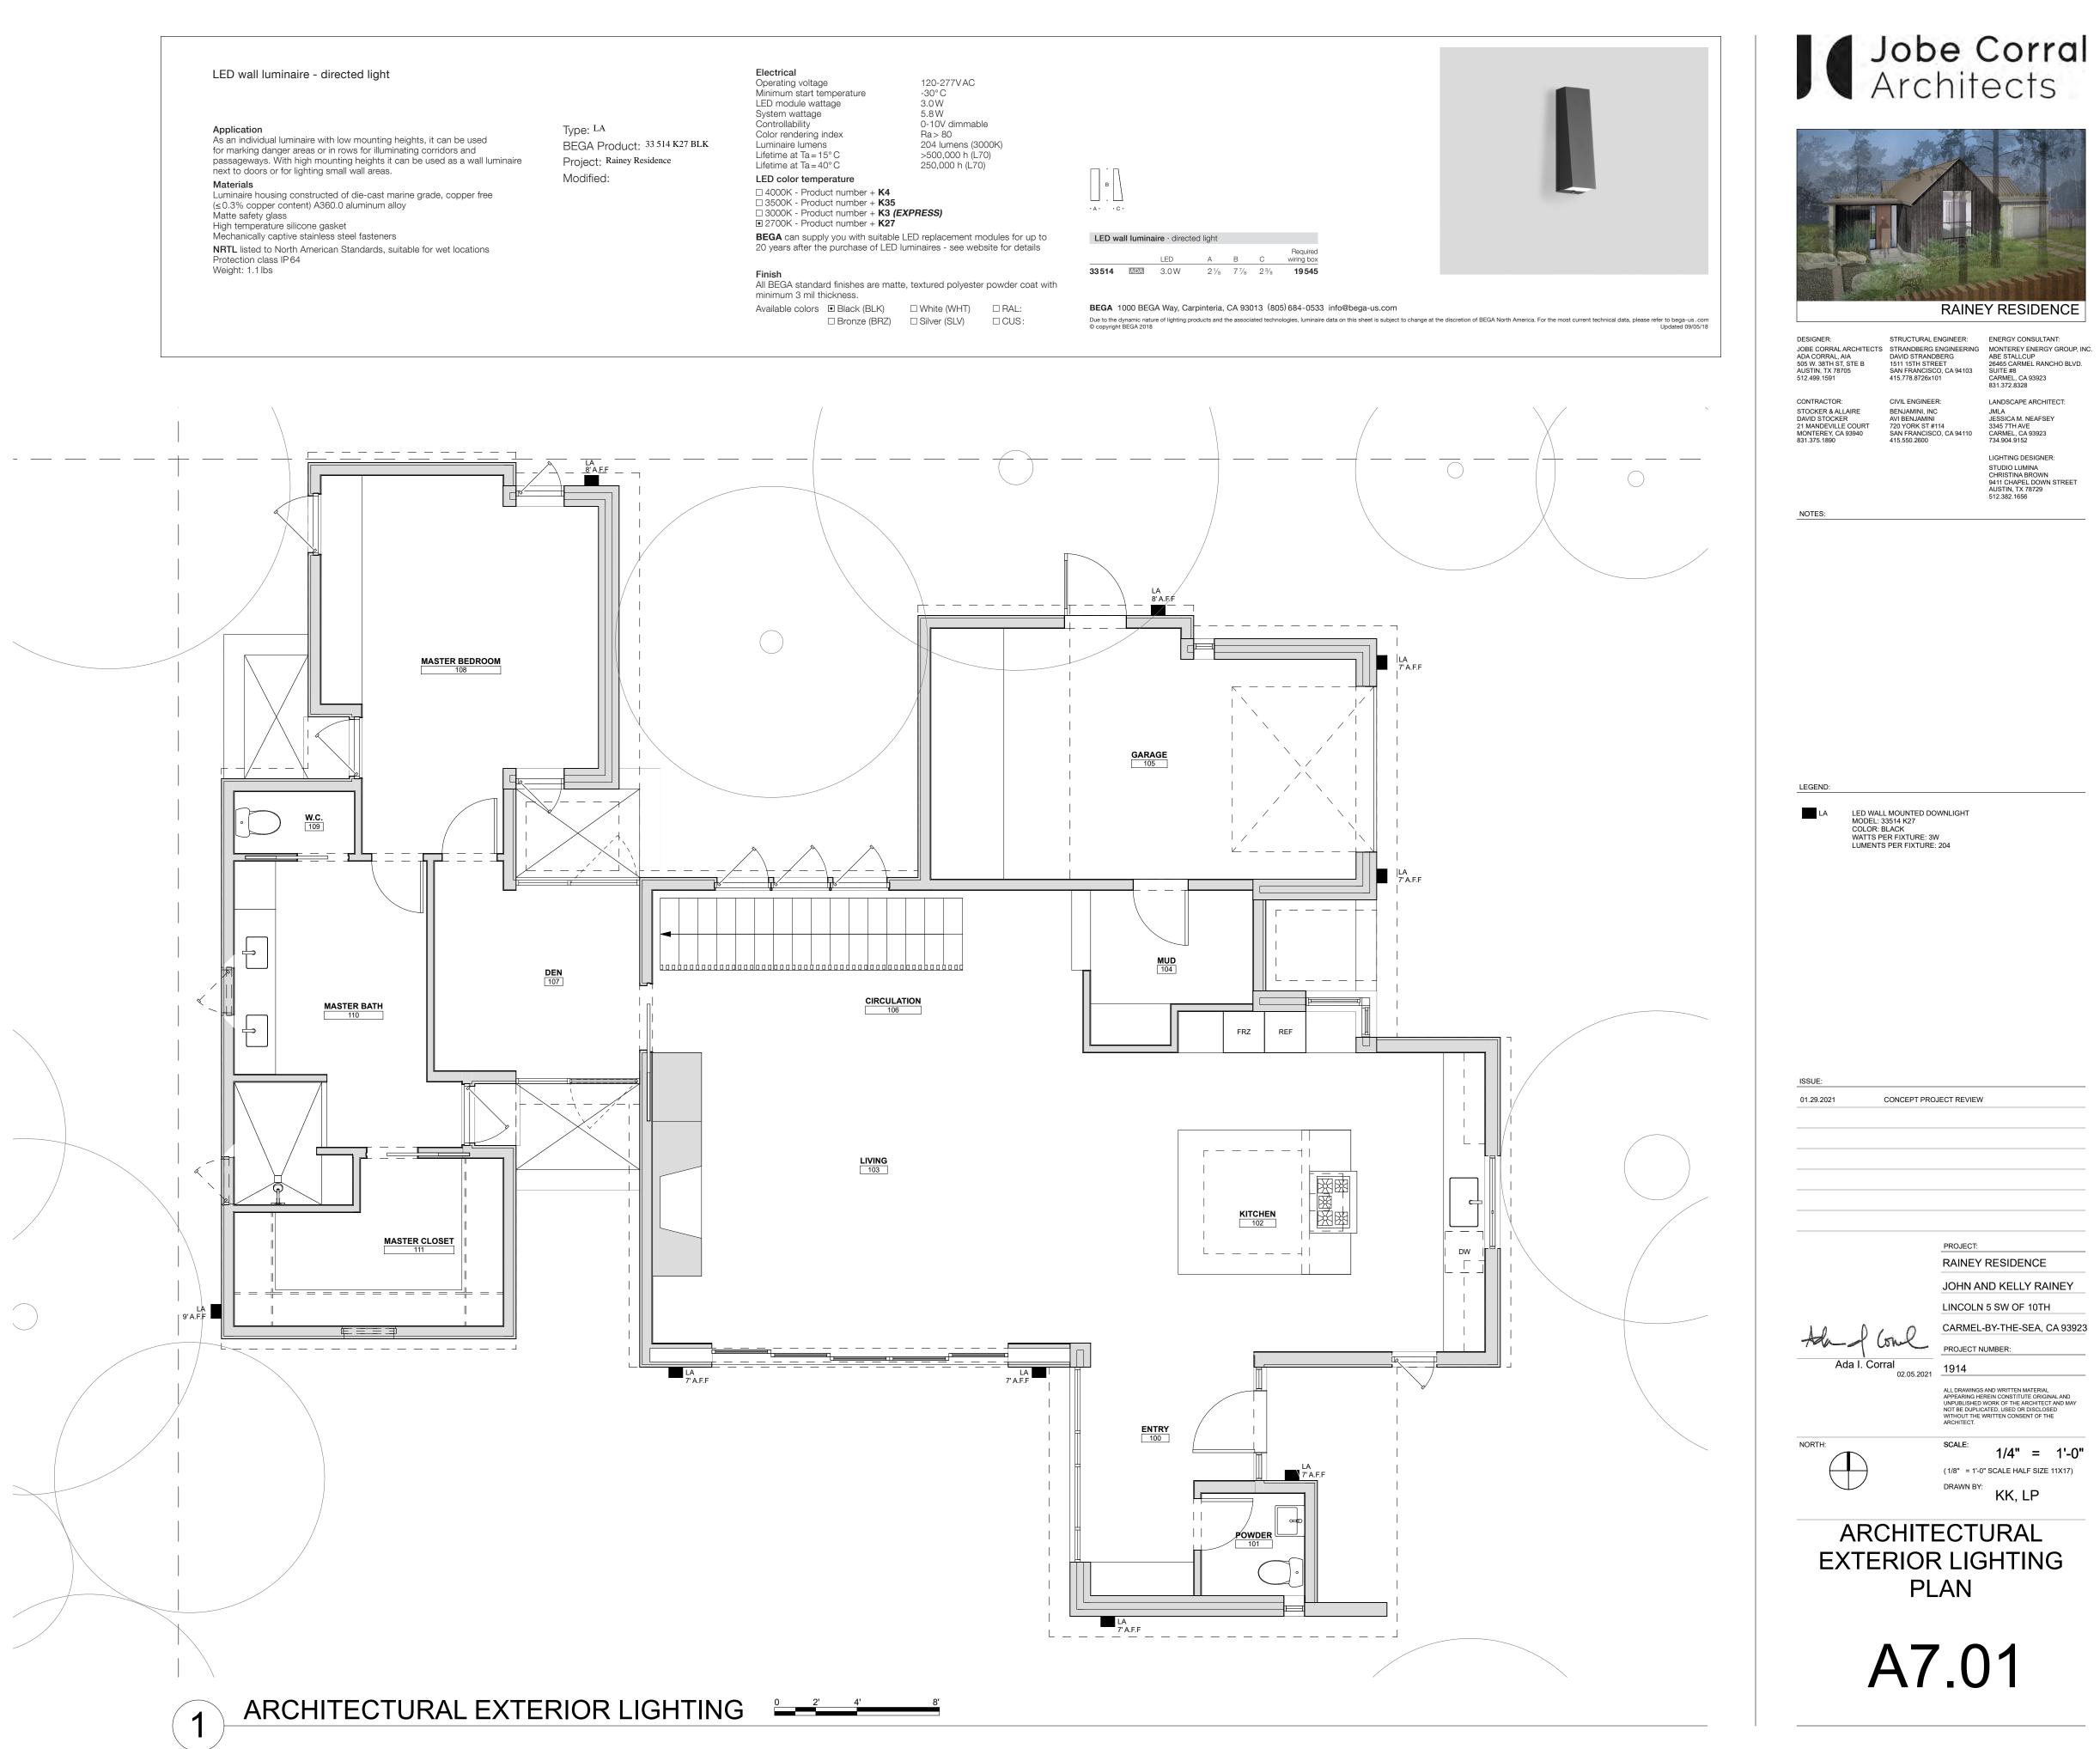




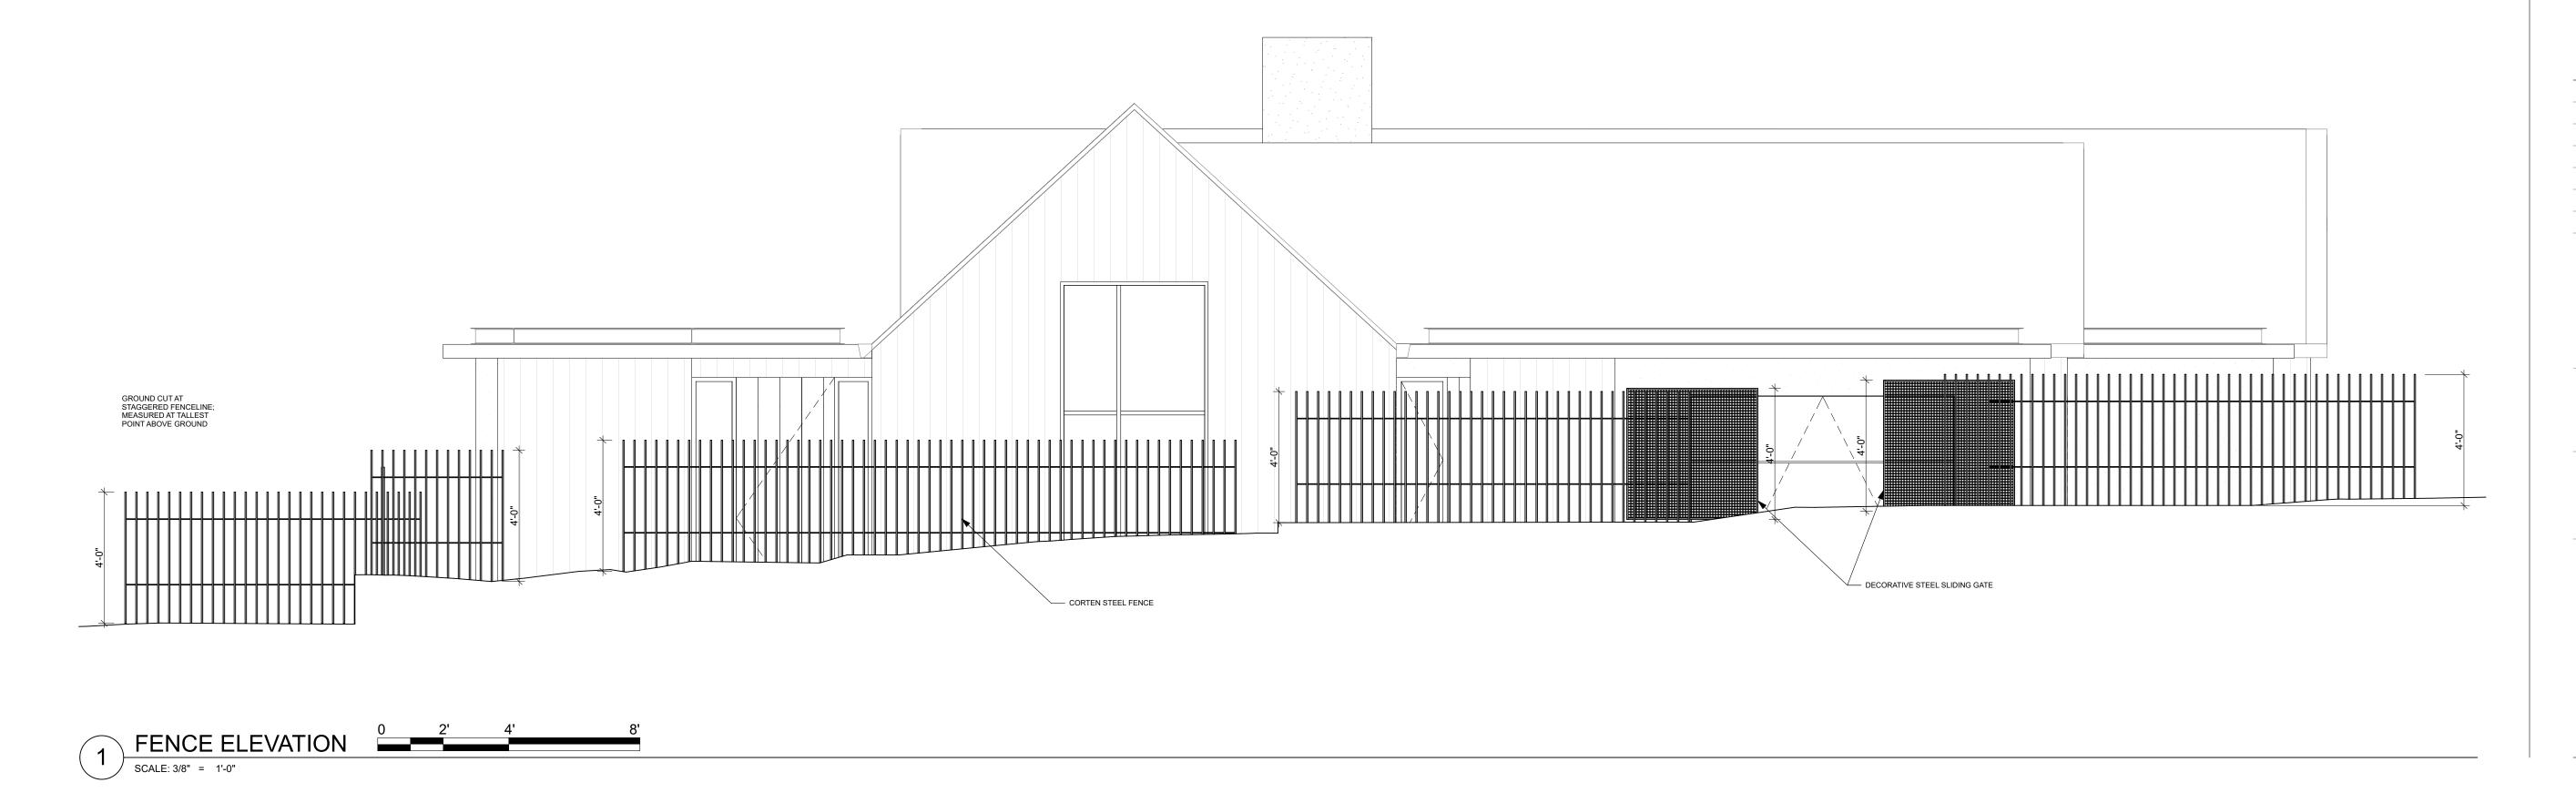



REFERENCE IMAGE FOR DECORATIVE STEEL ENTRY AND CAR GATES 4' TALL MAX STEEL, METAL MESH

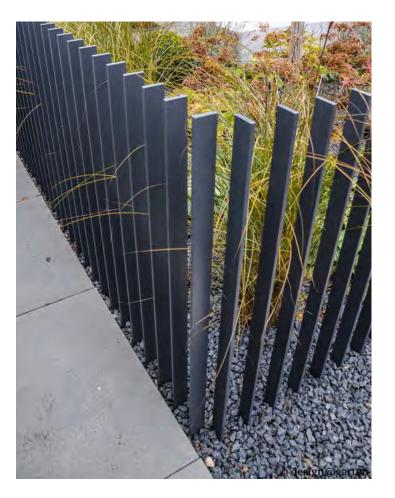

REFERENCE IMAGE FOR CORTEN FRONT FENCE 4' TALL MAX SHOWN PAINTED, PROPOSED AS CORTEN STEEL





RAINEY RESIDENCE

CONTRACTOR: STOCKER & ALLAIRE DAVID STOCKER 21 MANDEVILLE COURT MONTEREY, CA 93940 831.375.1890

DESIGNER:

NOTES:

STRUCTURAL ENGINEER: ENERGY CONSULTANT:

CIVIL ENGINEER: GIVIL ENGINEER: BENJAMINI, INC AVI BENJAMINI 720 YORK ST #114 SAN FRANCISCO, CA 94110 415.550.2600

 DESIGNER:
 STRUCTURAL EINGINEER.
 ENERGY GOUCLTANT.

 JOBE CORRAL ARCHITECTS
 STRANDBERG ENGINEERING
 MONTEREY ENERGY GROUP, INC.

 ADA CORRAL, AIA
 DAVID STRANDBERG
 ABE STALLCUP

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JMLA JESSICA M. NEAFSEY 3345 7TH AVE CARMEL, CA 93923 734.904.9152 LIGHTING DESIGNER

LANDSCAPE ARCHITECT:

STUDIO LUMINA CHRISTINA BROWN 9411 CHAPEL DOWN STREE AUSTIN, TX 78729 512.382.1656

LEGEND

ISSUE: CONCEPT PROJECT REVIEW 01.29.2021 PROJECT: RAINEY RESIDENCE JOHN AND KELLY RAINEY LINCOLN 5 SW OF 10TH CARMEL-BY-THE-SEA, CA 93923 Come Ada_ PROJECT NUMBER: Ada I. Corral 1914 02.05.2021 ALL DRAWINGS AND WRITTEN MATERIAL APPEARING HEREIN CONSTITUTE ORIGINAL AND UNPUBLISHED WORK OF THE ARCHITECT AND MAY NOT BE DUPLICATED, USED OR DISCLOSED WITHOUT THE WRITTEN CONSENT OF THE ARCHITECT. NORTH: SCALE: AS SHOWN



DRAWN BY:

KK, LP








FLAT GREEN ROOF REFERENCE L4.0 FOR PLANTING PLAN



MATTE STANDING SEAM ROOF STEELSCAPE METALS COLOR: VINTAGE



GATE - REF. TO A8.00

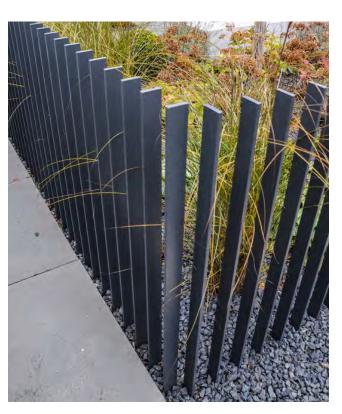

FENCE - REF. TO A8.00



EXTERIOR SIDING DELTA MILLWORKS ACCOYA - SB - BURNED AND BRUSHED - 1x6 WHITE WASH APPLIED BY CONTRACTOR



EXTERIOR SIDING VERTICAL BOARD FORM CONCRETE





RAINEY RESIDENCE

CONTRACTOR:

DESIGNER:

NOTES:

CIVIL ENGINEER: STOCKER & ALLAIRE DAVID STOCKER 21 MANDEVILLE COURT MONTEREY, CA 93940 831.375.1890

STRUCTURAL ENGINEER: ENERGY CONSULTANT:
 DESIGNER:
 STRANDBERG ENGINEER:

 JOBE CORRAL ARCHITECTS
 STRANDBERG ENGINEERING

 ADA CORRAL, AIA
 DAVID STRANDBERG

 505 W. 38TH ST, STE B
 1511 15TH STREET

 AUSTIN, TX 78705
 SAN FRANCISCO, CA 94103

 512.499.1591
 415.778.8726x101

GIVIL ENGINEEN: BENJAMINI, INC AVI BENJAMINI 720 YORK ST #114 SAN FRANCISCO, CA 94110 415.550.2600

MONTEREY ENERGY GROUP, INC. ABE STALLCUP 26465 CARMEL RANCHO BLVD. SUITE #8 CARMEL, CA 93923 831.372.8328 LANDSCAPE ARCHITECT:

JMLA JESSICA M. NEAFSEY 3345 7TH AVE CARMEL, CA 93923 734.904.9152 LIGHTING DESIGNER

STUDIO LUMINA CHRISTINA BROWN 9411 CHAPEL DOWN STREI AUSTIN, TX 78729 512.382.1656


ISSUE: CONCEPT PROJECT REVIEW 01.29.2021

> PROJECT: RAINEY RESIDENCE JOHN AND KELLY RAINEY LINCOLN 5 SW OF 10TH CARMEL-BY-THE-SEA, CA 93923 where PROJECT NUMBER: Ada I. Corral 02.05.2021 <u>1914</u> SCALE: N.T.S.

ALL DRAWINGS AND WRITTEN MATERIAL APPEARING HEREIN CONSTITUTE ORIGINAL AND UNPUBLISHED WORK OF THE ARCHITECT AND MA NOT BE DUPLICATED, USED OR DISCLOSED WITHOUT THE WRITTEN CONSENT OF THE KK, LP



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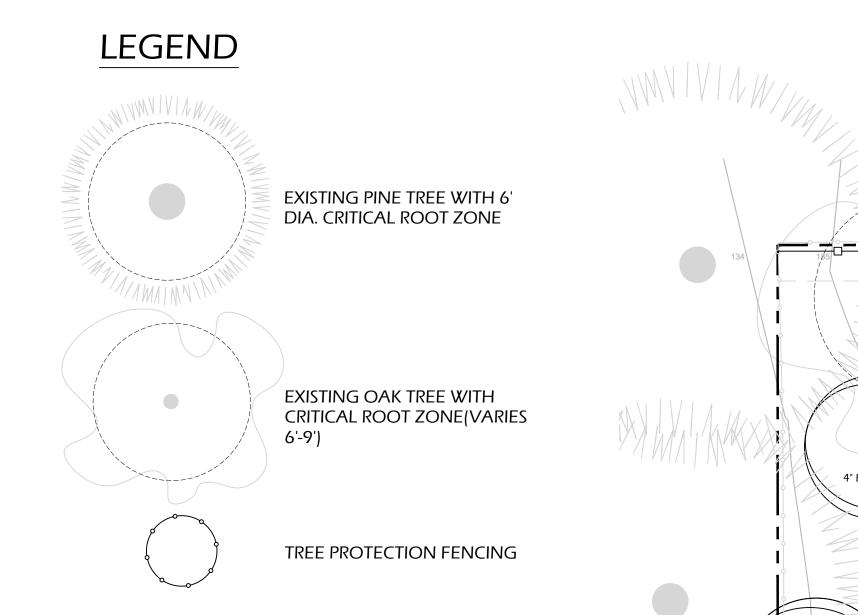


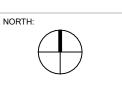



MATERIAL DETAILS


A9.00



NOTES

TREE PROTECTION

- 1. ALL TREES SHALL BE PRESERVED AND MAINTAINED IN GOOD CARE.
- 2. ALL TREES NOT SCHEDULED FOR REMOVAL SHALL BE PROTECTED FROM DAMAGE FROM CONSTRUCTION ACTIVITIES. TREE FENCING SHALL PROTECT TRUNKS, AND PREVENT SOIL COMPACTION INSIDE THECRITICAL ROOT ZONE. 3. BRIDGE OR TUNNEL UNDER MAJOR ROOTS TO AVOID DISTURBANCE WHEN
- EXPOSED FOR FOUNDATIONS OR UTILITY TRENCHING.

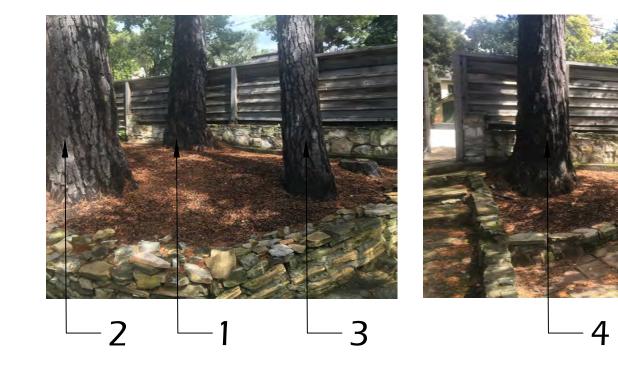




9)


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MAINN



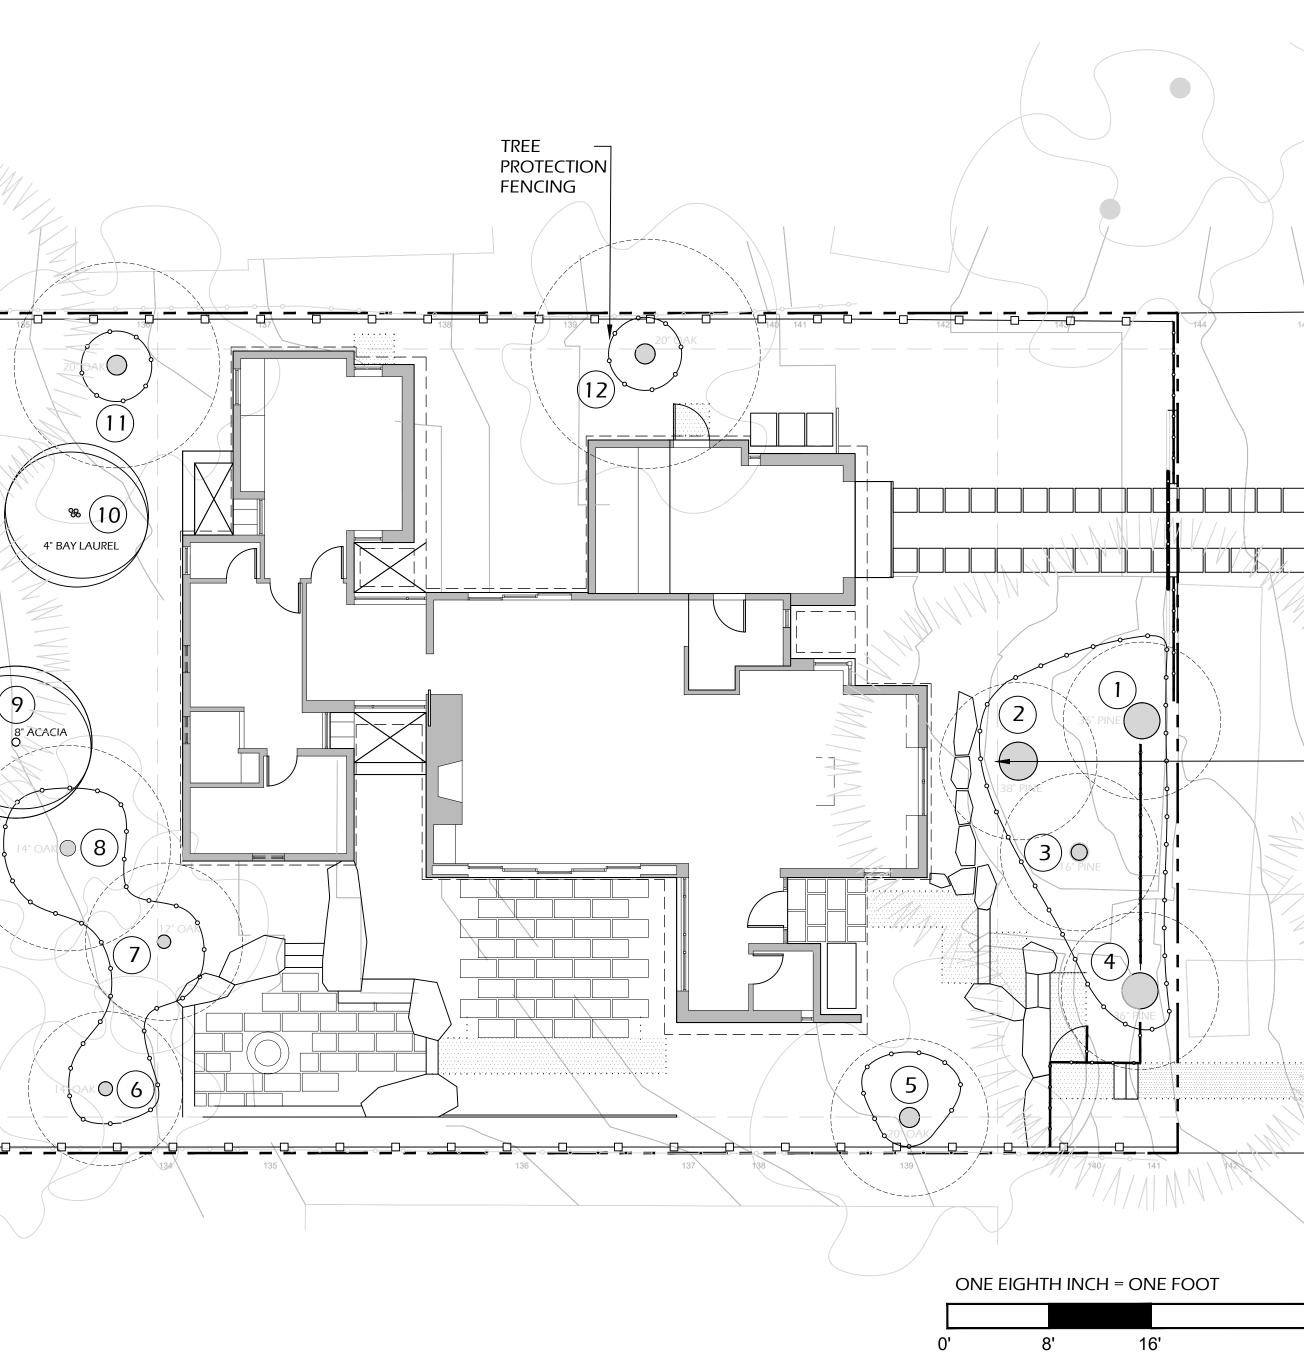



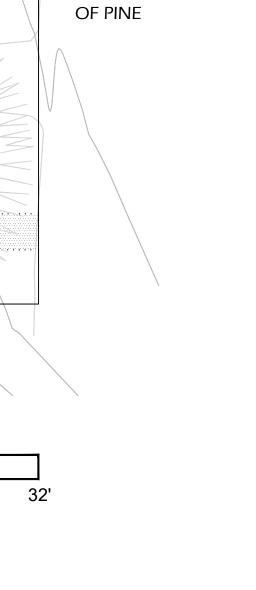

EXISTING stone RETAINING WALL ABUTS WEST EDGE

CONTRACTOR: STOCKER & ALLAIRE DAVID STOCKER 21 MANDEVILLE COURT MONTEREY, CA 93940 831.375.1890

DESIGNER:

CIVIL ENGINEER:

BENJAMINI, INC AVI BENJAMINI 720 YORK ST #114 SAN FRANCISCO, CA 94110 415.550.2600

LIGHTING DESIGNER:

STUDIO LUMINA CHRISTINA BROWN 9411 CHAPEL DOWN STREET AUSTIN, TX 78729 512.382.1656

JMLA JESSICA M. NEAFSEY 3345 7TH AVE CARMEL, CA 93923 734.904.9152

 JOBE CORRAL ARCHITECTS
 STROUTORAL ENGINEER:
 ENERGY CONSULTANT:

 JOBE CORRAL ARCHITECTS
 STRANDBERG ENGINEERING
 MONTERCY ENERGY GROUP,

 ADA CORRAL, AIA
 DAVID STRANDBERG
 INC.

 505 W. 38TH ST, STE B
 1511 15TH STREET
 ABE STALLCUP

 AUSTIN, TX 78705
 SAN FRANCISCO, CA 94103
 SUITE #8

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 415.778.8726x101
 CARMEL, CA 93923

 831.372.8328
 S31.372.8328
 LANDSCAPE ARCHITECT:

STRUCTURAL ENGINEER: ENERGY CONSULTANT:

RAINEY RESIDENCE

NOTES: 100'-0" = 137'-6" ABV SEA LEVEL

LEGEND

CONCEPT PROJECT REVIEW

CONCEPT PROJECT REVIEW

PROJECT:

RAINEY RESIDENCE

LINCOLN 5 SW OF 10TH

PROJECT NUMBER:

APPEARING HEREIN CONSTITUNPUBLISHED WORK OF THE NOT BE DUPLICATED, USED C

DRAWN BY: JMN

1914

SCALE

TREE PROTECTION

PLAN

L1.0

JOHN AND KELLY RAINEY

CARMEL-BY-THE-SEA, CA 93923

ISSUE: 01.29.2021 03.10.2021



JMLA



LANDSCAPE MATERIALS

NOTES

- 1. PROVIDE MOCK-UP SAMPLES FOR ITEMS REQUESTED, MOCK UPS TO BE REVIEWED BY JMLA
- 2. FOR PHOTO REFERENCES, REFER TO THIS SHEET

LANDSCAPE ELEMENT	PHOTO REFERENCE	MOCKUP REQUIRED
ASPHALT DRIVEWAY APRON	NONE	NO
FAUNE LIMESTONE FLAGSTONE + DRIVEWAY I BURNISHED FINISH (MAIDENSTONE)	PAVERS, 1	YES
GRAVEL PATHS - $\frac{3}{8}$ " YUMA TRINITY, ROUNDED	2	NO
FAUNE LIMESTONE STEPS (MAIDENSTONE)	3	YES
GRANITE BOULDERS	4	YES
BOARD-FORMED CONCRETE LOW RETAINING V	VALL 5	YES
CONCRETE FIRE FEATURE	6	NO
CEDAR PALING FENCE	7	NO
DRIVEWAY GATE - BY ARCHITECT	NONE	BY ARCHITECT
FRONT FENCE - BY ARCHITECT	NONE	BY ARCHITECT
TRENCH AND AREA DRAINS - BY CIVIL	NONE	BY CIVIL



1













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6





RAINEY RESIDENCE

DESIGNER:

CONTRACTOR:

CIVIL ENGINEER:

 STOCKER & ALLAIRE
 BENJAMINI, INC
 JMLA

 DAVID STOCKER
 AVI BENJAMINI
 JESSICA M. NEAFSEY

 21 MANDEVILLE COURT
 720 YORK ST #114
 3345 7TH AVE

 MONTEREY, CA 93940
 SAN FRANCISCO, CA 94110
 CARMEL, CA 93923

 831.375.1890
 415.550.2600
 734.904.9152
 LIGHTING DESIGNER:

STUDIO LUMINA CHRISTINA BROWN 9411 CHAPEL DOWN STREET AUSTIN, TX 78729 512.382.1656

NOTES: 100'-0" = 137'-6" ABV SEA LEVEL

LEGEND:

CONCEPT PROJECT REVIEW

NDSCA

Gran May Ales

B2 28 2021 Renewal Oate

CA

NORTH:

PROJECT:

RAINEY RESIDENCE

LINCOLN 5 SW OF 10TH

PROJECT NUMBER:

1914

SCALE:

LANDSCAPE

MATERIALS

L2.0

DRAWN BY: JMN

JOHN AND KELLY RAINEY

CARMEL-BY-THE-SEA, CA 93923

ALL DRAWINGS AND WRITTEN MATERIAL APPEARING HEREIN CONSTITUTE ORIGINAL AND UNPUBLISHED WORK OF THE ARCHITECT AND MA' NOT BE DUPLICATED, USED OR DISCLOSED WITHOUT THE WRITTEN CONSENT OF THE ARCHITECT.

1/8" = 1'-0"

ISSUE:

01.29.2021

STRUCTURAL ENGINEER: ENERGY CONSULTANT:
 JOBE CORRAL ARCHITECTS
 STRUCTURAL ENGINEER:
 ENERGY CONSULTANT:

 JOBE CORRAL ARCHITECTS
 STRANDBERG ENGINEERING
 MONTEREY ENERGY GROUP,

 ADA CORRAL, AIA
 DAVID STRANDBERG
 INC.


 505 W. 38TH ST, STE B
 1511 15TH STREET
 ABE STALLCUP


 AUSTIN, TX 78705
 SAN FRANCISCO, CA 94103
 SUITE #8

 512.499.1591
 415.778.8726x101
 CARMEL, CA 93923

 831.372.8328
 S31.872.8328

LANDSCAPE ARCHITECT:

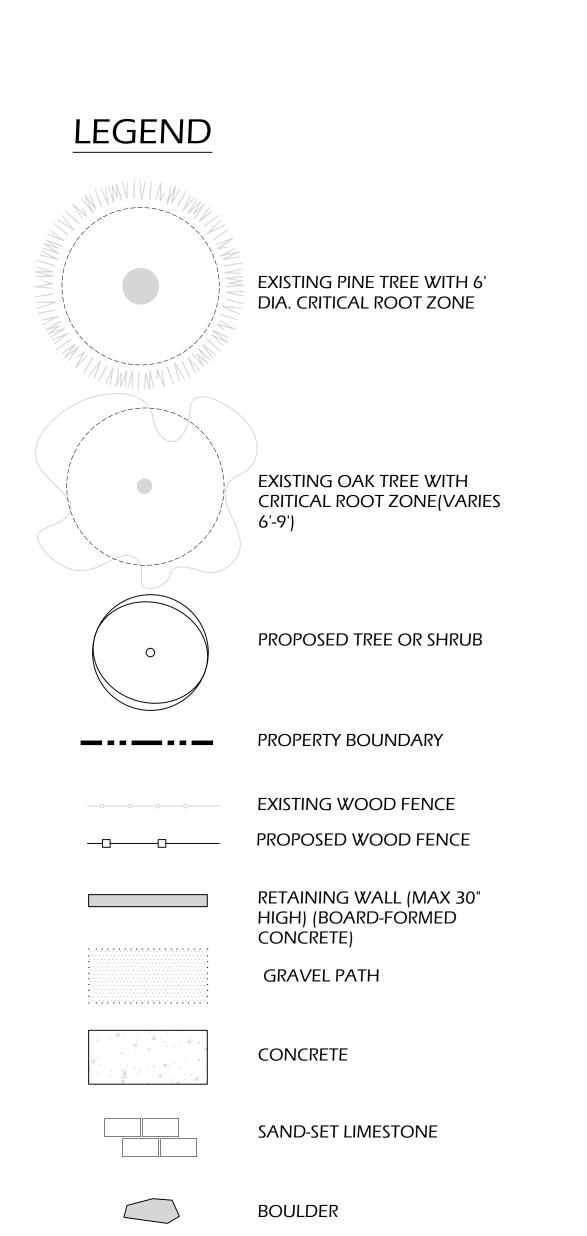

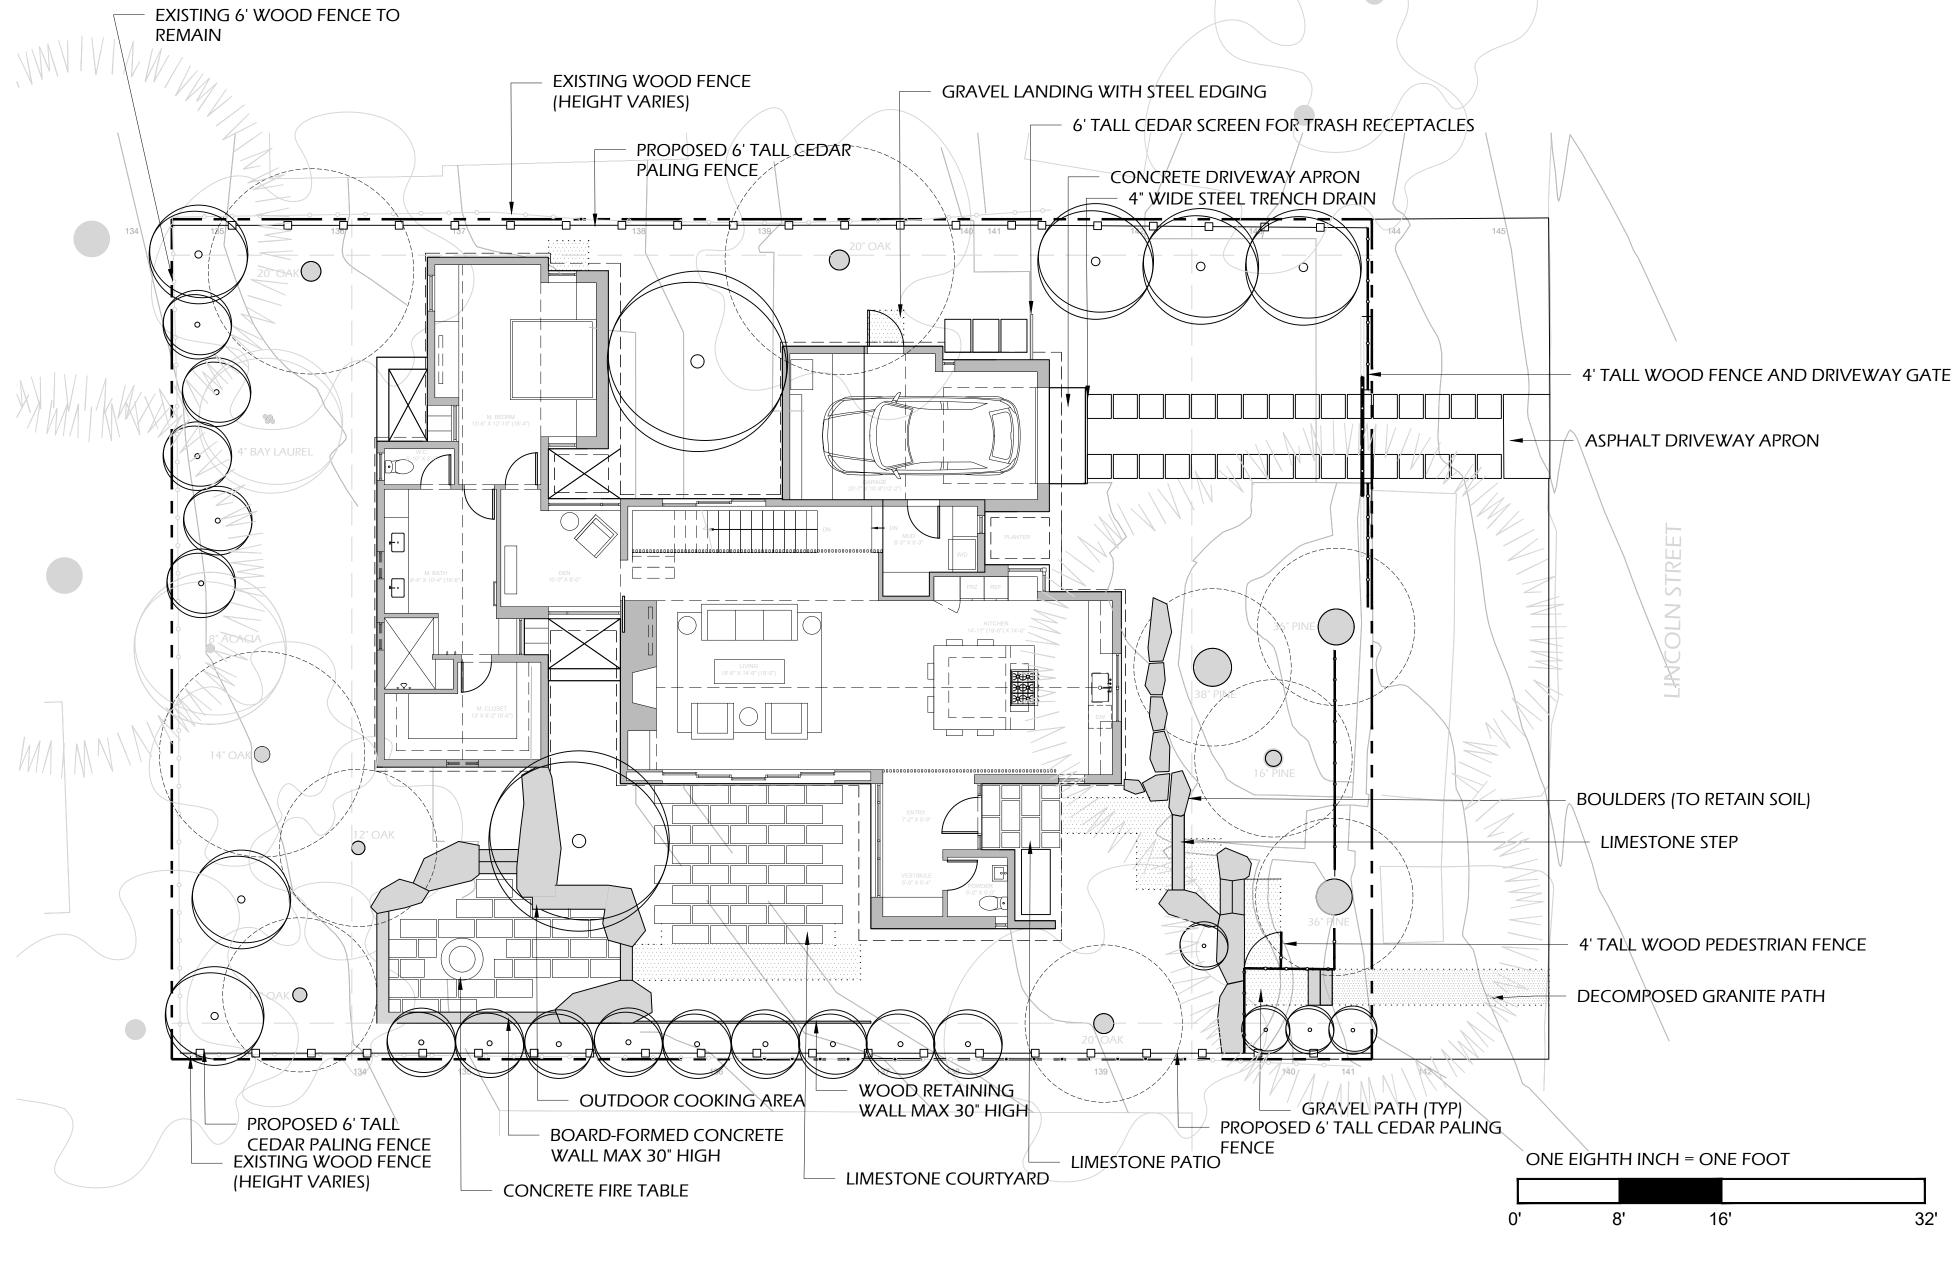

SITE COVERAGE

NOTES

LOT SIZE = 7,000 SF

IMPERVIOUS COVERAGE 270.47 SF			
97.59	SF	LIGHT WELLS	
88 SF		DRIVEWAY (INSIDE PROPERTY LINE)	
25.06	SF	GARAGE APRON + DRAIN	
9.62 9	SF	FIREPIT	
22.99	SF	ENTRANCE EAVE	
27.21		STEPS	

SEMI-PERVIOUS COVERAGE 508.03 SF

183.59 SF DINING TERRACE 122.47 SF ENTRY PATH AND LANDING (MINUS EAVE) 128.61 SF FIRE TERRACE (MINUS FIREPIT) 73.36 SF GRAVEL STOOPS/PATHS

TOTAL COVERAGE 778.5 SF (DOES NOT INCLUDE RETAINING WALLS/BOULDERS)

ALLOWED COVERAGE (IF OVER 50% IS SEMI-PERVIOUS = 881 SF

GENERAL

- 1. LANDSCAPE CONSTRUCTION SHALL BE PERFORMED IN ACCORDANCE WITH ALL APPLICABLE CODE AND REGULATORY REQUIREMENTS.
- 2. PROPER STORMWATER MANAGEMENT, EROSION CONTROL AND TREE PROTECTION WILL BE STRICTLY MAINTAINED THROUGHOUT THE ENTIRE DURATION OF THE PROJECT.
- 3. NATIVE DROUGHT-TOLERANT VEGETATION WITH DRIP (DOMINANT) IRRIGATION WILL COMPLY WITH ALL WATER EFFICIENCY STANDARDS AND REGULATIONS.
- 4. ALL PATHS, STAIRS AND WALKWAYS SHALL COMPLY WITH ACCESSIBILITY STANDARDS. 5. EXTERIOR LIGHTING AS SHOWN IN THIS CONCEPTUAL LAYOUT SHALL COMPLY WITH CALIFORNIA
- LIGHTING EFFICIENCY CODE. 6. ALL HARDWARE REQUIRED FOR ELEMENTS WITHIN THIS SCOPE OF WORK TO BE CORROSION
- RESISTANT, INCLUDING REBAR. 7. THE EXACT LOCATION OF DRAINAGE UTILITIES SHALL BE DETERMINED BY THE CONTRACTOR WITH THE LANDSCAPE ARCHITECT IN THE FIELD.





RAINEY RESIDENCE

JOBE CORRAL ARCHITECTS STRANDBERG ENGINEERING ADA CORRAL, AIA 505 W. 38TH ST, STE B AUSTIN, TX 78705 512.499.1591

DAVID STRANDBERG 1511 15TH STREET SAN FRANCISCO, CA 94103 415.778.8726x101

CIVIL ENGINEER: STOCKER & ALLAIRE DAVID STOCKER 21 MANDEVILLE COURT MONTEREY, CA 93940 831.375.1890

STRUCTURAL ENGINEER: ENERGY CONSULTANT: MONTEREY ENERGY GROUP INC. ABE STALLCUP 26465 CARMEL RANCHO BLVD. SUITE #8 CARMEL, CA 93923 831.372.8328

LANDSCAPE ARCHITEC

LIGHTING DESIGNER

NOTES:

BENJAMINI, INC AVI BENJAMINI 720 YORK ST #114 SAN FRANCISCO, CA 94110 415.550.2600 JMLA JESSICA M. NEAFSEY 3345 7TH AVE CARMEL, CA 93923 734.904.9152 STUDIO LUMINA CHRISTINA BROWN 9411 CHAPEL DOWN STREET AUSTIN, TX 78729 512.382.1656

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NORTH:

 $\left(\begin{array}{c} \end{array} \right)$

LINCOLN 5 SW OF 10TH PROJECT NUMBER: 1914

DRAWN BY: JMN

SITE PLAN

L3.0

RAINEY RESIDENCE CARMEL-BY-THE-SEA, CA 93923

PROJECT: JOHN AND KELLY RAINEY

NDSCA

01.29.2021 CONCEPT PROJECT REVIEW 03.10.2021

CONCEPT PROJECT REVIEW

ISSUE:


I EGEND

100'-0" = 137'-6" ABV SEA LEVEL

DESIGNER:

CONTRACTOR:



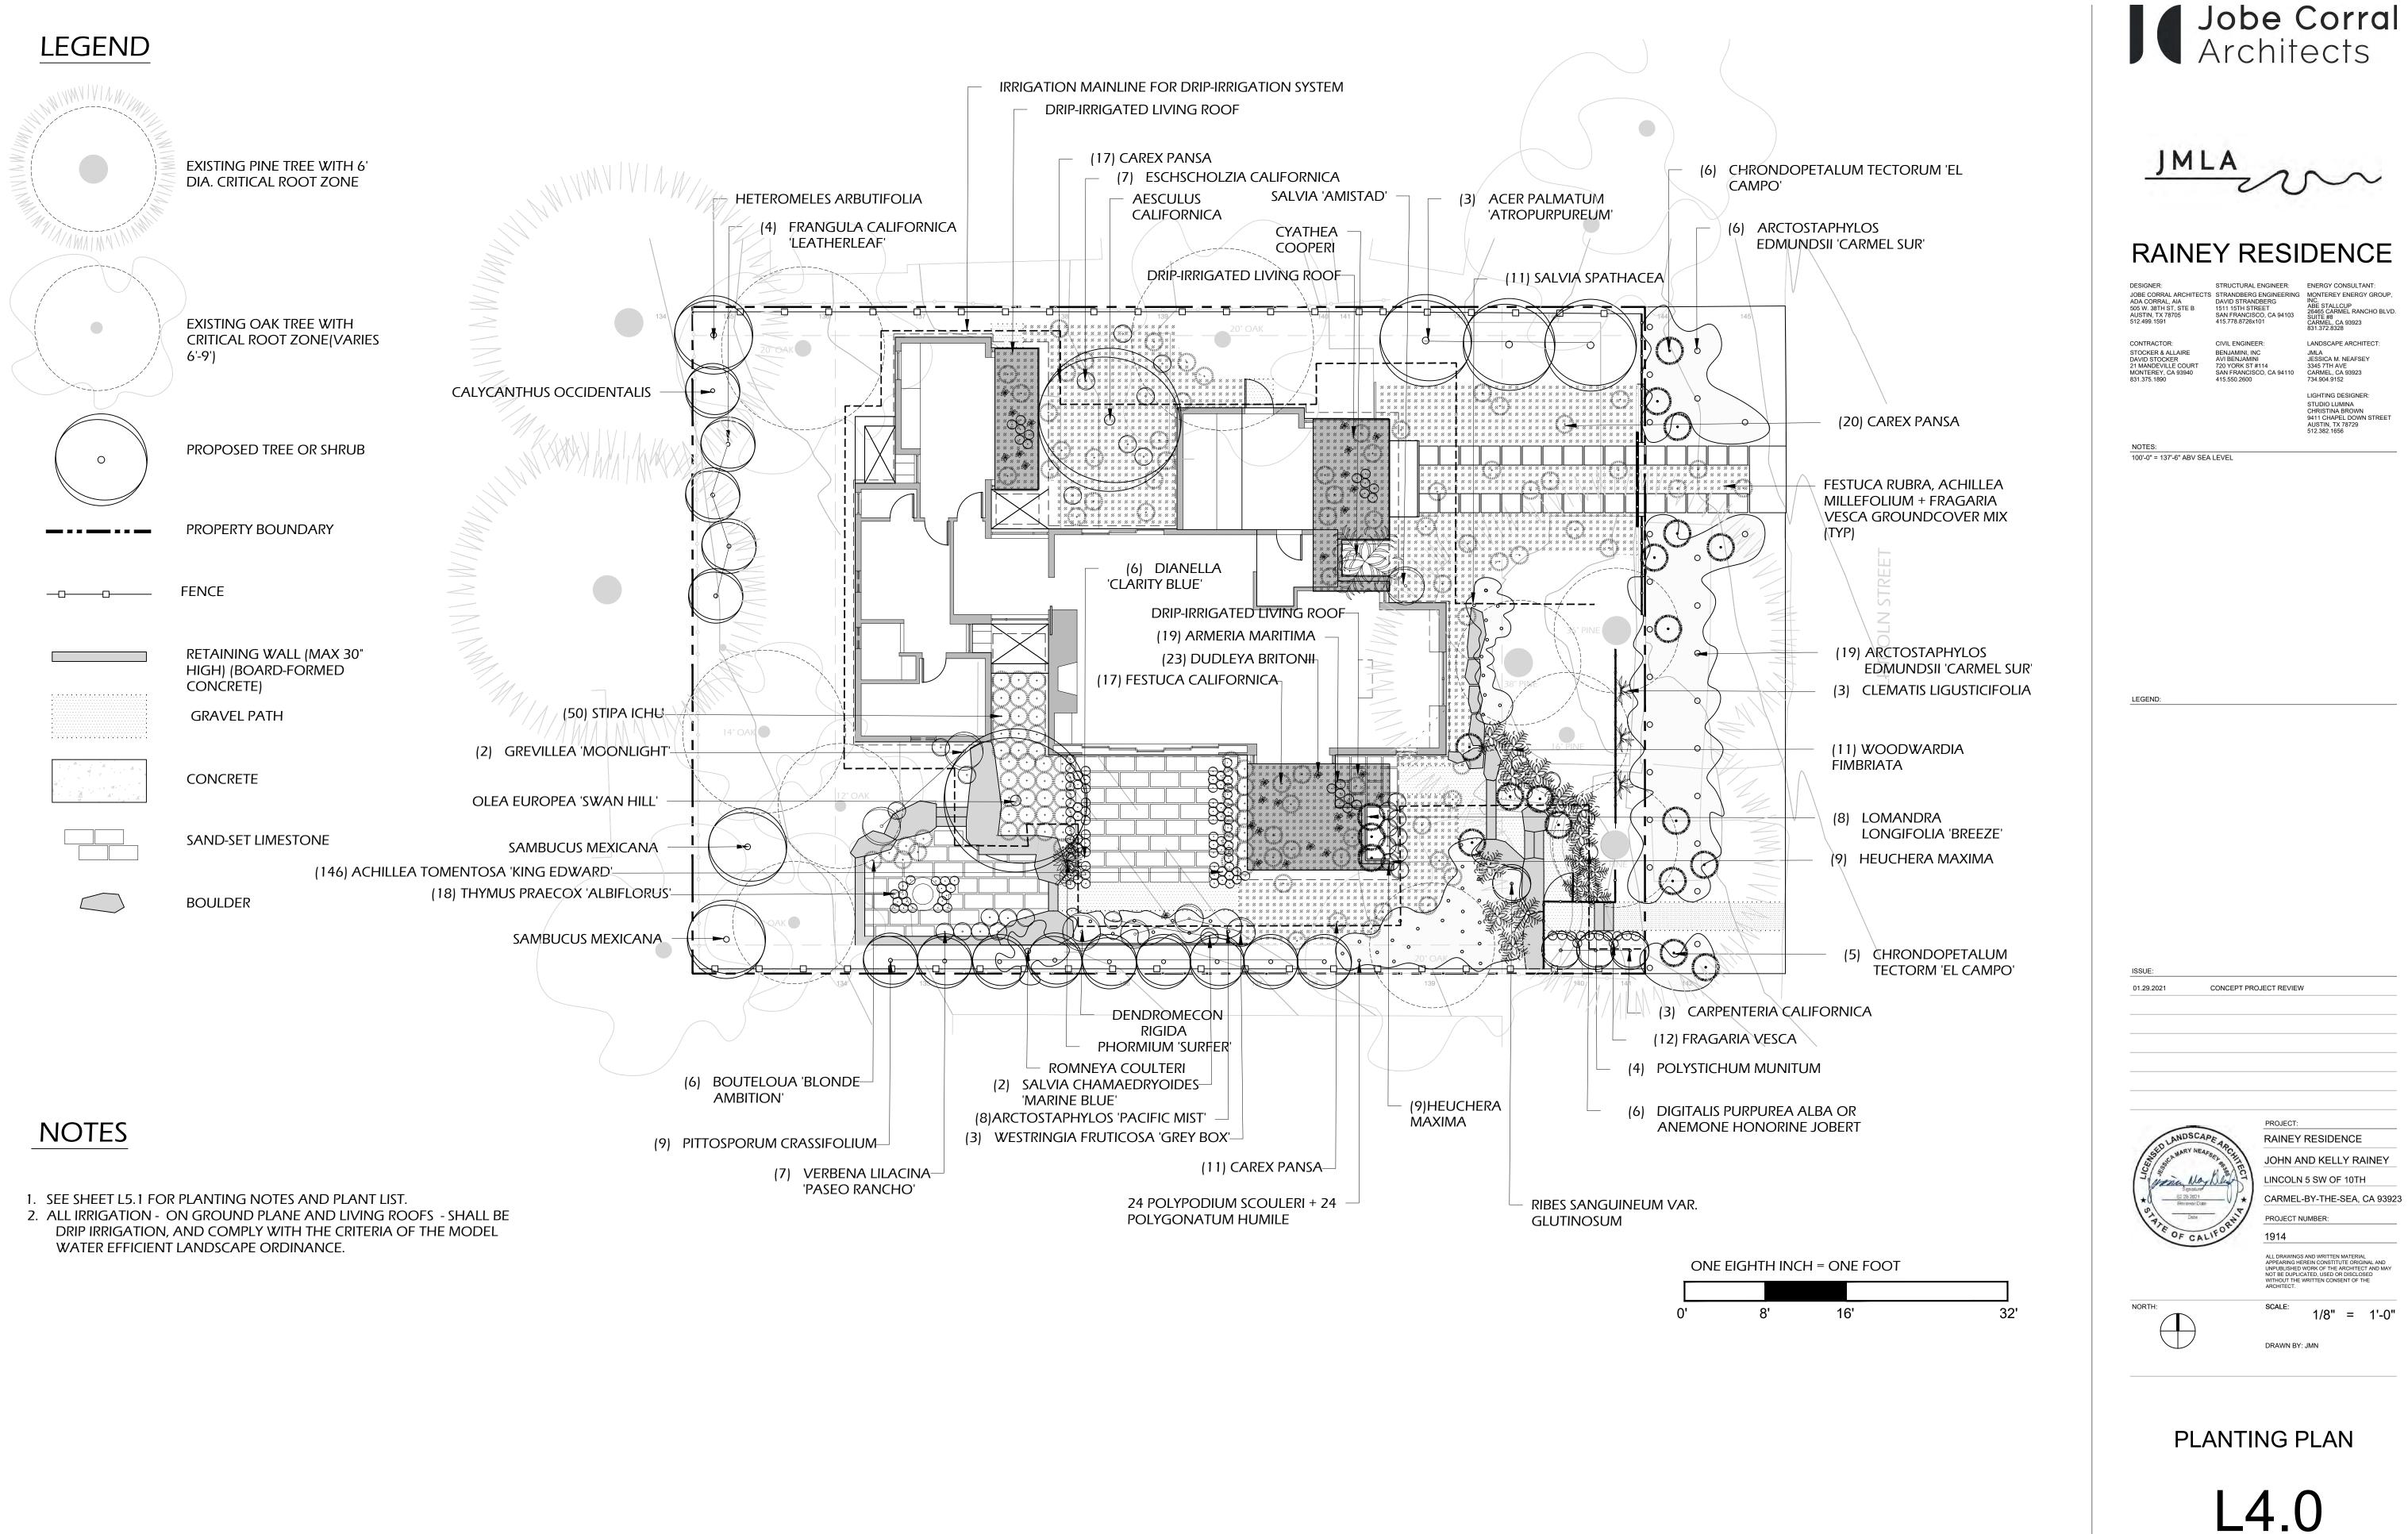

JOHN AND KELLY RAINEY

MONTEREY ENERGY GROUP

PLANT LIST

TYPE	SCIENTIFIC NAME	COMMON NAME
TREES	ACER PALMATUM 'ATROPURPUREUM'	RED LEAF JAPANESE MAPLE
	OLEA EUROPEA 'SWAN HILL'	SWAN HILL FRUITLESS OLIVE
	AESCULUS CALIFORNICA	CALIFORNIA BUCKEYE
SHRUBS		
	CARPENTERIA CALIFORNICA	BUSH ANEMONE
	ARCTOSTAPHYLOS 'PACIFIC MIST'	PACIFIC MIST MANZANITA
	CALYCANTHUS OCCIDENTALIS	SPICE BUSH
	ARCTOSTAPHYLOS EDMUNDSII 'CARMEL SUR'	CARMEL SUR MANZANITA
	HETEROMELES ARBUTIFOLIA	TOYON
	FRANGULA CALIFORNICA 'LEATHER LEAF'	
	PHORMIUM 'SURFER'	SURFER FLAX
	RIBES SANGUINEUM VAR. GLUTINOSUM	
		MEXICAN ELDERBERRY
	GREVILLEA 'MOONLIGHT'	MOONLIGHT GREVILLEA
	WESTRINGIA FRUTICOSA 'GREY BOX'	GREY BOX COAST ROSEMARY
GRASSES, SEDGES	5	
+ RUSHES	-	
	BOUTELOUA GRACILIS 'BLONDE AMBITION'	BLONDE AMBITION GAMA GRASS
	CAREX PANSA	SEDGE
	LOMANDRA LONGIFOLIA 'BREEZE'	DWARF MAT RUSH
	STIPA ICHU	PERUVIAN FEATHER GRASS
FERNS		
	WOODWARDIA FIMBRIATA	GIANT CHAIN FERN
	POLYSTICUM MUNITUM	WESTERN SWORD FERN
	POLYPODIUM SCOULERI	LEATHERY POLYPODIUM
	CYATHEA COOPERI	LACY TREE FERN
VINES		
PERENNIALS		
	ACHILLEA TOMENTOSA 'KING EDWARD'	KING EDWARD WOOLY YARROW
	CHRONDOPETALUM 'EL CAMPO'	SMALL CAPE RUSH
	CHRONDOPETALUM 'EL CAMPO' DIANELLA 'CLARITY BLUE	SMALL CAPE RUSH CLARITY BLUE DIANELLA
	CHRONDOPETALUM 'EL CAMPO' DIANELLA 'CLARITY BLUE THYMUS PRAECOX 'ALBIFLORUS	SMALL CAPE RUSH CLARITY BLUE DIANELLA WHITE CREEPING THYME
	CHRONDOPETALUM 'EL CAMPO' DIANELLA 'CLARITY BLUE	SMALL CAPE RUSH CLARITY BLUE DIANELLA
	CHRONDOPETALUM 'EL CAMPO' DIANELLA 'CLARITY BLUE THYMUS PRAECOX 'ALBIFLORUS	SMALL CAPE RUSH CLARITY BLUE DIANELLA WHITE CREEPING THYME WHITE FOXGLOVE
	CHRONDOPETALUM 'EL CAMPO' DIANELLA 'CLARITY BLUE THYMUS PRAECOX 'ALBIFLORUS DIGITALIS PURPUREA 'ABLA'	SMALL CAPE RUSHCLARITY BLUE DIANELLAWHITE CREEPING THYMEWHITE FOXGLOVEGUERNSEY WHITE MADERENSE
	CHRONDOPETALUM 'EL CAMPO' DIANELLA 'CLARITY BLUE THYMUS PRAECOX 'ALBIFLORUS DIGITALIS PURPUREA 'ABLA' GERANIUM MADERENSE 'GUERNSEY WHITE'	SMALL CAPE RUSH CLARITY BLUE DIANELLA WHITE CREEPING THYME WHITE FOXGLOVE GUERNSEY WHITE MADERENSE GERANIUM
	CHRONDOPETALUM 'EL CAMPO'DIANELLA 'CLARITY BLUETHYMUS PRAECOX 'ALBIFLORUSDIGITALIS PURPUREA 'ABLA'GERANIUM MADERENSE 'GUERNSEY WHITE'ANEMONE 'HONORINE JOBERT'	SMALL CAPE RUSH CLARITY BLUE DIANELLA WHITE CREEPING THYME WHITE FOXGLOVE GUERNSEY WHITE MADERENSE GERANIUM HONORINE JOBERT ANEMON
	CHRONDOPETALUM 'EL CAMPO' DIANELLA 'CLARITY BLUE THYMUS PRAECOX 'ALBIFLORUS DIGITALIS PURPUREA 'ABLA' GERANIUM MADERENSE 'GUERNSEY WHITE' ANEMONE 'HONORINE JOBERT' HEUCHERA MAXIMA	SMALL CAPE RUSH CLARITY BLUE DIANELLA WHITE CREEPING THYME WHITE FOXGLOVE GUERNSEY WHITE MADERENSE GERANIUM HONORINE JOBERT ANEMON CORAL BELLS
	CHRONDOPETALUM 'EL CAMPO' DIANELLA 'CLARITY BLUE THYMUS PRAECOX 'ALBIFLORUS DIGITALIS PURPUREA 'ABLA' GERANIUM MADERENSE 'GUERNSEY WHITE' ANEMONE 'HONORINE JOBERT' HEUCHERA MAXIMA FRAGARIA VESCA	SMALL CAPE RUSHCLARITY BLUE DIANELLAWHITE CREEPING THYMEWHITE FOXGLOVEGUERNSEY WHITE MADERENSEGERANIUMHONORINE JOBERT ANEMONCORAL BELLSWOODLAND STRAWBERRY
	CHRONDOPETALUM 'EL CAMPO'DIANELLA 'CLARITY BLUETHYMUS PRAECOX 'ALBIFLORUSDIGITALIS PURPUREA 'ABLA'GERANIUM MADERENSE 'GUERNSEY WHITE'ANEMONE 'HONORINE JOBERT'HEUCHERA MAXIMAFRAGARIA VESCAPOLYGONATUM HUMILESALVIA SPATHACEASALVIA CHAMAEDRYOIDES 'MARINE BLUE'	SMALL CAPE RUSH CLARITY BLUE DIANELLA WHITE CREEPING THYME WHITE FOXGLOVE GUERNSEY WHITE MADERENSE GERANIUM HONORINE JOBERT ANEMON CORAL BELLS WOODLAND STRAWBERRY DWARF SOLOMON'S SEAL HUMMINGBIRD SAGE MARINE BLUE GERMANDER SAGE
	CHRONDOPETALUM 'EL CAMPO'DIANELLA 'CLARITY BLUETHYMUS PRAECOX 'ALBIFLORUSDIGITALIS PURPUREA 'ABLA'GERANIUM MADERENSE 'GUERNSEY WHITE'ANEMONE 'HONORINE JOBERT'HEUCHERA MAXIMAFRAGARIA VESCAPOLYGONATUM HUMILESALVIA SPATHACEASALVIA CHAMAEDRYOIDES 'MARINE BLUE'VERBENA LILACINA 'PASEO RANCHO'	SMALL CAPE RUSH CLARITY BLUE DIANELLA WHITE CREEPING THYME WHITE FOXGLOVE GUERNSEY WHITE MADERENSE GERANIUM HONORINE JOBERT ANEMON CORAL BELLS WOODLAND STRAWBERRY DWARF SOLOMON'S SEAL HUMMINGBIRD SAGE MARINE BLUE GERMANDER SAGE PASEO RANCHO VERBENA
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<u>ANNUALS</u>	CHRONDOPETALUM 'EL CAMPO' DIANELLA 'CLARITY BLUE THYMUS PRAECOX 'ALBIFLORUS DIGITALIS PURPUREA 'ABLA' GERANIUM MADERENSE 'GUERNSEY WHITE' ANEMONE 'HONORINE JOBERT' HEUCHERA MAXIMA FRAGARIA VESCA POLYGONATUM HUMILE SALVIA SPATHACEA SALVIA SPATHACEA SALVIA CHAMAEDRYOIDES 'MARINE BLUE' VERBENA LILACINA 'PASEO RANCHO' SALVIA 'AMISTAD' ESCHSCHOLZIA CALIFORNICA 'ALBA' FESTUCA RUBRA ACHILLEA MILLEFOLIUM 'SONOMA' FRAGARIA VESCA	SMALL CAPE RUSH CLARITY BLUE DIANELLA WHITE CREEPING THYME WHITE FOXGLOVE GUERNSEY WHITE MADERENSE GERANIUM HONORINE JOBERT ANEMON CORAL BELLS WOODLAND STRAWBERRY DWARF SOLOMON'S SEAL HUMMINGBIRD SAGE MARINE BLUE GERMANDER SAGE PASEO RANCHO VERBENA AMISTAD SAGE WHITE CALIFORNIA POPPY CREEPING RED FESCUE SONOMA YARROW WOODLAND STRAWBERRY
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OUANTITY	CONTAINER SIZE	AREA (SF)
3	15 GAL.	
1	36" BOX	
1	36" BOX	
3	15 GALLON	
14	1 GALLON	
1	5 GALLON	
25	1 GALLON	
1	5 GALLON	
4	5 GALLON	
1	5 GALLON	
1	5 GALLON	
2	5 GALLON	
1	1 GALLON	
2	5 GALLON	
9	5 GALLON	
3	1 GALLON	
6	1 GALLON	
48	1 GALLON	
8	1 GALLON	
50	1 GALLON	
11	5 GALLON	
4	1 GALLON	
24	4" POT	
1	5 GALLON	
3	1 GALLON	
146	4" POT	
11	1 GALLON	
6	1 GALLON	
18		
6	4"	
	4" 4"	
	4"	
4	4" 1 GALLON	
6	4" 1 GALLON 1 GALLON	
6 9	4" 1 GALLON 1 GALLON 1 GALLON	
6 9 12	4" 1 GALLON 1 GALLON 1 GALLON 4"	
6 9 12 24	4" 1 GALLON 1 GALLON 1 GALLON 4" 4"	
6 9 12 24 11	4" 1 GALLON 1 GALLON 1 GALLON 4" 4" 1 GALLON 1 GALLON	
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PLANTING NOTES

GENERAL

- 1. SOIL IN PLANTING AREAS SHALL BE TESTED AND IMPROVED WITH QUALITY SOIL AND COMPOST (OMRI) AS NEEDED FOR HEALTH OF LANDSCAPE
- 2. ANY DETECTED HIGH SALINITY IN SOILS MUST BE FLUSH-IRRIGATED PRIOR TO ANY PLANTING UNDER SUPERVISION OF THE LANDSCAPE ARCHITECT.
- 3. GOPHER CAGES AND CHICKEN WIRE TOPS WITH ≤ 1" MESH SHALL BE INSTALLED WITH NEW PLANTINGS OVER 4" CONTAINER SIZE, AND AS NEEDED.
- 4. 3" DEPTH OF CLEAN 'ARBOR' MULCH (ORGANIC OMRI WHEN AVAILABLE, NO EUCALYPTUS OR DISEASED PLANT MATERIAL) OR SMALL FIR BARK (1/4" TO 3/4") SHALL BE APPLIED IN NEWLY PLANTED AREAS AND REPLENISHED AS NEEDED EACH SPRING AND FALL.
- 5. MULCH SHALL BE APPLIED SO THAT IT IS BELOW GRADE OF CURBS AND EDGINGS (SOME GRADING OF AREAS ADJACENT TO AFFECTED AREAS MAY BE REQUIRED)
- 6. MULCH IS TO BE KEPT 6" 12" AWAY FROM BASE OF SHRUBS AND TREES
- 7. ALL NEWLY PLANTED CONTAINER PLANTS AND TREES SHALL RECEIVE WATERING BASINS 3 TIMES THE SIZE OF THE ROOT BALL UPON PLANTING, UNLESS OTHERWISE SHOWN ON DRAWINGS.
- 8. BACKFILL MIX SHALL CONSIST OF 1 /3 IMPORTED ORGANIC COMPOST AND 2/3 AMENDED SITE SOIL.
- 9. CONTRACTOR IS RESPONSIBLE TO APPLY SUFFICIENT BUT NOT EXCESS IRRIGATION TO ALL NEW PLANTINGS TO ENSURE HEALTHY PLANT ESTABLISHMENT.

QUALITY CONTROL

- 1. PLANT QUANTITIES ARE PROVIDED FOR REFERENCE ONLY. CONTRACTOR IS RESPONSIBLE FOR ALL FINAL MATERIAL QUANTITIES.
- 2. ANY PLANT SUBSTITUTIONS MUST BE APPROVED BY THE LANDSCAPE ARCHITECT FOR APPROVAL OR ALTERNATE CHOICES.
- 3. ALL PLANTS SHALL BE HEALTHY, PEST AND DISEASE FREE, FREE OF GIRDLING ROOTS AND WELL ESTABLISHED IN THE CONTAINER.
- 4. PLANT MATERIAL STANDARDS: MINIMUM QUALITY AND SIZE OF ALL PLANT MATERIAL SHALL CONFORM TO PREVAILING PUBLISHED SPECIFICATIONS OF THE CALIFORNIA ASSOCIATION OF NURSERYMEN AND THE AMERICAN ASSOCIATION OF NURSERYMEN UNLESS OTHERWISE INDICATED.
- 5. PLANT AVAILABILITY AND SUBSTITUTIONS: A MINIMUM OF TEN (10) DAYS BEFORE PLANTING INSTALLATION, CONTRACTOR SHALL SUBMIT NOTICE TO THE LANDSCAPE ARCHITECT CERTIFYING THAT THE SPECIFIED PLANTS ARE AVAILABLE IN THE SIZE, QUANTITY AND QUALITY REQUIRED, AND PROPOSED SUBSTITUTIONS FOR PLANTS THAT ARE NOT AVAILABLE, TO BE REVIEWED AND APPROVED BY LANDSCAPE ARCHITECT.
- 6. WARRANTY: IT IS THE RESPONSIBILITY OF THE LANDSCAPE CONTRACTOR TO PROTECT PLANT MATERIAL FROM WEATHER, BREAKAGE, THEFT, AND DROUGHT DURING TRANSIT, STORAGE, INSTALLATION AND MAINTENANCE PERIOD.
- 6.1. ALL PLANT MATERIAL INSTALLED UNDER THE CONTRACT SHALL BE GUARANTEED AGAINST ANY AND ALL POOR INADEQUATE OR INFERIOR MATERIALS AND/OR WORKMANSHIP.
- 6.2. REPLACE DEAD PLANTS AND PLANTS NOT SHOWING EVIDENCE OF ACTIVE GROWTH AT END OF WARRANTY PERIOD.
- REPLACEMENT PLANTS: PROVIDE SAME KIND AND SIZE ORIGINALLY PLANTED UNLESS OTHERWISE APPROVED BY 6.3. LANDSCAPE ARCHITECT. MAINTAIN REPLACEMENT PLANTS THOUGH MAINTENANCE PERIOD OR UNTIL ACTIVE GROWTH IS ESTABLISHED.

ONSITE PLANTING REVIEWS

- 1. LOCATION OF ALL PLANTS AND TREES TO BE FIELD LOCATED WITH LANDSCAPE ARCHITECT PRIOR TO INSTALLATION.
- 2. CONTRACTOR TO LAYOUT PLANTS IN POTS AS SHOWN ON THE PLANTING PLAN FOR REVIEW AND ADJUSTMENTS BY LANDSCAPE ARCHITECT PRIOR TO PLANTING.
- 2.1. LAYOUT ONE AREA AT A TIME BASED ON WHAT CAN BE PLANTED IN ONE DAY.

IRRIGATION NOTES

- 1. ALL PLANTED AREAS SHALL RECEIVE DRIP IRRIGATION.
- 2. HAND TRENCH WHEREVER SURFACE ROOTS ARE PRESENT. TRENCH ADJACENT TO PAVING WHEREVER POSSIBLE TO MINIMIZE TREE ROOT DAMAGE.
- 3. WHERE IRRIGATION CONTROL WIRES ARE NOT SHOWN THEY ARE TO RUN PARALLEL TO MAINLINE.
- 4. AT LEAST SEVEN DAYS BEFORE BEGINNING WORK, THE IRRIGATION CONTRACTOR SHALL CONFIRM THE STATIC WATER PRESSURE IS AT LEAST 35 PSI AT THE POINT OF CONNECTION. IF STATIC WATER PRESSURE IS LESS THAN STATED, DO NOT PROCEED WITHOUT FIRST NOTIFYING THE IRRIGATION DESIGNER AND OWNER IN WRITING, AND OBTAINING SUBSEQUENT DIRECTION FOR CORRECTIONAL MEASURES. SHOULD THE IRRIGATION CONTRACTOR CHOOSE TO BEGIN THE INSTALLATION WITHOUT SUCH NOTIFICATION, THE IRRIGATION CONTRACTOR WILL ASSUME THE RESPONSIBILITY FOR ALL COSTS INCURRED TO ENSURE THE SYSTEM IS WORKING PROPERLY. NO CHANGE ORDERS WILL BE AUTHORIZED IN SUCH CIRCUMSTANCES.
- 5. THE IRRIGATION CONTRACTOR SHALL VERIFY THE LOCATIONS OF ALL ABOVE-GRADE IRRIGATION EQUIPMENT WITH THE OWNER'S AUTHORIZED REPRESENTATIVE PRIOR TO INSTALLATION. OR IRRIGATION CONTRACTOR MAY BE REQUIRED TO MOVE SUCH ITEMS AT HIS OWN COST.
- THE IRRIGATION CONTRACTOR SHALL VERIFY THE LOCATION OF ALL UTILITY LINES (WATER, SEWER, 6 ELECTRICAL, TELEPHONE, GAS, CABLE, TELEVISION, ETC.) PRIOR TO THE START OF ANY WORK. THE CONTRACTOR SHALL BE FAMILIAR WITH LOCATIONS OF WALLS, STRUCTURES AND UTILITIES. THE IRRIGATION CONTRACTOR SHALL COORDINATE WITH THE OWNER TO DETERMINE PROPOSED LOCATIONS OF THE IRRIGATION CONTROLLER.
- 7. UV RATED PVC PIPE AND CONNECTIONS SHALL BE USED IN PLACE OF PVC AT ANY PLACE WHERE IRRIGATION PIPE WILL REMAIN EXPOSED.
- 8. ALL VALVE BOX LOCATIONS TO BE APPROVED BY LANDSCAPE ARCHITECT PRIOR TO INSTALLATION OF IRRIGATION MAINLINE.
- CONTRACTOR IS RESPONSIBLE FOR OVERHEAD WATERING OF SOD AS NEEDED UNTIL ESTABLISHED, MIN. 1 MONTH. 9 10. FOLLOWING INSTALLATION, THE CONTRACTOR SHALL DEMONSTRATE TO THE OWNER AND DESIGNER THE PROPER
- **OPERATION OF THE SYSTEM FOR FINAL APPROVAL** 11. THE ENTIRE INSTALLATION SHALL CONFORM TO THE REQUIREMENTS OF THE 2010 CALIFORNIA FIRE CODE, THE
- 2010CALIFORNIA PLUMBING CODE (CPC), CALIFORNIA BUILDING CODE AND ALL OTHER APPLICABLE CODES AND **REGULATIONS.**





RAINEY RESIDENCE

DESIGNER: ADA CORRAL, AIA 505 W. 38TH ST, STE B AUSTIN, TX 78705 512.499.1591

STRUCTURAL ENGINEER: ENERGY CONSULTANT JOBE CORRAL ARCHITECTS STRANDBERG ENGINEERING DAVID STRANDBERG 1511 15TH STREET SAN FRANCISCO, CA 94103 415.778.8726x101

CONTRACTOR: CIVIL ENGINEER: STOCKER & ALLAIRE BENJAMINI, INC DAVID STOCKER 21 MANDEVILLE COURT MONTEREY, CA 93940 831.375.1890

MONTEREY ENERGY GROUP ABE STALLCUP 26465 CARMEL RANCHO BLVD. SUITE #8 CARMEL, CA 93923 831.372.8328

LANDSCAPE ARCHITECT JESSICA M. NEAFSEY 720 YORK ST #114 SAN FRANCISCO, CA 94110 415.550.2600 CARMEL, CA 93923 734.904.9152

> LIGHTING DESIGNER STUDIO LUMINA CHRISTINA BROWN 9411 CHAPEL DOWN STREET AUSTIN, TX 78729 512.382.1656

NOTES: 100'-0" = 137'-6" ABV SEA LEVEL

01.29.2021

ISSUE

CONCEPT PROJECT REVIEW



PROJECT: RAINEY RESIDENCE JOHN AND KELLY RAINEY LINCOLN 5 SW OF 10TH CARMEL-BY-THE-SEA, CA 93923 PROJECT NUMBER: 1914

ALL DRAWINGS AND WRITTEN MATERIAL APPEARING HEREIN CONSTITUTE ORIGINAL AND UNPUBLISHED WORK OF THE ARCHITECT AND M NOT BE DUPLICATED, USED OR DISCLOSED WITHOUT THE WRITTEN CONSENT OF THE MONITOR


1/8" = 1'-0"


NORTH: \square

DRAWN BY: JMN

SCALE:




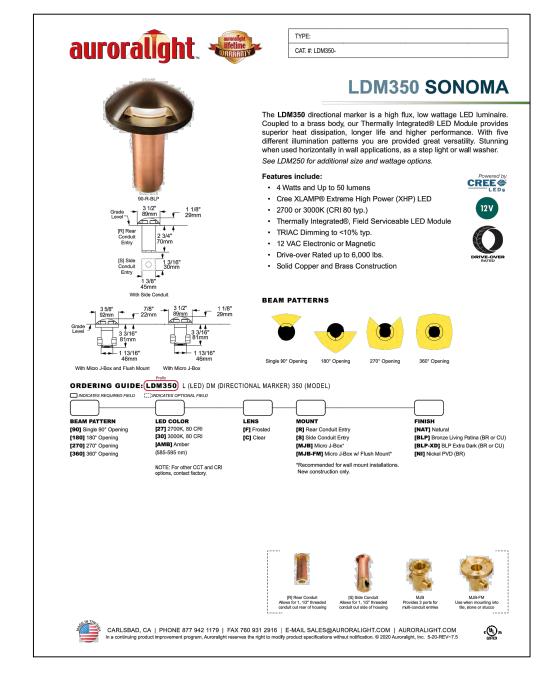


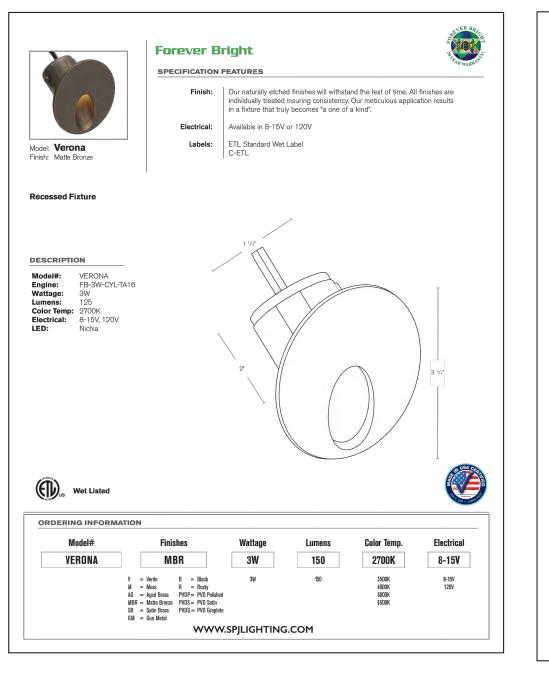

WWWWWWWWW

MALL MAN

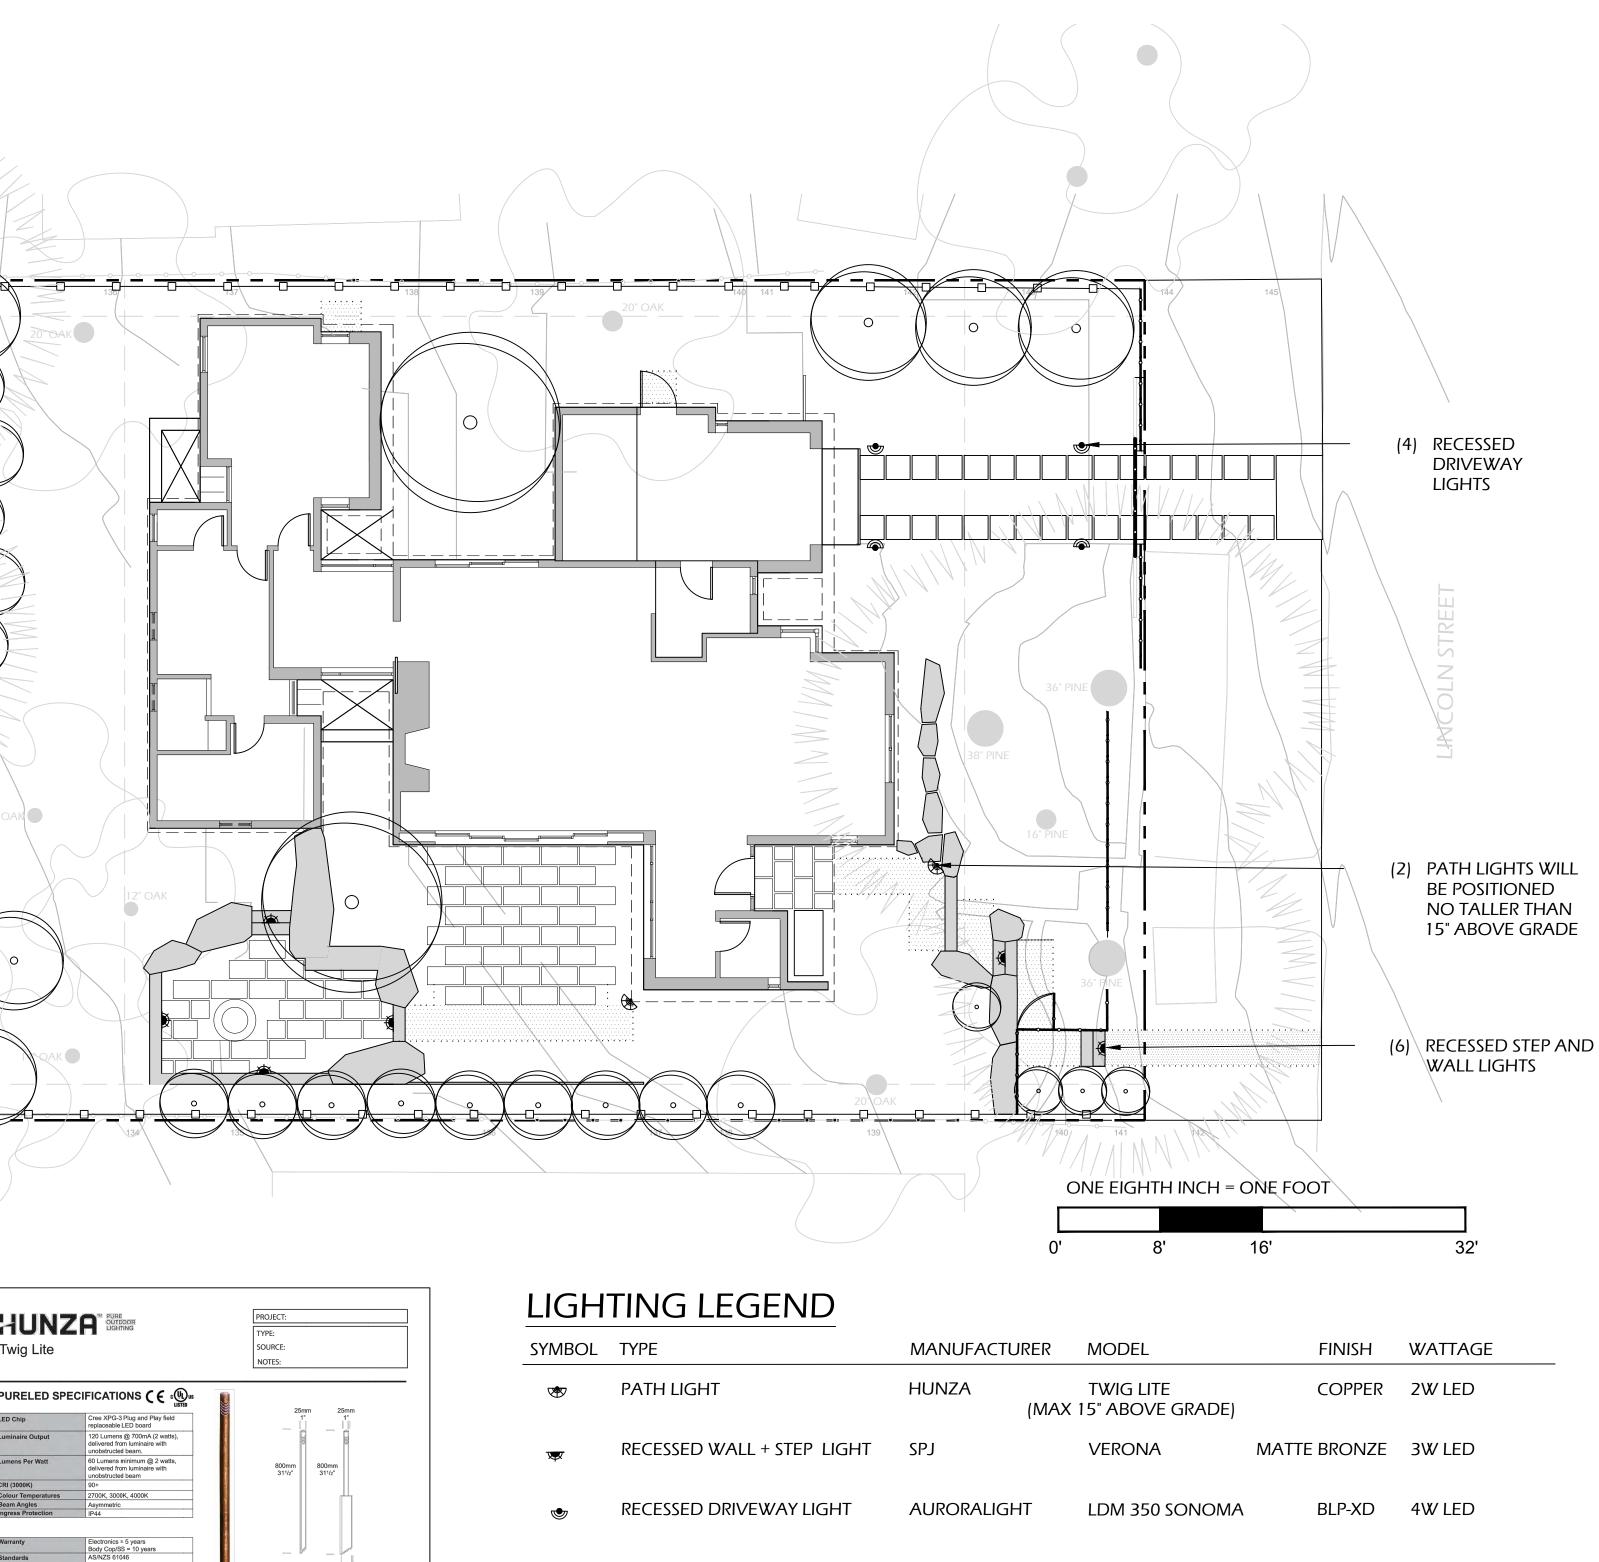


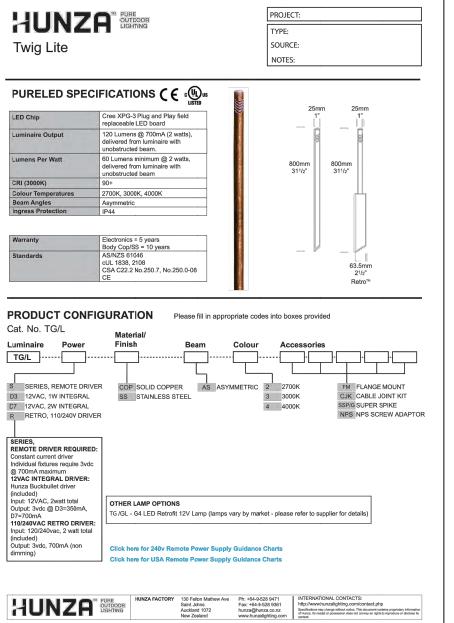

SYMBOL	ТҮРЕ	MANUFACTURER	MODEL
۲	PATH LIGHT	HUNZA (MAX	TWIG LITE 15" Above gra
W	RECESSED WALL + STEP LIGHT	SPJ	VERONA
۲	RECESSED DRIVEWAY LIGHT	AURORALIGHT	LDM 350 SONG

LIGHTING NOTES

- 1. A LICENSED ELECTRICIAN SHALL INSTALL 120 VAC POWER TO CONTROLLER LOCATION, AS WELL AS ALL 120 VAC WIRING WITHIN CONDUIT AND CONNECTIONS TO LIGHT FIXTURES. LOW-VOLTAGE LIGHTS AND WIRING SHALL BE INSTALLED BY THE LANDSCAPE CONTRACTOR.
- 2. POSITION LIGHTS IN FIELD. ADJUST TO MINIMIZE LIGHT SPILLAGE AND GLARE AND TO ACHIEVE DESIGN INTENT. FINAL LAYOUT TO BE APPROVED BY LANDSCAPE ARCHITECT.
- 3. FINAL ADJUSTMENTS SHALL BE MADE AT NIGHT WITH OWNER PRESENT FOR APPROVAL.
- 4. SWITCHING AND PROGRAMMING TO BE COORDINATED WITH ELECTRICAL CONTRACTORS.
- 5. CONTRACTOR TO PROVIDE SUBMITTAL SHEETS OF ALL PROPOSED FIXTURES TO LANDSCAPE ARCHITECT FOR APPROVAL. FINAL FINISHES TO BE DETERMINED WITH SUBMITTAL APPROVALS
- 6. POOL LIGHTS TO BE COORDINATED WITH POOL CONTRACTOR.

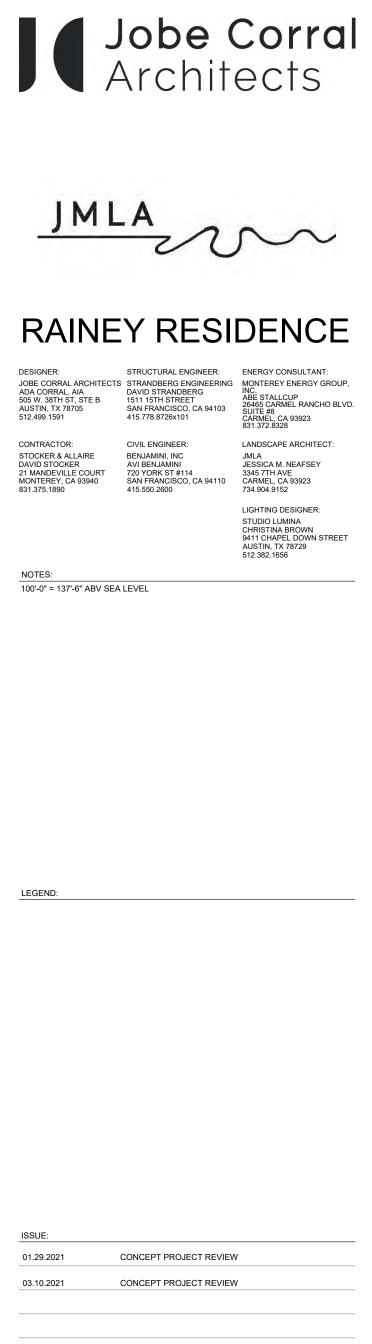

PROJECT: ANDSCAD RAINEY RESIDENCE JOHN AND KELLY RAINEY Jima May Dela LINCOLN 5 SW OF 10TH 02 28 2021 Renewal Date CARMEL-BY-THE-SEA, CA 93923 Cate PROJECT NUMBER: 1914 OF CAL ALL DRAWINGS AND WRITTEN MATERIAL APPEARING HEREIN CONSTITUTE ORIGINAL AND UNPUBLISHED WORK OF THE ARCHITECT AND MAY NOT BE DUPLICATED, USED OR DISCLOSED WITHOUT THE WRITTEN CONSENT OF THE ARCHITECT.

SCALE:

LANDSCAPE

LIGHTING PLAN

L5.0

DRAWN BY: JMN

1/8" = 1'-0"

NORTH:

GENERAL NOTES:

- 1. THESE PLANS REPRESENT THE OVERALL ON-SITE IMPROVEMENTS REQUIRED FOR PROJECT CONSTRUCTION. THE CONTRACTOR SHALI FURNISH, INSTALL, TEST AND COMPLETE ALL WORK TO THE SATISFACTION OF THE ENGINEER AND OWNER IN ACCORDANCE WITH THE CONTRACT DOCUMENTS. THE CONTRACTOR SHALL BE SOLELY RESPONSIBLE FOR MEANS AND METHODS OF CONSTRUCTION; AS SUCH, THESE PLANS DO NOT COMPLETELY REPRESENT, NOR ARE THEY INTENDED TO REPRESENT, ALL SPECIFIC INSTRUCTIONS REQUIRED FOR OFF-SITE CONSTRUCTION. THE CONTRACTOR SHALL BE RESPONSIBLE TO CONSTRUCT ALL IMPROVEMENTS DEPICTED ON THESE PLANS IN ACCORDANCE WITH ALL APPLICABLE RULES, REGULATIONS AND LAWS IN EFFECT AT THE TIME OF CONSTRUCTION.
- 2. THE CONTRACTOR SHALL ACCEPT THE SITE AS IS. THE CONTRACTOR SHALL ASSESS CONDITIONS, AND THE KIND, QUALITY AND QUANTITY OF WORK REQUIRED. THE OWNER MAKES NO GUARANTEE IN REGARD TO THE ACCURACY OF ANY AVAILABLE INFORMATION WHICH WAS OBTAINED DURING INVESTIGATIONS. THE CONTRACTOR SHALL MAKE A THOROUGH SITE INSPECTION IN ORDER TO FIELD CHECK EXISTING SITE CONDITIONS, CORRELATE CONDITIONS WITH THE DRAWINGS AND RESOLVE ANY POSSIBLE CONSTRUCTION CONFLICTS WITH THE OWNER AND ENGINEER PRIOR TO COMMENCEMENT OF WORK. THE CONTRACTOR SHALL MAKE ADDITIONAL TOPOGRAPHIC SURVEYS HE DEEMS NECESSARY. PROVIDED THEY ARE COORDINATED WITH THE OWNER, ANY CONDITIONS DETERMINED BY THE CONTRACTOR THAT DIFFER FROM THE INFORMATION SHOWN ON THE DRAWINGS THAT ARE NOT BROUGHT TO THE ATTENTION OF THE OWNER AND ENGINEER PRIOR TO THE START OF WORK SHALL NOT BE CONSIDERED GROUNDS FOR ADDITIONAL PAYMENT OR CHANGES TO THE CONTRACT DURATION, OR ANY OTHER CLAIMS AGAINST THE OWNER OR OWNER'S ENGINEER.
- 3. THE CONTRACTOR SHALL, WHEN THEY DEEM NECESSARY, PROVIDE WRITTEN REQUESTS FOR INFORMATION (RFI) TO THE OWNER AND ENGINEER PRIOR TO THE CONSTRUCTION OF ANY SPECIFIC SITEWORK ITEM. THE (RFI) SHALL BE IN A FORM ACCEPTABLE TO OWNER AND ENGINEER AND SHALL ALLOW FOR A MINIMUM OF TWO WORK DAYS OR ADDITIONAL REASONABLE TIME FOR A WRITTEN REPLY. RFIS SHALL BE NUMBERED CONSECUTIVELY BY DATE SUBMITTED. THE CONTRACTOR SHALL BE SOLELY RESPONSIBLE FOR SITEWORK ITEMS CONSTRUCTED DIFFERENTLY THAN INTENDED OR AS DEPICTED ON THE PLANS.
- 4. INFORMATION RELATED TO ELEVATIONS AND PROPOSED UTILITIES (SUCH AS GRADES, INVERT ELEVATIONS, RIM ELEVATIONS, GRATE ELEVATIONS, BUILDING FINISHED FLOOR ELEVATIONS, ETC.) MAY BE FOUND IN MORE THAN ONE LOCATION IN THE CONTRACT DOCUMENTS. THE CONTRACTOR SHALL SUFFICIENTLY REVIEW ALL PLANS, PROFILES AND ANY OTHER INFORMATION IN THE CONTRACT DOCUMENTS FOR CONSISTENCY PRIOR TO CONSTRUCTION. ANY INCONSISTENCIES OR DISCREPANCIES THAT ARE FOUND BY THE CONTRACTOR OR HIS ASSIGNS SHALL BE IMMEDIATELY BROUGHT TO THE ATTENTION OF THE OWNER AND ENGINEER IN WRITING, IN THE FORMAT OF AN RFI PRIOR TO CONSTRUCTION.
- 5. ALL WORK SHALL BE PERFORMED IN ACCORDANCE WITH THE PROJECT DOCUMENTS, JURISDICTION STANDARDS AND SPECIFICATIONS, AND ALL OTHER APPLICABLE LOCAL AND STATE CODES AND ORDINANCES. THERE ARE ADDITIONAL NOTES. SPECIFICATIONS AND REQUIREMENTS CONTAINED THROUGHOUT THE PLAN SET AS WELL AS REFERENCES TO SPECIFICATIONS FROM APPLICABLE GOVERNING AUTHORITIES AND INDUSTRY STANDARDS. IT IS THE CONTRACTOR'S RESPONSIBILITY TO OBTAIN, REVIEW AND ADHERE TO ALL THESE DOCUMENTS.
- 6. CONSTRUCTION STAKING SHALL BE DONE BY A LICENSED LAND SURVEYOR REGISTERED IN THE STATE OF CALIFORNIA.
- 7. REVISIONS TO THESE PLANS MUST BE REVIEWED AND APPROVED IN WRITING BY THE CIVIL DESIGN ENGINEER PRIOR TO CONSTRUCTION OF AFFECTED ITEMS. REVISIONS SHALL BE ACCURATELY SHOWN ON REVISED PLANS.
- 8. STANDARD CONSTRUCTION ACTIVITIES SHALL BE LIMITED TO THE DAYS AND HOURS REGULATED BY THE JURISDICTION.
- 9. THE CONTRACTOR SHALL NOTIFY UNDERGROUND SERVICE ALERT AT (800) 642-2444 AND A PRIVATE UTILITY LOCATOR AT PRIOR TO THE START OF WORK TO VERIFY THE LOCATION OF EXISTING UNDERGROUND UTILITIES. THE UTILITIES SHOWN ON THESE PLANS ARE BASED UPON RECORD INFORMATION. HOWEVER, THE CIVIL DESIGN ENGINEER ASSUMES NO RESPONSIBILITY FOR THEIR SIZE, ACCURACY OR ACTUAL LOCATIONS.
- 10. THE CONTRACTOR SHALL RESTORE TO THEIR PREVIOUS CONDITION OR REPLACE STRUCTURES TO REMAIN WHICH ARE DAMAGED DUE TO THE CONTRACTOR'S WORK AT THEIR OWN EXPENSE.
- 11. THE CONTRACTOR SHALL ABIDE BY THE RULES AND REGULATIONS OF THE STATE OF CALIFORNIA CONSTRUCTION SAFETY ORDERS PERTAINING TO EXCAVATIONS AND TRENCHES. EXCAVATIONS SHALL BE ADEQUATELY SHORED, BRACED, AND SHEATHED SO THAT THE EARTH WILL NOT SLIDE OR SETTLE AND SO THAT THE EXISTING IMPROVEMENTS WILL BE FULLY PROTECTED FROM DAMAGE. DAMAGE RESULTING FROM A LACK OF ADEQUATE SHORING, BRACING, AND SHEATHING SHALL BE THE RESPONSIBILITY OF THE CONTRACTOR AND SHALL BE REPAIRED OR RECONSTRUCTED AT THE CONTRACTORS EXPENSE.
- 12. TRENCHES SHALL NOT BE LEFT OPEN OVERNIGHT. CONTRACTOR SHALL BACKFILL TRENCHES, OR PLACE STEEL PLATING OR HOT-MIX ASPHALT AS REQUIRED TO PROTECT OPEN TRENCHES AT THE END OF EACH WORK DAY.
- 13. THE CONTRACTOR SHALL PROVIDE DUST CONTROL FOR THE ENTIRE PROJECT SITE AND REMAIN COMPLIANT WITH THE REGIONAL WATER QUALITY CONTROL BOARD REGULATIONS. THE SITE SHALL BE SPRINKLED AS NECESSARY TO PREVENT DUST NUISANCE.
- 14. UPON SATISFACTORY COMPLETION OF THE WORK, THE WORK SITE SHALL BE CLEANED UP AND LEFT WITH A SMOOTH AND NEATLY GRADED SURFACE FREE OF CONSTRUCTION DEBRIS OF ANY NATURE BY THE CONTRACTOR TO THE SATISFACTION OF THE OWNER.
- 15. THE CONTRACTOR SHALL POST ON SITE EMERGENCY TELEPHONE NUMBERS FOR JURISDICTION ENGINEER, AMBULANCE, POLICE, FIRE DEPARTMENTS, AND THOSE AGENCIES RESPONSIBLE FOR MAINTENANCE OF UTILITIES IN THE VICINITY OF THE JOB SITE.
- 16. THE CONTRACTOR SHALL BE AWARE THAT DEWATERING ACTIVITIES SHALL COMPLY WITH THE CONDITIONS OF THE REGIONAL WATER QUALITY CONTROL BOARD GENERAL PERMIT OF CONSTRUCTION SITES.

UTILITIES:

- 1. THE CONTRACTOR IS SPECIFICALLY CAUTIONED THAT THE LOCATION AND/OR ELEVATION OF EXISTING UTILITIES AS SHOWN ON THESE PLANS IS BASED ON RECORDS OF THE VARIOUS UTILITY COMPANIES. THE INFORMATION IS NOT TO BE RELIED ON AS BEING EXACT OR COMPLETE. THE CONTRACTOR MUST CALL THE APPROPRIATE UTILITY COMPANY AT LEAST 72 HOURS PRIOR TO ANY EXCAVATION TO REQUEST EXACT FIELD LOCATION OF UTILITIES. IT SHALL BE THE RESPONSIBILITY OF THE CONTRACTOR TO RELOCATE ALL EXISTING UTILITIES WHICH CONFLICT WITH THE PROPOSED IMPROVEMENTS SHOWN ON THE PLANS IN A MANNER WHICH WILL NOT NEGATIVELY AFFECT ANY EXISTING USERS OF THESE UTILITIES.
- 2. THE CONTRACTOR SHALL LOCATE ALL EXISTING UTILITY, INCLUDING BUT NOT LIMITED TO: WATER, SEWER, GAS, ELECTRIC & TELECOMMUNICATIONS, LOCATIONS, INVERTS AND CONDITIONS PRIOR TO CONSTRUCTION. ANY CONDITIONS FOUND TO DIFFER FROM THOSE SHOWN ON THE PLANS AND REQUIRING MODIFICATIONS TO THE DESIGN SHALL BE IMMEDIATELY BROUGHT TO THE ATTENTION OF THE ENGINEER PRIOR TO CONSTRUCTION. DIFFERING UTILITY CONDITIONS THAT ARE ENCOUNTERED BY THE CONTRACTOR, THAT REQUIRE MODIFICATION OF DESIGN THAT ARE NOT BROUGHT TO THE ATTENTION OF THE ENGINEER PRIOR TO CONSTRUCTION SHALL BE THE RESPONSIBILITY OF THE CONTRACTOR TO CORRECT AT NO ADDITIONAL COST.
- 3. CONTRACTOR SHALL REFER TO ARCHITECTURAL PLANS AND SPECIFICATIONS FOR ACTUAL LOCATIONS OF ALL UTILITY ENTRANCES INCLUDING, BUT NOT LIMITED TO SANITARY SEWER, STORM SEWER, DOMESTIC WATER, FIRE WATER, IRRIGATION WATER, GAS SERVICE, ELECTRICAL SERVICE, AND TELECOMMUNICATIONS, CONTRACTOR SHALL COORDINATE INSTALLATION OF UTILITIES IN SUCH A MANNER AS TO AVOID CONFLICTS AND ASSURE PROPER DEPTHS AND LOCATIONS ARE ACHIEVED AS WELL AS COORDINATING WITH THE GOVERNING UTILITY COMPANIES FOR APPROVAL OF UTILITY LOCATIONS AND SCHEDULING OF CONNECTIONS TO THEIR FACILITIES.
- 4. THE LOCATION OF EXISTING GAS AND ELECTRICAL MAINS ARE APPROXIMATE. THE CONTRACTOR MUST CONSULT WITH PG&E FOR ADDITIONAL INFORMATION. ALL PROPOSED GAS AND ELECTRICAL WORK SHALL BE IN CONFORMANCE WITH APPLICABLE LOCAL AND STATE CODES AND ORDINANCES AND PG&E REQUIREMENTS. MINIMUM DEPTH OF COVER OVER ELECTRICAL, GAS AND TELECOMMUNICATIONS SHALL BE TWO FEET.

RECORD DRAWINGS:

1. CONTRACTOR SHALL KEEP ACCURATE AS-BUILT DRAWINGS WHICH SHOW THE FINAL LOCATION, ELEVATION, AND DESCRIPTION OF WORK. CONTRACTOR SHALL ALSO NOTE THE LOCATION AND ELEVATION OF EXISTING IMPROVEMENTS ENCOUNTERED. PROVIDE THE AS-BUILTS TO THE PROJECT ARCHITECT AT THE COMPLETION OF WORK.

STATEMENT OF RESPONSIBILITY:

- 1. CONSTRUCTION CONTRACTOR AGREES THAT IN ACCORDANCE WITH GENERALLY ACCEPTED CONSTRUCTION PRACTICES, CONSTRUCTION CONTRACTOR WILL BE REQUIRED TO ASSUME SOLE AND COMPLETE RESPONSIBILITY FOR JOB SITE CONDITIONS DURING THE COURSE OF CONSTRUCTION OF THE PROJECT, INCLUDING SAFETY OF ALL PERSONS AND PROPERTY. THIS REQUIREMENT SHALL BE MADE TO APPLY CONTINUOUSLY AND NOT BE LIMITED TO NORMAL WORKING HOURS. CONSTRUCTION CONTRACTOR FURTHER AGREES TO DEFEND, INDEMNIFY AND HOLD DESIGN PROFESSIONAL HARMLESS FROM ANY AND ALL LIABILITY, REAL OR ALLEGED, IN CONNECTION WITH THE PERFORMANCE OF WORK ON THIS PROJECT, EXCEPTING LIABILITY ARISING FROM THE SOLE NEGLIGENCE OF THE DESIGN PROFESSIONAL.
- 2. CONTRACTOR SHALL COMPLY WITH FEDERAL, STATE, COUNTY, AND JURISDICTION LAWS, REGULATIONS, AND ORDINANCES.

<u>CONCRETE (SITE WORK):</u>

- CONCRETE.
- BETWEEN REINFORCEMENT.
- STRUCTURE.
- 7. DAYS.

- PLACING CONCRETE.
- CONSTRUCTION)

<u>GRADING NOTES</u>

- 17. SOIL COMPACTION SHALL BE PERFORMED PER THE RECOMMENDATIONS IN THE SOILS REPORT.

- DRAINAGE NOTES:

1. CONCRETE SHALL HAVE A MINIMUM ULTIMATE COMPRESSIVE STRENGTH OF 3000 PSI AT 28 DAYS, UNLESS OTHERWISE NOTED. 2. ALL EQUIPMENT FOR MIXING AND TRANSPORTING CONCRETE SHALL BE CLEAN.

FORMS SHOULD BE PROPERLY COATED WITH CONCRETE FORM RELEASE AGENT.

4. ALL LAITANCE AND OTHER UNSOUND MATERIAL SHALL BE REMOVED BEFORE ADDITIONAL CONCRETE IS PLACED AGAINST HARDENED

5. CONCRETING SHALL BE CARRIED ON AT SUCH RATE THAT CONCRETE IS AT ALL TIMES PLASTIC AND FLOWS READILY INTO SPACES

6. CONCRETE THAT HAS PARTIALLY HARDENED OR BEEN CONTAMINATED BY FOREIGN MATERIALS SHALL NOT BE DEPOSITED IN THE

CONCRETE NORMAL WEIGH READY MIX CONFORMING TO CBC STANDARD 6-13-8 DEVELOPING COMPRESSIVE STRENGTH AT 28

8. ALL CONCRETE SHALL BE MIXED, FORMED AND PLACED ACCORDING TO THE A.C.I. CODE AND 2016 CBC.

9. CEMENT FOR CONCRETE SHALL BE A STANDARD BRAND "PORTLAND CEMENT," MEETING THE REQUIREMENTS OF ASTM C150. 10. AGGREGATES FOR CONCRETE SHALL MEET THE REQUIREMENTS OF ASTM C33.

11. CONCRETE MIX SHALL BE DESIGNED BY AN APPROVED TESTING LABORATORY OR SHALL CONFORM TO MIX DESIGN REQUIREMENTS ESTABLISHED BY THE 2016 CBC.

12. BEFORE CONCRETE IS POURED, CHECK WITH ALL TRADES FOR PROPER PLACEMENT OF SLEEVES, CONDUITS, ETC. 13. ALL REINFORCING BARS, ANCHOR BOLTS AND OTHER CONCRETE INSERTS SHALL BE WELL SECURED IN POSITION PRIOR TO

14. CONCRETE SHALL NOT FALL MORE THAN 1.8 M (6 FEET) (GREEN BOOK – STANDARD SPECIFICATIONS FOR PUBLIC WORKS

1. ALL WORK SHALL CONFORM TO RECOMMENDATIONS SPECIFIED IN THE SOIL ENGINEERING INVESTIGATION.

2. THE CONTRACTOR OR ANY SUBCONTRACTOR SHALL NOTIFY UNDERGROUND SERVICE ALERT ONE CALL PROGRAM 48 HOURS IN ADVANCE OF PERFORMING EXCAVATION WORK BY CALLING THE TOLL-FREE NUMBER 800-227-2600. EXCAVATION IS DEFINED AS BEING 18 OR MORE INCHES IN DEPTH BELOW THE EXISTING GROUND.

EROSION CONTROL MEASURES SHALL BE IN PLACE AT THE END OF EACH WORKING DAY, BETWEEN OCTOBER 15 AND APRIL 15. 4. ACTUAL GRADING SHALL BEGIN WITHIN 30 DAYS OF VEGETATION REMOVAL OR THE AREA SHALL BE PLANTED TO CONTROL EROSION. SURFACE PLANT GROWTH ONLY AND WHICH DOES NOT EXCEED 4 INCHES IN DEPTH.

5. CONTRACTOR SHALL NOTIFY THE JURISDICTION 48 HOURS PRIOR TO THE INTENTION TO COMMENCE WORK.

6. A COPY OF ALL FIELD REPORTS/COMPACTION TESTS, AND FINAL GRADING REPORT SHALL BE SUBMITTED TO THE JURISDICTION AT SCHEDULED INSPECTIONS.

7. CUT AND FILL SLOPES SHALL BE NO STEEPER THAN THREE HORIZONTAL TO ONE VERTICAL PER GEOTECHNICAL REPORT.

8. THE GROUND IMMEDIATELY ADJACENT TO THE FOUNDATION SHALL BE SLOPED AWAY FROM THE BUILDING AT A SLOPE OF NOT LESS THAN ONE UNIT VERTICAL IN 20 UNITS HORIZONTAL (5% SLOPE) FOR A MINIMUM DISTANCE OF 10 FEET (3048 MM) MEASURED PERPENDICULAR TO THE FACE OF THE WALL. IF PHYSICAL OBSTRUCTIONS OR LOT LINES PROHIBIT 10 FEET (3048 MM) OF HORIZONTAL DISTANCE A 5% SLOPE SHALL BE PROVIDED TO AN APPROVED ALTERNATIVE METHOD OF DIVERTING WATER AWAY FROM THE FOUNDATION. SWALES USED FOR THIS PURPOSE SHALL BE SLOPED A MINIMUM OF 2% WHERE LOCATED WITHIN 10 FEET (3048 MM) OF THE BUILDING FOUNDATION. IMPERVIOUS SURFACES WITHIN 10 FEET (3048 MM) OF THE BUILDING SHALL BE SLOPED A MINIMUM OF 2% AWAY FROM THE BUILDING. ALL GRADING SHALL BE CONTOURED TO KEEP STORM DRAINAGE ON THE LOT OF ORIGIN.

9. THE CONTRACTOR SHALL REMOVE ALL OBSTRUCTIONS, BOTH ABOVE GROUND AND UNDERGROUND AS NECESSARY FOR THE CONSTRUCTION OF THE PROPOSED IMPROVEMENTS.

10. CONTRACTOR TO CONTACT GEOTECHNICAL/SOILS ENGINEER AT LEAST 5 DAYS PRIOR TO COMMENCEMENT OF GRADING WORK, OR AS DIRECTED BY THE GEOTECHNICAL ENGINEER/SOILS ENGINEER.

11. CONTRACTOR SHALL SUPPLY ALL EQUIPMENT, LABOR AND MATERIALS NECESSARY TO PERFORM THE WORK SHOWN ON THIS PLAN.

12. CONTRACTOR SHALL VERIFY ALL DIMENSIONS AND CONDITIONS ON THE JOB, AND SHALL NOTIFY THE ENGINEER OF ANY VARIATION FROM THE DIMENSIONS AND CONDITIONS SHOWN. WRITTEN DIMENSIONS SHALL TAKE PRECEDENCE OVER SCALED DIMENSIONS.

13. THE CONTRACTOR AGREES THAT IN ACCORDANCE WITH GENERALLY ACCEPTED CONSTRUCTION PRACTICES, CONSTRUCTION CONTRACTOR WILL BE REQUIRED TO ASSUME SOLE AND COMPLETE RESPONSIBILITY FOR THE JOB SITE CONDITIONS DURING THE COURSE OF CONSTRUCTION OF THE PROJECT, INCLUDING SAFETY OF ALL PERSONS AND PROPERTY, THAT THIS REQUIREMENT SHALL BE MADE TO APPLY CONTINUOUSLY AND NOT BE LIMITED TO NORMAL WORKING HOURS.

14. ANY DISCREPANCIES OR OMISSIONS FOUND IN THE CONTRACT DOCUMENTS SHALL BE REPORTED TO THE DESIGN ENGINEER IMMEDIATELY. THE DESIGN ENGINEER WILL CLARIFY DISCREPANCIES OR OMISSIONS, IN WRITING, WITHIN A REASONABLE TIME.

15. CONTRACTOR SHALL MINIMIZE THE VOLUME OF RECYCLABLE MATERIALS SENT TO AREA LANDFILLS.

16. THE EXPORTED SOILS FROM THIS SITE SHALL BE REMOVED AND DISPOSED OF IN A MANNER AND LOCATION ACCEPTABLE TO THE JURISDICTION FOLLOWING THE REQUIREMENTS OF ALL APPLICABLE CITY, STATE, AND FEDERAL LAWS OR ORDINANCES.

18. RETAINING WALLS REQUIRE A SEPARATE BUILDING PERMIT.

19. PAD ELEVATION/S SHALL BE CERTIFIED TO 0.1 FEET. PRIOR TO DIGGING ANY FOOTINGS OR SCHEDULING ANY INSPECTIONS.

20. THE GROUND SURFACE SHALL BE PREPARED TO RECEIVE FILL BY REMOVING VEGETATION. NON-COMPLYING FILL, TOPSOIL AND OTHER UNSUITABLE MATERIALS SCARIFYING TO PROVIDE A BOND WITH THE NEW FILL.

21. A STATE LICENSED SURVEYOR SHALL VERIFY THE LOCATION OF THE FOUNDATION ON THE LOT PRIOR TO CITY FOOTING/FOUNDATION INSPECTION. SURVEYOR'S DOCUMENTATION SHALL BE PROVIDED AT TIME OF CITY INSPECTION.

22. A STATE LICENSED SURVEYOR SHALL VERIFY THE BUILDING HEIGHT PRIOR TO CITY ROOF FRAMING INSPECTION. SURVEYOR'S DOCUMENTATION SHALL BE PROVIDED AT TIME OF CITY INSPECTION.

23. A PRE-CONSTRUCTION SITE MEETING INCLUDING THE CONTRACTOR, DESIGNER, BUILDING INSPECTOR, AND ENVIRONMENTAL COMPLIANCE MANAGER SHALL BE SCHEDULED AT LEAST 48 HOURS PRIOR TO BEGINNING ANY WORK ON THE PROJECT.

1. SD PIPES SHALL BE 6-INCH SDR-35 TYPE. FOUNDATION DRAINS SHALL BE 4-INCH SDR-35 TYPE.

2. DI'S SHALL BE CHRISTY V24 OR APPROVED EQUIVALENT, UNLESS OTHERWISE NOTED.

3. DRAIN INLET GRATES TO BE SPECIFIED BY ARCHITECT.

4. DOWNSPOUT LOCATIONS ARE APPROXIMATE. REFER TO ARCHITECTURAL PLANS FOR EXACT LOCATIONS.

5. CONTRACTOR SHALL INSTALL CLEANOUTS AT ENDS AND BENDS WHERE APPLICABLE.

SOILS ENGINEER INSPECTION NOTES:

1. THE GENERAL CONTRACTOR SHALL HAVE THE SOILS REPORT ONSITE AS PART OF THE CONSTRUCTION CONTRACT DOCUMENTS. THE RECOMMENDATION IN THE SOILS REPORT SHALL APPLIED TO THE PROJECT BY THE GENERAL CONTRACTOR.

2. THE SOILS ENGINEER SHALL REVIEW AND APPROVE THE GRADING, DRAINAGE, AND FOUNDATION PLANS PRIOR TO CONSTRUCTION. PROVIDE A SIGNED AND SEALED LETTER FROM THE SOILS ENGINEER ATTESTING TO HIS/HER APPROVAL OF THE REFERENCED PLANS.

3. GEOTECHNICAL ENGINEERS SHALL PROVIDE DETERMINATION OF RE-COMPACTION FOR LOOSE SOIL CONDITIONS.

4. GEOTECHNICAL ENGINEER SHALL DETERMINE DEPTH OF ANY NECESSARY SUB-EXCAVATION.

5. GRADING, FILLING, COMPACTION OPERATIONS, AND FOUNDATION EXCAVATIONS SHALL BE INSPECTED AND TESTED BY GEOTECHNICAL ENGINEER.

6. UTILITY TRENCH BACKFILL MATERIAL SHALL BE APPROVED BY THE GEOTECHNICAL ENGINEER PRIOR TO USE AS TRENCH BACKFILL.

EGEND & ABBREVIATIONS:			PROJECT INFORMATION:		
		PROPERTY LINE	PROJECT NAME:	RAINEY RESIDENCE	
	129— —	CONTOUR	PROJECT ADDRESS:	LINCOLN STREET, 5 SW OF 10TH AVE	
1	28.54	SPOT GRADE		CARMEL-BY-THE-SEA, CA 93923	
I	AD	AREA DRAIN	APN:	010-082-004	
	CO	CLEANOUT	PURPOSE OF GRADING:	NEW SINGLE FAMILY DWELLING	
	DI	DRAIN INLET		NEW SINGLE PAWIET DWELLING	
	DS	DOWNSPOUT			
	(E)	EXISTING	BENCHMARK:		
	FFE	FINISHED FLOOR ELEVATION		TAMPED "CENTRAL COAST SURVEYORS"	
FG ⊕		FINISHED GRADE	IN AC PAVEMENT; ELEV 146.00 (~NAVD88)		
	DRAIN INLET SURFACE FLOW	GEOTECHNICAL REPORT: ALL WORK TO COMPLY WITH THE RECOMMENDATIONS IN THE GEOTI			
	BW	BOTTOM OF WALL			
	\bigotimes	TREE			
	TD	TRENCH DRAIN			
	HP	HIGH POINT			

<u>CIVIL SHEET INDEX:</u>

SHEET	DESCRIPTION
C0.1	PROJECT INFORMATION & NOTES
C1.0	GRADING & DRAINAGE PLAN
C1.1	LOWER LEVEL DRAINAGE PLAN
C2.0	SECTIONS & DETAILS
C3.0	EROSION & SEDIMENT CONTROL (1 OF 2) / GRADING &
C3.1	EROSION & SEDIMENT CONTROL (2 OF 2)

QUANTITIES:

GRADING		CUT (CY)	FILL (CY)
FOUNDATION FOR NEW SFD		464	0
SITE WORK		13	28
PROPERTY AREA		7,000 SF (0.16 ACRE)	
SITE DISTURBANCE		4,800 SF (0).11 ACRE)

CARMEL-BY-THE-SEA CIVIL DRAWING MATRIX/CHECKLIST:

PLANS STAMPED AND SIGNED	SHEET C0.1, C1.0, C1.1, C2.0, C3.0, C3.1
NORTH ARROW AND SCALE	SHEET C0.1, C1.0, C1.1, C2.0, C3.0, C3.1
TITLE BLOCK	SHEET C0.1, C1.0, C1.1, C2.0, C3.0, C3.1
LOT LINES AND RIGHT OF WAY	SHEET C1.0
LOCATIONS OF STRUCTURES ON SITE	SHEET C1.0
LOCATIONS OF STRUCTURES REAL ACTIONS	S&BC1SET
LOCATIONS OF UTILITY POLES VAULTS ETC	Shee Cle 一口
LOCATIONS OF DRIVEWAYS	SHEET C1.0
EROSION/DRAINAGE CONTROL PLAN/BMPS	SHEET C1.2
FINAL GRADING/DRAINAGE PLAN	SHEET C1.0
WATER QUALITY MITIGATION PLAN	SHEET C1.0
RUN-OFF CONTROL PLAN	SHEET C1.0

TECHNICAL



BENJAMINI INC . ENGINEERS

720 YORK STREET, STE 114 SAN FRANCISCO, CA 94110 415.550.2600 BENJAMINI.COM

RAINEY RESIDENCE

ADA CORRAL, AIA 505 W. 38TH ST, STE B AUSTIN, TX 78705 512.499.1591

STOCKER & ALLAIRE DAVID STOCKER 21 MANDEVILLE COURT

MONTEREY, CA 93940 831.375.1890

CONTRACTOR

CIVIL ENGINEER: BENJAMINI, INC 720 YORK ST #11 SAN FRANCISCO, CA 94110 415.550.2600

STRUCTURAL ENGINEER:

SAN FRANCISCO, CA 94103 415.778.8726x101


ENERGY CONSULTANT JOBE CORRAL ARCHITECTS STRANDBERG ENGINEERING MONTEREY ENERGY GROUP, ABE STALLCUP 26465 CARMEL RANCHO BLVD. SUITE #8 CARMEL, CA 93923 831.372.8328 LANDSCAPE ARCHITECT

> ESSICA M. NEAFSEY CARMEL, CA 93923 734.904.9152


LIGHTING DESIGNER: TUDIO LUMINA CHRISTINA BROWN 9411 CHAPEL DOWN STREE AUSTIN, TX 78729 512.382.1656

100'-0" = 137'-6" ABV SEA LEVE

01.29.2021

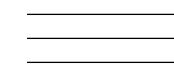

CONCEPT PROJECT REVIEW

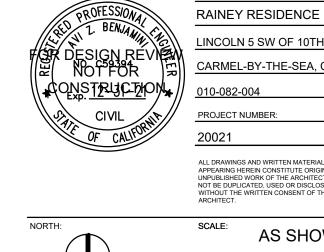



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LINCOLN 5 SW OF 10TH

ALL DRAWINGS AND WRITTEN MATERIA

PROJECT NUMBER

20021

CARMEL-BY-THE-SEA, CA 93923




PROJECT INFORMATION & NOTES



CALL BEFORE YOUR DIG

& OPERATION PLAN

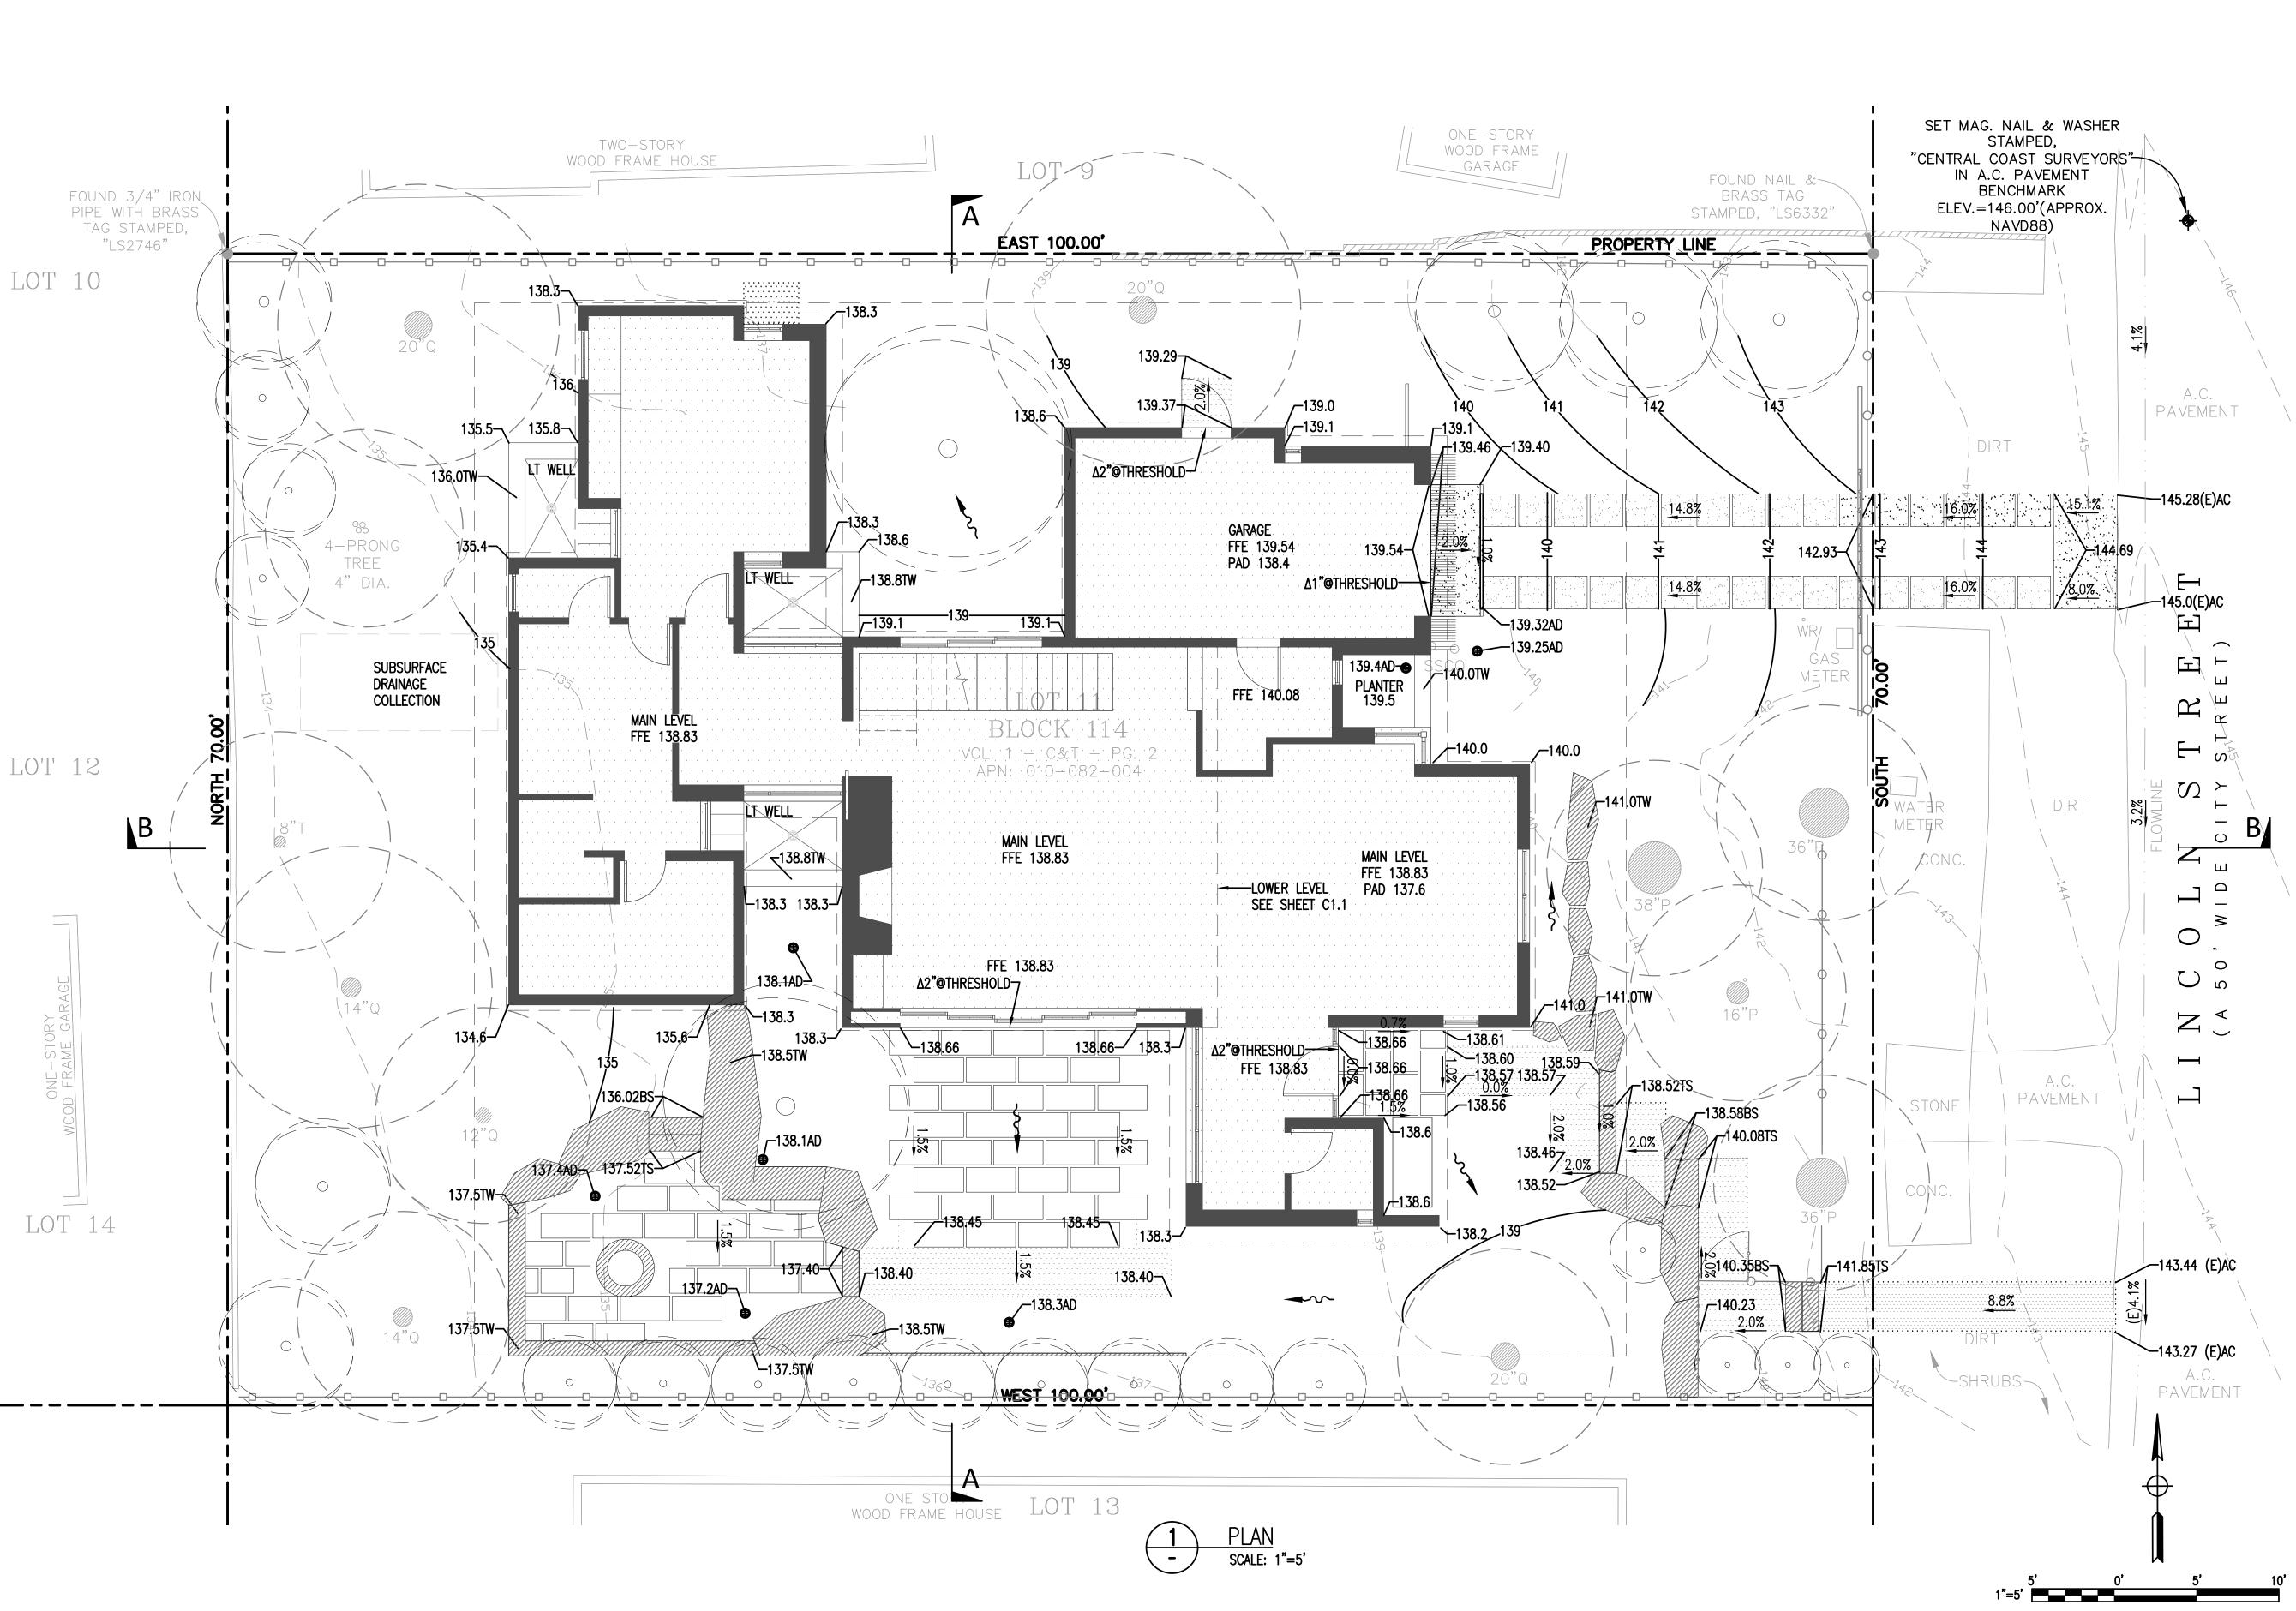



BENJAMINI INC CIVIL ENGINEERS

720 YORK STREET, STE 114 SAN FRANCISCO, CA 94110 415.550.2600 BENJAMINI.COM

RAINEY RESIDENCE

DESIGNER:

CONTRACTOR:

STOCKER & ALLAIRE DAVID STOCKER 21 MANDEVILLE COURT MONTEREY, CA 93940 831.375.1890

CIVIL ENGINEER: BENJAMINI, INC AVI BENJAMINI 720 YORK ST #114 SAN FRANCISCO, CA 94110 415.550.2600

STRUCTURAL ENGINEER: ENERGY CONSULTANT: JOBE CORRAL ARCHITECTS STRANDBERG ENGINEERING ADA CORRAL, AIA DAVID STRANDBERG ENGINEERING 505 W. 38TH ST, STE B 1511 15TH STREET AUSTIN, TX 78705 SAN FRANCISCO, CA 94103 512.499.1591 415.778.8726x101 CARMED CA 93923 CARMEL CA 93923 INC. ABE STALLCUP 26465 CARMEL RANCHO BLVD. SUITE #8 CARMEL, CA 93923 831.372.8328 LANDSCAPE ARCHITECT:

JMLA JESSICA M. NEAFSEY 3345 7TH AVE CARMEL, CA 93923 734.904.9152

LIGHTING DESIGNER: CHRISTING DESIGNER: STUDIO LUMINA CHRISTINA BROWN 9411 CHAPEL DOWN STREET AUSTIN, TX 78729 512.382.1656

NOTES: 100'-0" = 137'-6" ABV SEA LEVEL

ISSUE: 01.29.2021 CONCEPT PROJECT REVIEW PROJECT: RAINEY RESIDENCE LINCOLN 5 SW OF 10TH 010-082-004 CIVIL PROJECT NUMBER: 20021 ALL DRAWINGS AND WRITTEN MATER APPEARING HEREIN CONSTITUTE ORIGINAL AN UNPUBLISHED WORK OF THE ARCHITECT AND NOT BE DUPLICATED, USED OR DISCLOSED WITHOUT THE WRITTEN CONSENT OF THE ARCHITECT

CARMEL-BY-THE-SEA, CA 93923

1/8"

NORTH: (\square)

AS SHOWN

DRAWN BY:






GRADING & DRAINAGE

PLAN

C1.0

SCALE:

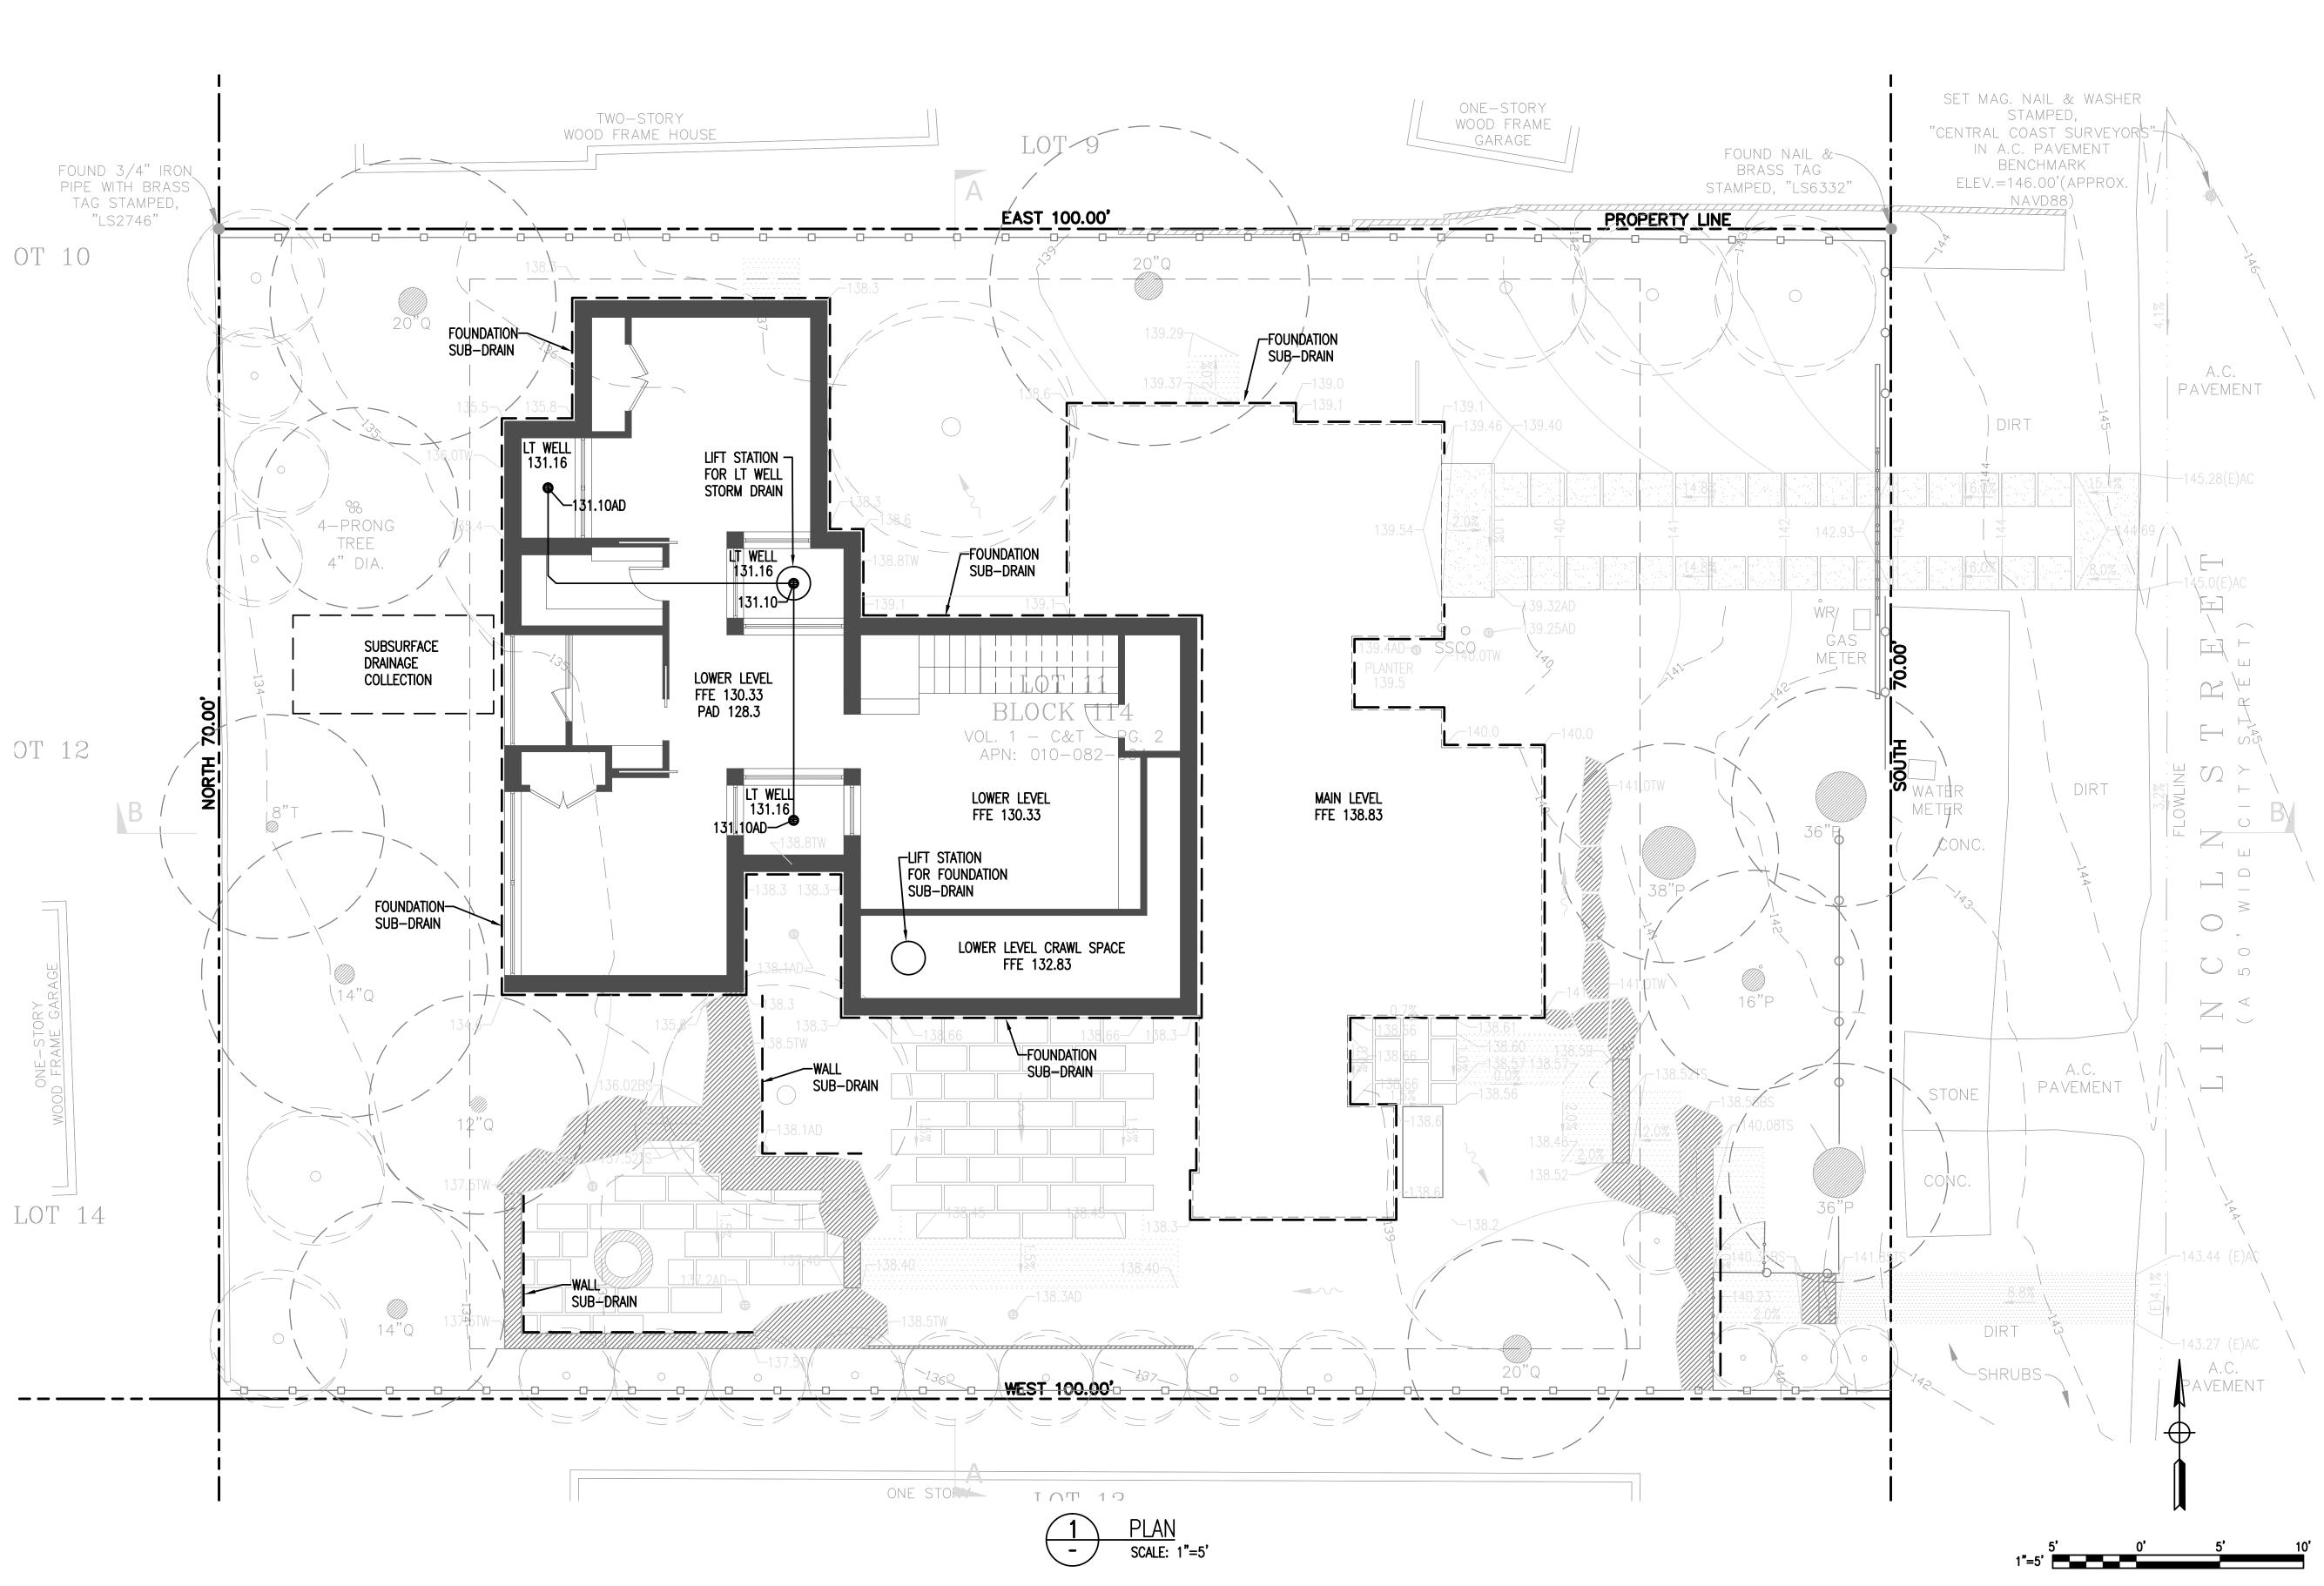



BENJAMINI INC CIVIL ENGINEERS 720 York Street, ste 114 San Francisco, ca 94110 415.550.2600

BENJAMINI.COM

RAINEY RESIDENCE

DESIGNER:

CONTRACTOR:

STOCKER & ALLAIRE DAVID STOCKER 21 MANDEVILLE COURT MONTEREY, CA 93940 831.375.1890

CIVIL ENGINEER: BENJAMINI, INC AVI BENJAMINI 720 YORK ST #114 SAN FRANCISCO, CA 94110 415.550.2600

JMLA JESSICA M. NEAFSEY 3345 7TH AVE CARMEL, CA 93923 734.904.9152

NOTES: 100'-0" = 137'-6" ABV SEA LEVEL

CONCEPT PROJECT REVIEW

PROJECT:

010-082-004

20021

SCALE:

1/8"

LOWER LEVEL DRAINAGE

PLAN

C1.1

DRAWN BY:

PROJECT NUMBER:

ALL DRAWINGS AND WRITTEN MATERIA


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AS SHOWN

RAINEY RESIDENCE

LINCOLN 5 SW OF 10TH

CARMEL-BY-THE-SEA, CA 93923

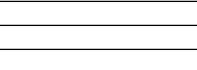

ISSUE:

01.29.2021

CONSTRUCTION

CIVIL

NORTH:

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CHRING DESIGNER: STUDIO LUMINA CHRISTINA BROWN 9411 CHAPEL DOWN STREET AUSTIN, TX 78729 512.382.1656

STRUCTURAL ENGINEER: ENERGY CONSULTANT:
 JOBE CORRAL ARCHITECTS
 STRANDBERG ENGINEERING
 MONTEREY ENERGY GROUP,


 ADA CORRAL, AIA
 DAVID STRANDBERG
 MONTEREY ENERGY GROUP,

 505 W. 38TH ST, STE B
 1511 15TH STREET
 MAE STALLCUP

 20465 CARMEL RANCHO BLVD.
 SAN FRANCISCO, CA 94103
 SUITE #8


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 INC. ABE STALLCUP 26465 CARMEL RANCHO BLVD. SUITE #8 CARMEL, CA 93923 831.372.8328 LANDSCAPE ARCHITECT:


LIGHTING DESIGNER:

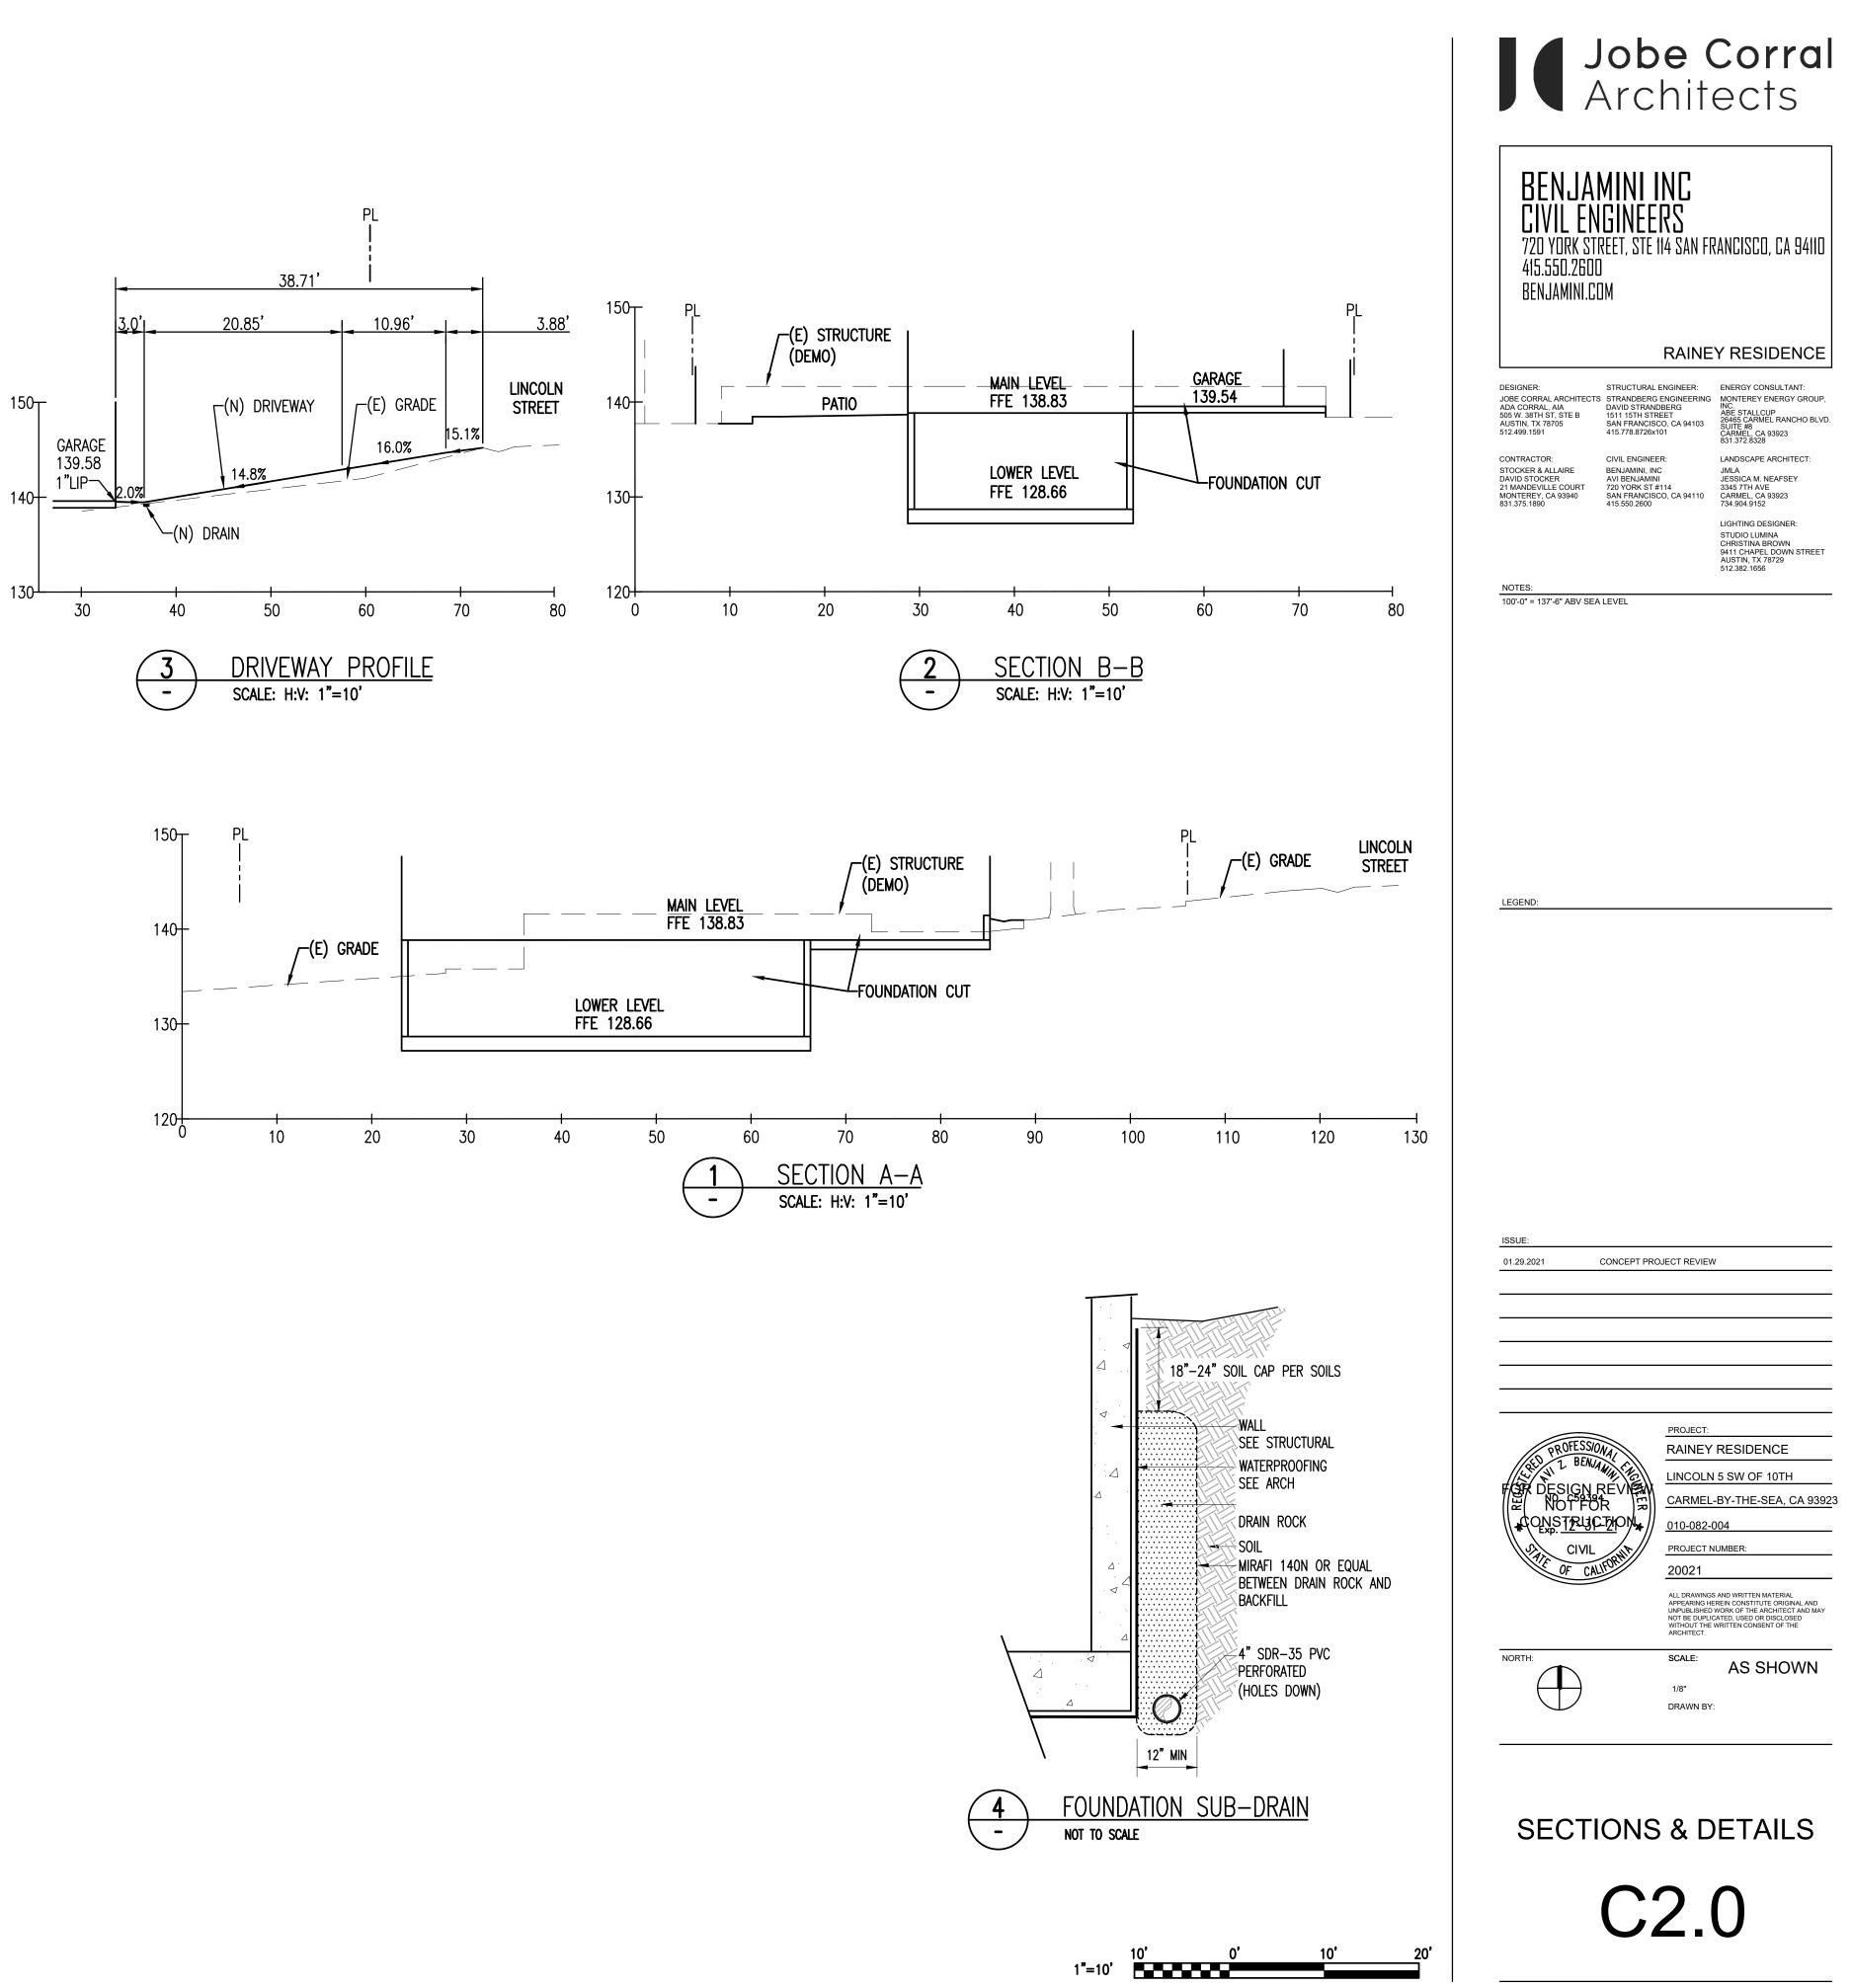


EROSION AND SEDIMENT CONTROL NOTES:

- ACTUAL GRADING SHALL BEGIN WITHIN 30 DAYS OF VEGETATION REMOVAL OR THE AREA SHALL BE PLANTED TO CONTROL EROSION. SURFACE PLANT GROWTH ONLY AND WHICH DOES 1. NOT EXCEED 4 INCHES IN DEPTH.
- 2. STABILIZE ALL GRADED AREAS WITH VEGETATION, CRUSHED STONE, RIPRAP, OR OTHER GROUND COVER AS SOON AS GRADING IS COMPLETED OR IF WORK IS INTERRUPTED FOR 14 WORKING DAYS OR MORE. USE MULCH TO STABILIZE AREAS TEMPORARILY WHERE FINAL GRADING MUST BE DELAYED.
- STOCKPILES, BORROW AREAS AND SPOIL AREAS SHALL BE STABILIZED TO PREVENT EROSION AND SEDIMENTATION.
- ALL DISTURBED SURFACES MUST BE PROTECTED FROM EROSION. ALL YEAR ROUND, EROSION CONTROL MEASURES MUST BE IN PLACE AND CONTINUOUSLY MAINTAINED. DISTURBANCE 4. OF SURFACE VEGETATION DURING CONSTRUCTION SHALL BE KEPT TO A MINIMUM.
- 5. ALL EROSION CONTROL MEASURES SHALL BE IN PLACE BY START OF CONSTRUCTION. EROSION CONTROL MEASURES SHALL BE MAINTAINED THROUGHOUT CONSTRUCTION. CONDITIONS OF EPCP SHALL BE FOLLOWED AT ALL TIMES, YEAR AROUND. REFER TO EROSION CONTROL PLANS/DETAILS FOR ADDITIONAL REQUIREMENTS.
- 6. ALL EROSION CONTROL FACILITIES MUST BE INSPECTED AND REPAIRED AS NECESSARY AT THE END OF EACH WORKING DAY OR AFTER SIGNIFICANT RAIN.
- CONTRACTOR IS RESPONSIBLE FOR INSPECTION AND RESTORATION OF ALL ASPECTS OF THE EROSION CONTROL PLAN. SEDIMENT ON THE SIDEWALKS AND GUTTERS SHALL BE REMOVED BY SHOVEL OR BROOM AND DISPOSED APPROPRIATELY.
- ALL EMPLOYEES, CONTRACTORS, AND SUBCONTRACTORS ARE RESPONSIBLE FOR CONFORMING TO THE ELEMENTS SHOWN ON THIS PLAN AND RELATED DOCUMENTS. 8.
- 9. CONTRACTOR TO EMPLOY BEST MANAGEMENT PRACTICES IN ACCORDANCE WITH THE STATE OF CALIFORNIA DEPARTMENT OF TRANSPORTATION.
- 10. ALL DUMPSTERS OR OTHER TRASH STORAGE ENCLOSURES SHALL BE UTILIZED SOLELY FOR NON-HAZARDOUS MATERIALS.
- 11. DURING THE RAINY SEASON. ALL PAVED AREAS WILL BE KEPT CLEAR OF EARTH MATERIAL AND DEBRIS. THE SITE SHALL BE MAINTAINED SO THAT A MINIMUM OF SEDIMENT-LADEN RUNOFF ENTERS THE STORM DRAIN SYSTEM. THESE PLANS SHALL REMAIN IN EFFECT UNTIL THE IMPROVEMENTS ARE ACCEPTED BY THE JURISDICTION AND ALL SLOPES ARE STABILIZED.
- 12. BORROW AREAS AND TEMPORARY STOCKPILES SHALL BE PROTECTED WITH APPROPRIATE EROSION CONTROL MEASURES TO THE SATISFACTION OF THE JURISDICTION.
- 13. REMOVE SPOILS PROMPTLY AND AVOID STOCKPILING OF FILL MATERIALS WHEN RAIN IS FORECAST. IF RAIN IS FORECAST OR APPARENT, STOCKPILED SOILS AND OTHER MATERIALS SHALL BE COVERED WITH PLASTIC OR A TARP, AT THE REQUEST OF THE JURISDICTION.
- 14. STORE, HANDLE AND DISPOSE OF CONSTRUCTION MATERIALS AND WASTES SO AS TO PREVENT THEIR ENTRY INTO THE STORM DRAIN SYSTEM. CONTRACTOR MUST NOT ALLOW CONCRETE, WASHWATERS, SLURRIES, PAINT OR OTHER MATERIALS TO ENTER THE CATCH BASINS, STORM DRAINAGE, OR ENTER SITE RUNOFF.
- 15. NO CLEANING, FUELING OR MAINTAINING VEHICLES ON SITE SHALL BE PERMITTED TO ALLOW DELETERIOUS MATERIALS FROM ENTERING THE CATCH BASINS, STORM DRAINAGE, OR ENTER SITE RUNOFF.
- 16. CONTRACTOR SHALL BE RESPONSIBLE FOR STREET SWEEPING TO KEEP DUST, SOIL, AND OTHER CONSTRUCTION DEBRIS FROM LEAVING PROJECT SITE.
- 17. CONTRACTOR WILL PROVIDE AND MAINTAIN A CAL-TRANS APPROVED CONCRETE WASH OUT. CONTRACTOR WILL PROVIDE AND MAINTAIN ACCESS TO WASH OUT FACILITIES.
- 18. CONTRACTOR SHALL SUSPEND EXCAVATION AND GRADING ACTIVITY WHEN WINDS (INSTANTANEOUS GUSTS) EXCEED 25 MPH.
- 19. CONTRACTOR SHALL INSTALL SANDBAGS OR OTHER EROSION CONTROL MEASURES TO PREVENT SILT RUNOFF TO PUBLIC RIGHT-OF-WAYS.
- 20. CONTRACTOR SHALL SWEEP STREETS DAILY WITH WATER SWEEPERS, IF VISIBLE AMOUNTS OF SOIL MATERIAL ARE CARRIED ONTO PUBLIC STREETS.
- 21. CONTRACTOR SHALL PAVE, APPLY WATER THREE TIMES DAILY, OR APPLY NON-TOXIC SOIL STABILIZERS ON ALL UNPAVED PARKING AREAS AND STAGING AREAS AT CONSTRUCTION SITES, TO MINIMIZE DUST POLLUTION.
- 22. SPECIAL INSPECTIONS, BY A SPECIAL INSPECTOR, ARE REQUIRED DURING AFILL PLACEMENT AND THAT PROPER MATERIALS AND PROCEDURES ARE USED IN ACCORDANCE WITH THE PROVISIONS OF THE APPROVED GEOTECHNICAL REPORT (CBC 1705.6)
- 23. ALL OR PART OF THE CONSTRUCTION OF THIS PROJECT IS EXPECTED TO OCCUR DURING THE WINTER SEASON (OCT 15 THROUGH APRIL 15)
- 24. NO VEGETATION REMOVAL OR GRADING WILL BE ALLOWED WHICH RESULT IN SILTATION OF WATER COURSES OR UNCONTROLLABLE EROSION (CMC TITLE 17).
- 25. DUST FROM GRADING OPERATIONS MUST BE CONTROLLED. THE OWNER OR CONTRACTOR MAY BE REQUIRED TO KEEP ADEQUATE EQUIPMENT ON THE GRADING SITE TO PREVENT DUST PROBLEMS (MCC 16.08.340).
- 26. IT SHALL BE THE RESPONSIBILITY OF THE OWNER AND THE PERMITTEE TO ENSURE THAT EROSION DOES NOT OCCUR FROM AN ACTIVITY DURING OR AFTER PROJECT CONSTRUCTION. ADDITIONAL MEASURES, BEYOND THIOSE SPECIFIED, MAY BE REQUIRED AS DEEMED NECESSARY TO CONTROL ACCELERATED EROSION (MCC 16.12.100).
- 27. TEMPORARY EROSION CONTROL TO BE INSTALLED BETWEEN OCTOBER 1 AND APRIL 15.
- 28. THE DIRECTOR OF BUILDING INSPECTION (BUILDING OFFICIAL) SHALL STOP OPERATIONS DURING PERIODS OF INCLEMENT WEATHER IF HE OR SHE DETERMINES THAT EROSION PROBLEMS ARE NOT BEING CONTROLLED ADEQUATELY (CMC TITLE 15).
- 29. PRIOR TO COMMENCEMENT OF ANY LAND DISTURBANCE, THE OWNER/APPLICANT SHALL SCHEDULE AN INSPECTION WITH CITY OF CARMEL ENVIRONMENTAL COMPLIANCE MANAGER AND BUILDING INSPECTOR TO ENSURE ALL NECESSARY SEDIMENT CONTROLS ARE IN PLACE AND THE PROJECT IS COMPLIANT WITH CITY OF CARMEL EROSION CONTROL AND GRADING REGULATIONS.
- 30. DURING CONSTRUCTION THE OWNER/APPLICANT SHALL SCHEDULE AN INSPECTION WITH CARMEL BUILDING SAFETY DIVISION AND ENVIRONMENTAL COMPLIANCE MANAGER TO UPDATE COMPACTION TEST RECORDS, INSPECT DRAINAGE DEVICE INSTALLATION, REVIEW THE MAINTENANCE AND EFFECTIVENESS OF BMPS INSTALLED, AS WELL AS, TO VERIFY THAT POLLUTANTS OF CONCERN ARE NOT DISCHARGED FROM THE SITE.
- 31. PRIOR TO FINAL INSPECTION, THE OWNER/APPLICANT SHALL SCHEDULE AN INSPECTION WITH RMA-ENVIRONMENTAL SERVICES TO CONDUCT A FINAL GRADING INSPECTION, COLLECT FINAL GEOTECHNICAL LETTER OF CONFORMANCE, ENSURE THAT ALL DISTURBED AREAS HAVE BEEN STABILIZED AND THAT ALL TEMPORARY EROSION AND SEDIMENT CONTROL MEASURES THAT ARE NO LONGER NEEDED HAVE BEEN REMOVED.
- 32. SUFFICIENTLY WET THE STRUCTURE PRIOR TO DECONSTRUCTION OR DEMOLITION. CONTINUE WETTING AS NECESSARY DURING ACTIVE DECONSTRUCTION OR DEMOLITION AND THE DEBRIS.
- 33. DEMOLISH THE STRUCTURE INWARD TOWARD THE BUILDING PAD. LAY DOWN ROOF AND WALLS SO THAT THEY FALL INWARD AND NOT AWAY FROM THE BUILDING.
- 34. COMMENCEMENT OF DECONSTRUCTION OR DEMOLITION ACTIVITIES SHALL BE PROHIBITED WHEN THE PEAK WIND SPEED EXCEEDS 15 MILES PER HOUR. ALL AIR DISTRICT STANDARS SHALL BE ENFORCED BY THE AIR DISTRICT.

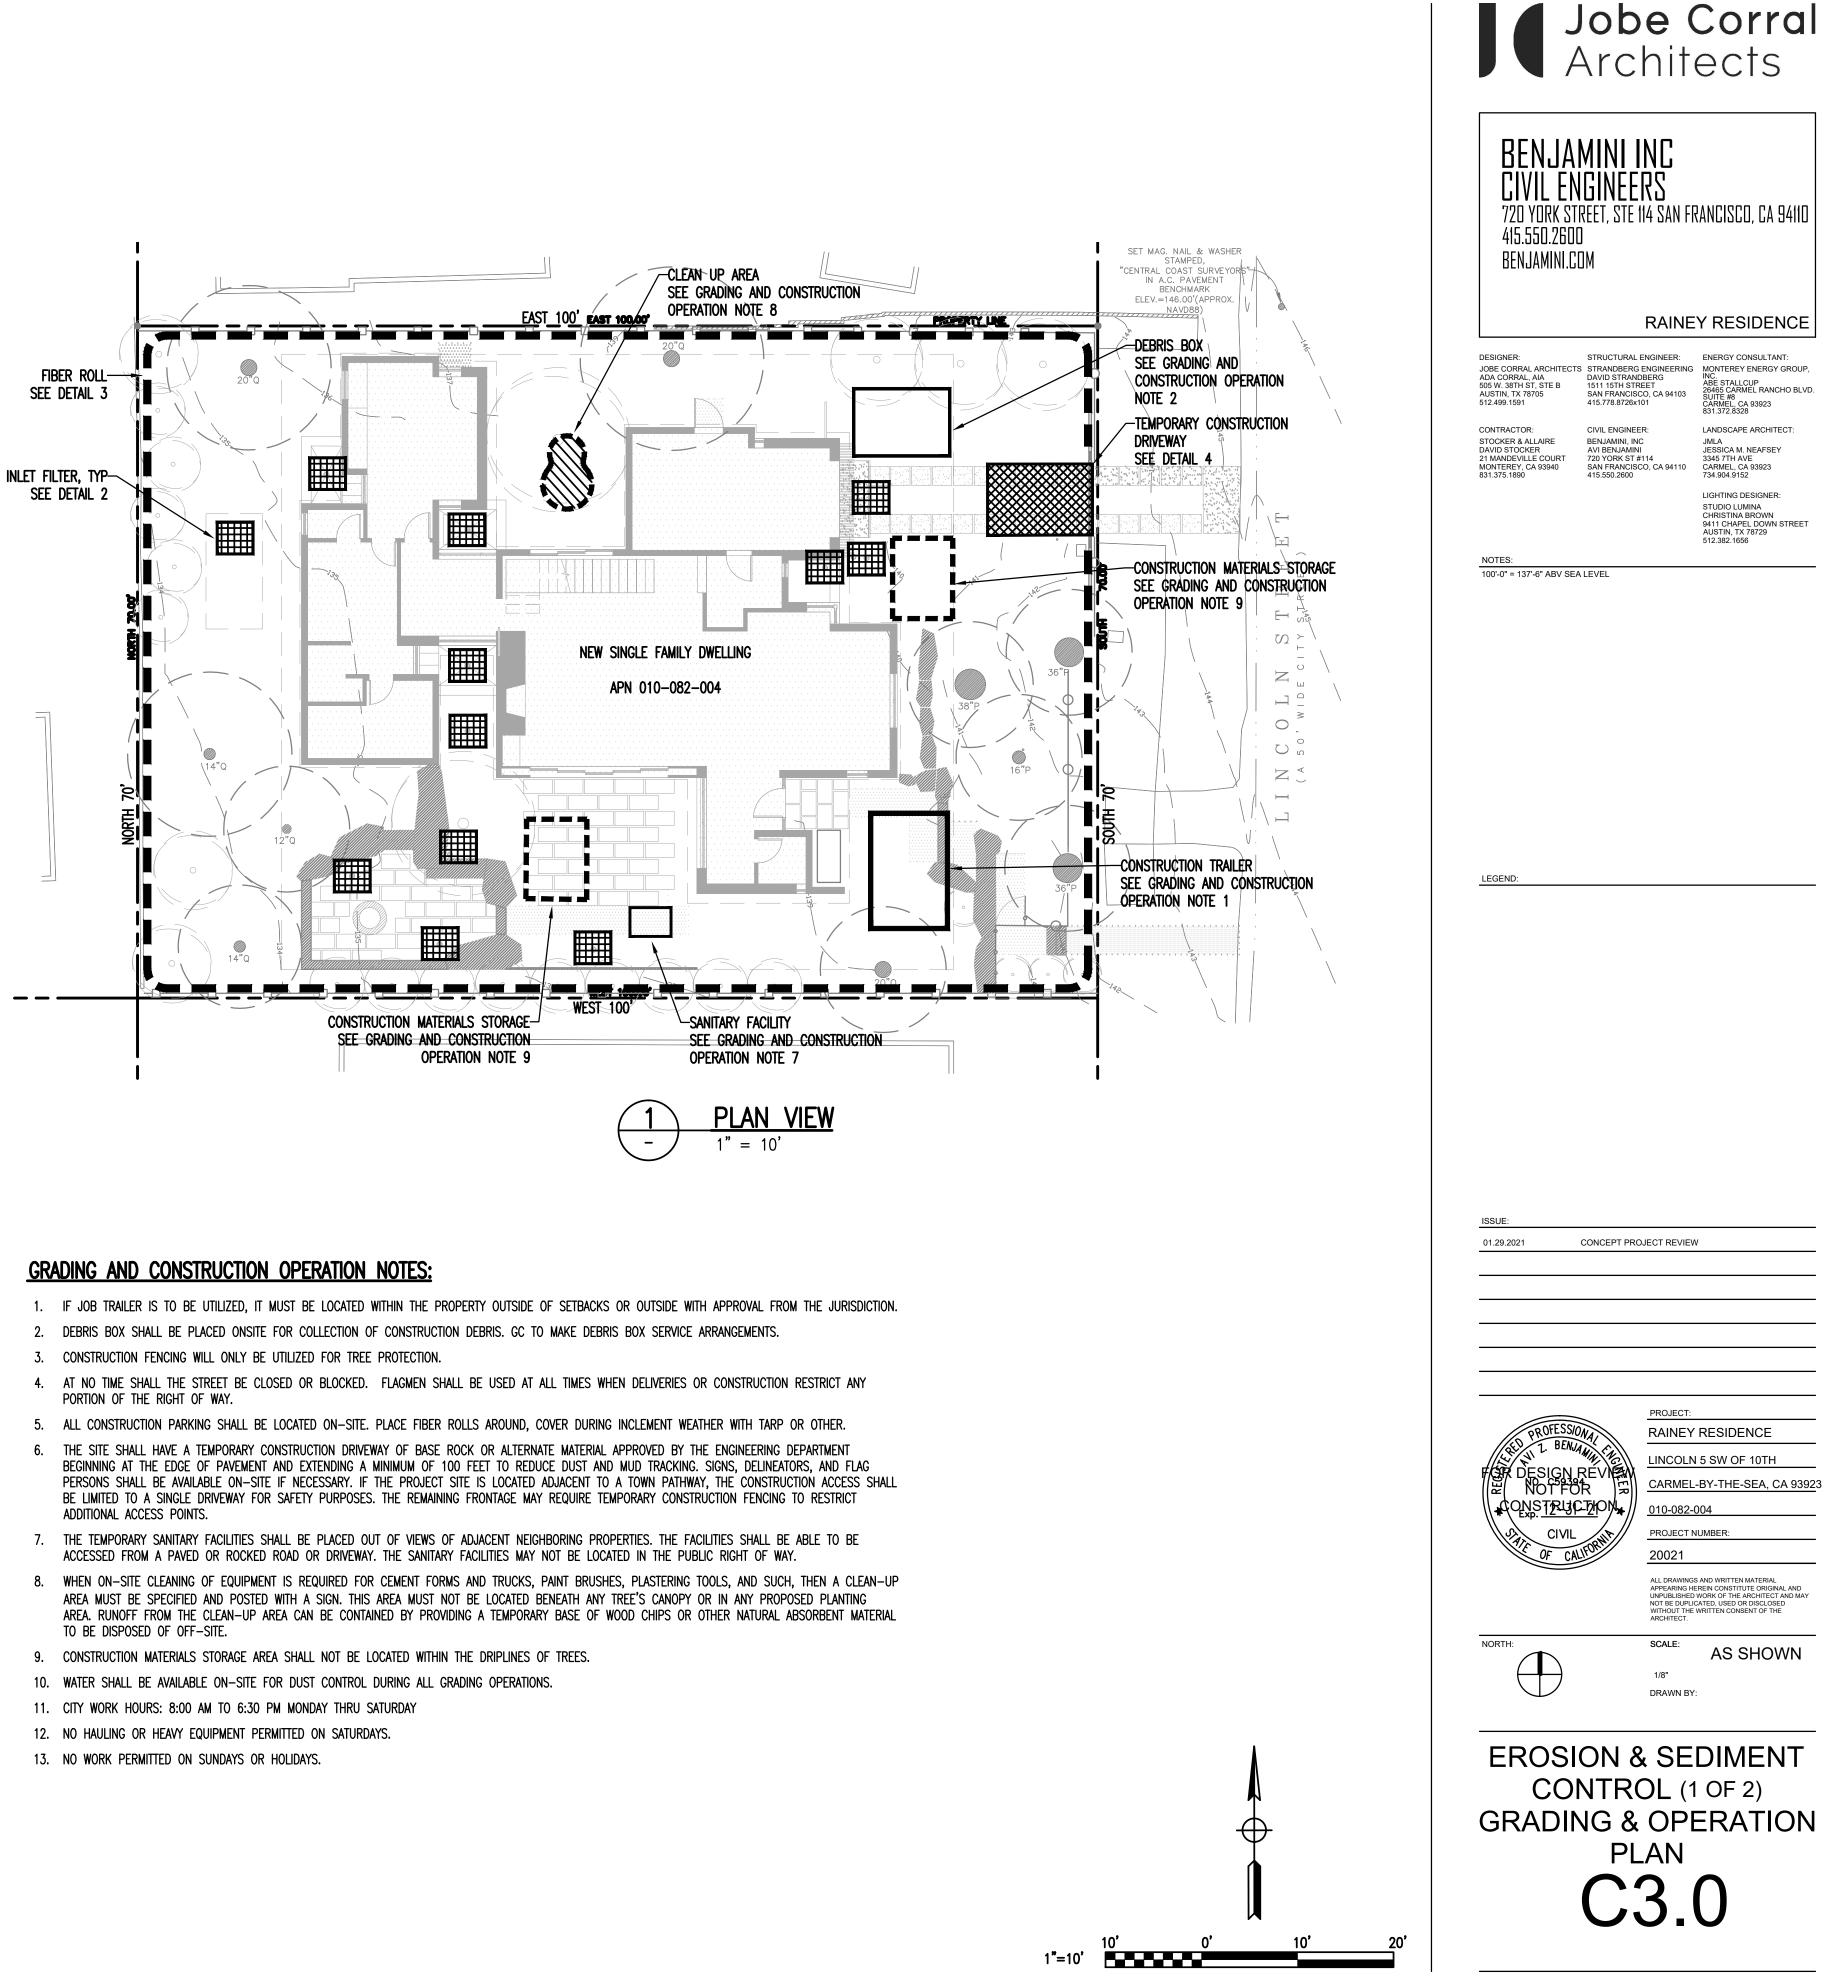

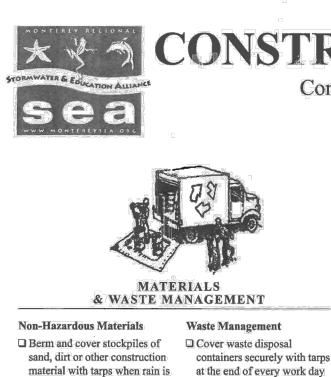

used within 14 days. Use (but don't overuse) reclaimed water for dust control. Hazardous Materials Label all hazardous materials and hazardous wastes (such as pesticides, paints, thinners, solvents, fuel, oil, and antifreeze) in accordance with city, county, state and federal regulations. Store hazardous materials and wastes in water tight containers, store in appropriate secondary containment, and cover them at the end of every work day or during wet weather or when rain is forecast. Follow manufacturer's application instructions for hazardous materials and be careful not to use more than necessary. Do not apply chemicals outdoors when rain is forecast within 24 hours. Arrange for appropriate disposal of all hazardous wastes.

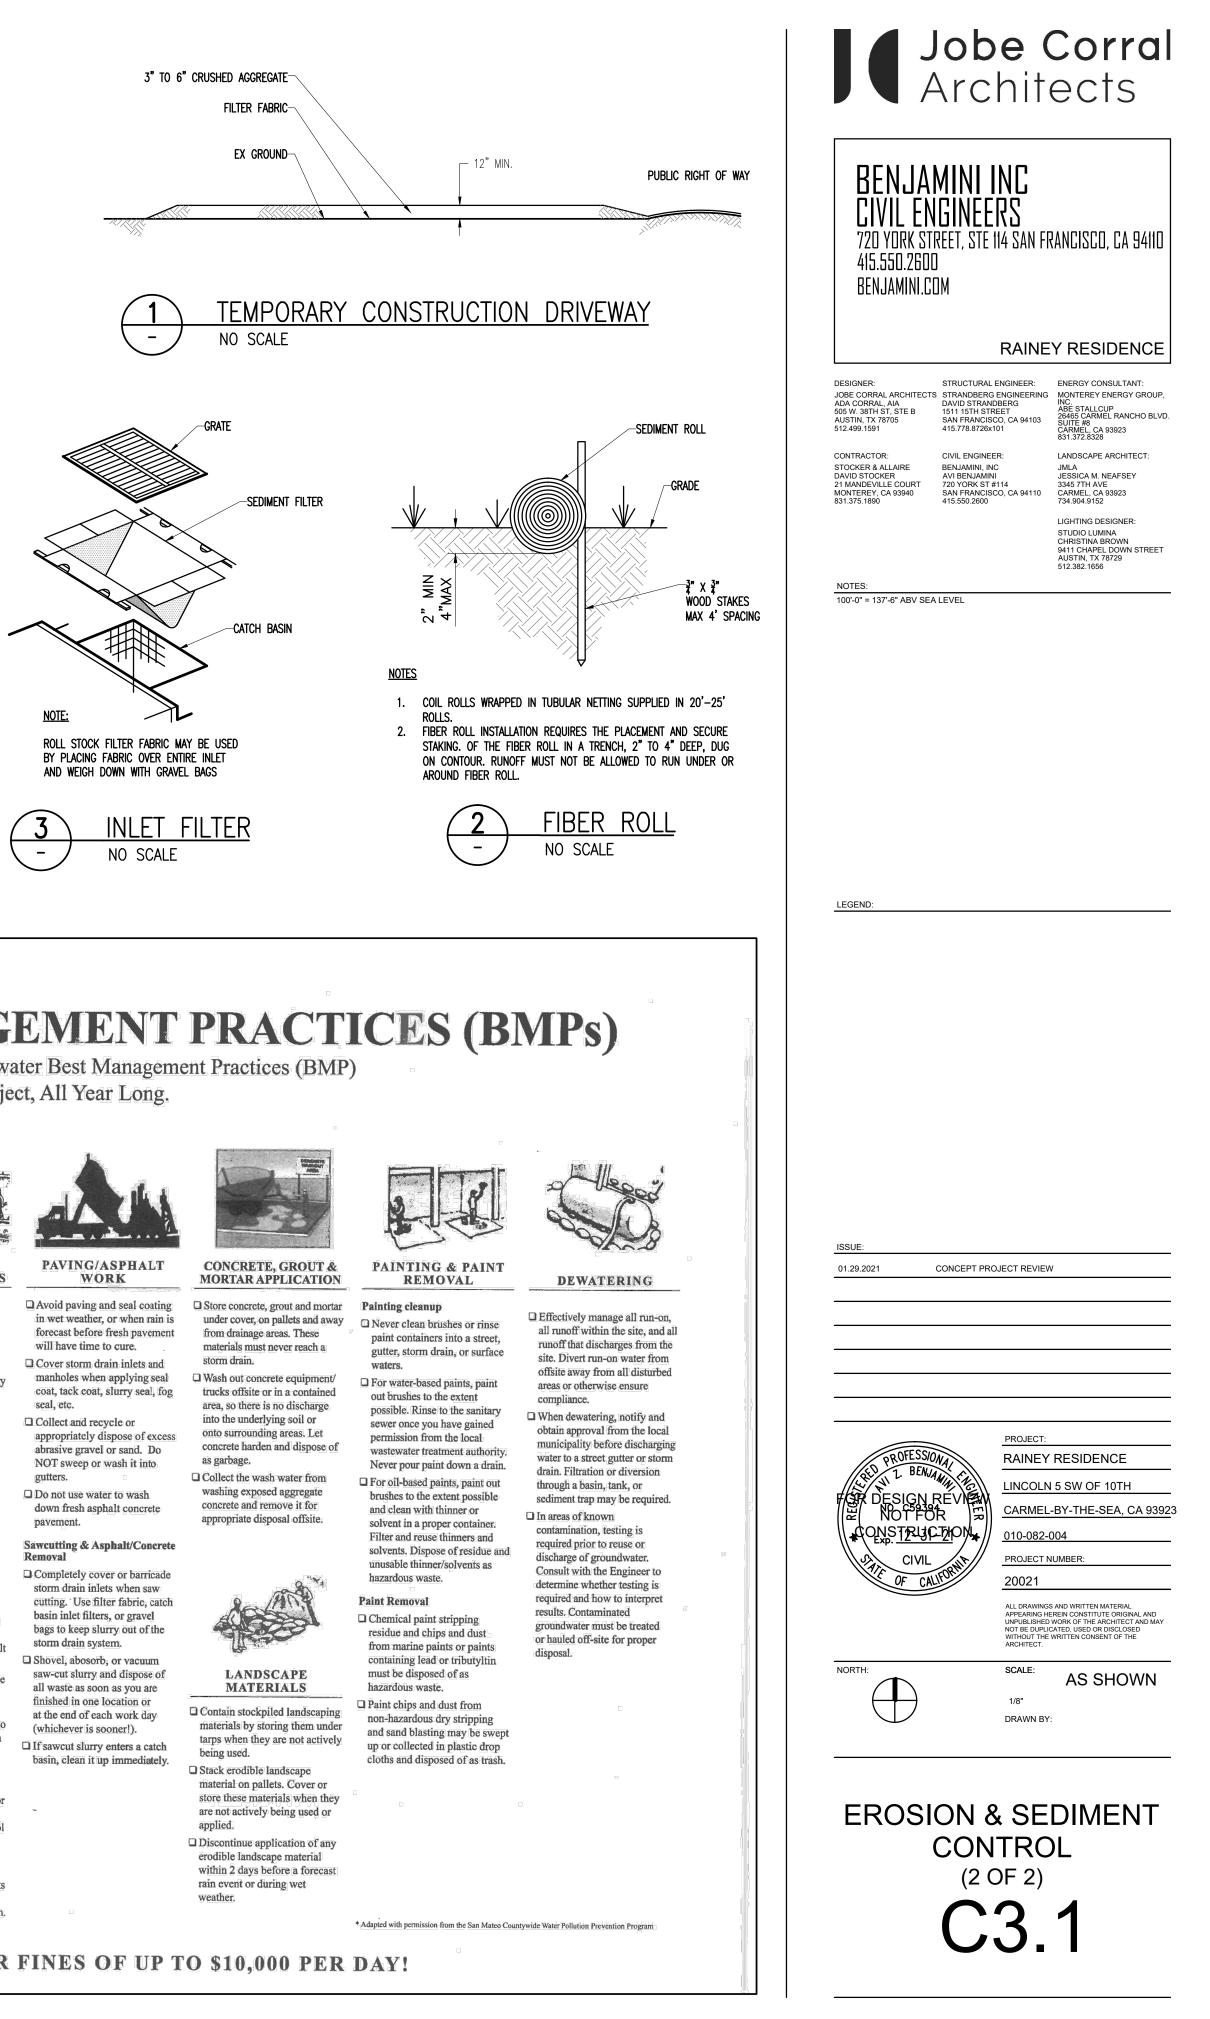

CONSTRUCTION BEST MANAGEMENT PRACTICES (BMPs)

Construction Projects Are Required to Implement the Stormwater Best Management Practices (BMP) on this Page, as they Apply to Your Project, All Year Long.

- Waste Management Cover waste disposal containers securely with tarps forecast or if not actively being and during wet weather.
 - Check waste disposal containers frequently for leaks and to make sure they are not overfilled. Never hose down a dumpster on the construction site.
 - Clean or replace portable toilets, and inspect them frequently for leaks and spills.
 - Dispose of all wastes and debris properly. Recycle materials and wastes that can be recycled (such as asphalt, concrete, aggregate base
 - materials, wood, gyp board, pipe, etc.) Dispose of liquid residues from paints, thinners, solvents, glues, and cleaning fluids as
 - hazardous waste. Construction Entrances and Perimeter

Establish and maintain effective perimeter controls and stabilize all construction

- entrances and exits to sufficiently control erosion and sediment discharges from site and tracking off site. □ Sweep or vacuum any street
- tracking immediately and secure sediment source to prevent further tracking. Never hose down streets to clean up tracking.



- Designate an area, fitted with appropriate BMPs, for vehicle and equipment parking and storage.
- Perform major maintenance, repair jobs, and vehicle and equipment washing off site.
- If refueling or vehicle maintenance must be done onsite, work in a bermed area away from storm drains and over a drip pan big enough to collect fluids. Recycle or dispose of fluids as hazardous waste.
- If vehicle or equipment cleaning must be done onsite, clean with water only in a bermed area that will not allow rinse water to run into gutters, streets, storm drains, or surface waters.
- Do not clean vehicle or equipment onsite using soaps, solvents, degreasers, steam cleaning equipment, etc.

Spill Prevention and Control Keep spill cleanup materials (rags, absorbents, etc.) available at the construction site at all times. □ Inspect vehicles and equipment

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- frequently for and repair leaks promptly. Use drip pans to catch leaks until repairs are made.
- Clean up spills or leaks immediately and dispose of cleanup materials properly. Do not hose down surfaces where fluids have spilled. Use dry cleanup methods
- (absorbent materials, cat litter, and/or rags). □ Sweep up spilled dry materials immediately. Do not try to
- wash them away with water, or bury them. Clean up spills on dirt areas by digging up and properly
- disposing of contaminated soil. Report significant spills immediately. You are required by law to report all significant releases of hazardous materials, including oil. To report a spill: 1) Dial 911 or your local emergency response number, 2) Call the Governor's Office of **Emergency Services Warning** Center, (800) 852-7550 (24

hours).


EARTHWORK & CONTAMINATED SOILS

- Erosion Control Schedule grading and excavation work for dry weather only. □ Stabilize all denuded areas, install and maintain temporary erosion controls (such as erosion control fabric or bonded fiber matrix) until vegetation is established.
- Seed or plant vegetation for erosion control on slopes or where construction is not immediately planned.

Sediment Control

- Protect storm drain inlets, gutters, ditches, and drainage courses with appropriate BMPs, such as gravel bags,
- fiber rolls, berms, etc. Prevent sediment from migrating offsite by installing
- and maintaining sediment controls, such as fiber rolls, silt fences, or sediment basins. Keep excavated soil on the site
- where it will not collect into the street. Transfer excavated materials to
- dump trucks on the site, not in the street. Contaminated Soils
- □ If any of the following conditions are observed, test for contamination and contact the Regional Water Quality Control Board:
- Unusual soil conditions, discoloration, or odor.
- · Abandoned underground tanks Abandoned wells
- · Buried barrels, debris, or trash.



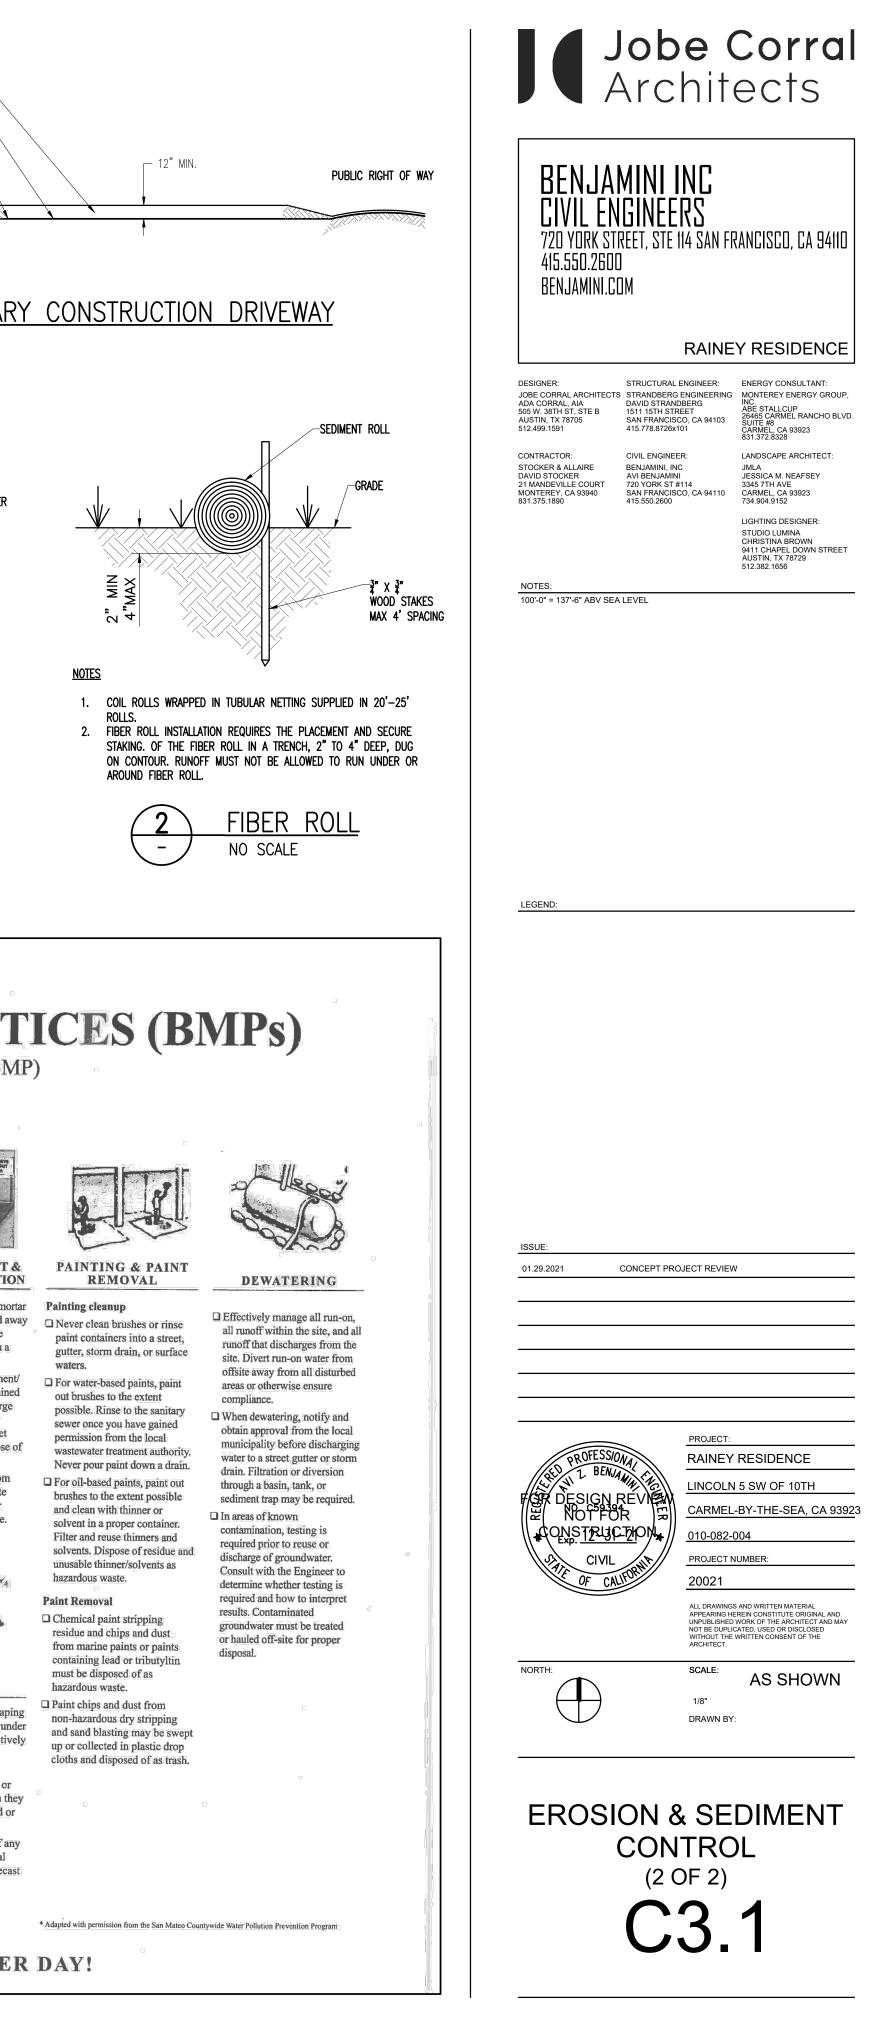



STORM DRAIN POLLUTERS MAY BE LIABLE FOR FINES OF UP TO \$10,000 PER DAY!