

# BLISS LANDSCAPE ARCHITECTURE

26344 Carmel Rancho Lane, Ste. 4U Carmel, CA 93923

www.blisslandscapearchitecture.com



project name

#### The Quan Residence

SW Corner of 6th and Carpenter Carmel, CA 93923

01.02.18

010-033-005

issue set

issue date

previous issue

rev descrip

drawing title

MAIN ENTRY

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OL 1/16"=1'-0"



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SECONDARY ACCESS


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# THE OUAN FAMILY

				car	mel, california	a			
					1	PROJECT DATA		PROJECT TEAM	SHEET INDEX
					OWNER:  SITE:  A.P.N.  ZONING:  FIRE DISTRICT:  OCCUPANCY:  CONSTRUCTION TYPE:  SITE AREA:  BUILDING AREA:  ALLOWED  PROPOSED  GARAGE (FLOOR AREA FIRST FLOOR SECOND FLOOR  SITE COVERAGE:  ALLOWED  22% BASE FLOOR AREA 4% BONUS AREA FOR I	743 SQ. FT. 812 SQ. FT. TOTAL I,800 SQ. FT (45.0% FA		ARCHITECT: JUSTIN PAULY JUSTIN PAULY ARCHITECTS 550 HARTNELL ST. SUITE H MONTEREY CA 93940 P. 831.920.1045 jtp@justinpaulyarchitects.com CA LICENSE #C32962  SURVEY: WHITSON ENGINEERS 9699 BLUE LARKSPUR LANE MONTEREY, CA 93940 P. 831.649.5225 P. 831.373.5065  LANDSCAPE ARCHITECT: MICHAEL BLISS BLISS LANDSCAPE ARCHITECTURE P. 831.251.8551 michael@blisslandarch.com  SOILS ENGINEER SOIL SURVEYS GROUP, INC. MICHELLE GARCIA 103 CHURCH ST. SALINAS, CA 93401 P. 831.757.2172	ID NAME  A0.0 COVER SHEET  A1.1 SURVEY  A1.2 PRELIMINARY SITE ASSESMENT  A1.3 CALCULATIONS  A1.4 VOLUME CALCULATIONS  L1.0 LANDSCAPE PLAN  L1.1 MATERIALS + FINISHES  L3.0 PLANTING PLAN  L4.0 IRRIGATION CONCEPT PLAN  L5.0 LIGHTING PLAN  A2.1 FIRST FLOOR PLAN  A2.2 SECOND FLOOR PLAN  A2.3 ROOF PLAN  A3.1 NORTH & WEST ELEVATIONS  A3.2 SOUTH & WEST ELEVATIONS  A3.3 NORTH & WEST ELEVATIONS (COURTYARD)  A3.4 EXISTING & PROPOSED STREET ELEVATIONS (CARPENTER)  A3.5 EXISTING & PROPOSED STREET ELEVATIONS (6TH AVENUE)  A3.6 DETAILED DRIVEWAY STUDY  A3.7 DETAILED TREE LOCATION  A4.1 BUILDING SECTIONS  A4.2 BUILDING SECTIONS  A5.1 WINDOW & DOOR SCHEDULES
DEFERRED SUBMITTALS  LIOR TO INSTALLATION OF THE FOLLOWING SYSTEMS, THE CONTRACTOR SHALL SUBMIT TO THE CONTRACT CO. BUILDING DEPARTMENT THE REQUIRED DOCUMENTATION FOR REVIEW AND	SPECIAL INSPE	1	SPECIAL INSPECTION		I. TYPICAL CONSTRUCTION REQUISHALL APPLY WHERE APPLICABLE	ERAL CONDITIONS  IREMENTS OF THE 2013 CALIFORNIA STANIAND WHEN NOT SPECIFICALLY NOTED OT	DARDS CODE		
PROVAL. REVIEW BY ARCHITECT SHALL BE PERFORMED PRIOR TO SUBMITTING DOCUMENTS TO  IE CITY OF CARMEL  ALTOMATIC FIRE SPRINKLER SYSTEM COORDINATE DESIGNATION OF SPRINKLER	GRADING AND COMPACTION		INSTECTION.	OBSERVATION		CTOR IS RESPONSIBLE TO ACQUAINT HIMSI SAL. IF THE CONTRACTOR DISCOVERS ANY		VICINITY MAP	/TRUCK HAUL ROUTE
AUTOMATIC FIRE SPRINKLER SYSTEM. COORDINATE DESIGN FOR THE LOCATION OF SPRINKLER HEADS W/ARCHITECT.	SUBDRAINS				DURING HIS SITE FAMILIARIZATION WHICH HE FEELS HAVE NOT BEEN	ON WHICH HE FEELS WILL ADVERSELY AFFEON ADEQUATELY ADDRESSED BY THE CONTINE ARCHITECT IN WRITING. CONTRACTO	CT THE WORK, OR RACTOR	3rd Ave 3rd Ave ≤	3rd Ave 3rd Ave
	SHEAR WALL NAILING AND HARDWARE				,	ING HIM OR HERSELF WITH THE GEOTEC		ssion St	N Carm
	TIE DOWN INSTALLATION FOUNDATIONS				RESPONSIBLE TO NOTIFY THE ARC	THE CONTRACTOR AND ALL SUBCONTRACHITECT IN WRITING OF ANY UNSAFE OR DR PROPOSED CONSTRUCTION WHICH AR ORK.	UNSATISFACTORY	PROJECT LOCATION	4th Ave  Ath Ave  Ath Ave  Randall Way  Hatton Rd  Grandall Way
	FIELD WELDING				OUT BY RESPECTIVE CONTRACTO	PECIFICALLY SHOWN ON THE DRAWINGS ORS IN ACCORDANCE WITH THE BEST COI S SPECIFICATIONS FOR INSTALLATION FOR	MMON PRACTICE	5th Ave  Best Western Plus Carmel Bay View Inn	Carmel Hills Carpen
	NOTES:  I. REQUIRED TESTING AND/OR SPECIAL IN BE DONE IN ACCORDANCE WITHT THE SPECIAL INSPECTOR AND/OR BY AN ENG	CURRENT CODE BY	Y AN APPROVED SPEC		OR ITEMS.  5. DEMOLITION: COORDINATE ALL WITH OWNER WHICH ITEMS, IF A BECOME THE PROPERTY OF THE	DEMOLITION REQUIREMENTS WITH THE CANY, HE WISHES TO RETAIN FOR HIS USAGE. CONTRACTOR AND ARE TO BE PROPERLY INTROL MEASURES DURING DEMOLITION.	OWNER. VERIFY . ALL OTHER ITEMS	of Dr. Seuss  Ocean Ave  Ocean Ave  Ocean Ave  Ocean Ave	Allen Pl Randal Way  Allen Pl Randal Way  Carmel High Scho Performing Arts T  Ocean Ave  Ocean Ave
	<ol> <li>ENGINEERING OBSERVATION SHALL BE</li> <li>ENGINEERING OBSERVATION SHALL BE</li> </ol>				SUPPRESSION OR EMERGENCY AI	FIRE HYDRANT FOR ANY PURPOSE OTHER D, WITHOUT FIRST OBTAINING WRITTEN A ATER TO THE HYDRANT AND FROM THE MO	APPROVAL FROM THE	Santa Fe Raskin Gallery  TRUCK HAUL  ROUTE	Forest Rd.  Carmel High School
APPLICABLE CODES	4. SUBMIT ALL TESTING AND INSPECTION DEPARTMENT.  NOTE: SEE STRUCTURAL DRAWINGS FOR REQUIREMENT				7. MECHANICAL AND PLUMBING: IT SHALL FUNCTION WELL INDIVIDICATION CONTRACTOR IS RESPONSIBLE FOR	IS THE ESSENCE OF THE CONTRACTOR THUALLY AND IN COMBINATION WITH OTHE OR THE PLUMBING LAYOUT FOR ALL FIXTU	ER SYSTEMS THE	ROUTE  7th Ave  Santa Fe St	7th Ave Shafter Way Cabrill
HIS PROJECT SHALL COMPLY WITH ALL CURRENT CODES AS FOLLOWS:  13 CALIFORNIA BUILDING CODE 13 CALIFORNIA PLUMBING CODE	NOTE: FINAL INSPECTION AND APPROVAL FROM I PRIOR TO COUNTY APPROVAL.	MONTEREY PENINSULA	A WATER MANAGEMENT	-DISTRICT REQ'D	EQUIPPED WITH A SHUT OFF NO	ON WITH ANY CONSTRUCTION ACTIVITIES ZZLE. WHEN AN AUTOMATIC SHUT OFF N TAINED FOR THE SIZE OR TYPE OF HOSE IN OFF NOZZLE.	IOZZLE CAN BE	SC	OPE OF WORK
013 CALIFORNIA MECHANICAL CODE 013 CALIFORNIA ENERGY CODE 013 CALIFORNIA ELECTRICAL CODE									

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COVER SHEET



## Part One: Initial Screening:

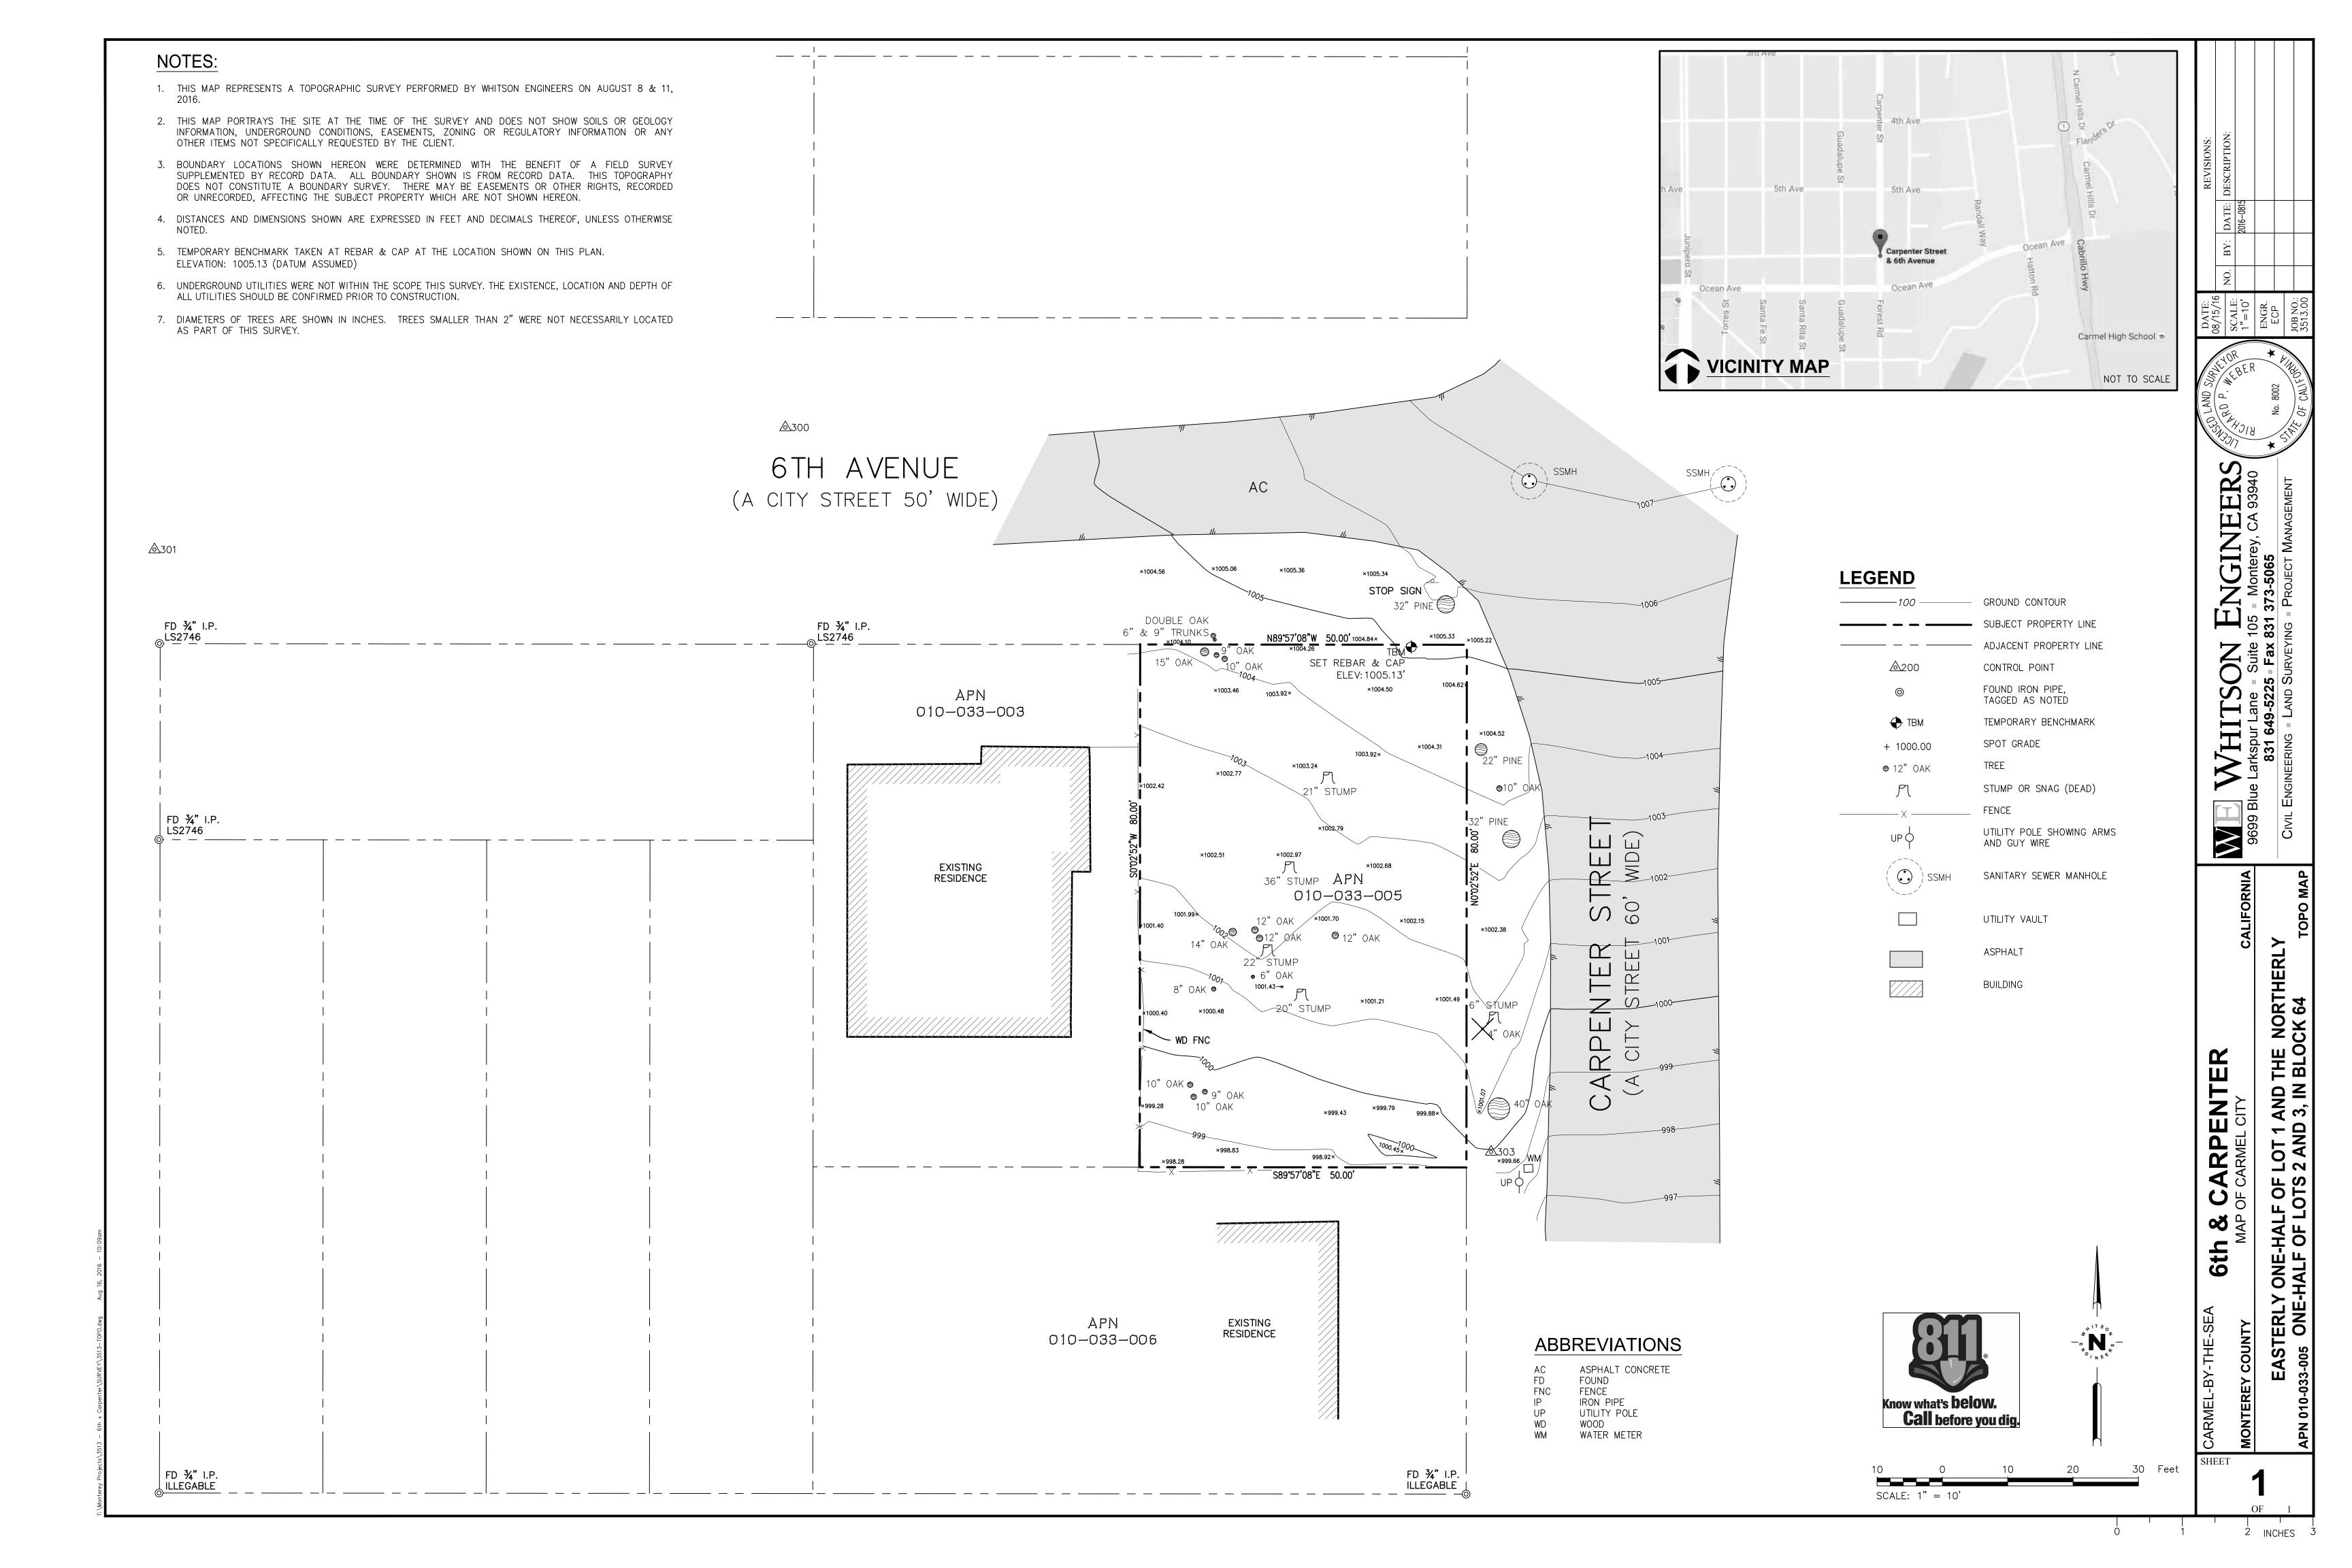Complete Part One to determine if further assessment is warranted. Trees must pass all criteria in Part One to be considered significant or moderately significant.

#### A. Does the tree pose an above-normal potential risk to life and property?

Tree #	1	2	3	4	5	6	7	8	9
YES									
NO	X	X	X	X	X	X	X	X	X

Any tree with structural impairment likely to cause failure should be marked as unsafe and removed. Use page four of this worksheet to document the safety risk. Trees that have limited and specific defects that can be remedied with selective pruning or other mitigation should be marked as safe and specific recommendations should be given to the owner for tree care. Such trees may still be assessed for significance.

#### B. <u>Is the tree one of the following native species on the Carmel-by-the-Sea recommended tree list?</u>

Tree #	1	2	3	4	5	6	7	8	9
Species	CO								
YES	X	X	X	X	X	X	X	X	X
NO									

MP – Monterey pine MC – Monterey cypress BP – Bishop pine CR – Coast redwood CO – Coast live oak CI – Catalina Ironwood CS – California sycamore BL – Big leaf maple

OT – Other (Note: Other species on the recommended tree list may be determined to be Significant Trees only if they are exceptional examples of the species. Such trees also must exhibit excellent health, form, vigor, and substantial size to rate an overall score of at least 7 points in Part Two of the assessment.)

#### C. Does the tree meet the minimum size criteria for significance? Tree # 1 2 3 4 5 6 7 8 9 YES X X X X X X X X X X

Coast live oak – cluster or multi-trunk tree measured as an

average diameter of all the trunks that reach breast height

1	<b>VO</b>											
											Diameter	Н
	Monte	rey pir	ne, Mo	nterey	cypre	ss, Bis	hop pi	ine, Co	ast re	dwood	4 inches @ dbl	n 15
	Coast	live oa	ık – sir	ngle tru	ınk tre	e					6 inches @ dbl	ı l

California sycamore, Big leaf maple, Catalina ironwood 10 inches @ dbh 25 Feet dbh = diameter at breast height or 4.5 feet above the adjacent ground surface

#### Quan 083116

Part Two: Assessment For Tree Significance

For each of the criteria below assign points as shown to assess the tree. If any criteria score is zero the assessment may stop as the tree cannot qualify as significant or moderately significant.

6 inches @ dbh

Page 2 of 5

N/A

#### D. What is the health and condition of the tree?

Tree #	1	2	3	4	5	6	7	8	9
score	1	2	2	2	2	1	2	1	2

The tree is heavily infested with pests or has advanced signs of disease that indicates the tree is declining and has very limited life expectancy.

> The tree shows some pests or disease that impair its condition, but which does not immediately threaten the health of the tree. The tree may recover on its own, or with appropriate intervention.

The tree appears healthy and in good condition.

The tree shows excellent health, is free of pests and disease and is in very strong

#### E. What is the overall form and structure of the tree?

Tree#	1	2	3	4	5	6	7	8	9
score	1	2	2	2	2	1	2	2	2

likely deteriorate into a structural hazard.

Prior pruning, disease or growth habit have left the tree deformed or unsound to an extent that it cannot recover or will never be a visual asset to the neighborhood or will

The tree has poor form or structure but (a) can recover with proper maintenance or (b) it provides visual interest in its current form, and does not have structural defects that are likely to develop into a safety hazard.

2 points: The tree has average form and structure for the species but does not exhibit all the qualities of excellent form and structure.

> The tree exhibits excellent form and structure. For all species there will be a good distribution of foliage on multiple branches with no defects. For conifers, the tree will have a single straight leader with balanced branching and with good taper. Oaks will exhibit a well-developed canopy with no suppressed branches. Oaks may be single-trunked or multi-trunked and will have a balanced distribution of foliage on each trunk/branch.

Quan 083116

F. What is the age and vigor of the tree?

Tree #	1	2	3	4	5	6	7	8	9
score	2	2	2	1	1	2	2	2	2

The tree is over-mature or shows signs of poor or declining vigor such as die-back of major limbs or of the crown, small leaves/needles and/or minimal new growth.

Page 3 of 5

Page 4 of 5

The tree is mature but retains normal vigor and is likely to continue as a forest asset for a substantial period into the future.

The tree is young to middle age and shows exceptional vigor.

The tree is young to middle age and shows normal vigor.

#### G. Are environmental conditions favorable to the tree?

Tree #	1	2	3	4	5	6	7	8	9
score	1	1	1	2	1	1	2	2	2

The tree is crowded or has no room for growth to maturity. The tree has poor access to light, air or has poor soil for the species.

The tree has average environmental conditions including room for growth to maturity, access to light, air and soils suitable for the species.

The tree has room for growth to maturity with no crowding from other significant trees or existing buildings nearby. The tree also has excellent access to light, air and excellent soils for root development.

Quan 083116

Part Three: Final Assessment

Please record the total points scored on pages two and three for each tree.

Tree #	1	2	3	4	5	6	7	8	9
Total	5	7	7	7	6	5	8	7	8
Score	1								

#### A. Did all assessment categories in Part Two achieve a minimum score of 1-point?

Tree #	1	2	3	4	5	6	7	8	9
YES	X	X	X	X	X	X	X	X	X
NO									

#### B. Are there any other factors that would disqualify a tree from a determination of significance? (Explain any 'yes' answer)

No \_X\_\_\_ Yes \_\_\_\_


(Explanation) **NOTES:** 

Site assessment was amended on June 7, 2017 due to additional facts related to an arborist report. Trees identified in the original report as #5, 6 and 7 were determined to be one tree. Site assessment has been updated with new tree numbers.

#### Conclusion: Does The Tree Qualify As Significant Or Moderately Significant?

If the tree meets the species, size and safety criteria identified in Part One and scores at least one point under each of the criteria in Part Two, it shall be classified as Significant if it achieves a score of 6 or more points or shall be classified as Moderately Significant if it achieves a score of 4 or 5 points. Tree species not listed in Part One-B that meet other screening criteria in Part One may be classified by the City Forester as Significant if they score at least 7 points, or as Moderately Significant if they score at least 4 points. All other trees are classified as non-significant.

Tree #	1	2	3	4	5	6	7	8	9
SIGNIF		X	X	X	X		X	X	X
MOD SIGNIF	X					X			
NOT SIGNIF									

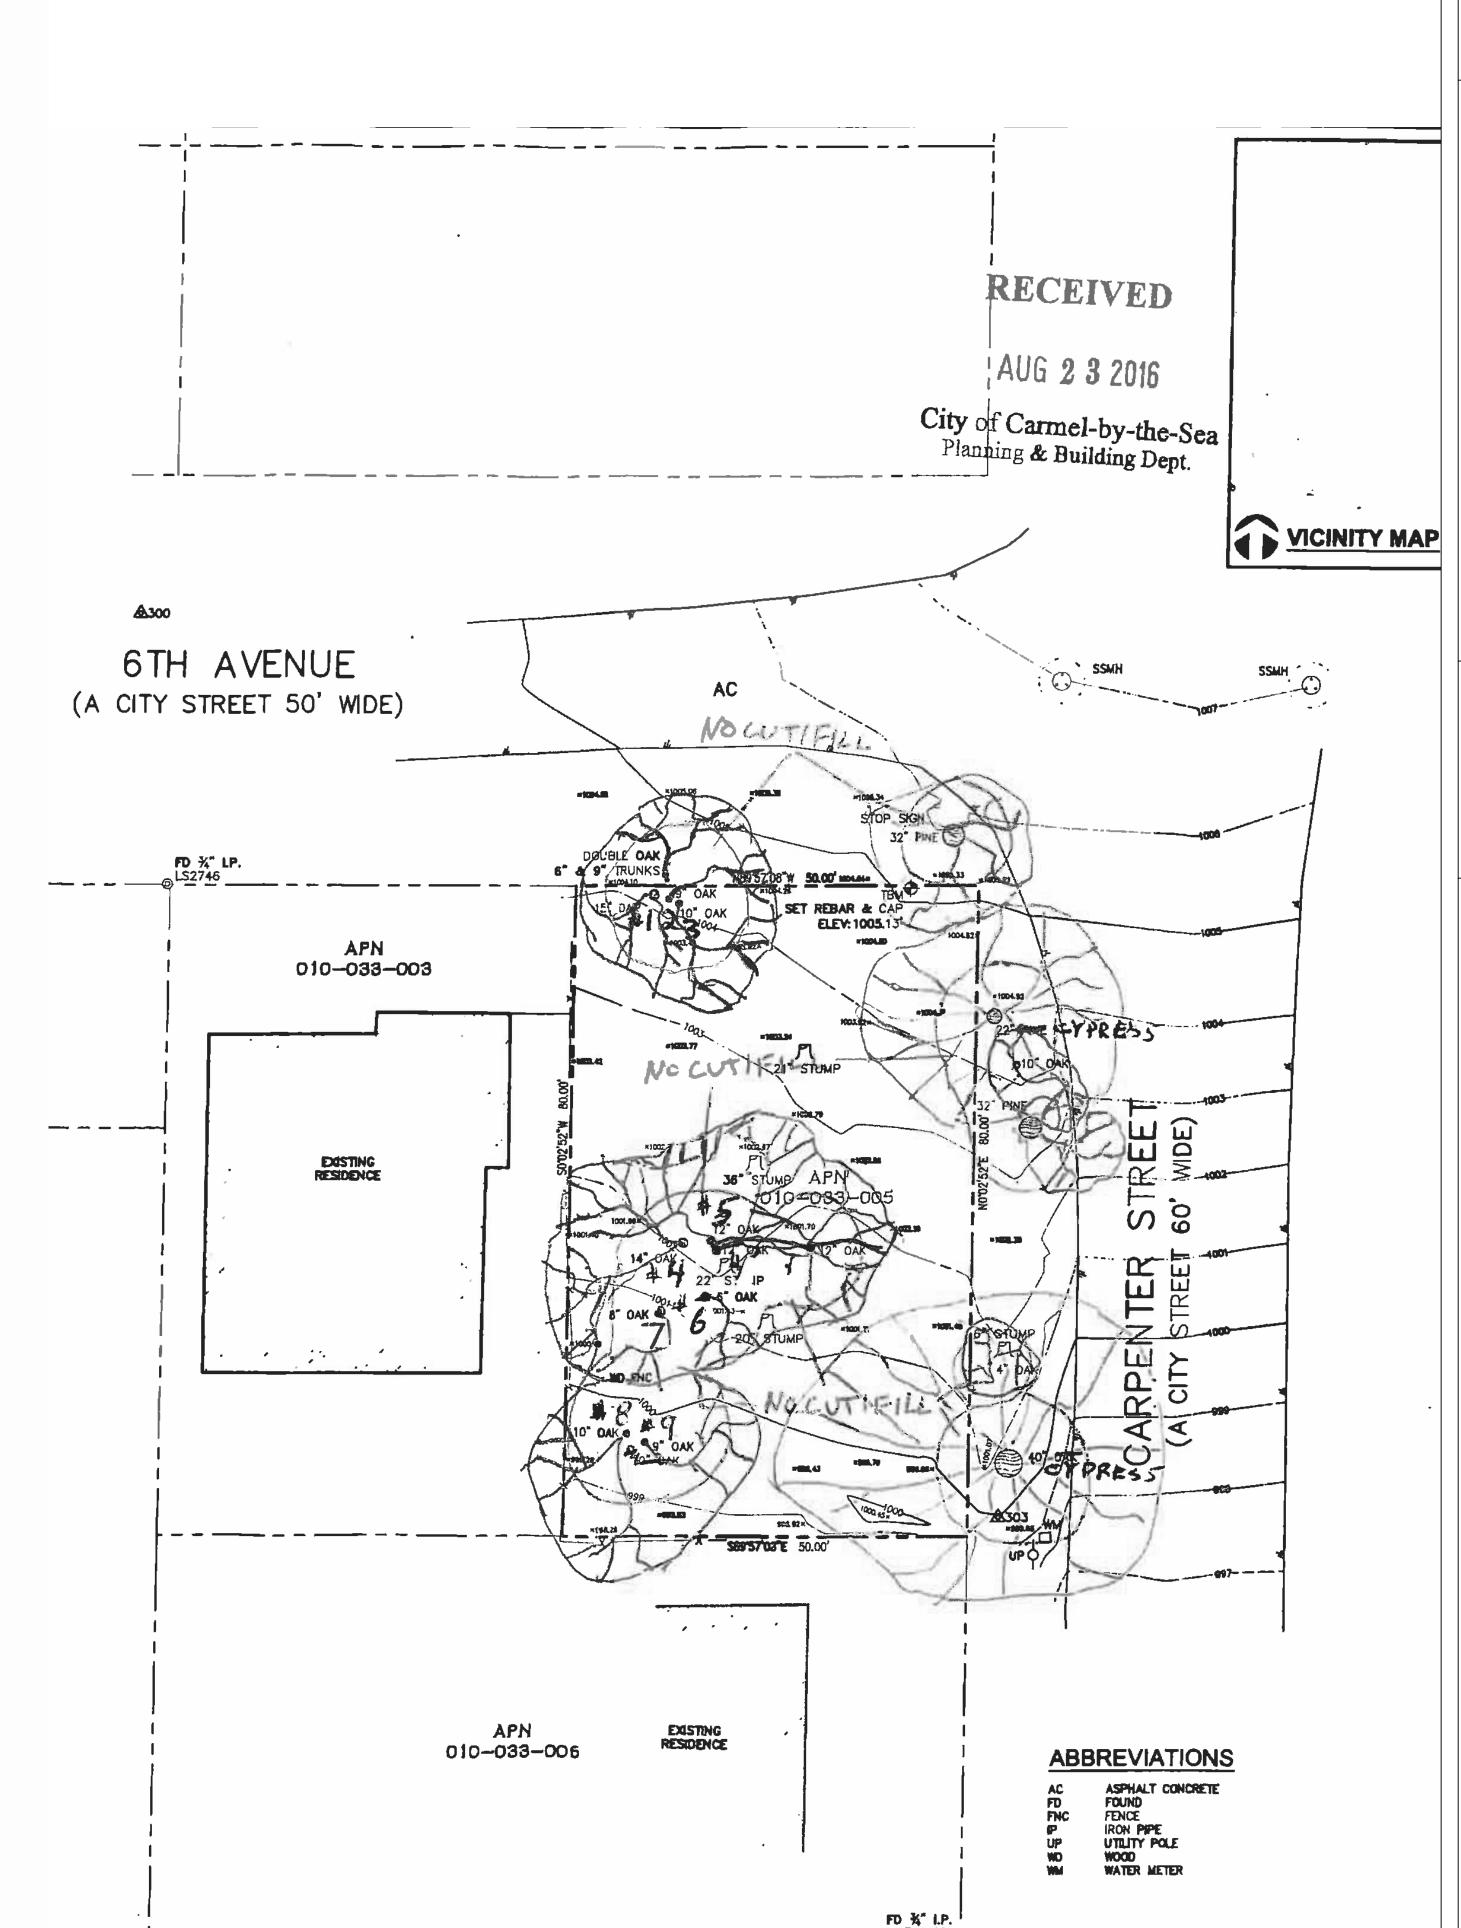

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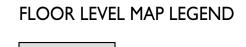
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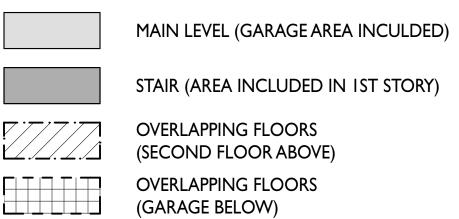
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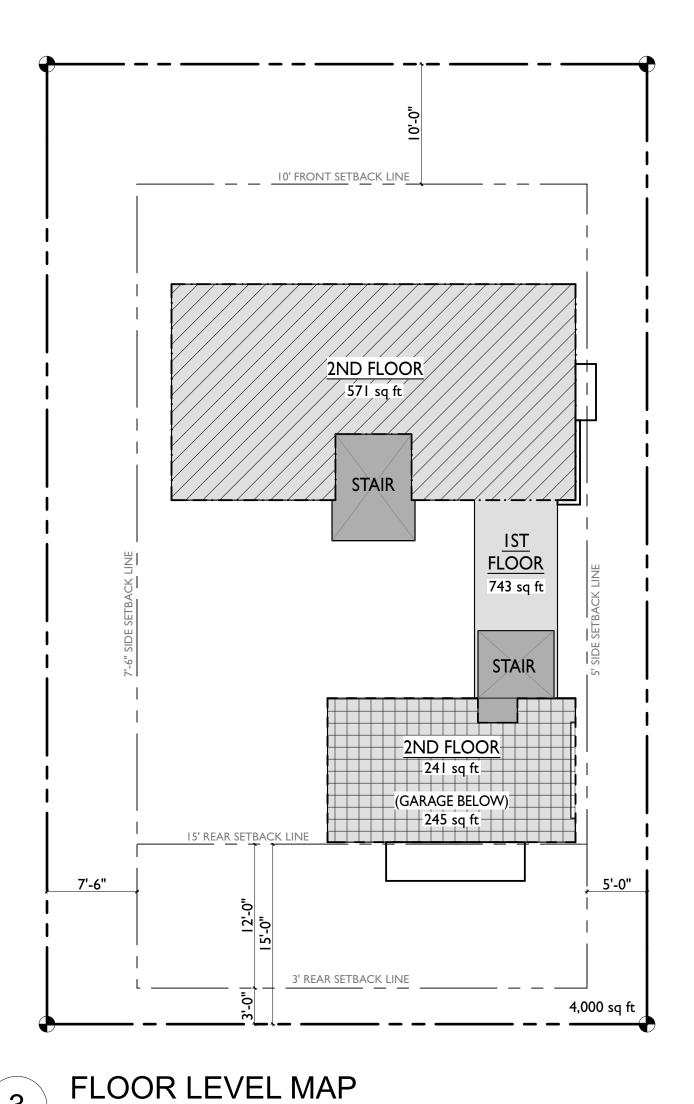
PRELIMINARY SITE ASSESMENT

sheets






CHIMNEY & STORAGE




# FLOOR AREA CALCULATIONS

FLOOR		AREA
MAIN FLOOR		743 SQ.FT.
GARAGE		245 SQ.FT.
2ND STORY ABOVE MAIN FLOOR		571 SQ.FT.
2ND STORY ABOVE GARAGE		241 SQ.FT.
	TOTAL	1.800 SO.FT.

#### SITE COVERAGE LEGEND

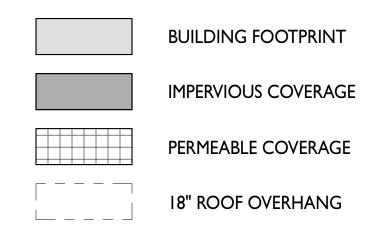

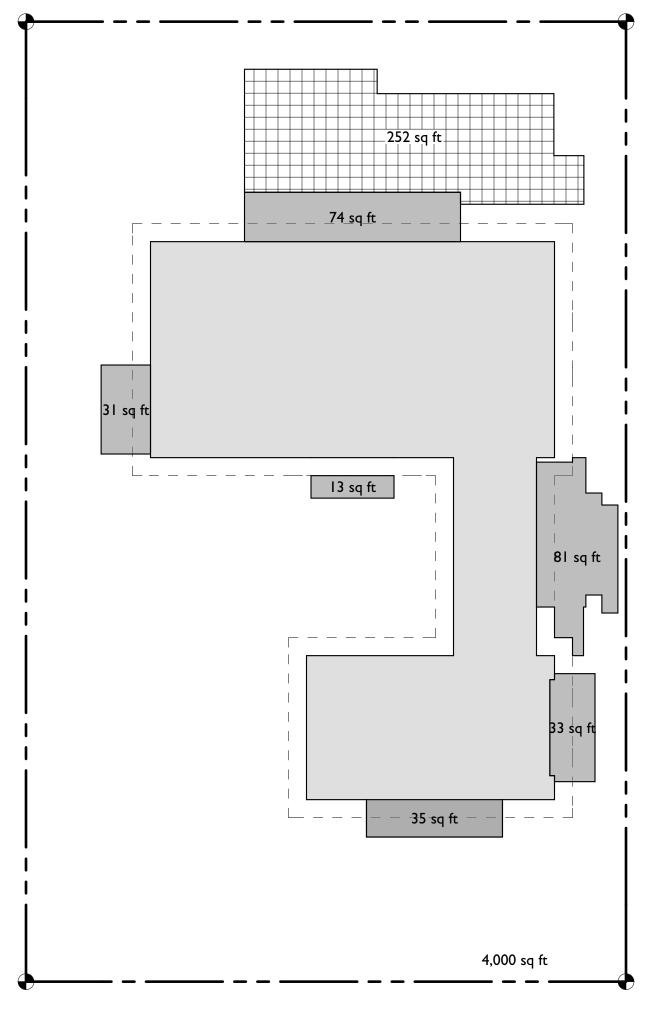


# SITE COVERAGE

#### **COVERAGE SUMMARY**

ALLOWED		AREA
22% BASE FLOOR AREA		396 SQ.FT.
4% BONUS AREA FOR DRIVEWAY		160 SQ.FT.
ТО	TAL ALLOWED	556 SQ.FT.
PROPOSED		AREA

PROPOSED		AREA
SEMI - PERMEABLE		252 SQ.FT.
IMPERVIOUS		267 SQ.FT.
	TOTAL PROPOSED	519 SQ.FT.

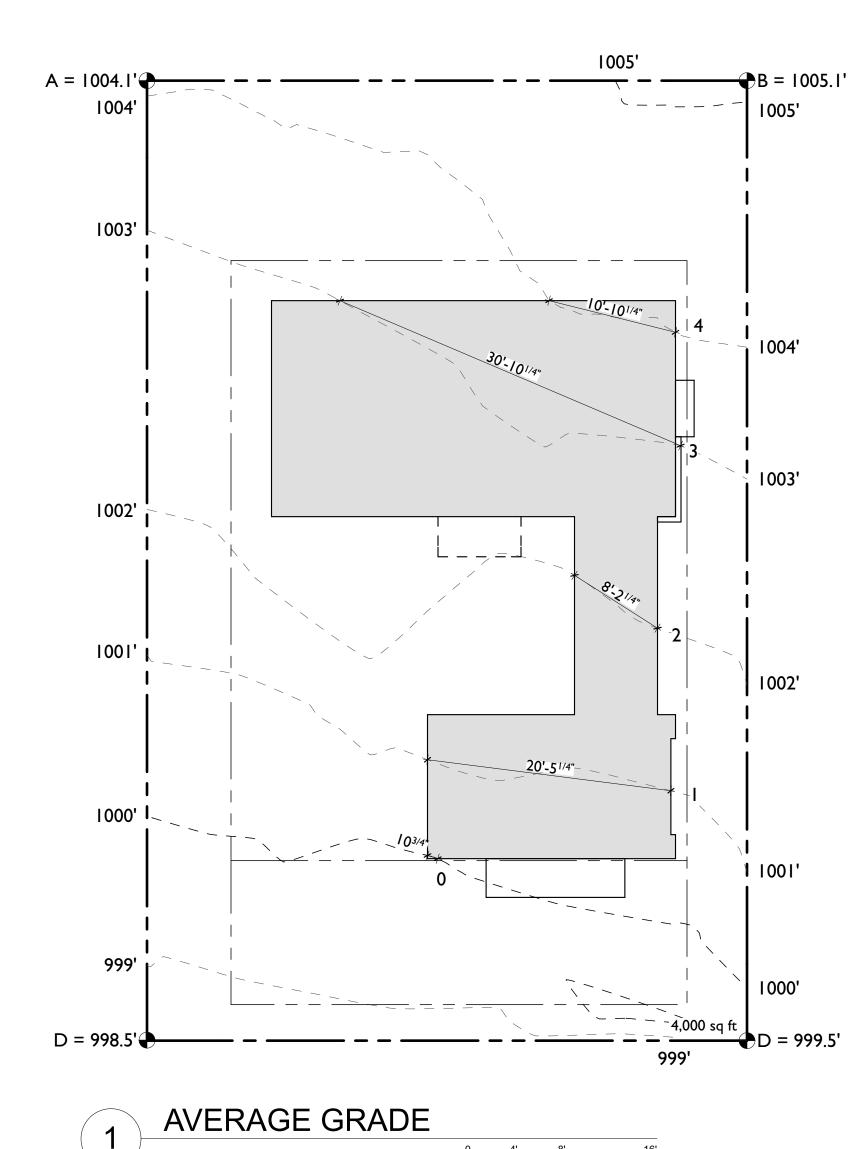

#### **AVERAGE GRADE**

LINE	LENGTH	PRODUCT
0	0.38	0
1	20.4	20
2	8.22	16
3	30.9	93
4	10.9	44
TOTAL	71	173
PRODUCT / LEN	IGTH	2.4
REFERENCE HEI	GHT @ 0	1000,
AVERAGE NATU	RAL GRADE	1002.4'

3/1/18 issued:


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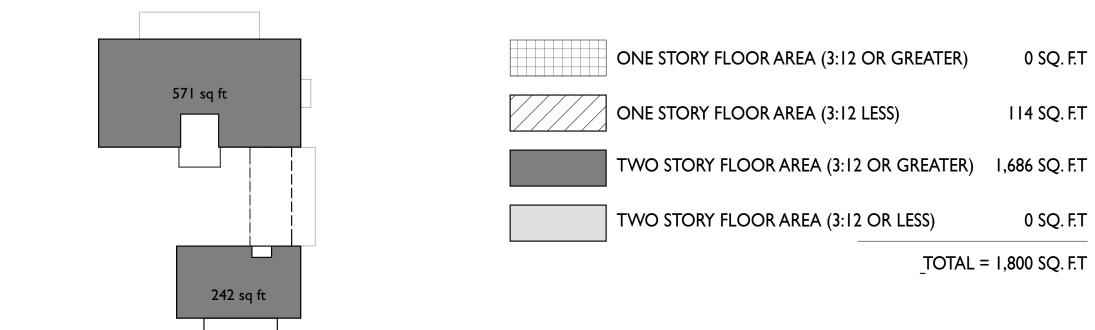
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CALCULATIONS

sheet 4






# ALLOWED VOLUME

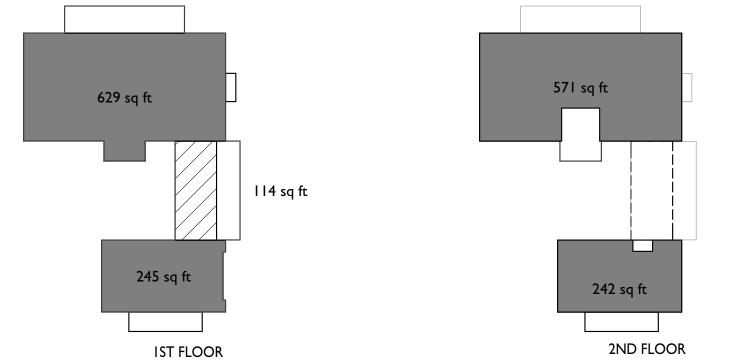
AREATYPE PROPOSED ALLOWED AREA FACTOR VOLUME	
ONE STORY FLOOR AREA (3:12 OR GREATER) 0 SQ.FT. 12 0	CU.FT.
ONE STORY FLOOR AREA (3:12 OR LESS) 114 SQ. FT. 11 1,254	CU.FT.
TWO STORY FLOOR AREA (3:12 OR GREATER) 1,686 SQ. FT. 11 18,546	CU.FT.
TWO STORY FLOOR AREA (3:12 OR LESS) 0 SQ. FT. 10 0	CU.FT.
TOTAL 1,800 SQ.FT. 19,800	CU.FT.

#### PROPOSED VOLUME

ZONE	SECTIONAL AREA	LENGTH (FT.)	VOLUME
Α	363 SQ.FT.	13.38	4,857 CU.FT.
В	411 SQ.FT.	6.917	2,843 CU.FT.
С	30 SQ.FT.	19.98	599 CU.FT.
D	9 SQ.FT.	4.71	42 CU.FT.
E	371 SQ.FT.	13.38	4,964 CU.FT.
F	115 SQ.FT.	16.5	1,898 CU.FT.
G	202 SQ.FT.	20.67	4,175 CU.FT.
<u>H</u>	I0 SQ.FT.	12.23	122 CU.FT.
		TOTAL	19,501 CU.FT.

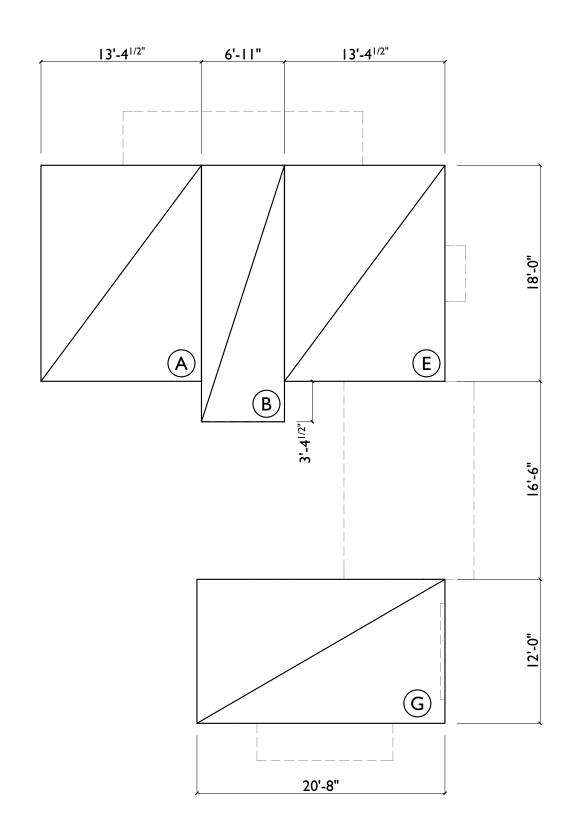



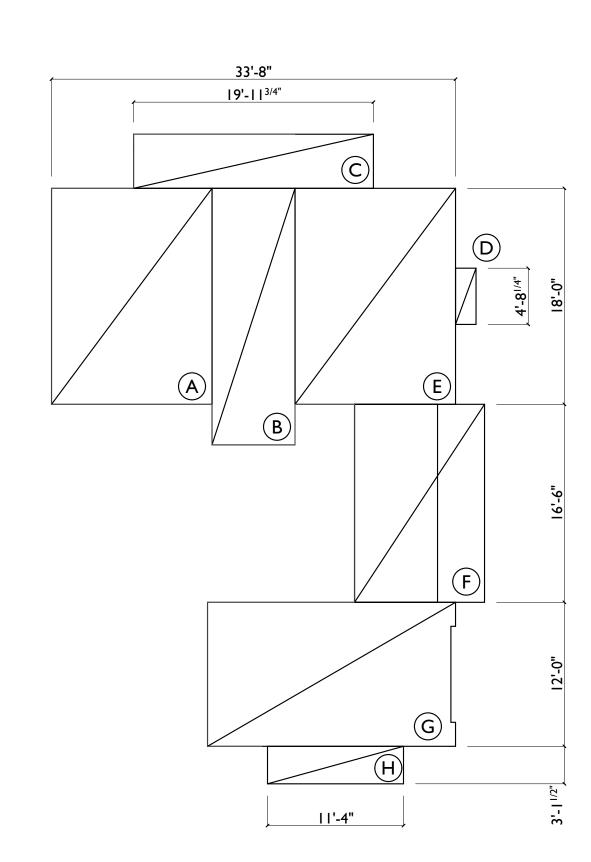

VOLUME CALC. 1ST FLOOR SCALE: 1/8" = 1'-0"

3/1/18 issued: revised:

drawn by:

0 SQ. F.T

114 SQ. F.T

0 SQ. F.T

S

JU

010.033.005

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VOLUME CALCULATIONS

sheet 5



#### **LEGEND**

- 1 Concrete paving
- 2 Gravel paving
- 3 Chip-seal gravel paving
- 4 Concrete steps
- 5 Board form concrete wall (Height varies, see exterior elevations)
- 6 Wood picket fence (Height varies, see exterior elevations)
- 7 Grape stake fence
- 8 Concrete firepit
- 9 Wood bench, Cantilever
- (10) Outdoor cook station
- 11 Steel retainer
- 12 Bark chips
- ← Water Flow

# BLISS LANDSCAPE ARCHITECTURE

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LANDSCAPE PLAN

drawn by: scale:

OL 1/4"=1'-0"

### TREE PROTECTION NOTES

Tree protection shall conform with City tree protection standards. The contractor shall erect protective barricades around all trees on a private building site. These barricades shall be in place prior to the start of any construction or demolition activities. Barricades shall be upright, two-inch by four-inch planks standing a minimum of eight feet vertically, conforming to the tree, tied with wire or rope forming a maximum of one-inch space between the planks. If the tree's configuration or site conditions do not lend themselves to the installation of this type barricade, the City Forester will designate alternate tree protection methods.

## LANDSCAPE MATERIALS + FINISHES

#### NOTES

- 1 ALL ITEMS BELOW CORRESPOND TO NUMBERED ITEMS ON L1.0 SITE PLAN
- 2 PROVIDE MOCK-UP SAMPLES FOR ITEMS REQUESTED, MOCK UPS TO BE REVIEWED BY BLA
- 3 FOR PHOTO REFERENCES, REFER TO THIS SHEET

DESIGNER/CONTRACTOR LEGEND

Bliss Landscape Architecture


Structural Engineer

General Contractor LC Landscape Contractor


CE Civil Engineer

ARCH

LANDSCAPE ITEM  1 PAVING: CONCRETE	SPECIFICATION  Concrete: 4" PIP reinforced concrete paver, integral color TBD, light acid-etch finish, 1/8" radius corners TYP.	DESIGNER RESPONSIBLE BLA	CONTRACTOR RESPONSIBLE GC	NOTES	CD DETAIL # L1.1	MOCK UP REQUIRED YES
2 PAVING: GRAVEL	Gravel: 3/8" clean 'Yuma' gravel over compacted aggregate base per geotech report	BLA	GC+LC	Base prep by GC, Gravel prep by LC Gravel 3/8", rolled in two even courses	L1.1	YES
3 PAVING: CHIP-SEAL GRAVEL PAVING	TBD	BLA	GC		L1.1	YES
4 STEP: CONCRETE	Concrete: reinforced concrete step, integral color TBD, light acid-etch finish, 1/8" radius corners TYP.  Base: compacted aggregate base per geotech report	BLA	GC		L1.1	YES
5 WALL: BOARD FORM CONCRETE	PIP concrete with decorative horizontal board-form finish, integral color TBD, Height varies, see exterior elevations. Finish: use 2" x 6" wide re-sawn wood form boards to imprint texture, no gap between boards; square edges at corners; align & level boards at all horizontals on each face; align boards on all sides of walls, ensure alignment of board coursing of imprinted texture between poirs and accounting for form board shrinkage; use of form ties on visible surfaces shall be prohibited; rub down excessive protrusions between board coursing	BLA	GC	Structural retaining wall detailing by SE, Drainage by Civil Engineer	L1.1 #5	YES
6 FENCE: WOOD, PICKET	Vertical pickets: full dimension 2" x 2" WRC - STK; rough sawn finish (all sides), with semi-transparent stain finish. Height varies, see exterior elevations.	BLA	GC		L1.1 #6	YES
7 FENCE: GRAPE STAKE	Split face, 1" x 2" redwood grape stake fencing with 2" x 4" PTDF top + bottom rail and 4" x 4" PTDF posts.	BLA	GC		L1.1 #7	YES
8 FIRE PIT: CONCRETE	PIP reinforced concrete w/ smooth finish.	BLA	GC		L1.1	YES
9 BENCH: WOOD, CANTILEVER	3" x 4" S4S ipe slats with 3/8" galv. steel spacers and 3/8" galv. steel plate anchored to conc. wall.  Bench to be 24" wide, with top of bench 18" above finish grade.	BLA	GC		L1.1	YES
10 OUTDOOR COOK STATION	See Architecture drawings.	ARCH	GC		-	YES
11 STEEL RETAINER	3/16" Unfinished, cold-rolled steel edge welded to verticle stakes. Steel flush with finish surface, and set 1/4" above finish grade.	BLA	GC		-	YES
12 BARK CHIP	Type TBD	BLA	LC		-	YES

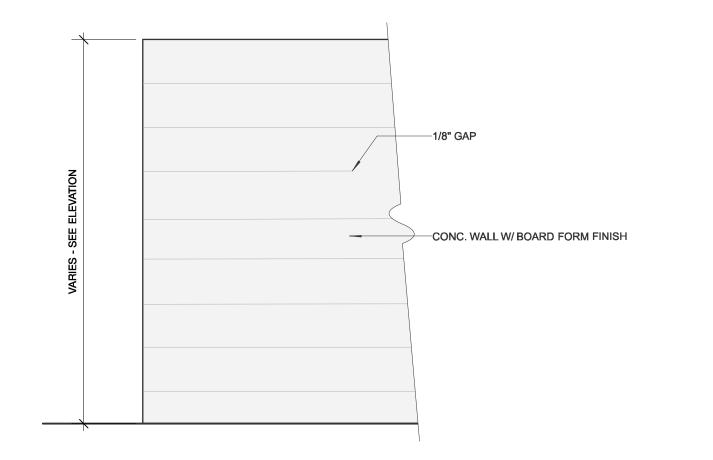

5 ELEVATION DETAIL: BOARD FORM CONCRETE WALL
1" = 1'-0"

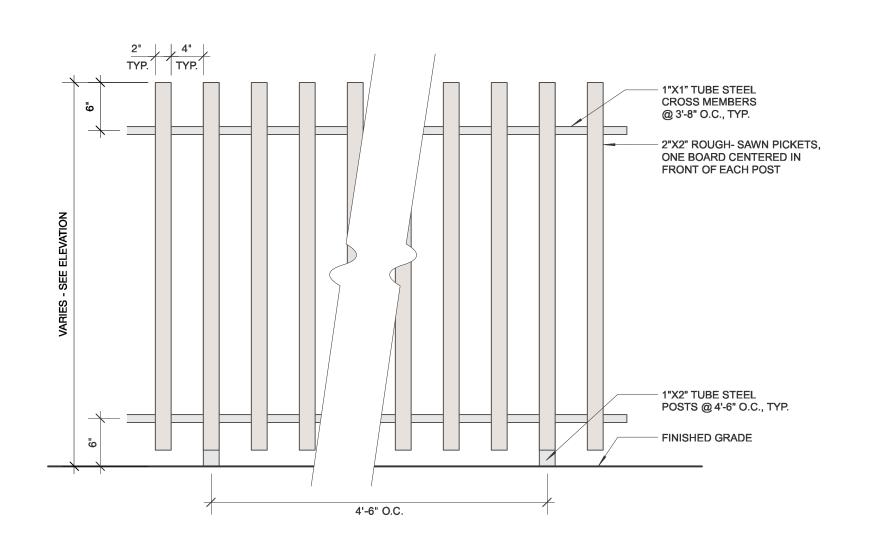

6 ELEVATION DETAIL: VERTICAL WOOD FENCE
1" = 1'-0"

project name

**BLISS** 

Carmel, CA 93923

LANDSCAPE

ARCHITECTURE

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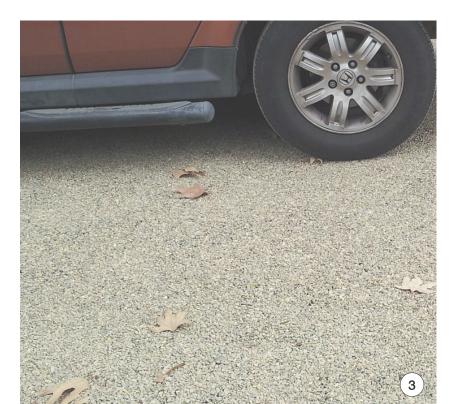
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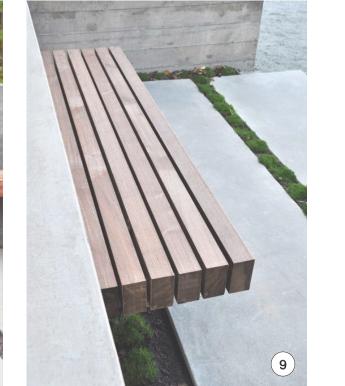













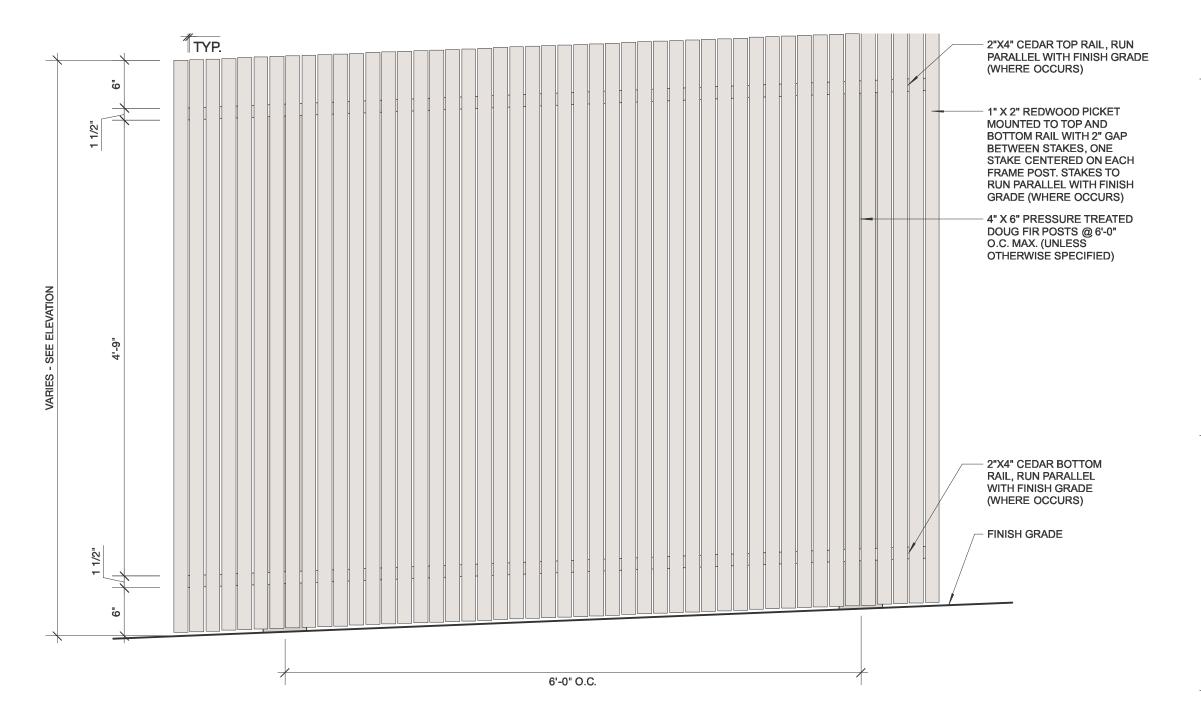

MATERIALS & FINISHES

drawn by:

drawing title

As shown

7 ELEVATION DETAIL: SINGLE-SIDED GRAPE STAKE FENCE



#### PLANT LEGEND

Symbol Quantity Botanical Name Common Name Container Size

TREES 1 Acer palmatum 'Green' Japanese Maple (mult-trunk) 36" box

5 Chondropetalum 'El Campo' Dwarf Cape Rush 5 gal 8 Dianella revoluta 'Cool Vista' 1 gal 16 Euonymous japonicus 'Green Spires' Green Spire Euonymous 15 gal 15 gal 1 Fatsia japonica Japanese Aralia 2 Hydrangea quercifolia 'Snow Queen' Oak-Leaf Hydrangea 15 gal 30 Juncus effusus 'Quartz Creek' 1 gal Quartz Creek Soft Rush 4 Phormium cookianum Mountain Flax 5 gal 18 Pittosporum crassifolium 15 gal 10 Woodwardia fimbriata Giant Chain Fern 5 gal

#### **GROUNDCOVERS**



#### PLANTING NOTES

1. Contractor shall be responsible for making themselves familiar with all underground utilities, pipes, and structures. Contractor shall take responsibility for any cost incurred due to damage of said utilities.

2. Contractor shall not willfully proceed with construction as designed when it is obvious that unknown obstructions and/or grade differences exist in planting areas. Such conditions shall be immediately brought to the attention of the Construction Manager.

3. Contractor shall be responsible for any coordination with subcontractors as required to accomplish planting operations

4. Contractor shall submit a random soil samples from the site to a qualified soil testing lab for a horticultural suitability test and amendment recommendations. After amending topsoil to a depth of 8" (and in accordance with soil test recommendations), grade all areas smooth with no localized depressions or humps exceeding 1". Insufficient or unsuitable existing soil shall be augmented or replaced with topsoil as approved by the Landscape Architect.

5. All plant material shall be approved by Landscape Architect prior to installation.

6. Contractor to complete all soil amending, finish grading and removal of any and all construction debris from the planting areas before the laying out of approved plant material.

7. Contractor shall layout all plants in their containers as per this Plan and receive approval from Landscape Architect prior to

8. Contractor shall notify Construction Manager + Landscape Architect 48 hours prior to commencement of work to coordinate project inspection schedules.

9. Any plant substitutions must be approved by the Landscape Architect for approval or alternate choices.

10. All plants shall be healthy, pest and disease free, free of girdling roots and well established in the container.

11. Trees shall be located a minimum of 4 ft. from walls, overheads, walks, headers and other trees within the project, unless shown otherwise.

12. No plant shall be planted with rootballs or planting pits in a dry condition.

13. Water all plants by handheld hose with watering wand attachment immediately after planting (no water 'jetting'). No plant should be out of it's container more than twenty minutes before being planted and watered. Contractor shall be responsible for irrigating all new plantings until the entire project has been completed and accepted by the Owner.

14. Contractor is responsible to apply sufficient but not excess irrigation to all new plantings to ensure healthy plant establishment.

15. Backfill mix shall consist of 1/3 imported organic compost and 2/3 amended site soil.

16. Immediately after excavation of plant pits, test drainage of pits by filling with water. Give written notification of conditions permitting the retention of water in pits for more that (3) hours. Contractor shall submit to Owner and Landscape Architect for acceptance a written proposal and cost estimate for the correction of poor drainage conditions before proceeding with planting.

17. All newly planted container plants and trees shall receive watering basins 3 times the size of the root ball upon planting, unless otherwise shown on Drawings.

18. Planting areas shall receive a 2" layer of composted oak leaf mulch, unless noted otherwise.

19. Mulch shall be kept at a depth of 2" deep near the plant crowns and trunks, and not extend higher than 1/8" onto the crown or trunk of any newly planted plant or tree.

20. All plant material shown on the Planting Plan is subject to the adverse effects of Nature including, but not limited to, fire, earthquake, flooding, freeze, drought, erosion and foraging predators. The Landscape Architect cannot, and does not, guarantee or imply warranty that specified plants will survive these Acts of Nature. All plants specified satisfy the general climatic conditions set forth by the U.S. Department of Agriculture and the Sunset Western Garden Book.

# **BLISS** LANDSCAPE **ARCHITECTURE**

26344 Carmel Rancho Lane, Ste. 4U Carmel, CA 93923

www.blisslandscapearchitecture.com



project name

The Quan Residence

SW Corner of 6th and Carpenter Carmel, CA 93923

010-033-005

issue set

01.02.18 issue date


previous issue

rev description

drawing title PLANTING PLAN

drawn by:

1/4"=1'-0"

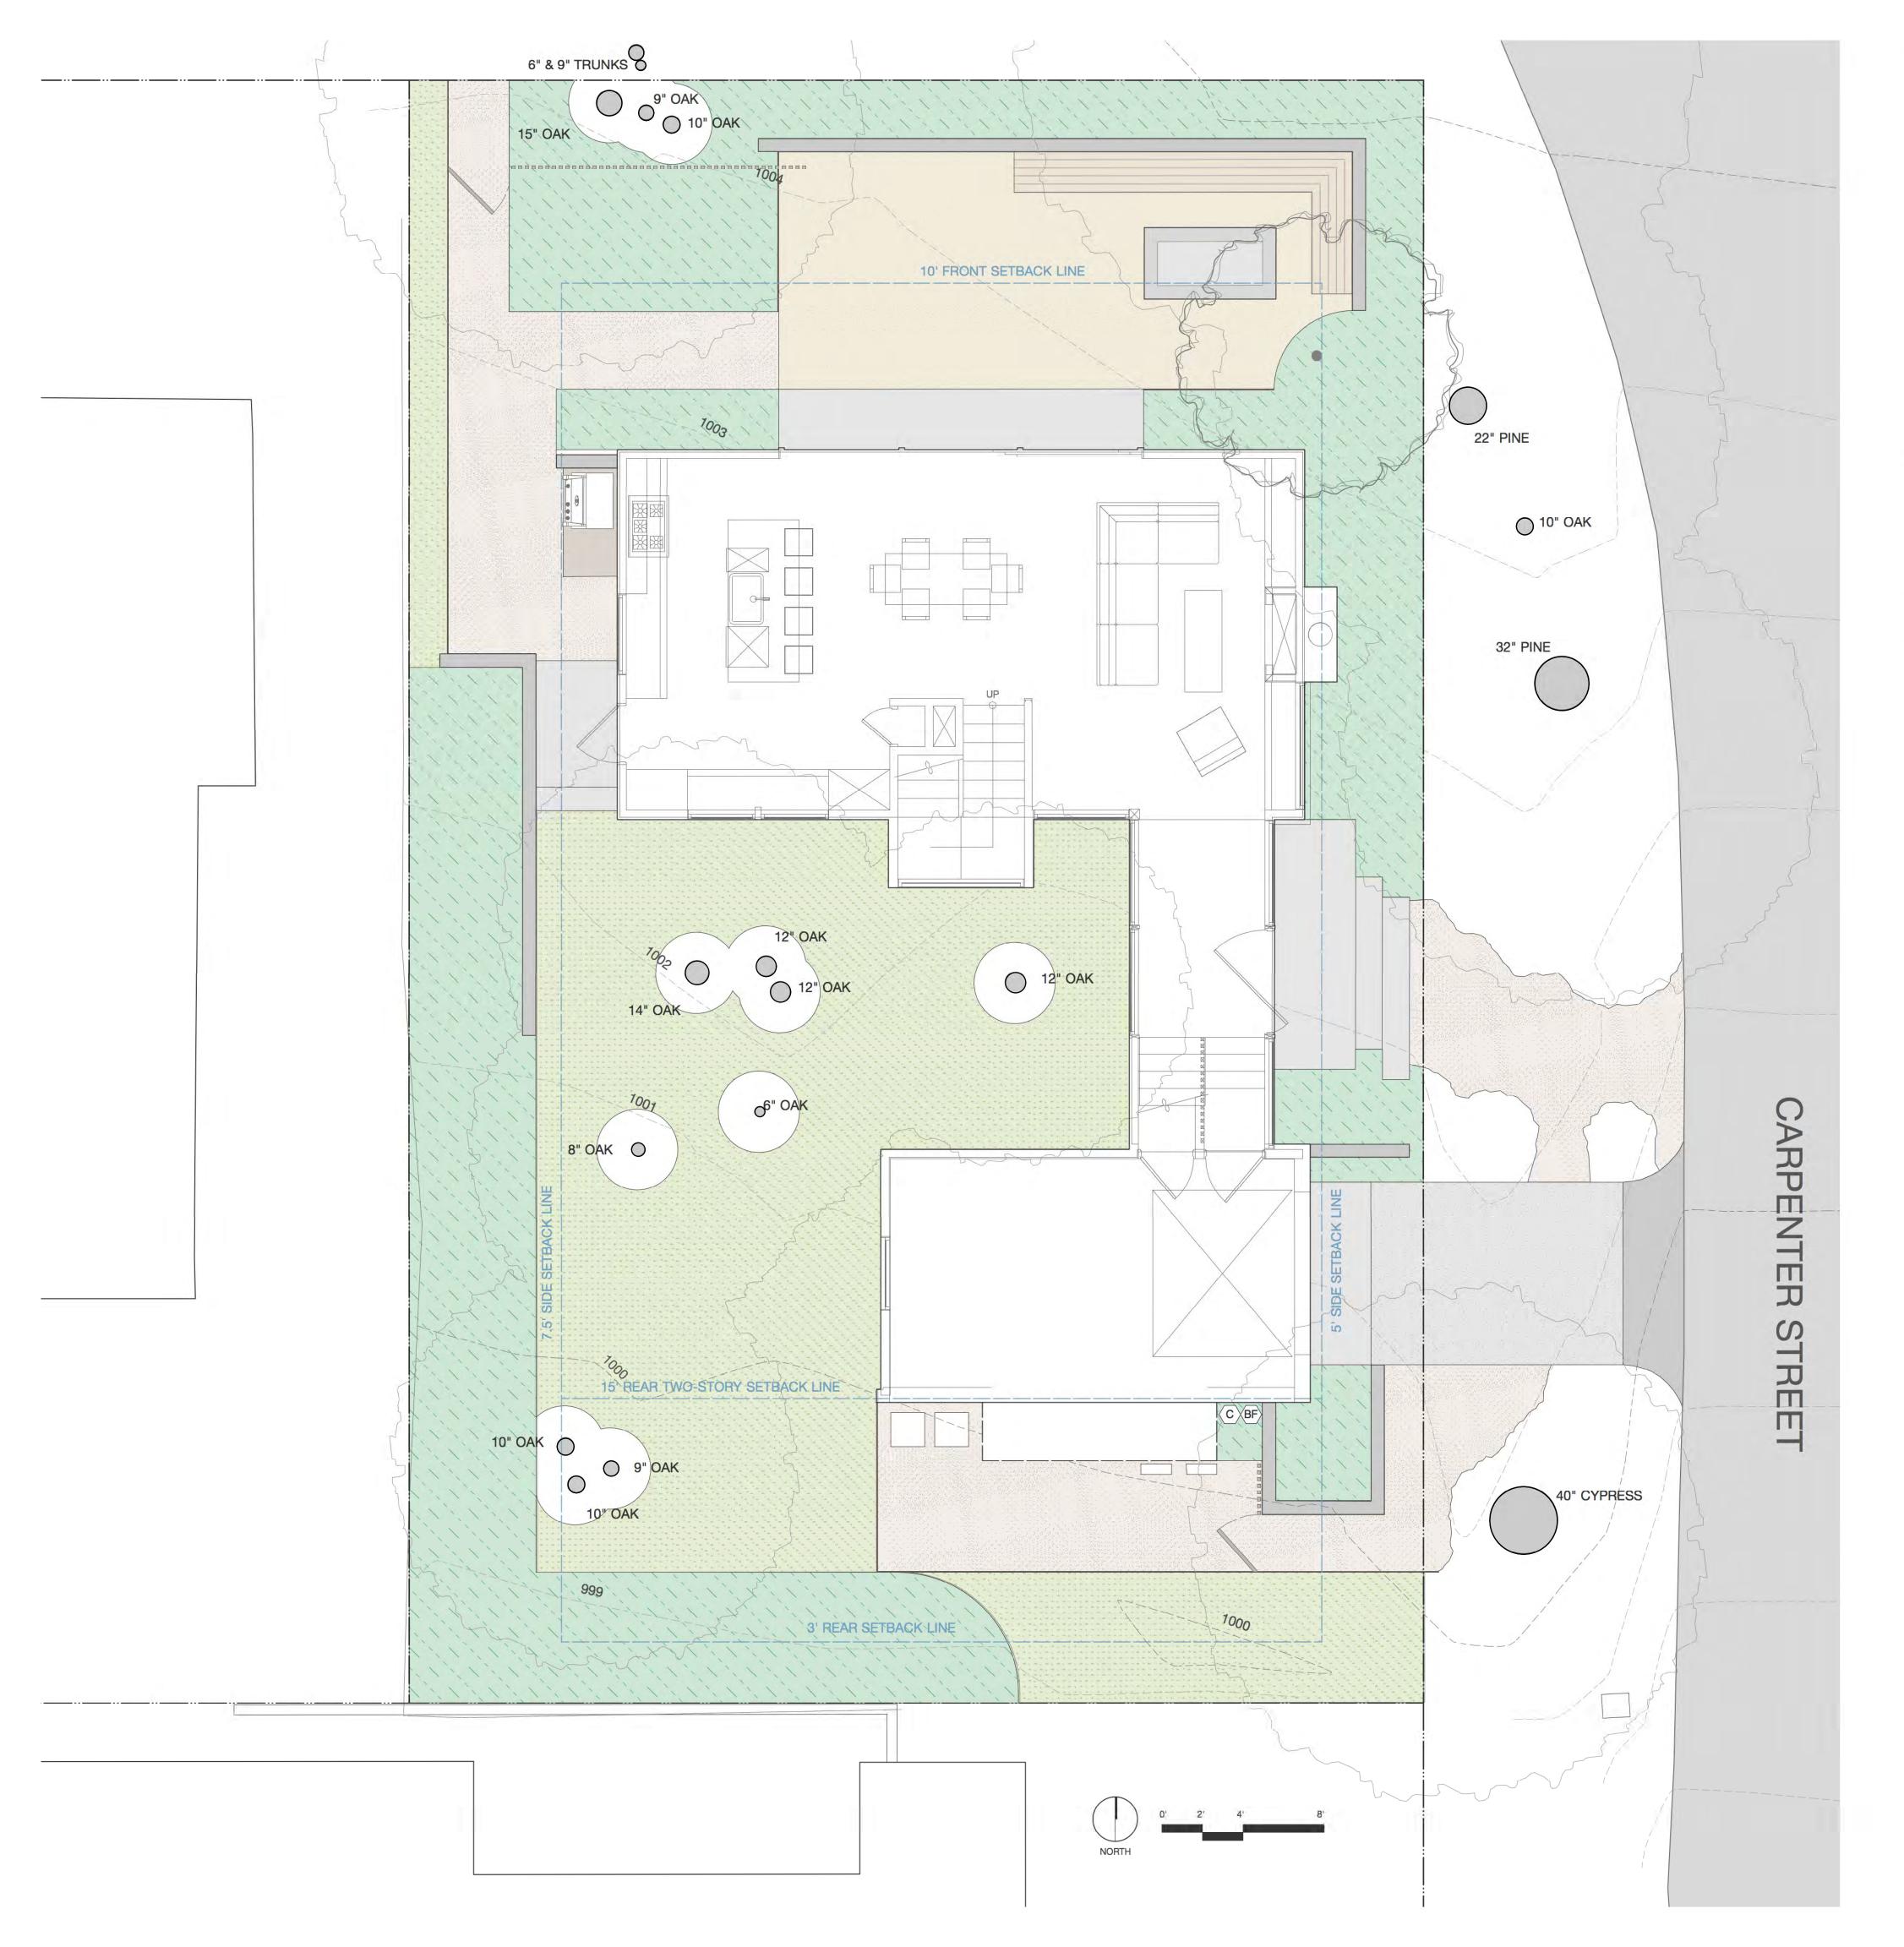

#### **IRRIGATION ZONES**

ZONE 1: Low flow, sub-surface dripline, Toro DL2000 Dripline with Root Guard, or equivalent.



ZONE 2: Low flow, drip emitter irrigation system for trees, shrub and grasses.



CONTROLLER LOCATION

BACKFLOW PREVENTER + SHUT-OFF VALVE, TBD.

# **BLISS** LANDSCAPE ARCHITECTURE

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#### **IRRIGATION NOTES**

- 1. This diagram is to show design intent only, it is not intended to replace a complete irrigation plan construction document and is therefore not for construction. Zones of differing water needs are indicated, exact water requirements to be determined.
- 2. The proposed irrigation system will provide appropriate methods of water distribution based on planting types and groups of plants with similar water needs. Because all proposed plant material has medium- to low-water requirements, the irrigation system will consist of low-flow or 'drip' system.
- 3. All 'drip' control valves will include in-line filtration. Trees will be irrigated on separate valves from shrubs, groundcovers and turf. Each irrigation zone will have a matched precipitation rate and will be designed to irrigate hydro zones with similar site, slope, soil, solar aspect and plant material.
- 4. Contractor shall be responsible for ensuring that all work is in accordance with all applicable codes and that all necessary permits are obtained style.
- 5. Contractor shall verify available pressure, and review the following with the Landscape Architect or Owner: point of connection, backflow preventer, master shut off valve, entire irrigation system pressure regulator, controller location, power source and other information pertinent to the installation of the irrigation system.
- 6. Contractor to lay out piping to minimize disturbance under existing trees. No trenching shall occur within tree dripines. If a condition arises where trenching within the tree driplines is necessary, consult Landscape Architect or Owner before
- 7. Materials should be Rainbird or products of an equivalent quality.
- 8. Wire shall be #14 minimum, U.L. Approved for direct burial.
- 9. All pressure lines and lateral lines shall be minimum Schedule 40.
- 10. Select nozzles to fit area being irrigated and to minimize overspray. Use adjustable arc nozzles in areas smaller than 90 degree angle. Nozzles to point away from Oaks.
- 11. 100% head to head overlap is required for all spray areas.
- 12. Locate remote control valves in shrub areas out of sight and adjacent to edges wherever possible. Review locations of valves with Landscape Architect or Owner prior to installation. Valve box covers to be black.
- 13. Install check valves on all low heads as required to prevent low head drainage.
- 14. Controller shall be multi programmable with repeat start times and capable of minimum 28 day cycle.
- 15. Contractor shall provide sleeves under walls and paving areas as needed for irrigation, electrical, and drainage lines. Provide at least two (2) 4" Schedule 40 sleeves at each location.
- 16. Contractor to provide Owner with warranties and operating instructions for all equipment, with a diagram coordinating numbers with site irrigation zones, and instruct Owner in controller operation.
- 17. Provide hose bibbs as directed by Landscape Architect or Owner. Hose bibb to be standard brass fixture mounted 12" above adjacent finish grace stake place with 3/4" galvanized pipe attached with radiator clamps. Drive stake a minimum of 3'
- 18. Landscape Architect to review all irrigation layout prior to installation.

#### DRIP IRRIGATION NOTES

- 1. The contractor shall provide a drip emitter system for all tree, shrubs and groundcover plantings as indicated on the Plan.
- 2. Actual layout of emitter system shall be determined by the Contractor in the field using the Planting Plan as a guide.
- 3. Each 15 gallon shrub shall receive three 1 GPH emitters distributed evenly around shrub, via distribution tubing.
- 4. Each 5 gallon shrub shall receive two 1 GPH emitters on opposite sides of shrub, via distribution tubing.
- 5. Each 1 gallon shrub shall receive two 1/2 GPH emitters on opposite sides of shrub, via distribution tubing.
- 6. Install emitters on top of the rootball and as far from the trunk of the plant as possible.
- 7. Distribution tubing shall be a maximum of 5' in length from 1/2" tubing to emitter. Each length of 1/2" drip tubing shall be a
- 8. Install 'Flush Plugs' at the end of the rigid PVC supply lines.
- 9. All PVC lateral pipe to drip tubing shall be 3/4".
- 10. The drip emitter system layout shall be approved by the Landscape Architect after planting has been completed.

project name

# The Quan Residence

SW Corner of 6th and Carpenter Carmel, CA 93923

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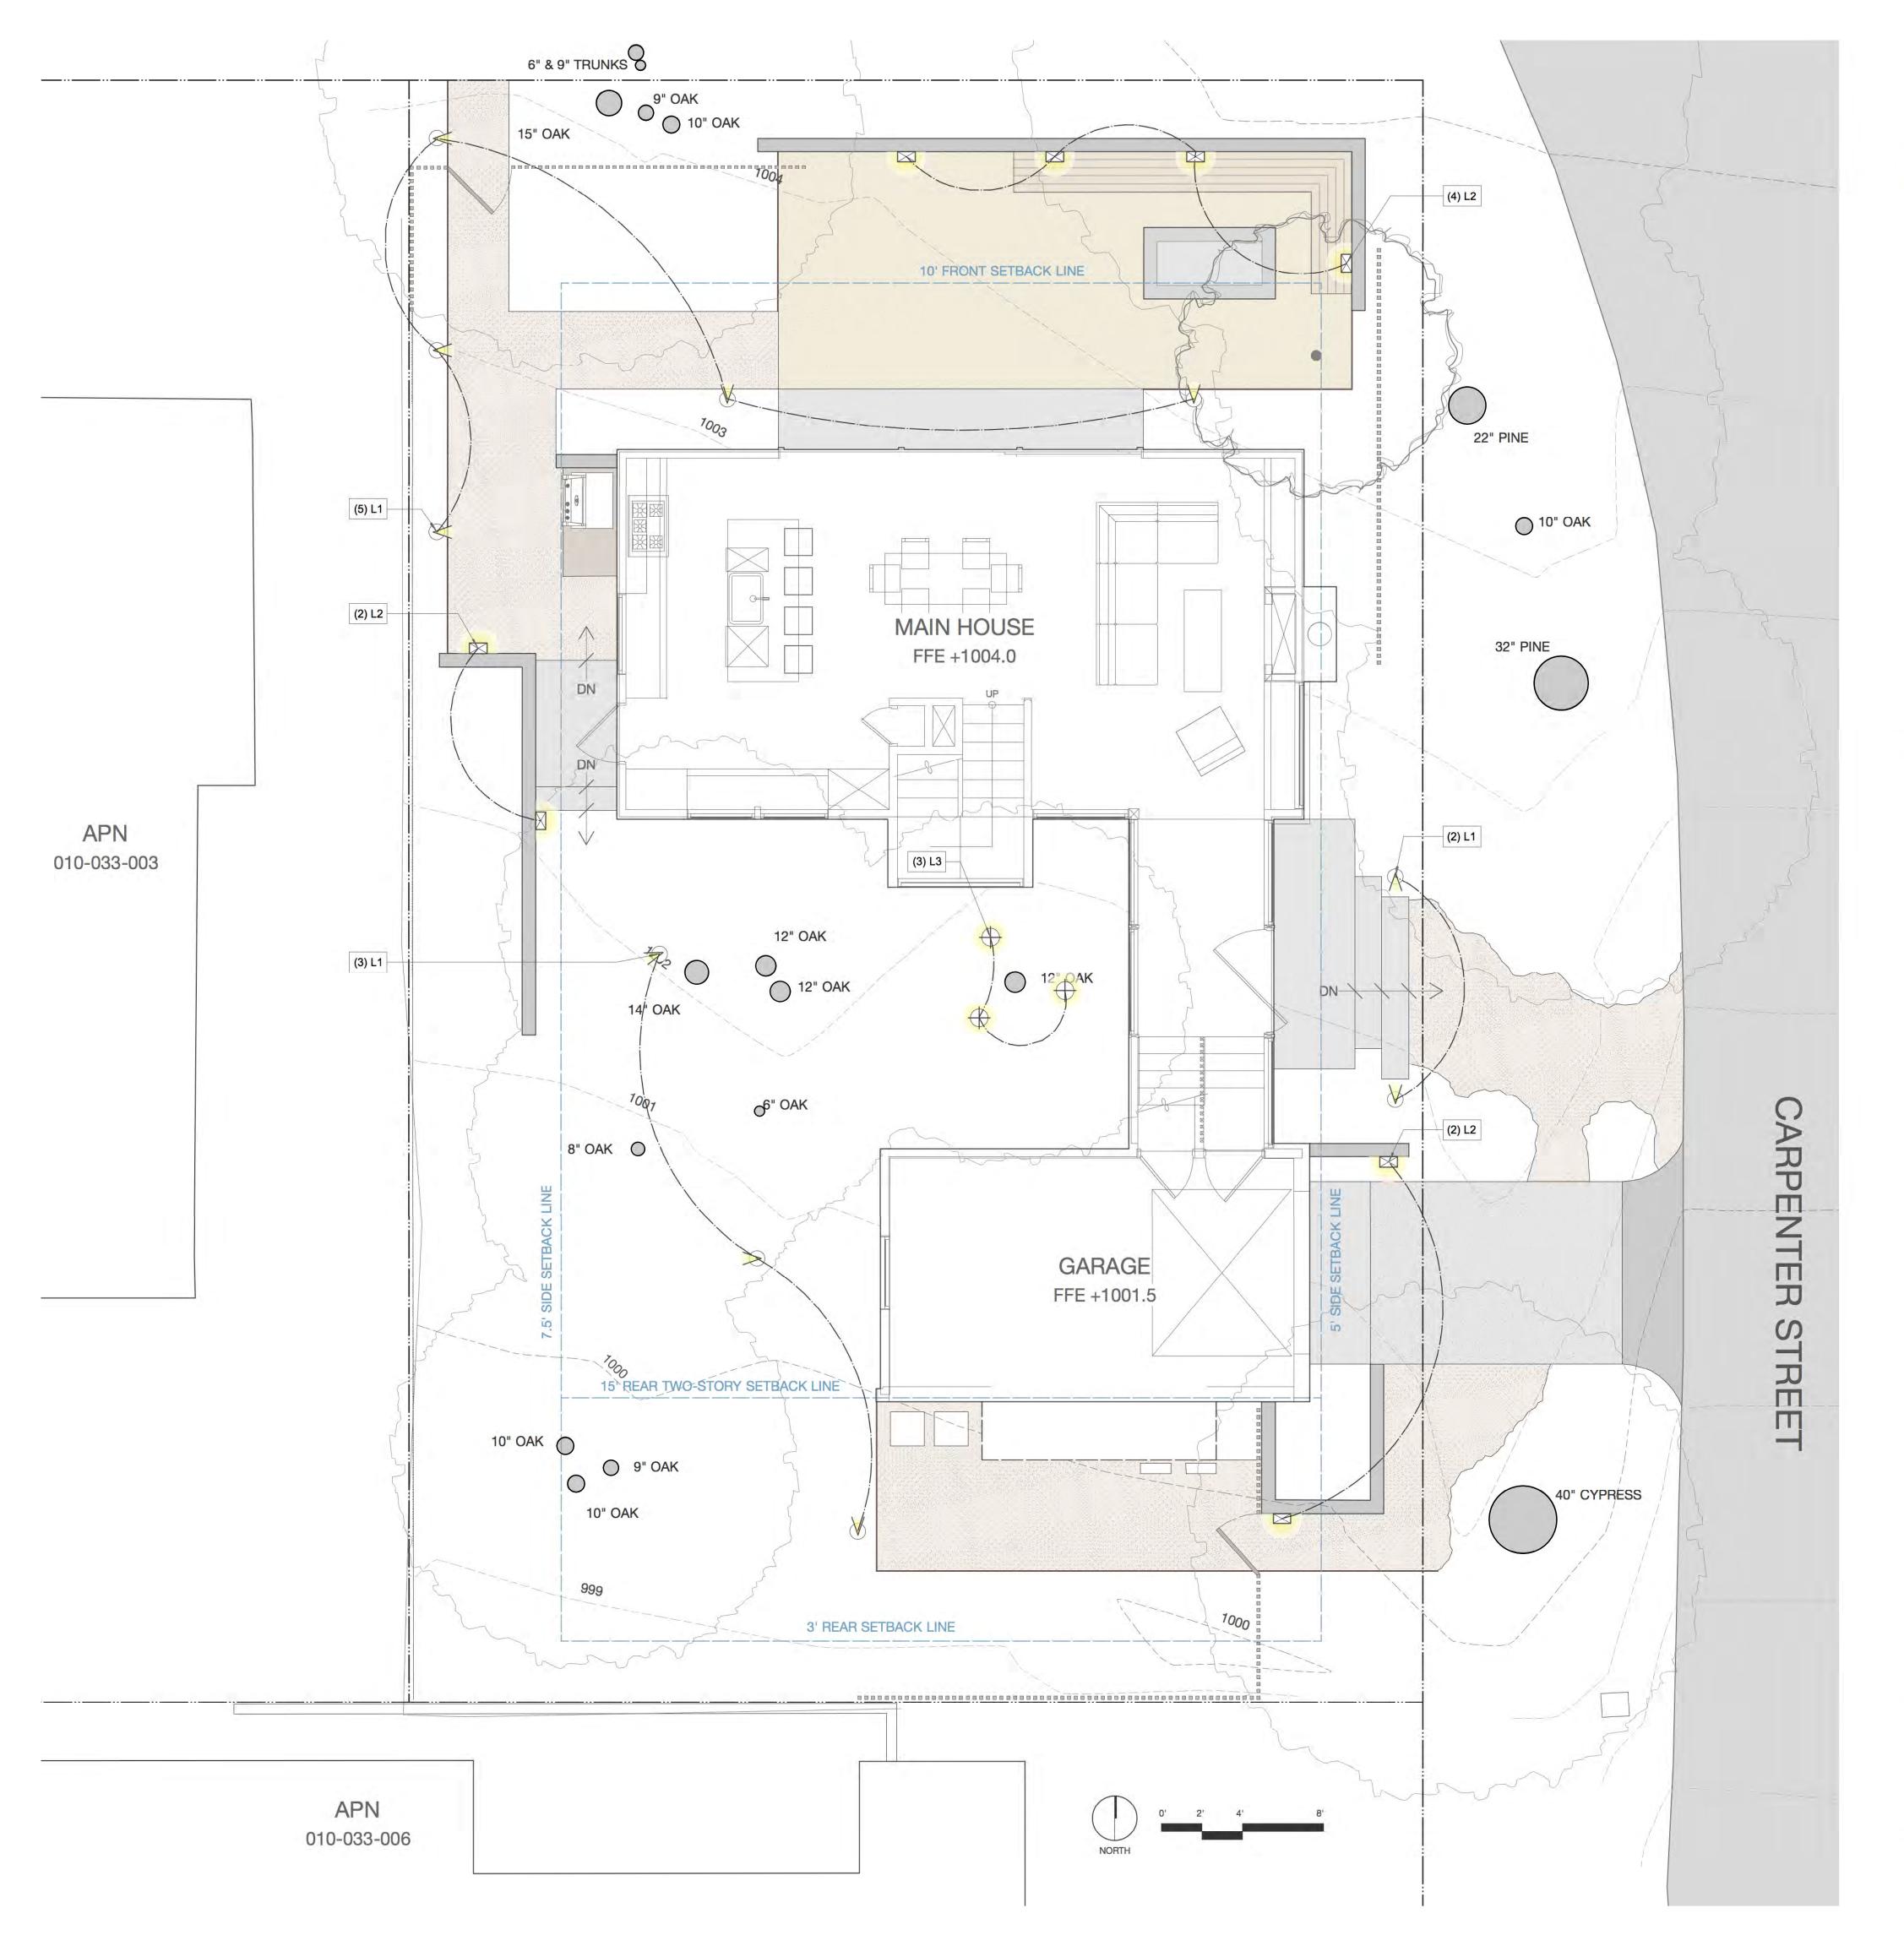
previous issue

rev description

drawing title IRRIGATION PLAN

drawn by: scale:

1/4"=1'-0"



#### LIGHTING LEGEND & SPECIFICATIONS

Symbol Quantity Description Brand/Model Wattage Notes

L1 10 Path Light Hunza- 'Twig Lite' TG COP 5W

L2 8 Reccessed Wall Light Lucifer- 'Double Impact' ISL2-LED 6.5W

L3 3 Tree Down Light BK Lighting- 'Aristar Ring Mount Down Light' RM AR LED 7W

BLISS LANDSCAPE ARCHITECTURE

26344 Carmel Rancho Lane, Ste. 4U Carmel, CA 93923

www.blisslandscapearchitecture.com



Twig Lite
Cat. No. TG

The Twig Lite has a subtle appearance, which allows it to blend into taller foliage. The luminaire has a frosted glass lens to reduce glare and is operated with a 5, 10 or 20 watt G4 b-pin halogen lamp.

The Retro™, which is a mains option, avoids the need to bury a transformer. The 110/240-12 voit electronic transformer is built into the pole and is a double insulated safety isolating transformer. The transformer has an IP56 rating.

Ordering Information

Luminaire Type
TG - Twig Lite
COP - Copper
SSP/G - Hunza™ Super Spike
RF - Retro™ Transformer
110/240-12 voit
For LED options, refer to page
10.4 (G4 of LED)
10.4 (

L2 / Recessed Wall

L1 / Path Light



O2017 Luciter Lighting Company

As part of its policy of definitions resisting and product development, the company

[GATE OF REV. 05.0197]

[OATE OF REV. 05.0197]

L3 / Tree Down Light



**EXTERIOR LIGHTING NOTES** 

Lights to be controlled with switches (S.A.D.).

2. Light source shall not be visible from off-site premises.

The lighting plan is diagrammatic and intended to show general fixture location and type. Exact location of fixtures and transformers shall be verified on site with landscape architect.

4. Contractor shall coordinate with general contractor and electrical contractor for installation of conduit, sleeving, switching locations and junction boxes during other phases of work.

5. All fixtures to be installed per manufacturer's specifications.

6. All "flush" fixtures to be installed level with top of paving material, gravel or plant bed mulch, unless otherwise noted.

project name

The Quan Residence

SW Corner of 6th and Carpenter Carmel, CA 93923

010-033-005

issue set

issue date 01.02.18


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drawing title
LIGHTING PLAN

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OL 1/4"=1'-0"

L5.0



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FIRST FLOOR PLAN

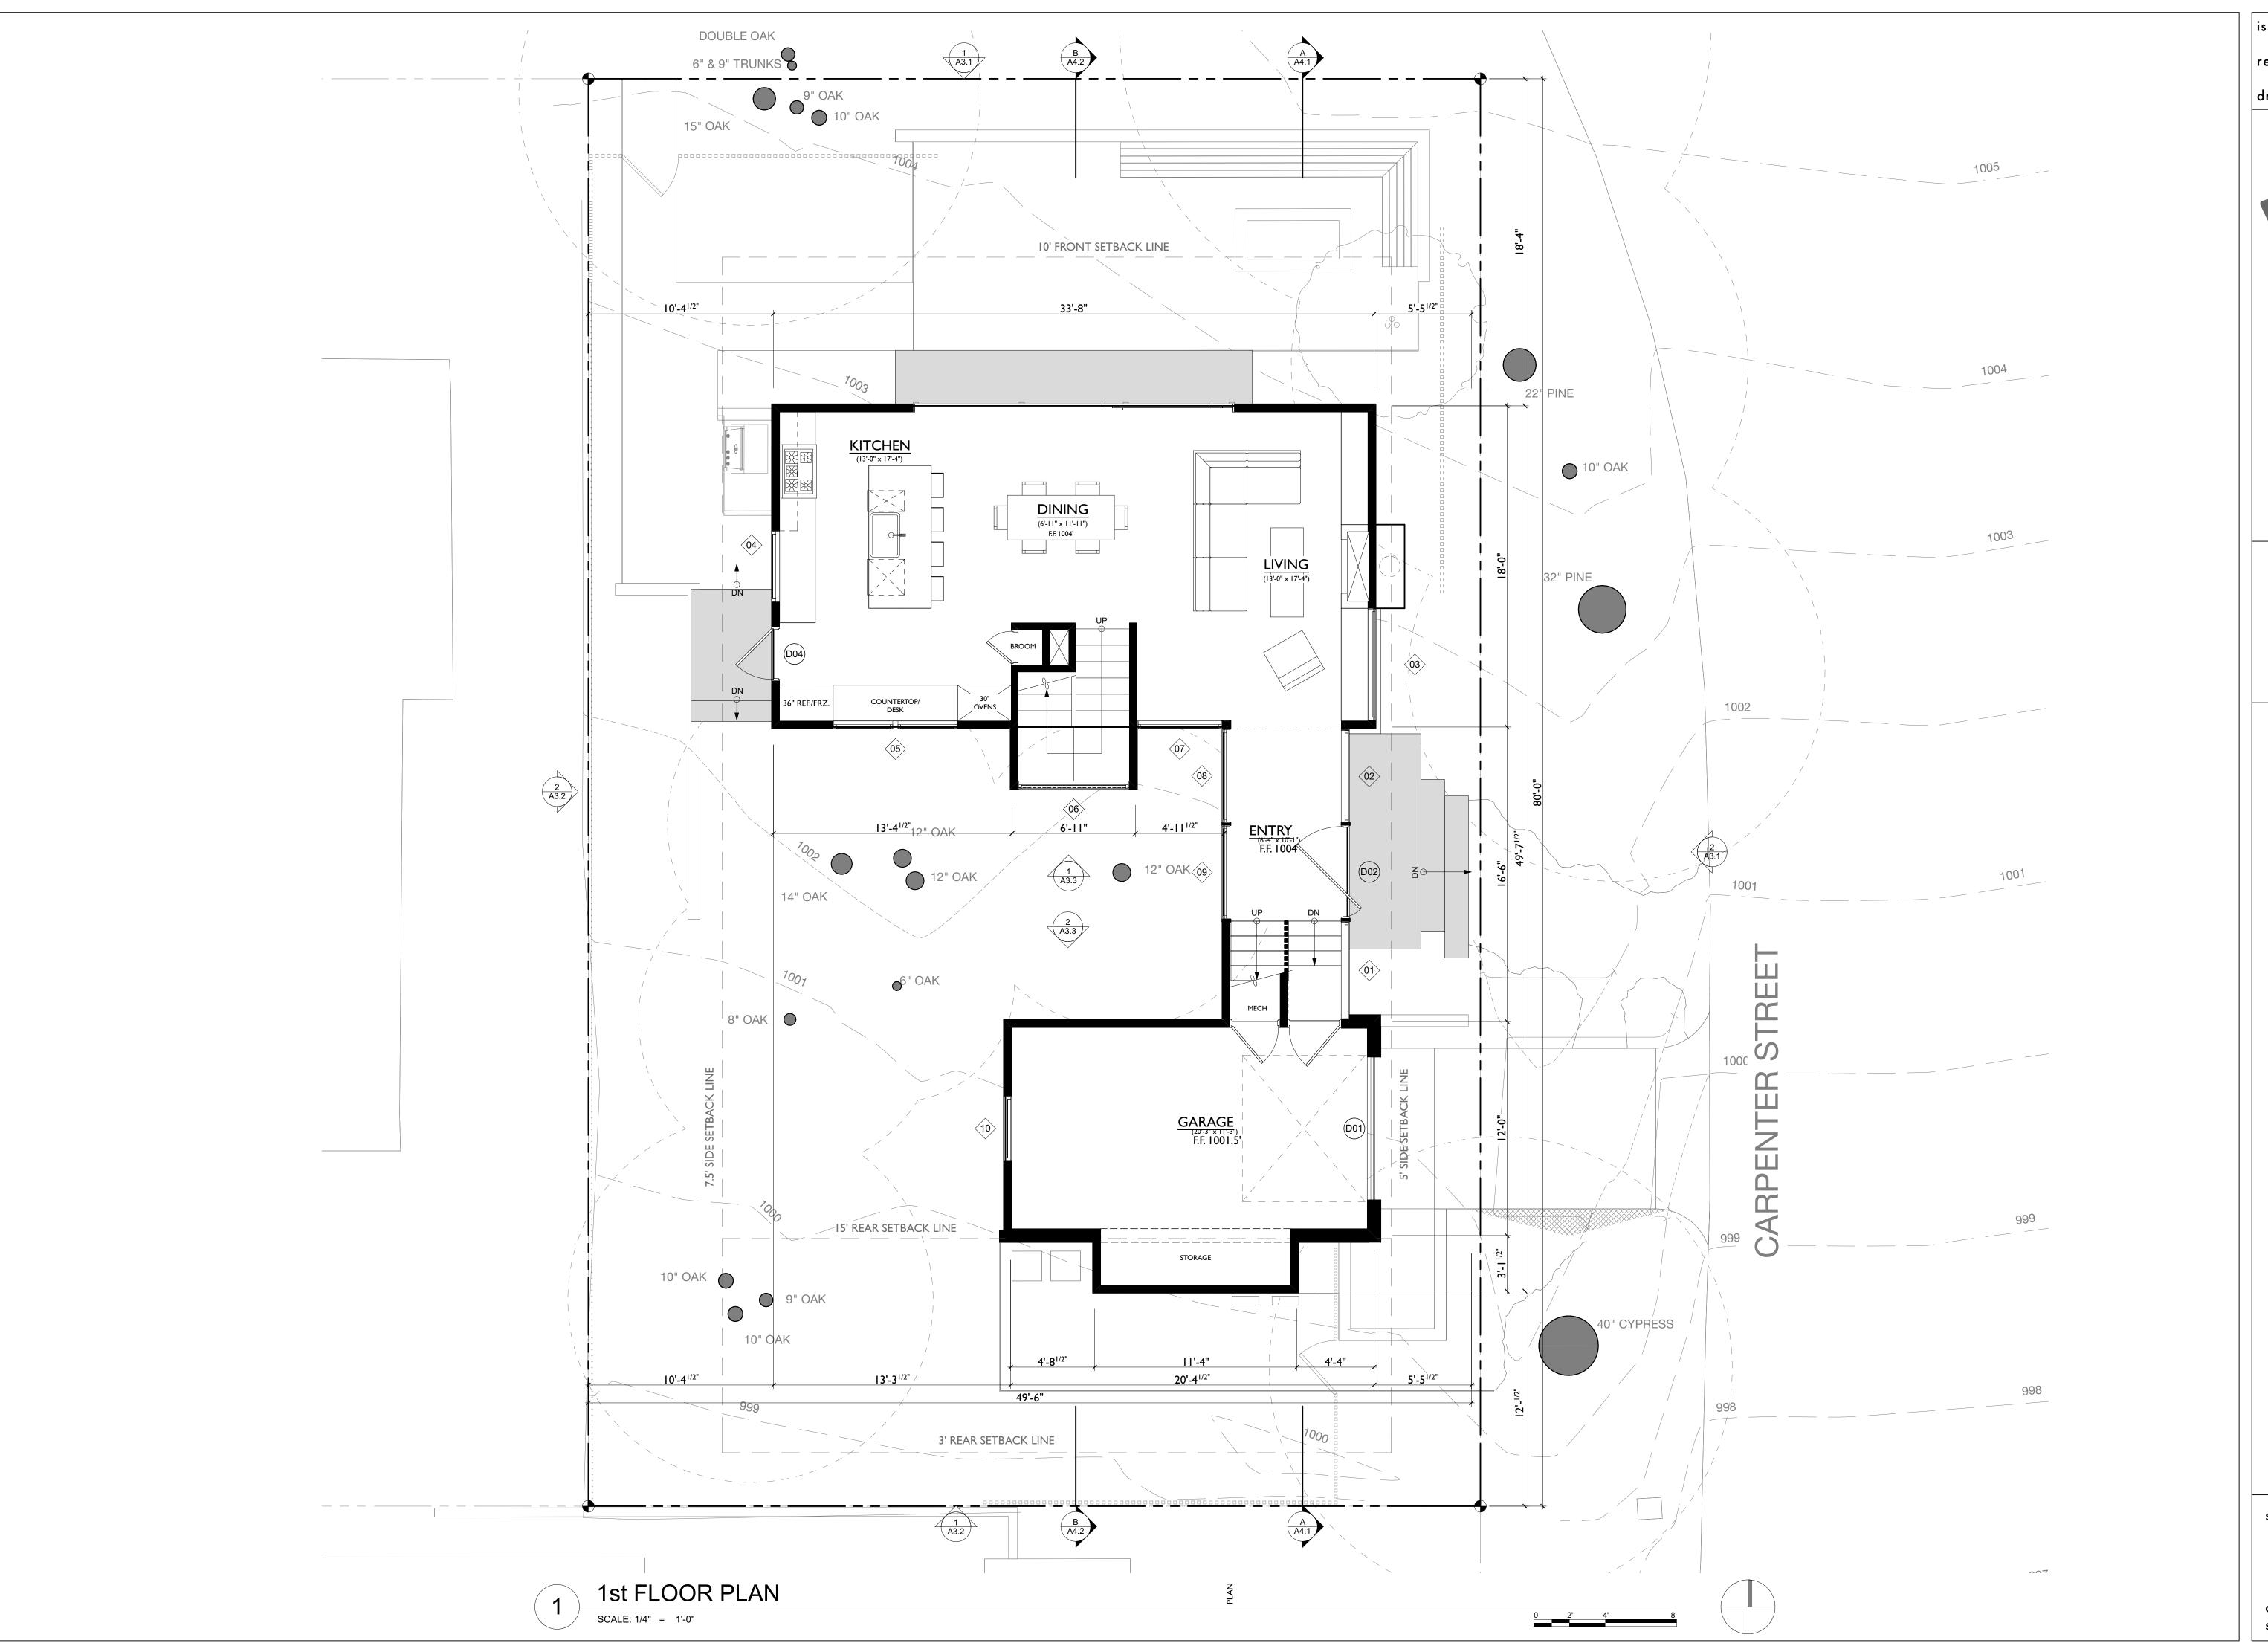sheet 11




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SECOND FLOOR PLAN

sheet 12



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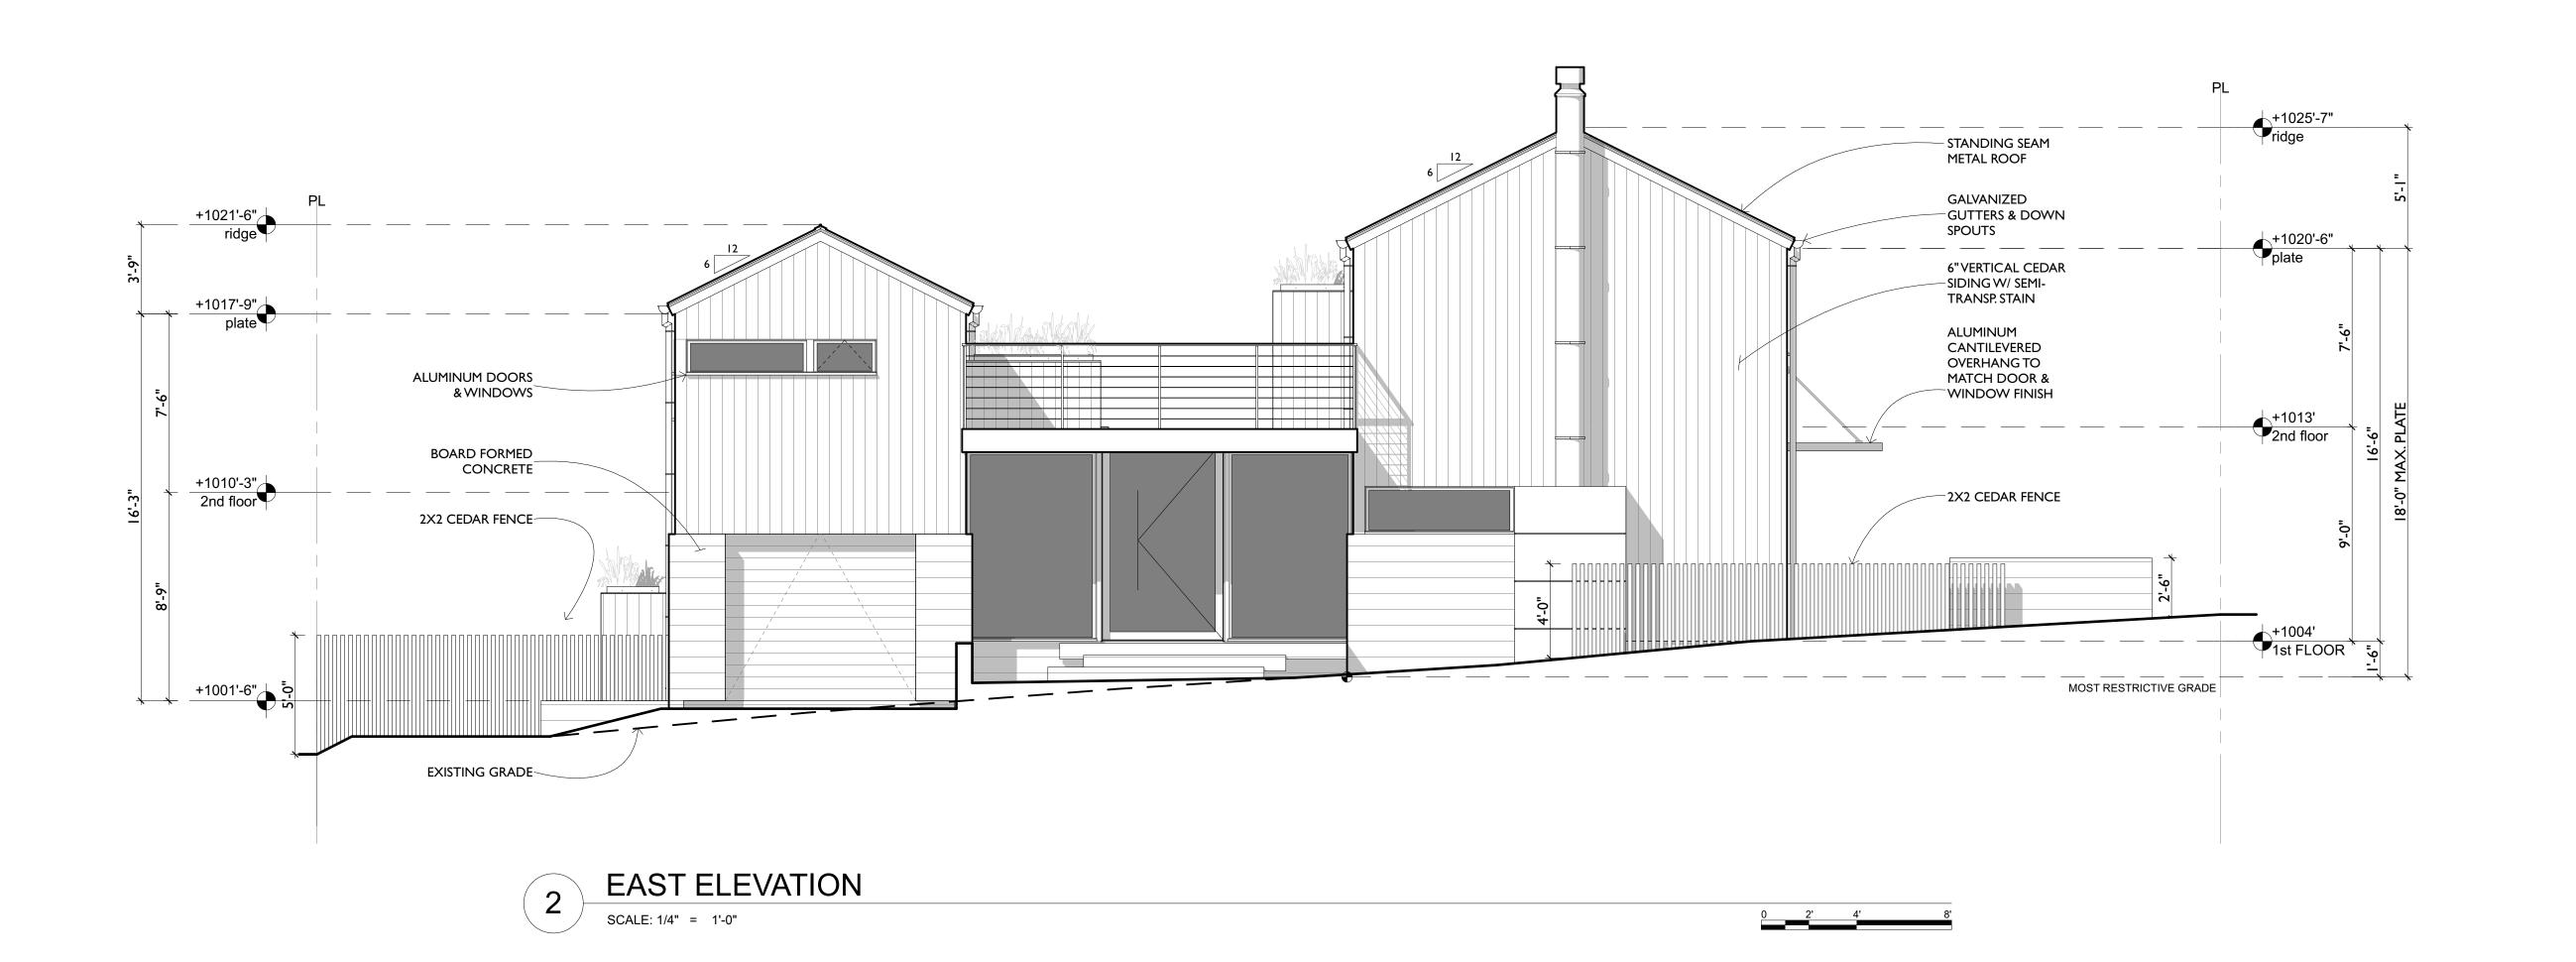
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ROOF PLAN

sheet 13

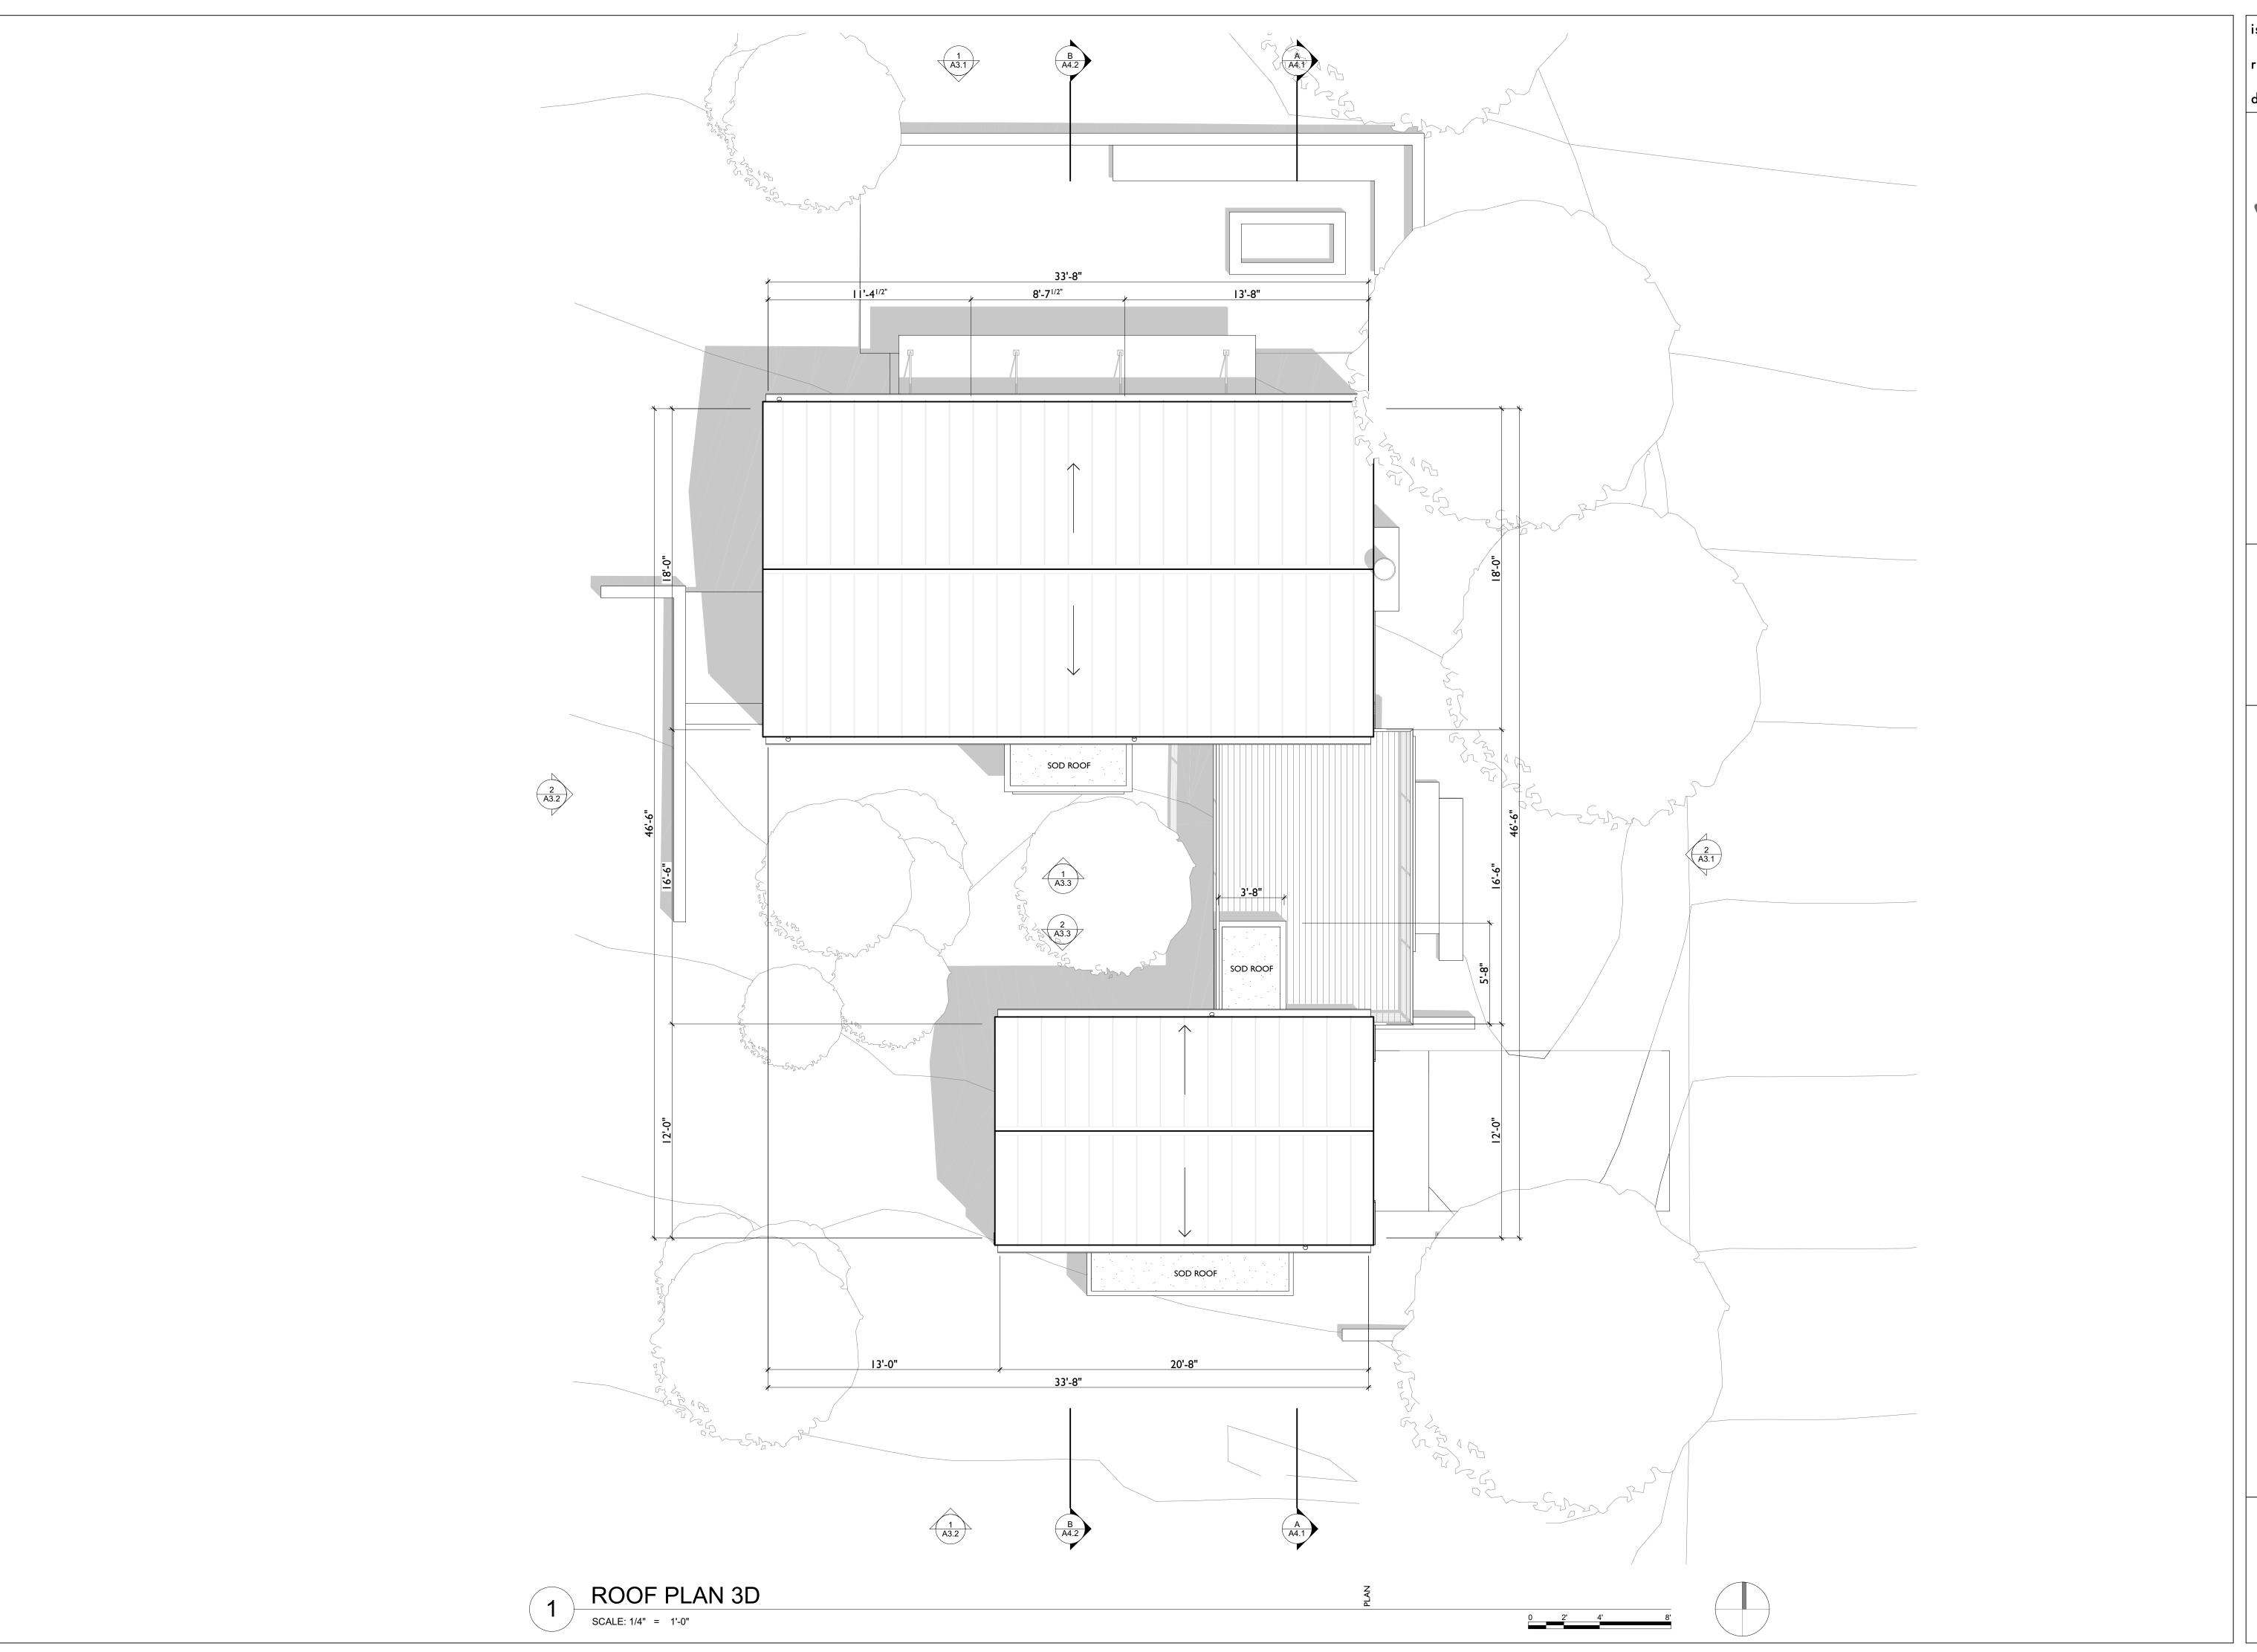

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revised:

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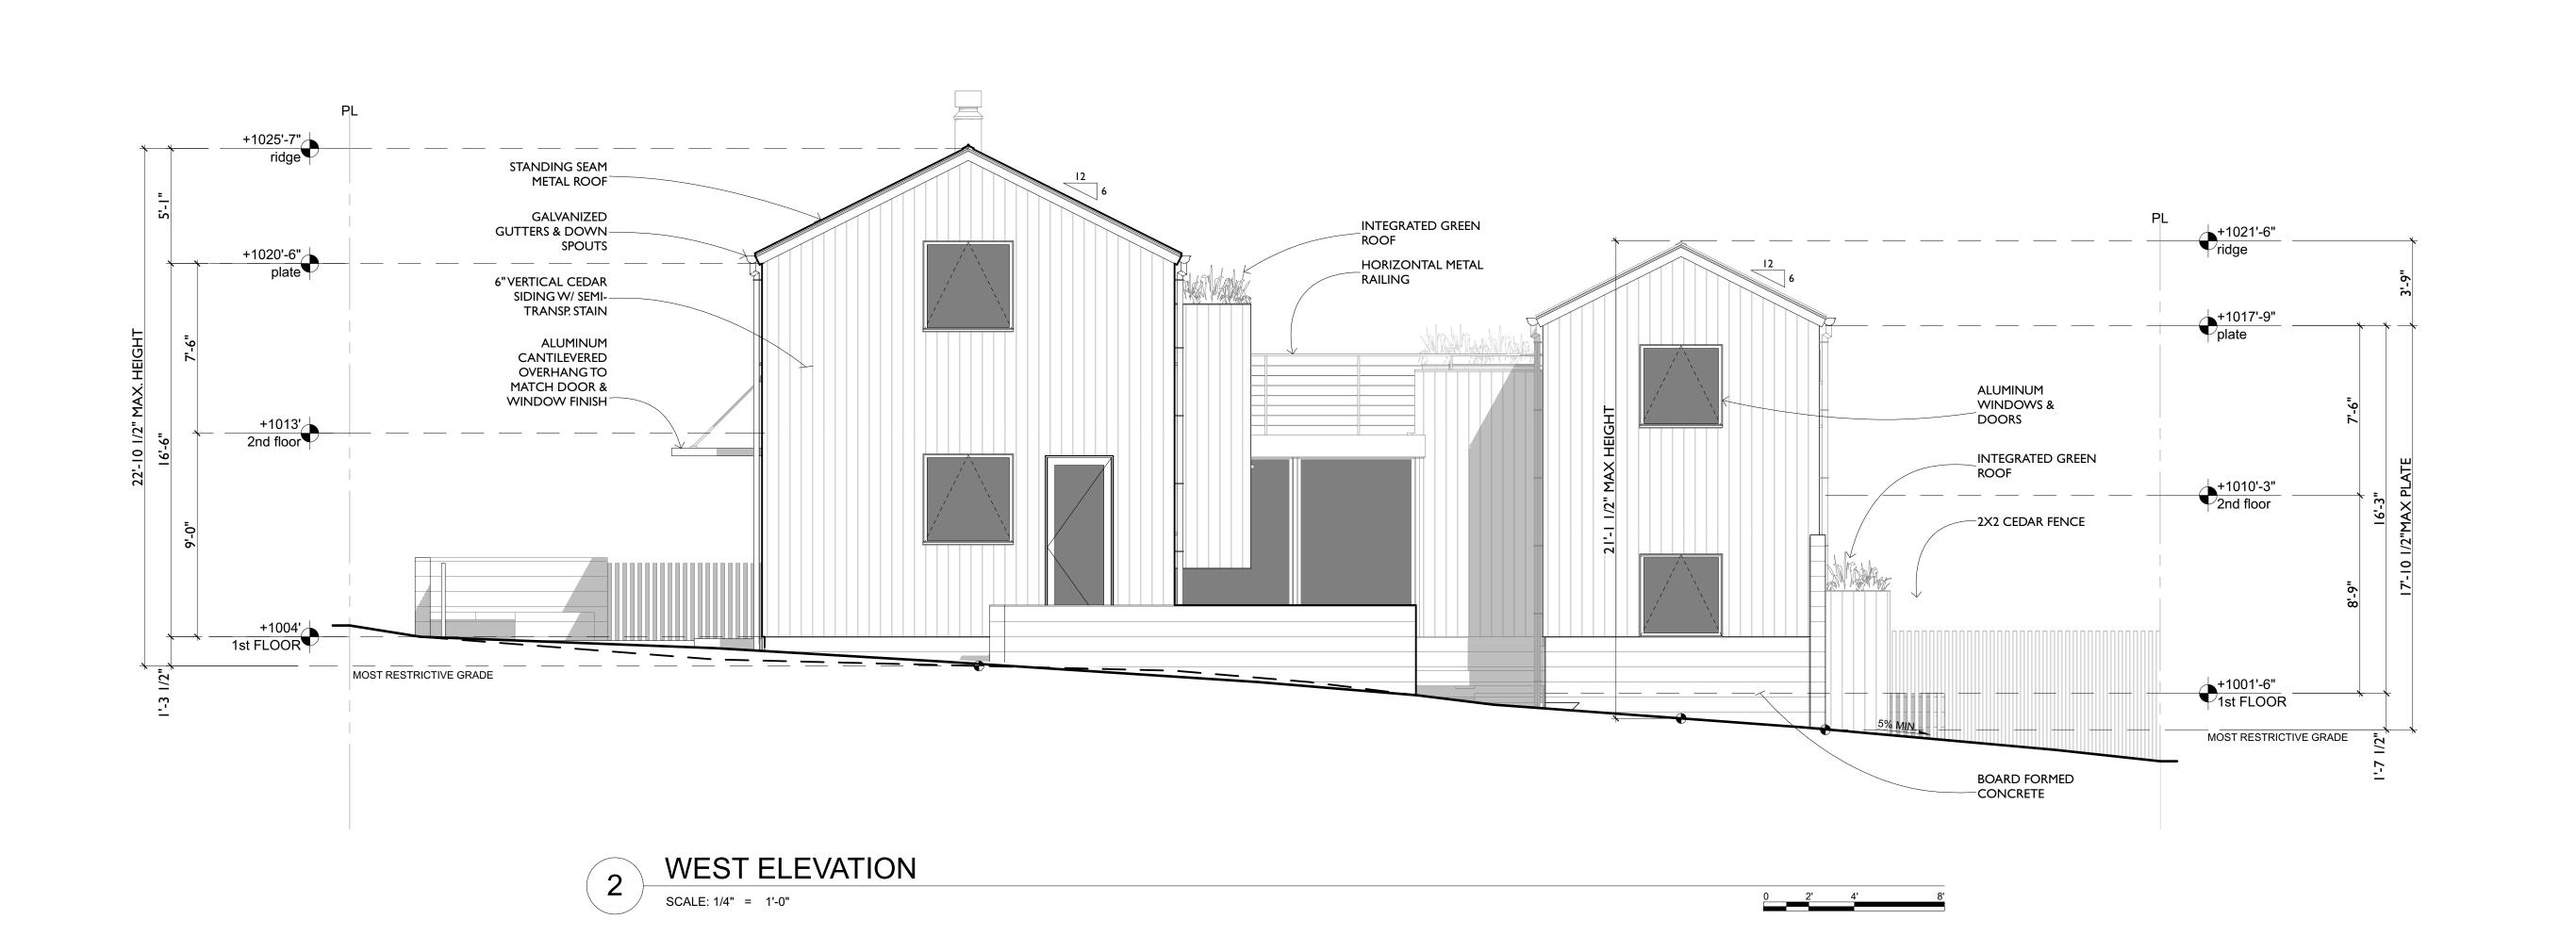
NORTH & WEST ELEVATIONS

sheet 14

**A3.** 

of sheets





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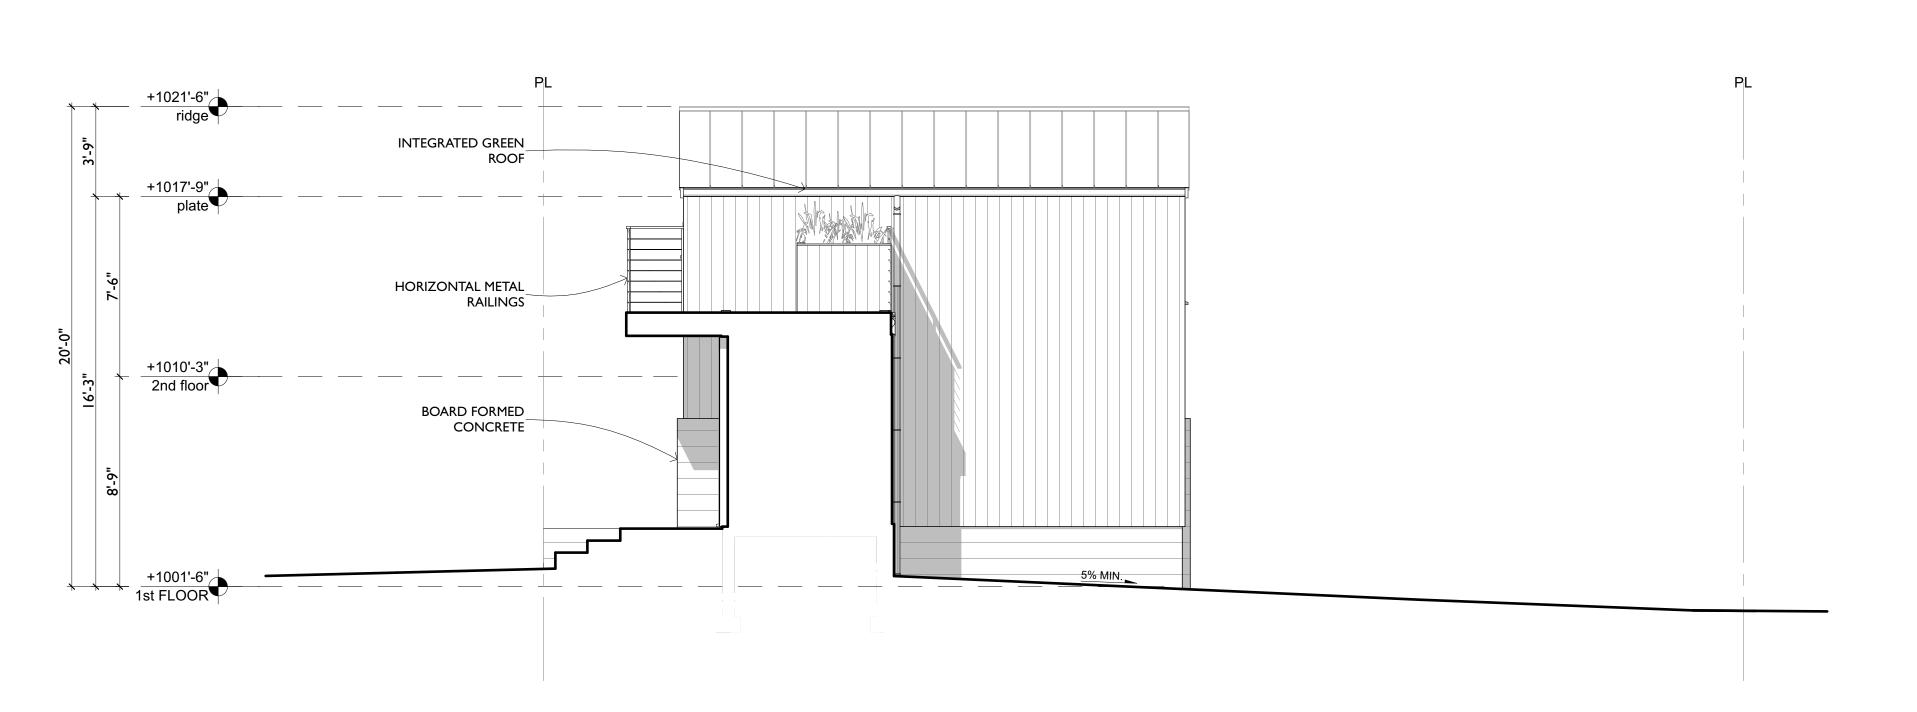
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SOUTH & WEST **ELEVATIONS** 

sheet 15





2 SECTION THROUGH ENTRY LOOKING SOUTH

SCALE: 1/4" = 1'-0"

0 2'

issued: 3/1/18

revised:

drawn by:

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NORTH & WEST ELEVATIONS (COURTYARD)

sheet 16

**A3.** 

of sheets



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EXISTING & PROPOSED STREET ELEVATIONS (CARPENTER)



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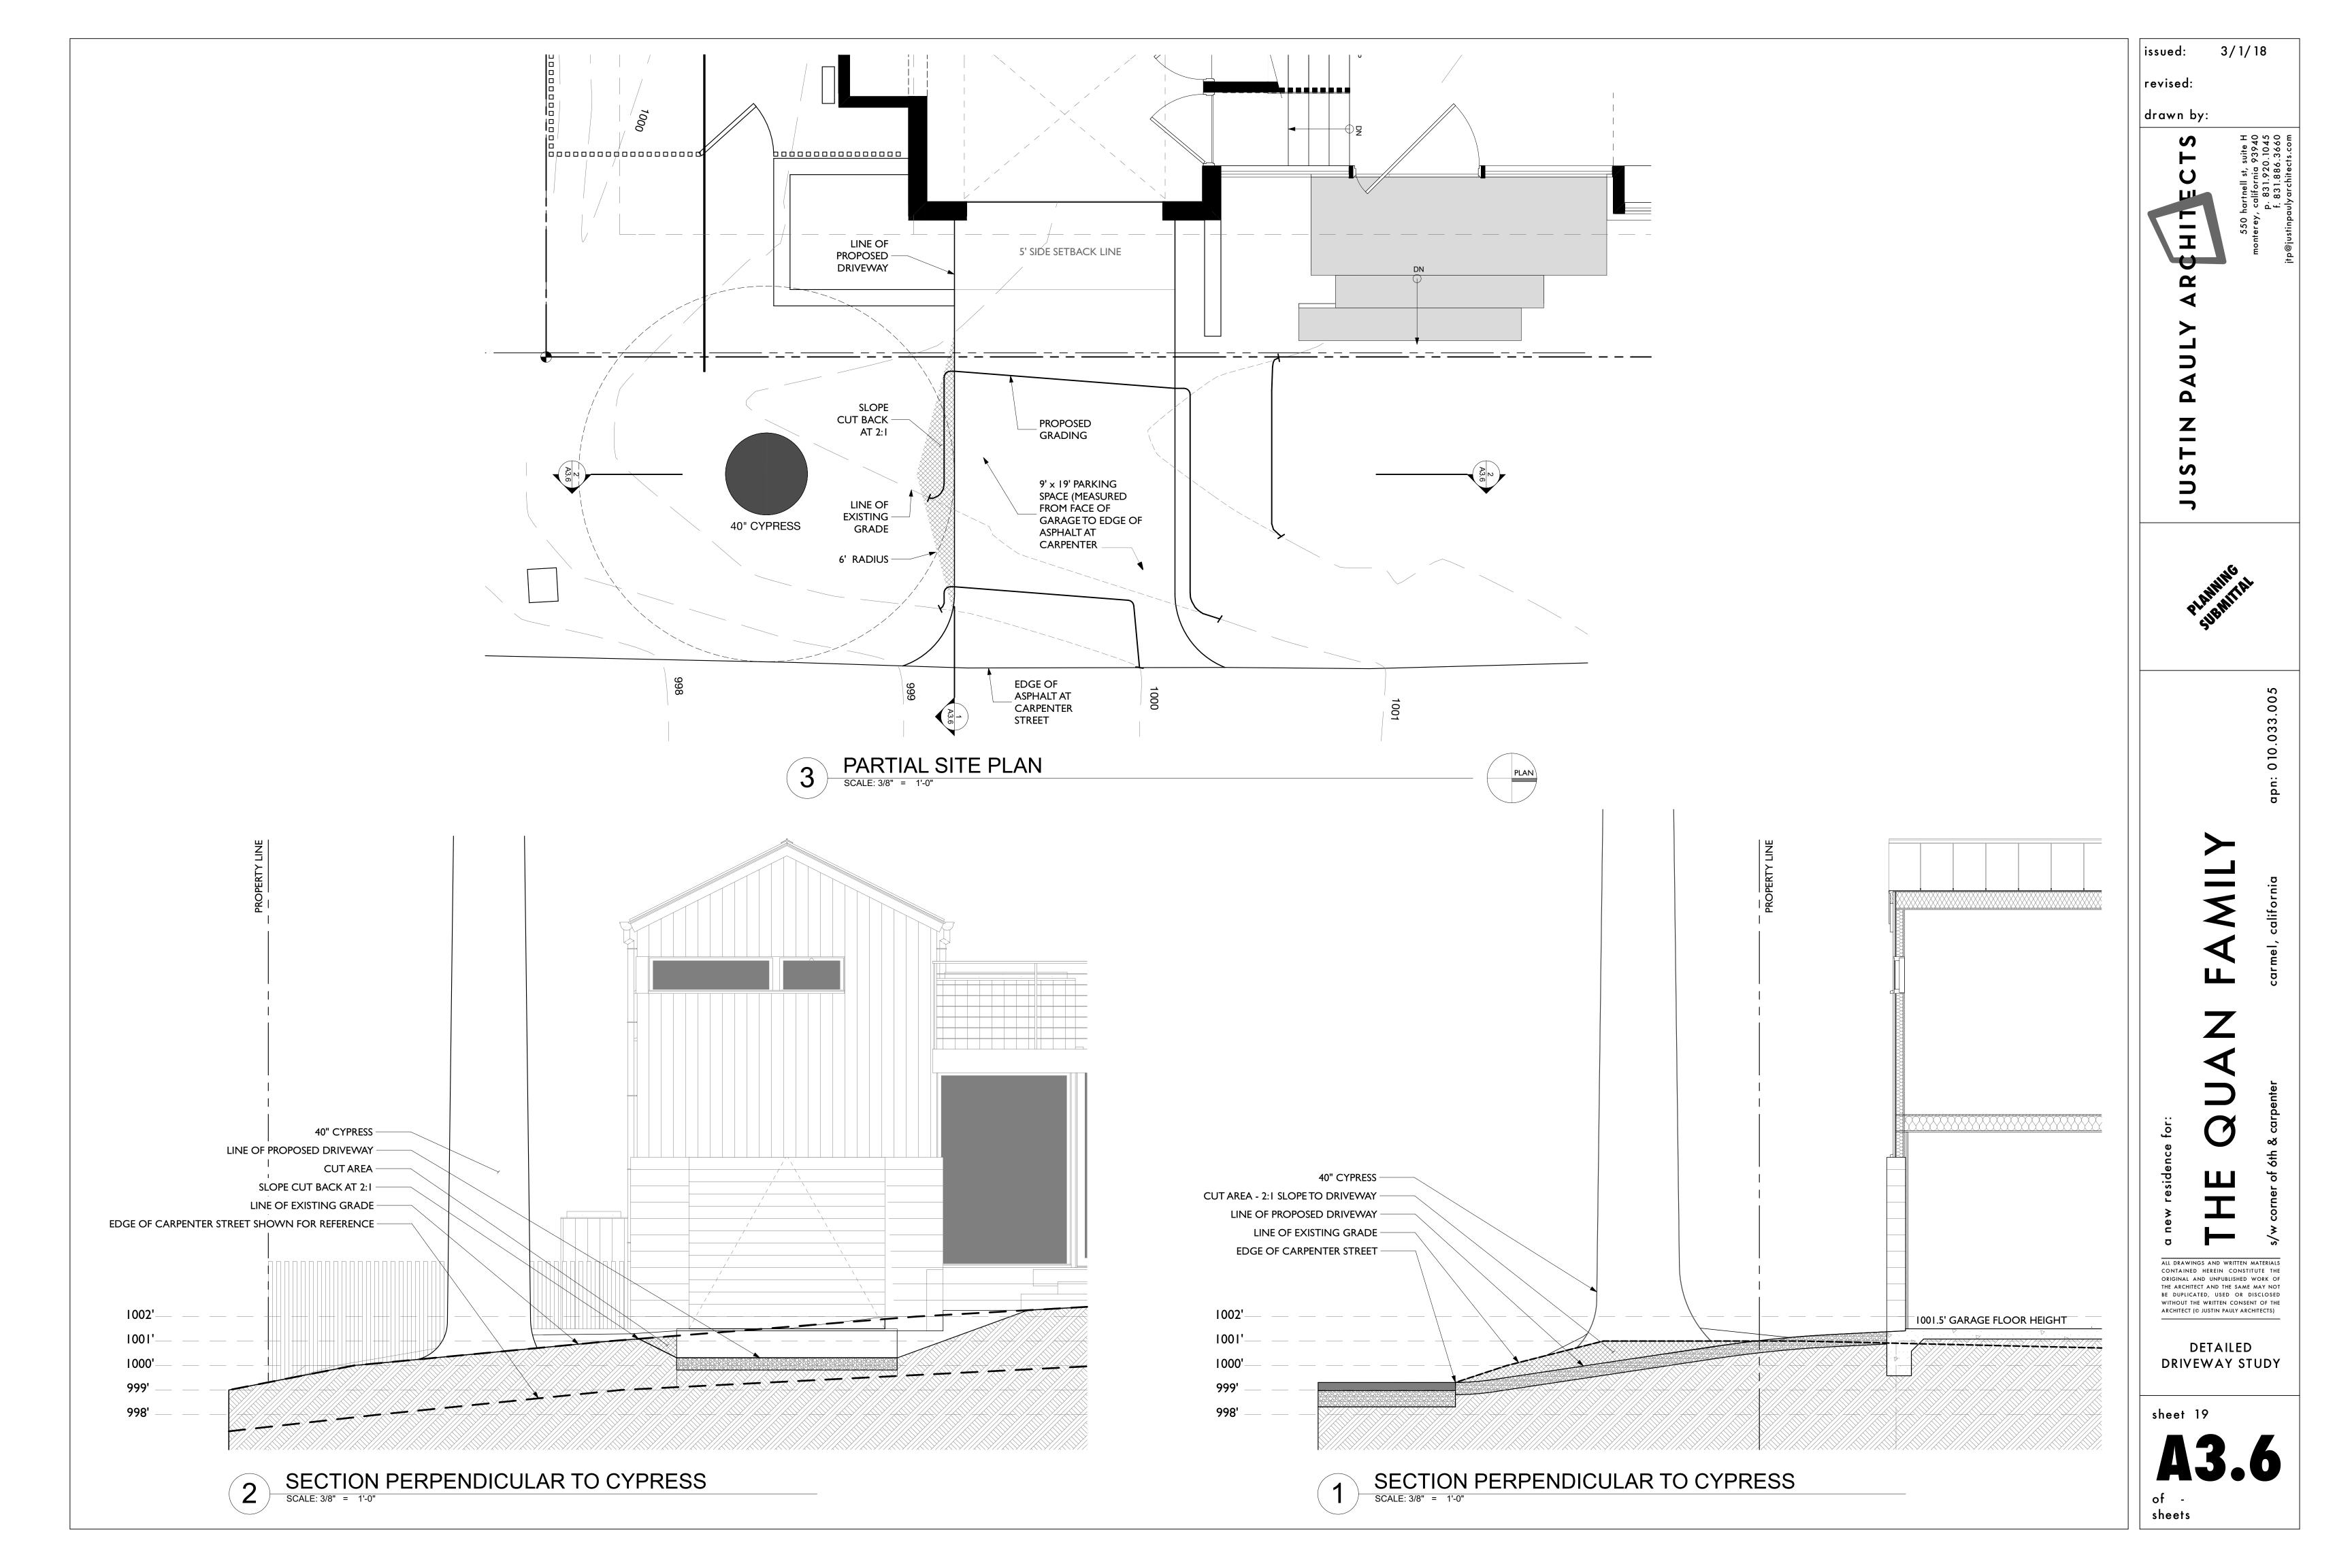
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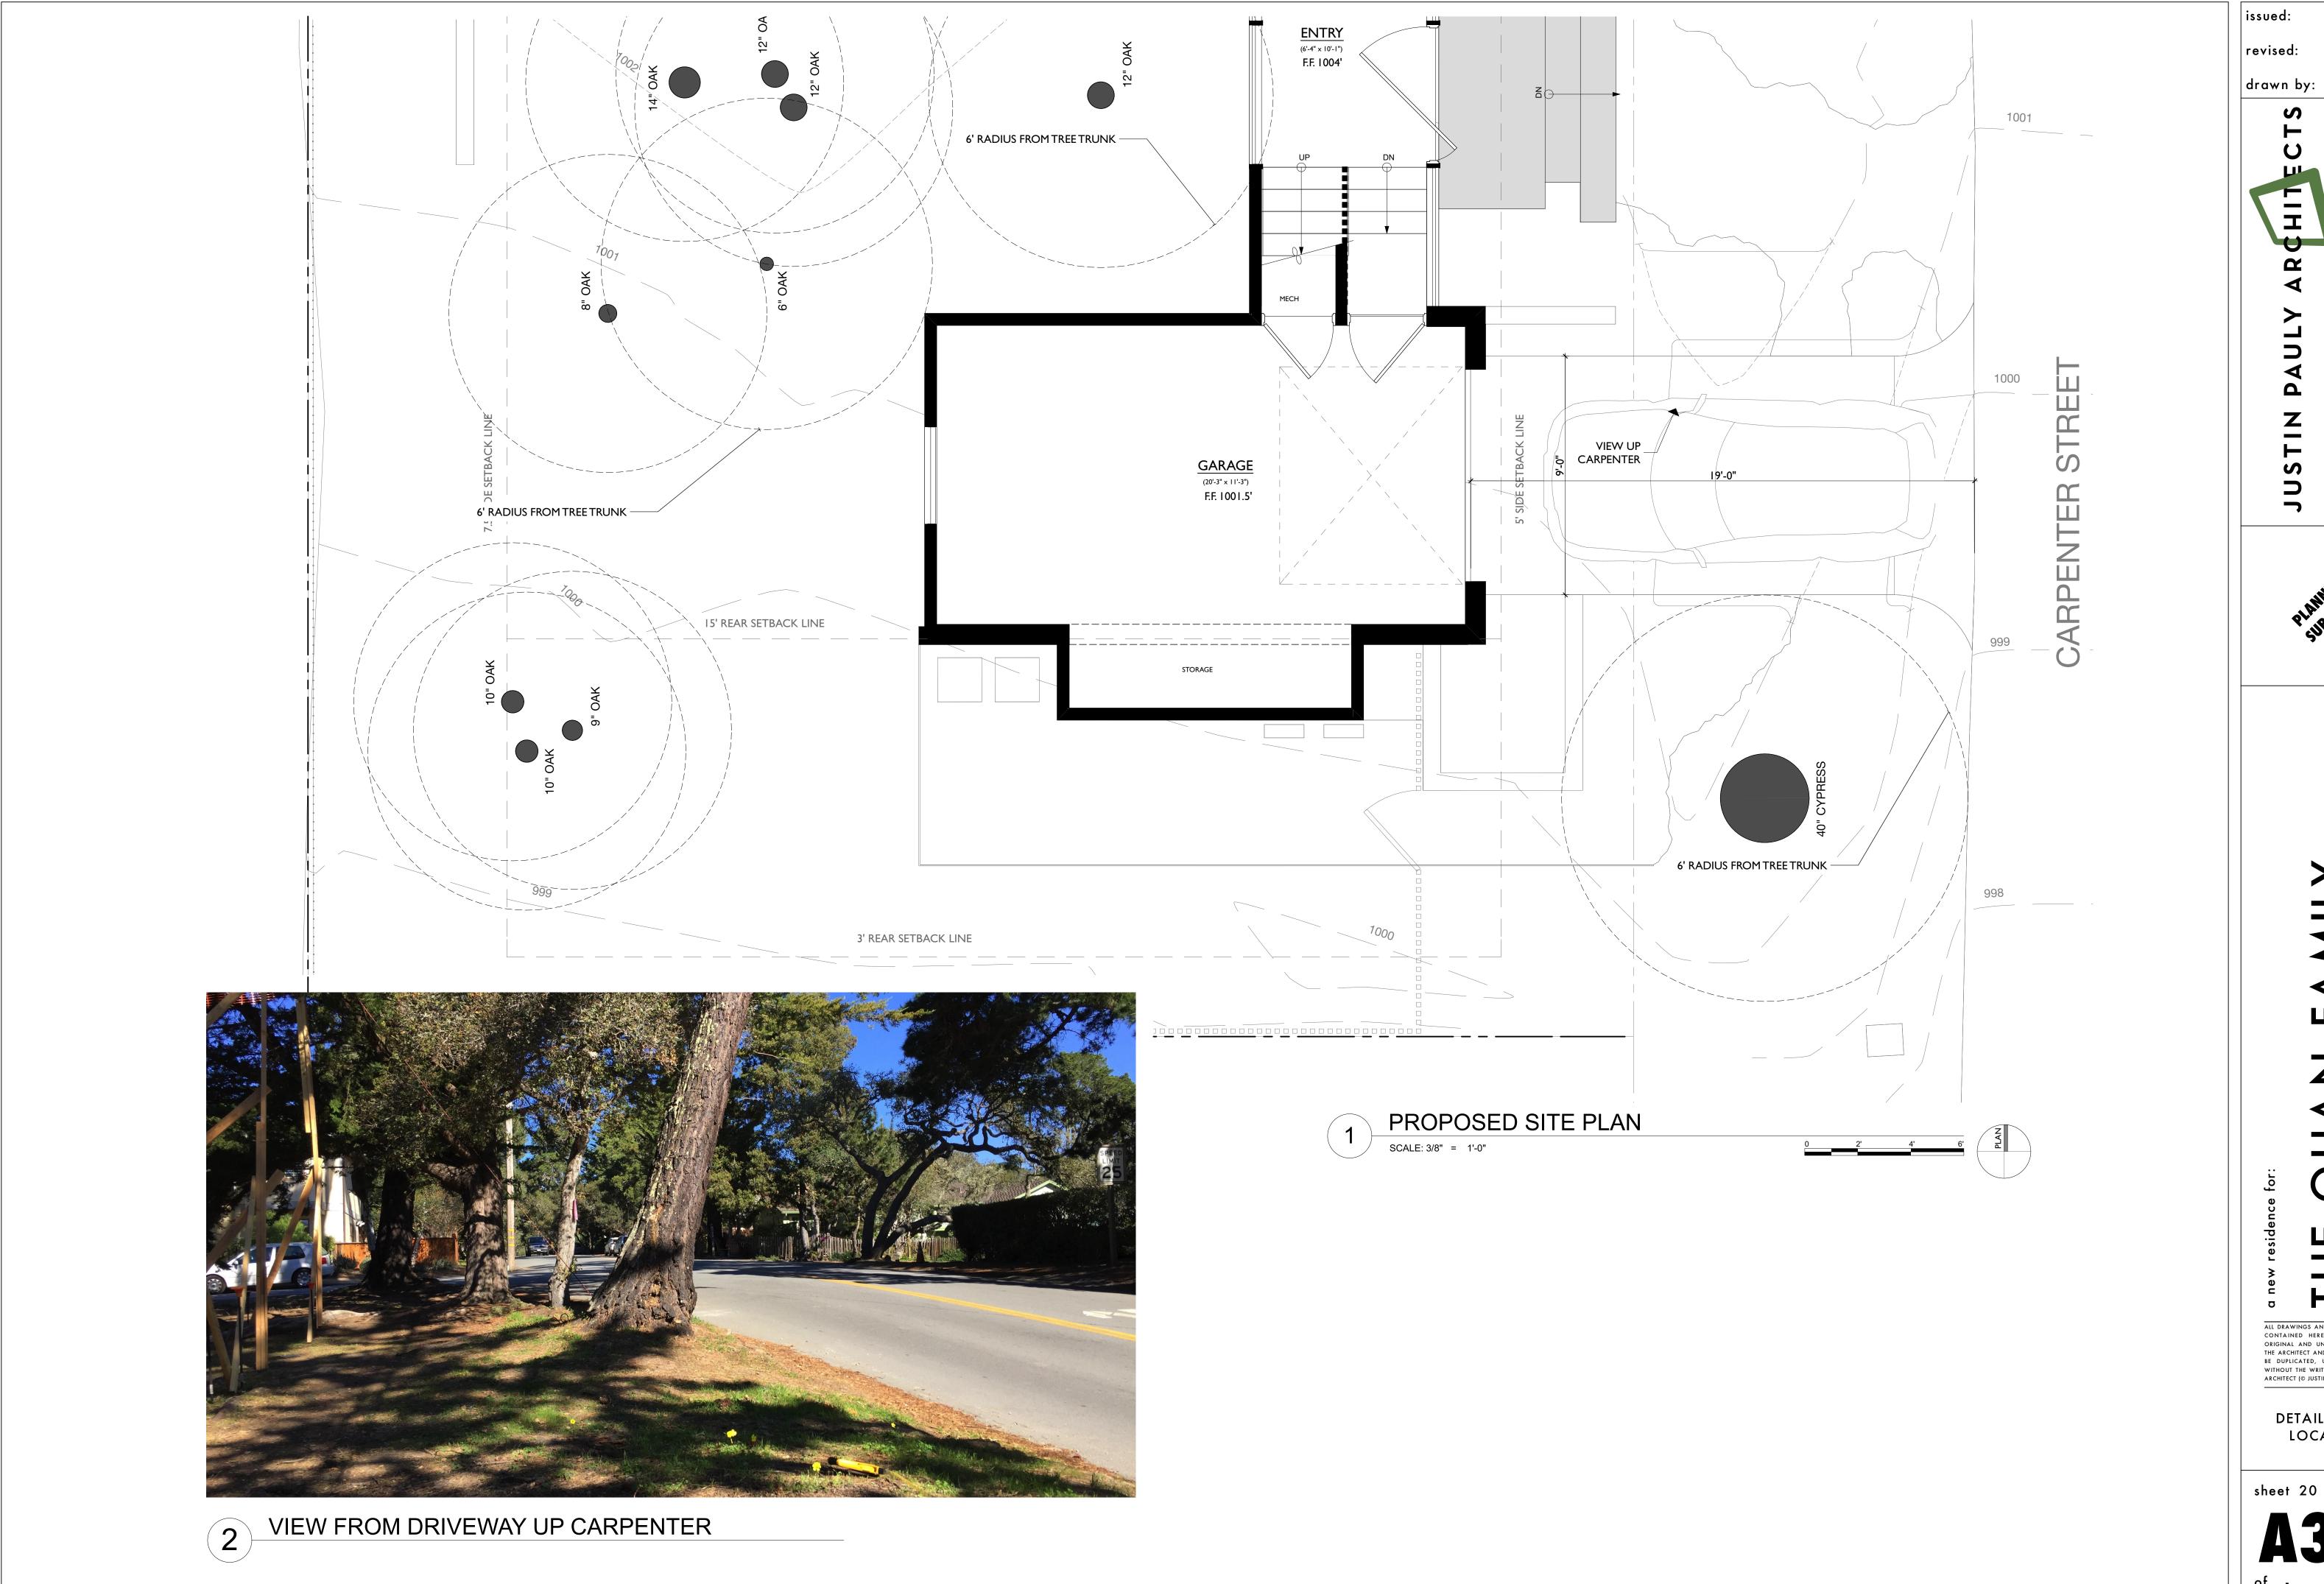
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EXISTING & PROPOSED STREET ELEVATIONS (6TH AVENUE)

sheet 18







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DETAILED TREE LOCATION





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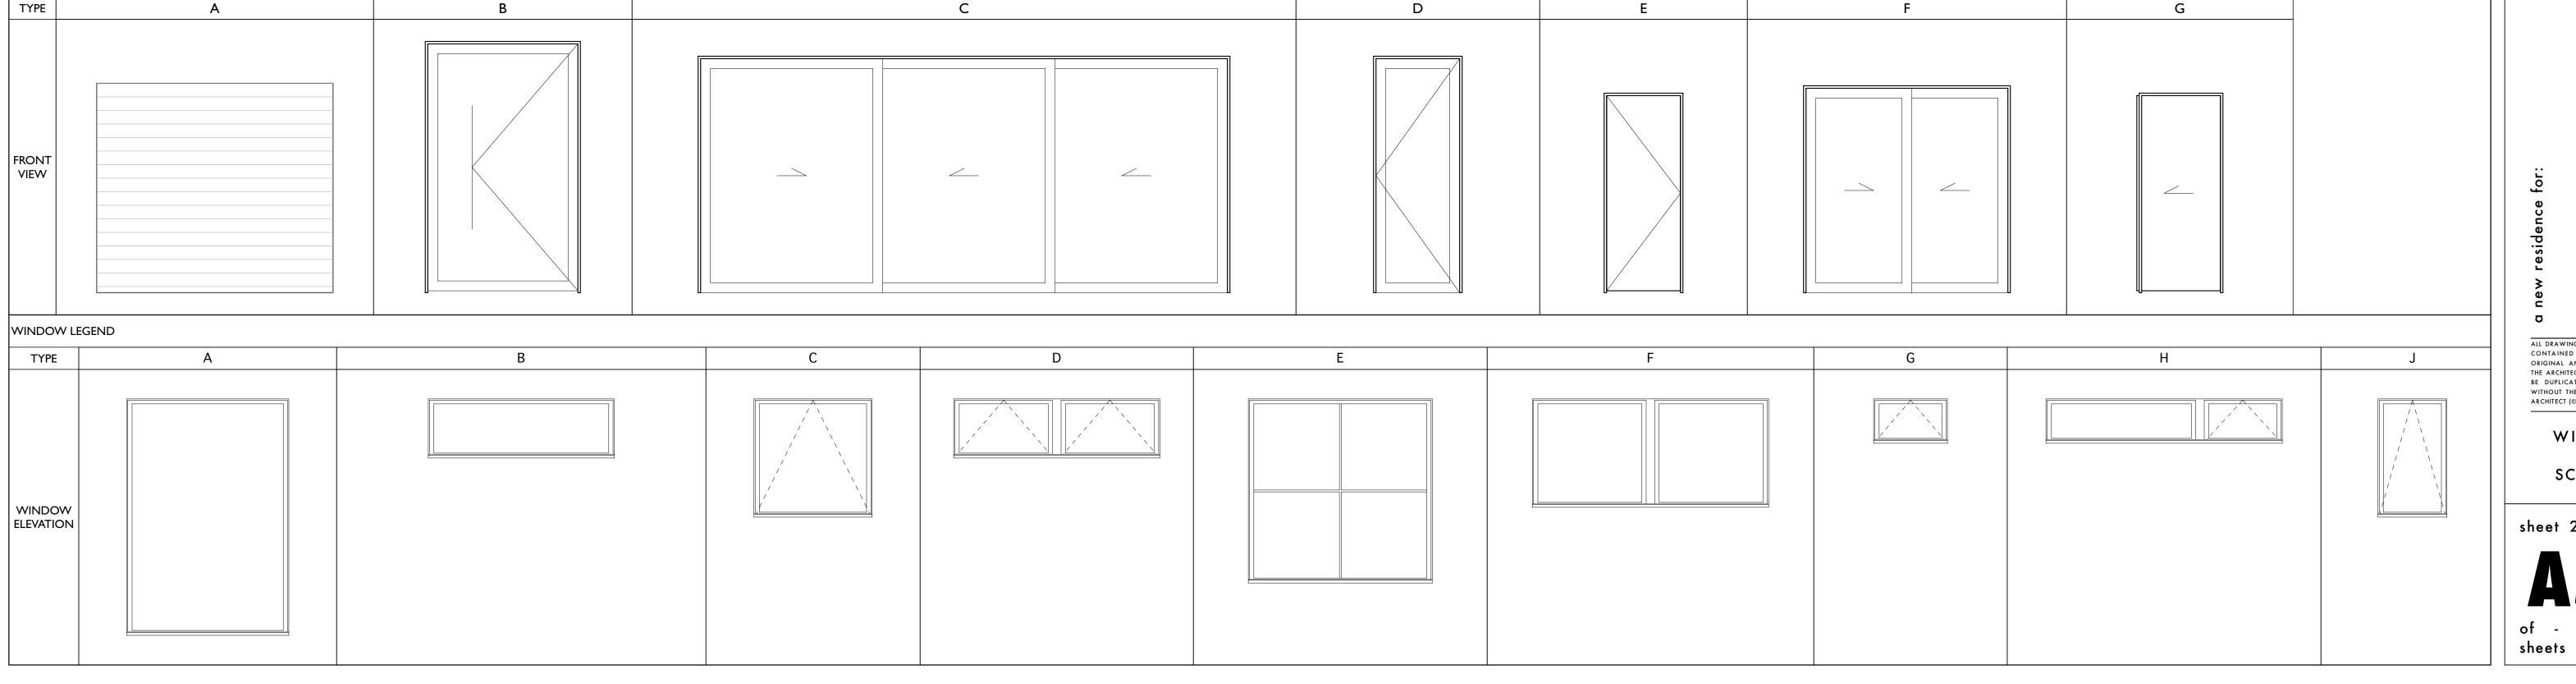
BUILDING SECTIONS

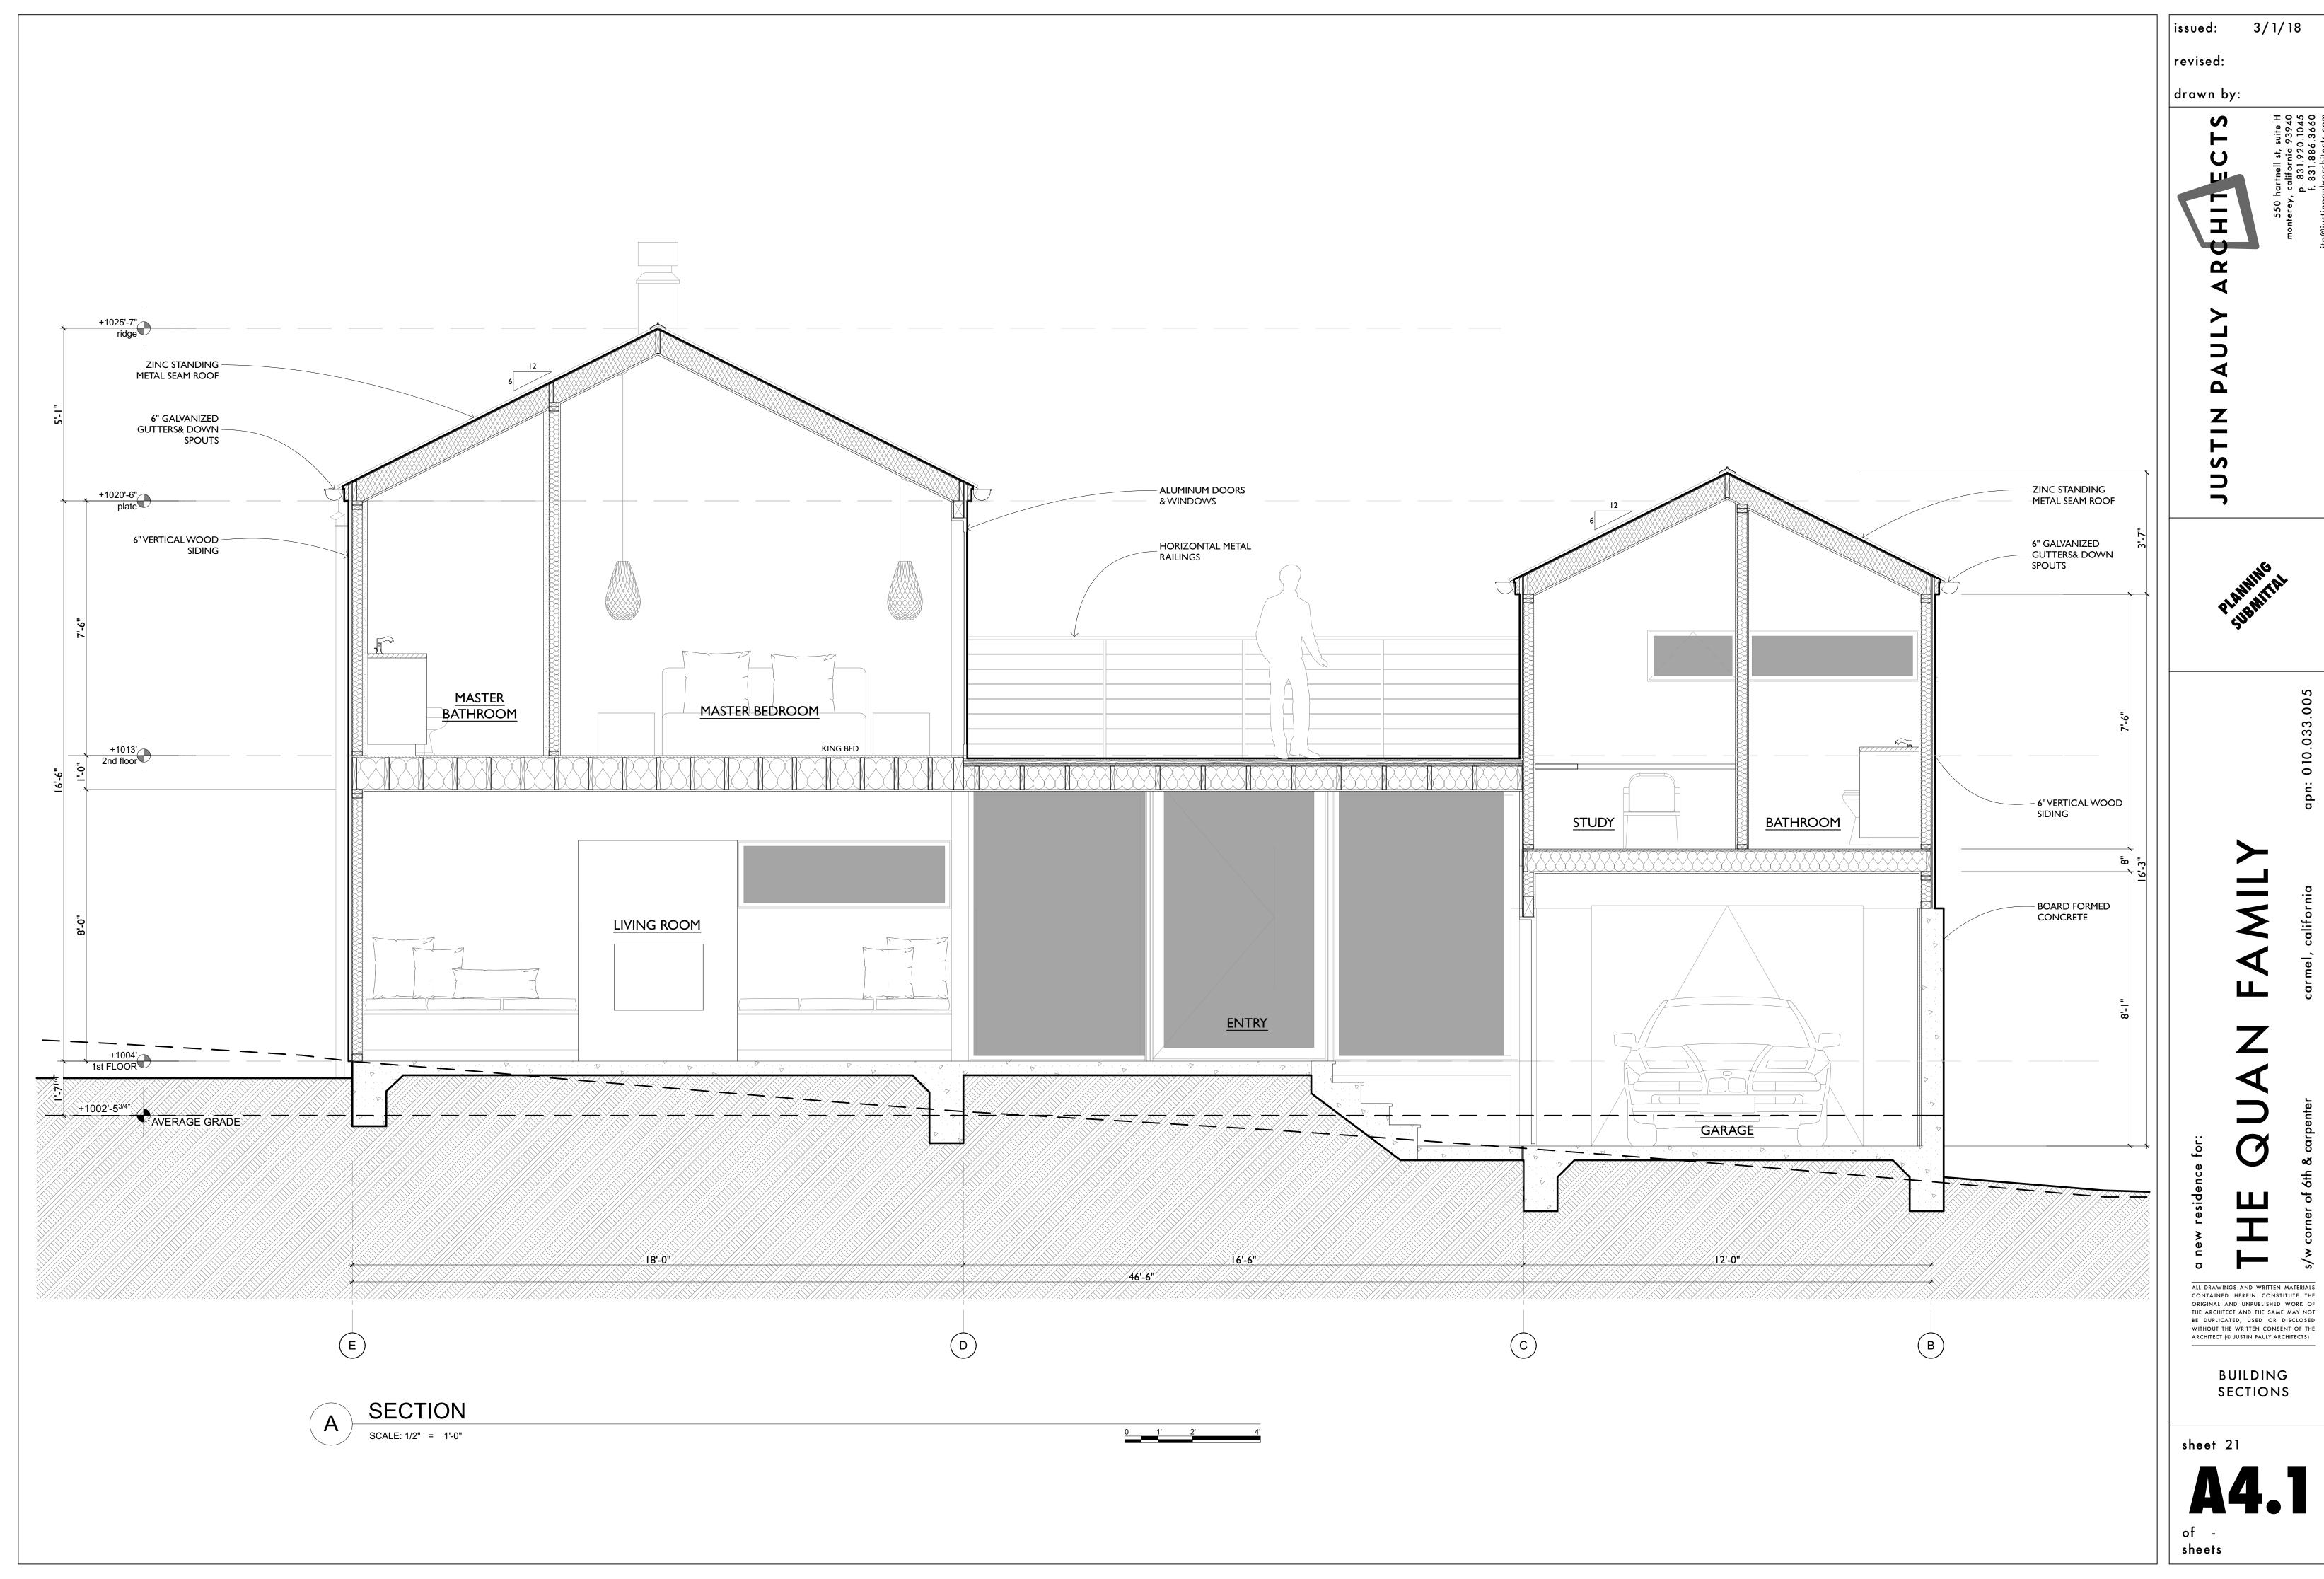				EXTERIOR D	OOR SCHEDULE								WINDOW S	CHEDULE	
IARK WIDTH	DETAILS HARDWARE	MARK	SIZE		l l			SHADE	HEAD	NOTES					
ARK   WIDTH	HEIGHT	TYPE	TEMP'D HEAD	JAMB SILL	GROUP	NOTES	MARK	WIDTH	HEIGHT	TYPE	TEMPERED	SCREEN	SHADE	HEIGHT	NOTES
8'-0"	7'-0"						01	5'-6"	8'-0"	Α				8'-0"	
D01		Α					02	5'-3"	8'-0"	Α				8'-0"	
D02 5'-1"	8'-4"	В					03	6'-3 1/2"	2'-0"	В				6'-6"	
D03   17'-10"	7'-11"	С					04	4'-0"	4'-0"	С				8'-1"	
D04 2'-10"	7'-11"	D					05	6'-12"	2'-0"	D				6'-6"	
							06	6'-3"	6'-3"	E				10'-8"	
				INTERIOR D	OOR SCHEDULE		07	4'-9"	8'-0"	Α				8'-0"	
	1	1 1			T T		08	5'-3"	8'-0"	Α				8'-0"	
ARK WIDTH	HEIGHT	TEMP'D	TYPE	DETAILS	HARDWARE		09	5'-3"	8'-0"	Α				8'-0"	
			HEAD	JAMB SILL	GROUP		10	3'-8"	3'-8"	С				2'-1"	
005 2'-7 1/2"	6'-7"		E				21	2'-4"	4'-0"	J				7'-0"	
D06 2'-10"	6'-7"		F				22	2'-4"	4'-0"	J				7'-0"	
D07 I'-9 I/2"	6'-7"		E				23	2'-4"	4'-0"	J				7'-0"	
DII 2'-8"	6'-7"		G				24	4'-0"	4'-0"	С				8'-6"	
D12 2'-6"	6'-7"		E				25	4'-0"	4'-0"	С				7'-0"	
D13 2'-6"	6'-7"		Е				26	3'-8"	3'-8"	С				8'-5"	
D14 2'-8"	6'-7"		Н				27	8'-0"	3'-8"	F				0'-10"	
DI5 2'-8"	6'-7"		G				28	2'-6"	1'-6"	G				1'-1"	
+	6'-7"		Н				29	8'-0"	1'-6"	Н				8'-2 1/2"	

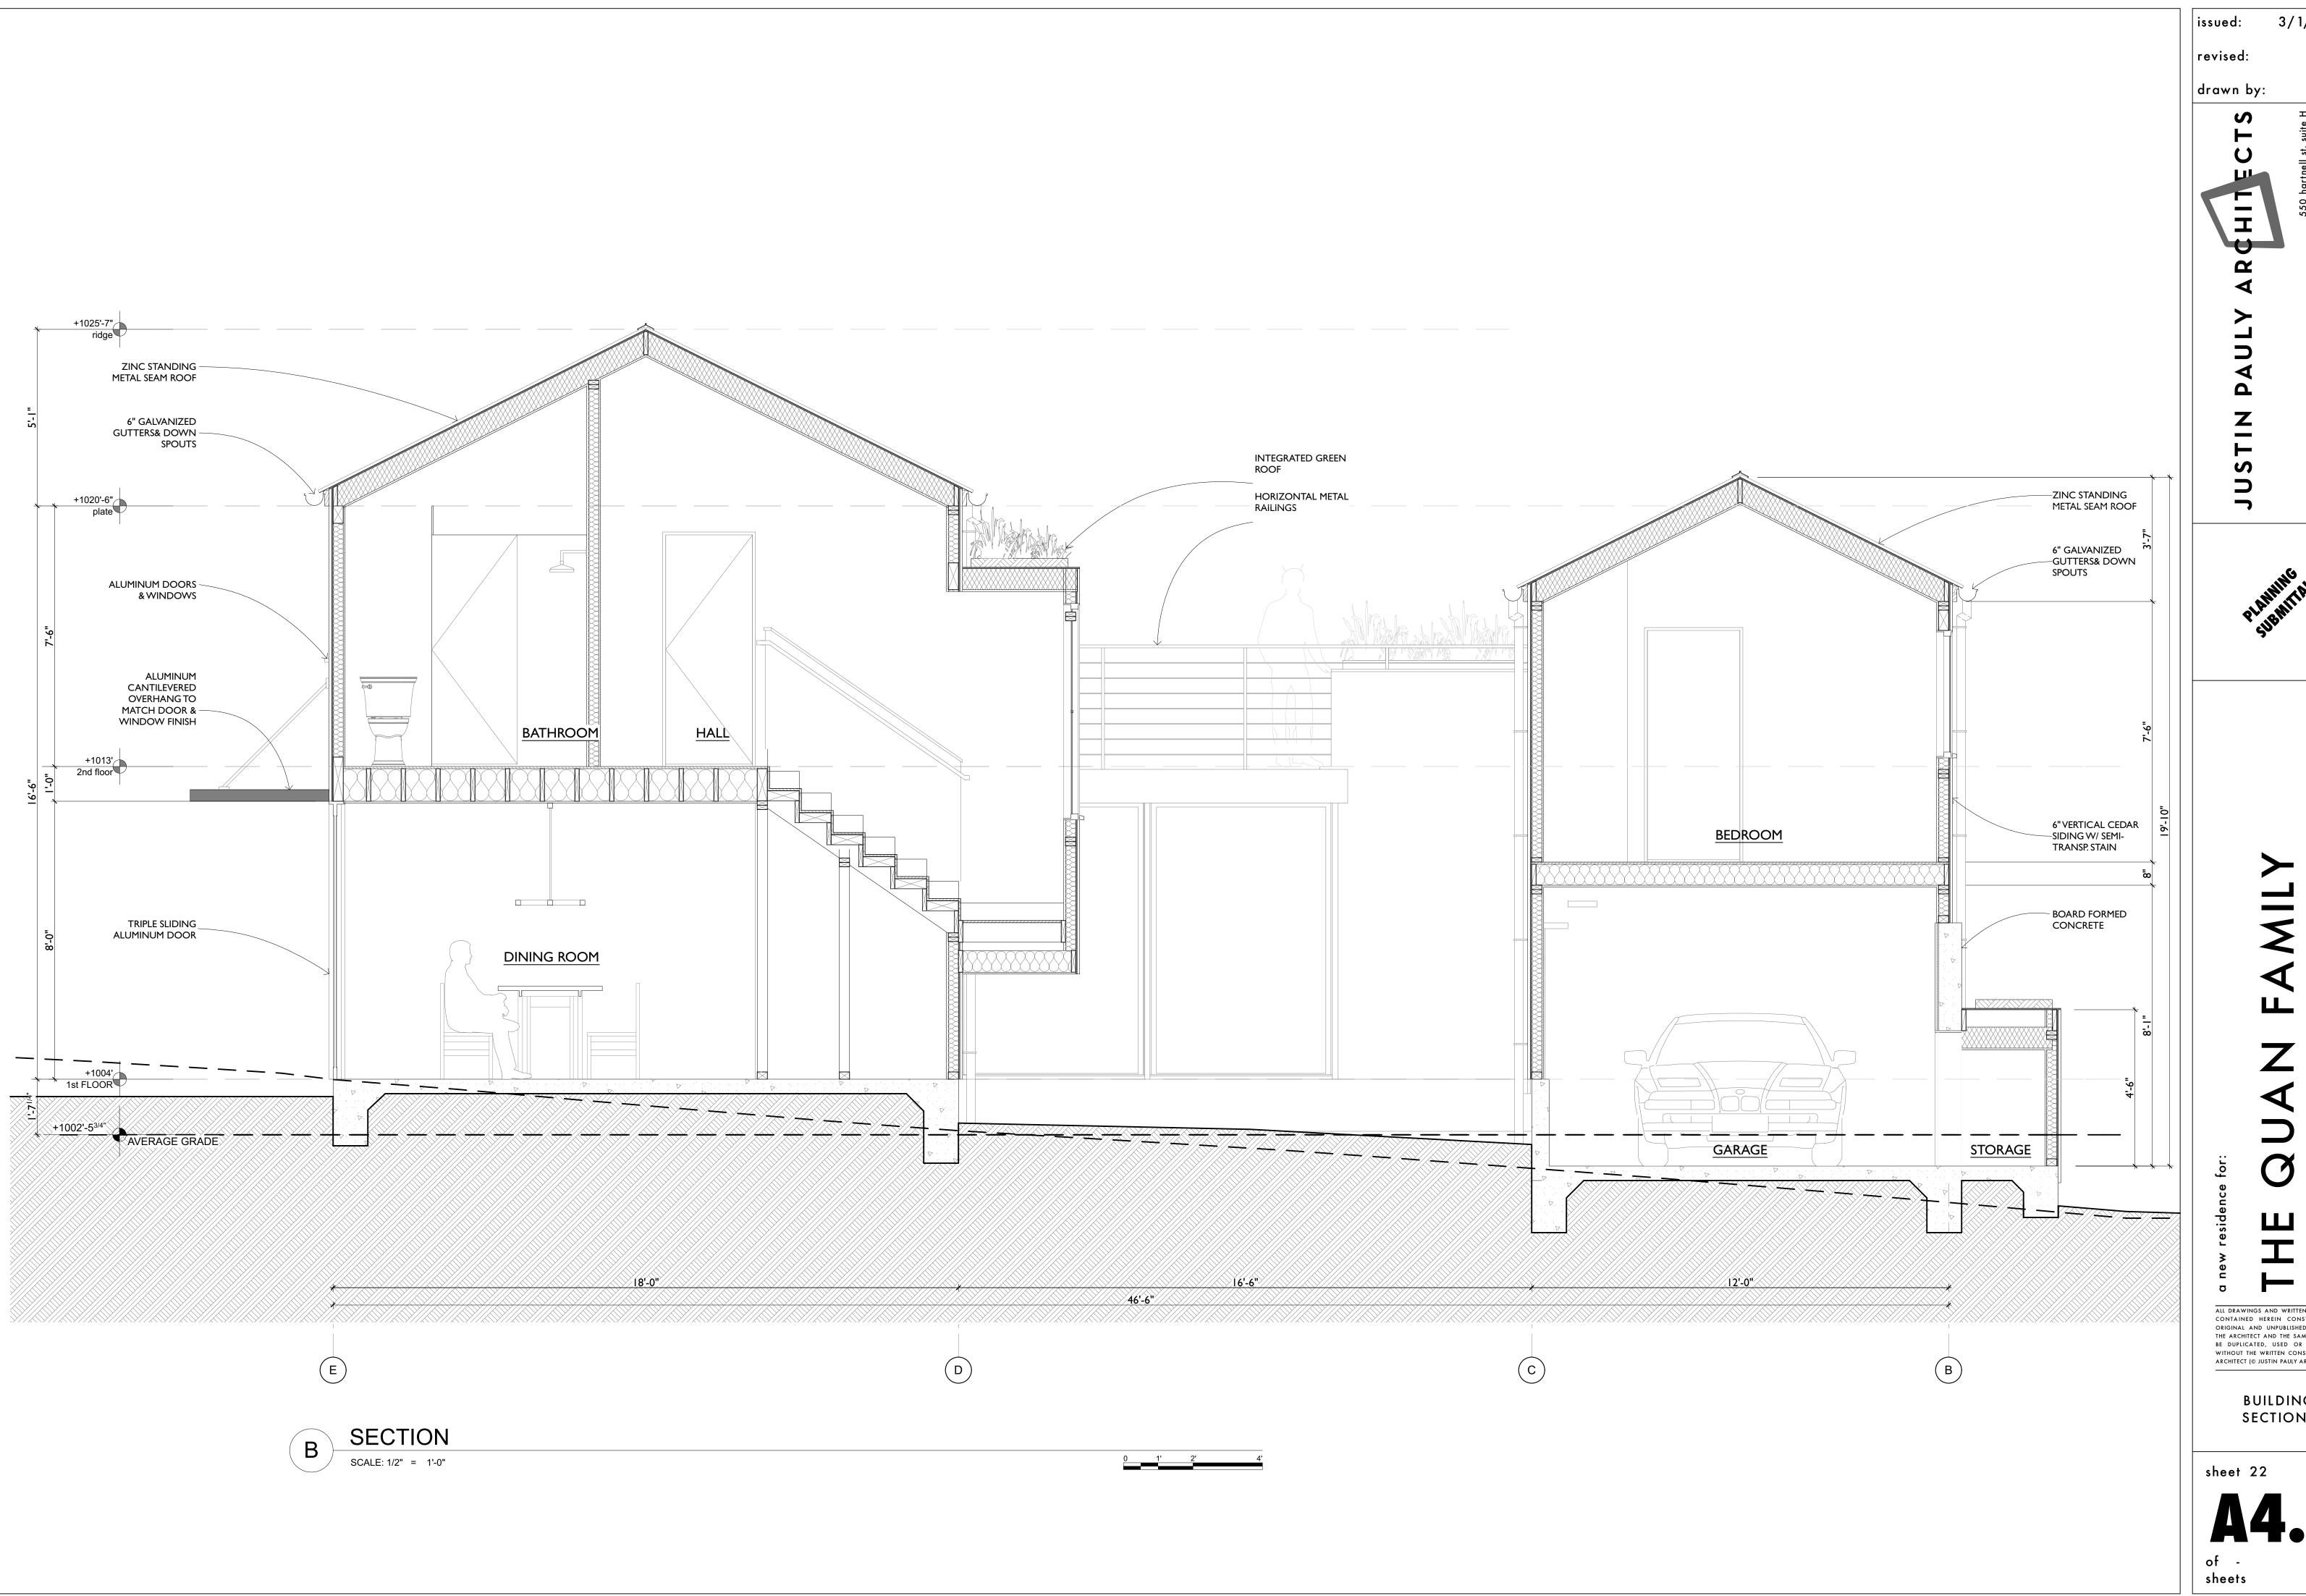DOOR LEGEND

6. GLAZING TO BE LOW E<sup>2.</sup>, CONTRACTOR TO PROVIDE GLAZING SAMPLES PROIR TO ORDERING FENESTRATION

7. SEE GENERAL NOTE #16 ON SHEET A0.1 FOR EGRESS WINDOW REQUIREMENTS



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WINDOW & DOOR SCHEDULES