### PROJECT ABBREVIATIONS

ANW	AWNING	MAX MIN	MAXIMUM MINIMUM
BLD'G BLK BM	BUILDING BLOCK, BLOCKING, BLOCKS BEAM, BEAMS	(N) N/C	NEW NO CHANGE
BOT CEIL'G	BOTTOM CEILING	PL PW	PLATE PLYWOOD
CJ CL'G CLR	CEILING JOIST CEILING CLEAR	PLYWD RCP	PLYWOOD  REFLECTED CEILING PLAN
CLST CMU CONC	CLOSET CONCRETE MASONRY UNITS	REF REINF RF	REFERENCE
CONT CSMT	CONTINUOUS CASEMENT	REQ'D REQM'T	REQUIRED REQUIREMENT
CTR DBL	DOUBLE	RFT RR RS	RAFTER ROOF RAFTER RISER
DIFF DR DS	DIFFERENCE DOOR (S) DOWNSPOUT	o/ o/c	OVER ON CENTER
FIN FLR	FINISH FLOOR	SECT SF	SECTION SQUARE FEET
EA ELEC	EACH ELECTRICAL	SHT SHT'G SIM	SHEET SHEATHING SIMILAR
ELEV EQ EXTER	ELEVATION (S) EQUAL EXTERIOR	SIN SLD SQ	SINGLE SLIDER SQUARE
(E) FAU	EXISTING FORCED AIR UNIT	ST'L	SPECIFICATION STEEL STAINLESS STEEL
FLR FJ	FLOOR FLOOR JOIST		STRUCTURAL  TO BE DECIDED
FOOT'G FR	FRENCH	THK (NS) TP	THICK (THICKNESS) TOP PLATE
FT FT'G	FOOT or FEET FOOTING	TRD TYP	TREAD TYPICAL
GB GRD GYP BRD	GYPSUM BOARD GRADE GYPSUM BOARD	U.N.O. VERT	UNLESS NOTED OTHERWISE VERTICAL
INTER	INTERIOR	w/ w/o	WITH WITHOUT
HGT HRD	HEIGHT HARD	WD WHT	WOOD WEIGHT
HOZ HTR	HORIZONTAL HEATER	WIND WND WTR	WINDOW WINDOW WATER
JST MFG	JOIST MANUFACTURER	₽ <sup>©</sup>	CENTER LINE PROPERTY LINE
MECH	MECHANICAL	. ±	PLUS or MINUS DEGREE (S)
LF LT	LEAF LIGHT	Ø	DIAMETER

### CONSULTANT LIST

ARCHITECTURE:

STERLING + HUDDLESON P.O. BOX 221092 CARMEL, CA 93922 831.624.4363

SOILS ENGINEER:

SOIL SURVEYS GROUP 103 Church Street Salinas, CA 93103 TEL: 831 757-2172

SURVEYOR/ CIVIL ENGÍNEER:

> L & S ENGINEERING 2640 Garden Road Suite G Monterey, CA 93940 TEL: 831 655-2733

# FIVE SAND & SEA

5 SAND & SEA, CARMEL-BY-THE-SEA, CA A.P.N. 010-321-025

PROJECT DESCRIPTION	PROJECT DATA		
CONSTRUCTION OF NEW 2-STORY SINGLE FAMILY RESIDENCE TO REPLACE EXISTING 1659 S.F. RESIDENCE.	OWNER:  NORTHPOINT INVESTMENTS P.O. BOX 470577 SAN FRANCISCO, CA 94147	SITE ADDRESS:  FIVE SAND & SEA  CARMEL-BY-THE-SEA, CA	

### **ZONING DATA**

ZONING:	R-1
DESCRIPTION OF USE:	SINGLE FAMILY RESIDENTIAL
TYPE OF CONSTRUCTION:	TYPE V-N
STORIES:	2
HEIGHT LIMIT:	18 FT
TREES:	NO REMOVAL
PARKING:	REQUIRED PROVIDED
GRADING:	CUT: 500 C.Y. APPROX. FILL: 200 C.Y. APPROX.
WATER PROVIDER:	CAL-AM
SEWER PROVIDER:	CAWD


### PROJECT NOTES

- 1. THIS PROJECT SHALL COMPLY WITH TITLE 24 AND 2016 CALIFORNIA RESIDENTIAL CODE (CRC), 2016 CALIFORNIA MECHANICAL CODE (CMC), 2016 CALIFORNIA PLUMBING CODE (CPC), 2016 CALIFORNIA ELECTRICAL CODE (CEC) CALIFORNIA ENERGY CODE (CENC).
- 2. CONSTRUCTION WASTE MANAGEMENT: RECYCLE AND/OR SALVAGE FOR REUSE A MINIMUM OF 50 PERCENT OF THE NONHAZARDOUS CONSTRUCTION AND DEMOLITION WASTE IN ACCORDANCE WITH THE CALIFORNIA GREEN BUILDING CODE, CHAPTER 4, DIVISION 4.4.
- 3. PRIOR TO BUILDING PERMIT FINAL APPROVAL, THE PROPERTY SHALL BE IN COMPLIANCE WITH THE VEGETATION MANAGEMENT REQUIREMENTS PRESCRIBED IN CALIFORNIA FIRE CODE SECTION 4906, INCLUDING CALIFORNIA PUBLIC RESOURCES CODE 4291 OR CALIFORNIA GOVERNMENT CODE SECTION 51182 PER CRC R327.1.5.

SQUARE FOOTAGE ANALYSIS

LOT SIZE	8928	S.F
ALLOWABLE BASE FLOOR AREA	3136	S.F
MAX ALLOWABLE BONUS AREA	1045	S.F
FLOOR AREA TABULATION:		
MAIN LEVEL	1750	S.F.
LOWER LEVEL	1181	S.F.
TOTAL BASE FLOOR	2931	S.F.
TOTAL ALLOWABLE BASEMENT AREA		
$[(3136-2931)\times2] = 410 \text{ S.F.}$ GARAGE & STORAGE (BASEMENT AREA)	410	SF
BASEMENT BONUS AREA	100	
TOTAL FLOOR AREA	3431	S.F
SITE COVERAGE TABULATION (ALL IMPERVIO	US):	
UPPER TERRACES (NOT OVER LOWER LEVE	L) 275	S.F.
DECK	202	S.F.
ENTRY STEPS + LANDING	129	S.F.
TOTAL SITE COVERAGE	606	S.F.
ALLOWABLE SITE COVERAGE (.22 X 3136)*	690	S.F.
EXISTING SITE COVERAGE TO BE REMOVED	(1598	S.F.
CHANGE IN SITE COVERAGE	(992	S.F.
ADDITIONAL ADDITION NOT COUNTED IN TABLE	ATIONS	
ADDITIONAL AREAS NOT COUNTED IN TABUL	07	S.F.
MECHANICAL (LESS THAN 5' CEILING)	87	

### **VICINITY MAP**

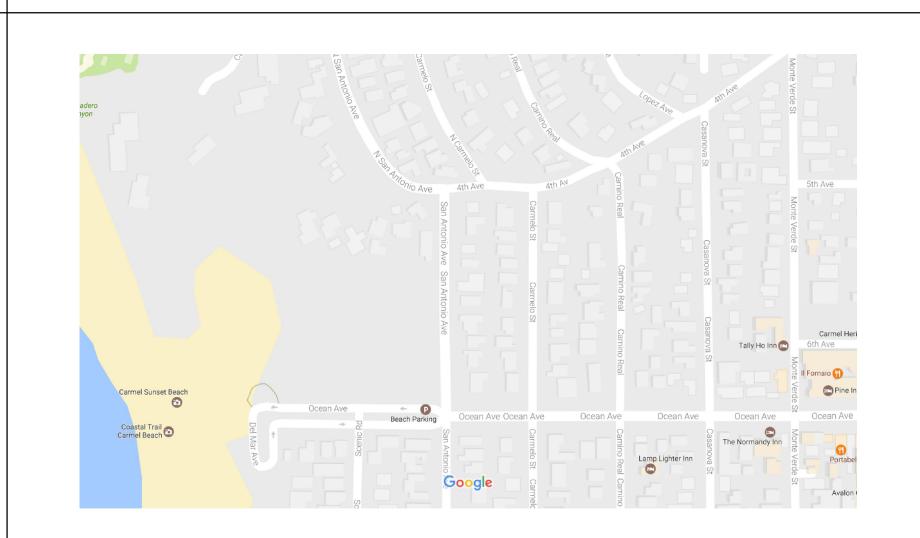

### SHEET INDEX

T1.0 TITLE SHEET

SITE SURVEY

SITE OVERLAY PROPOSED SITE PLAN

CONSTRUCTION MANAGEMENT PLAN

SITE DEMOLITION

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MAIN FLOOR PLAN A2.2 LOWER FLOOR PLAN

SITE SECTIONS

**EXTERIOR ELEVATIONS EXTERIOR ELEVATIONS** 

**EXTERIOR MATERIALS** 

L1.0 LANDSCAPE PLAN

L2.0 EXTERIOR LIGHTING PLAN

A3.1 ROOF PLAN

**EXTERIOR ELEVATIONS** BEACHSCAPE ELEVATION

Prepared by:

SAND

FIVE

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Action:


09.17.18 PRELIM. PLANNING 02.11.19 TRACK 2 PLANNING


Date: 05.11.17

Description: TITLE SHEET

T-1.0

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NOTES:
1. BOUNDARY LOCATIONS SHOWN HEREON WERE DETERMINED WITH THE BENEFIT OF A FIELD SURVEY SUPPLEMENTED BY RECORD DATA AND A TITLE REPORT DATED DECEMBER 29, 2016. ALL BOUNDARY DATA SHOWN HEREON ARE FROM THE RECORDS.

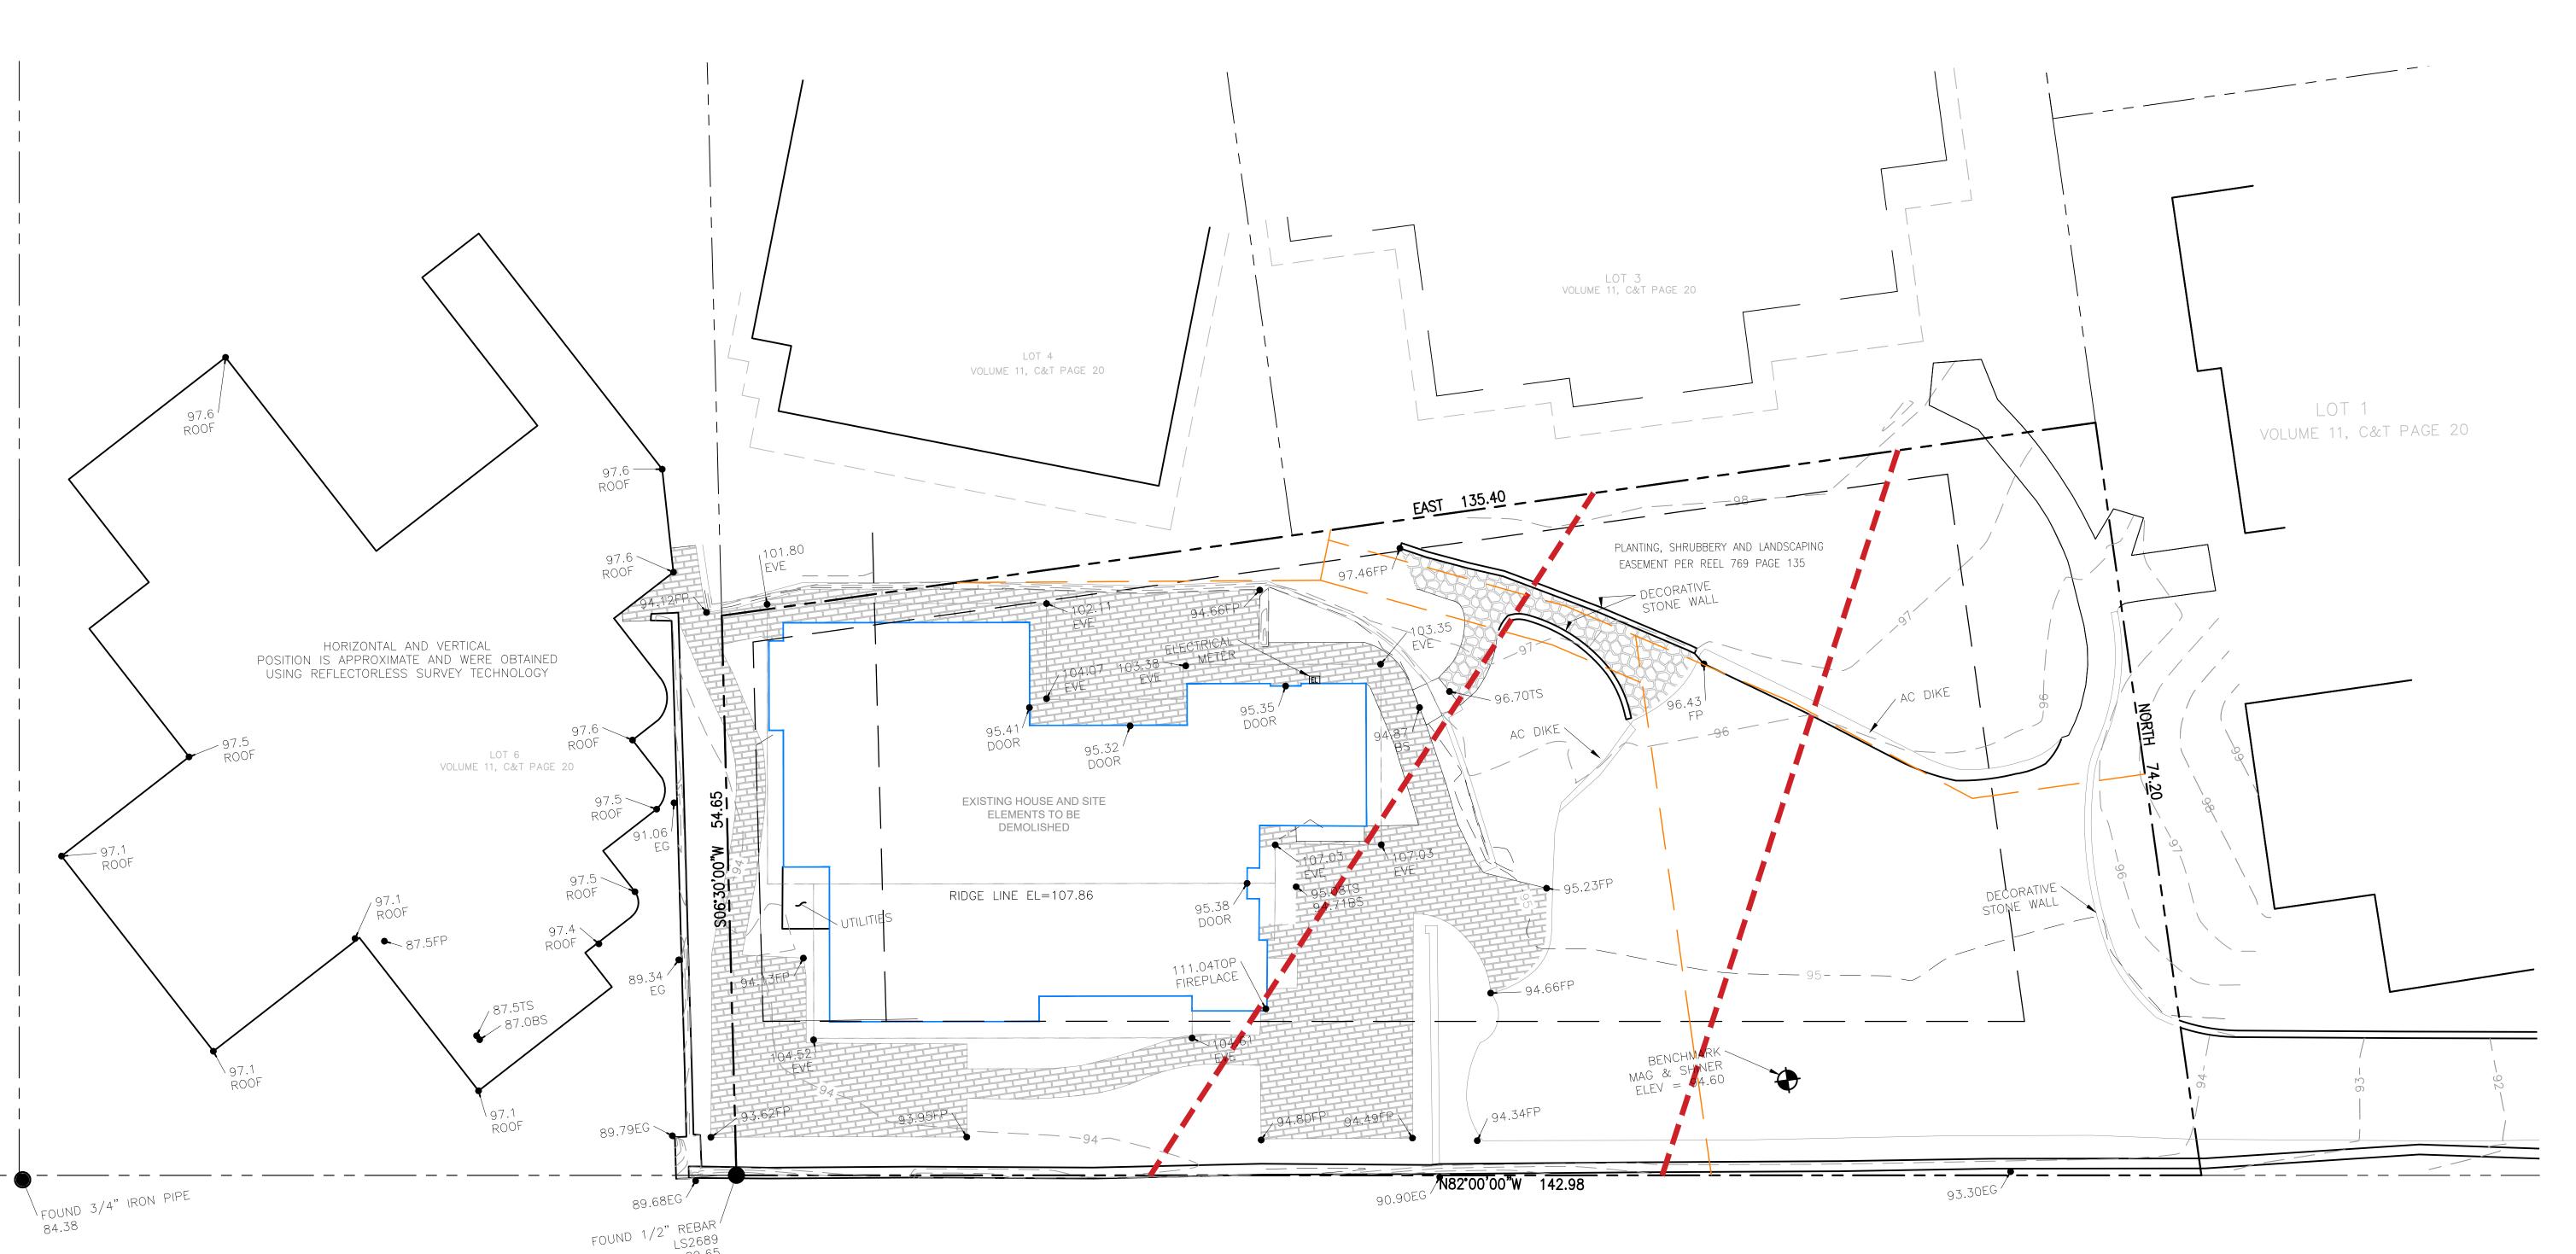3. DISTANCES SHOWN ARE EXPRESSED IN FEET AND DECIMALS THEREOF.

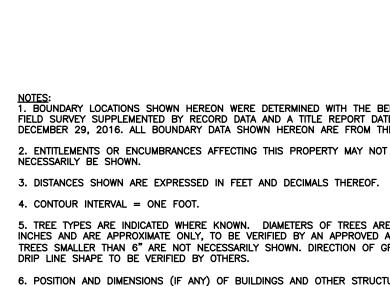5. TREE TYPES ARE INDICATED WHERE KNOWN. DIAMETERS OF TREES ARE SHOWN IN INCHES AND ARE APPROXIMATE ONLY, TO BE VERIFIED BY AN APPROVED ARBORIST.
TREES SMALLER THAN 6" ARE NOT NECESSARILY SHOWN. DIRECTION OF GROWTH AND DRIP LINE SHAPE TO BE VERIFIED BY OTHERS.

6. POSITION AND DIMENSIONS (IF ANY) OF BUILDINGS AND OTHER STRUCTURES ARE SHOWN HEREON APPROXIMATE ONLY DUE TO MEASUREMENT LIMITATIONS, IRREGULAR SHAPE OF BRICK FACING, POP-OUTS, BULL NOSE CORNERS, ETC. 7. NOT ALL UTILITY BOXES AND/OR UTILITY STRUCTURES ARE SHOWN INCLUDING BUT NOT LIMITED TO HOSE BIBS AND IRRIGATION VALVES. ONLY THE VISIBLE UTILITY BOXES AND/OR UTILITY STRUCTURES THAT WERE CONSIDERED TO CONVEY THE GENERAL UTILITY CONDITIONS ARE SHOWN.

8. A LOCAL BENCHMARK FOR THIS PROJECT IS A SET MAG & SHINER IN THE DRIVEWAY AS SHOWN HEREON, HAVING AN ELEVATION OF 94.60, ESTABLISHED BY SURVEYOR JON HAGEMEYER AND BASED UPON MEAN SEA LEVEL.

SITE SURVEY

PROPERTY LINE BUILDING OVERHANG MAJOR CONTOUR

WOOD FENCE

LEGEND

\_\_\_ \_\_\_ \_\_ \_\_ \_\_ \_\_ \_\_ MINOR CONTOUR

ASPHALT BOTTOM OF STAIRS CYPRESS TREE

EXISTING
EXISTING GROUND
ELEVATION
FINISH PAVEMENT
FACE OF WALL
OAK TREE
PINE TREE
TREE
TOP OF STAIRS
TYPICAL

95.00 **→ SPOT ELEVATION** 

SCALE: 1/8"=1'-0"

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Action:

Date: 12.06.17

Scale: 1/8"=1'-0" Drawn:

Description:

SURVEY Sheet No:



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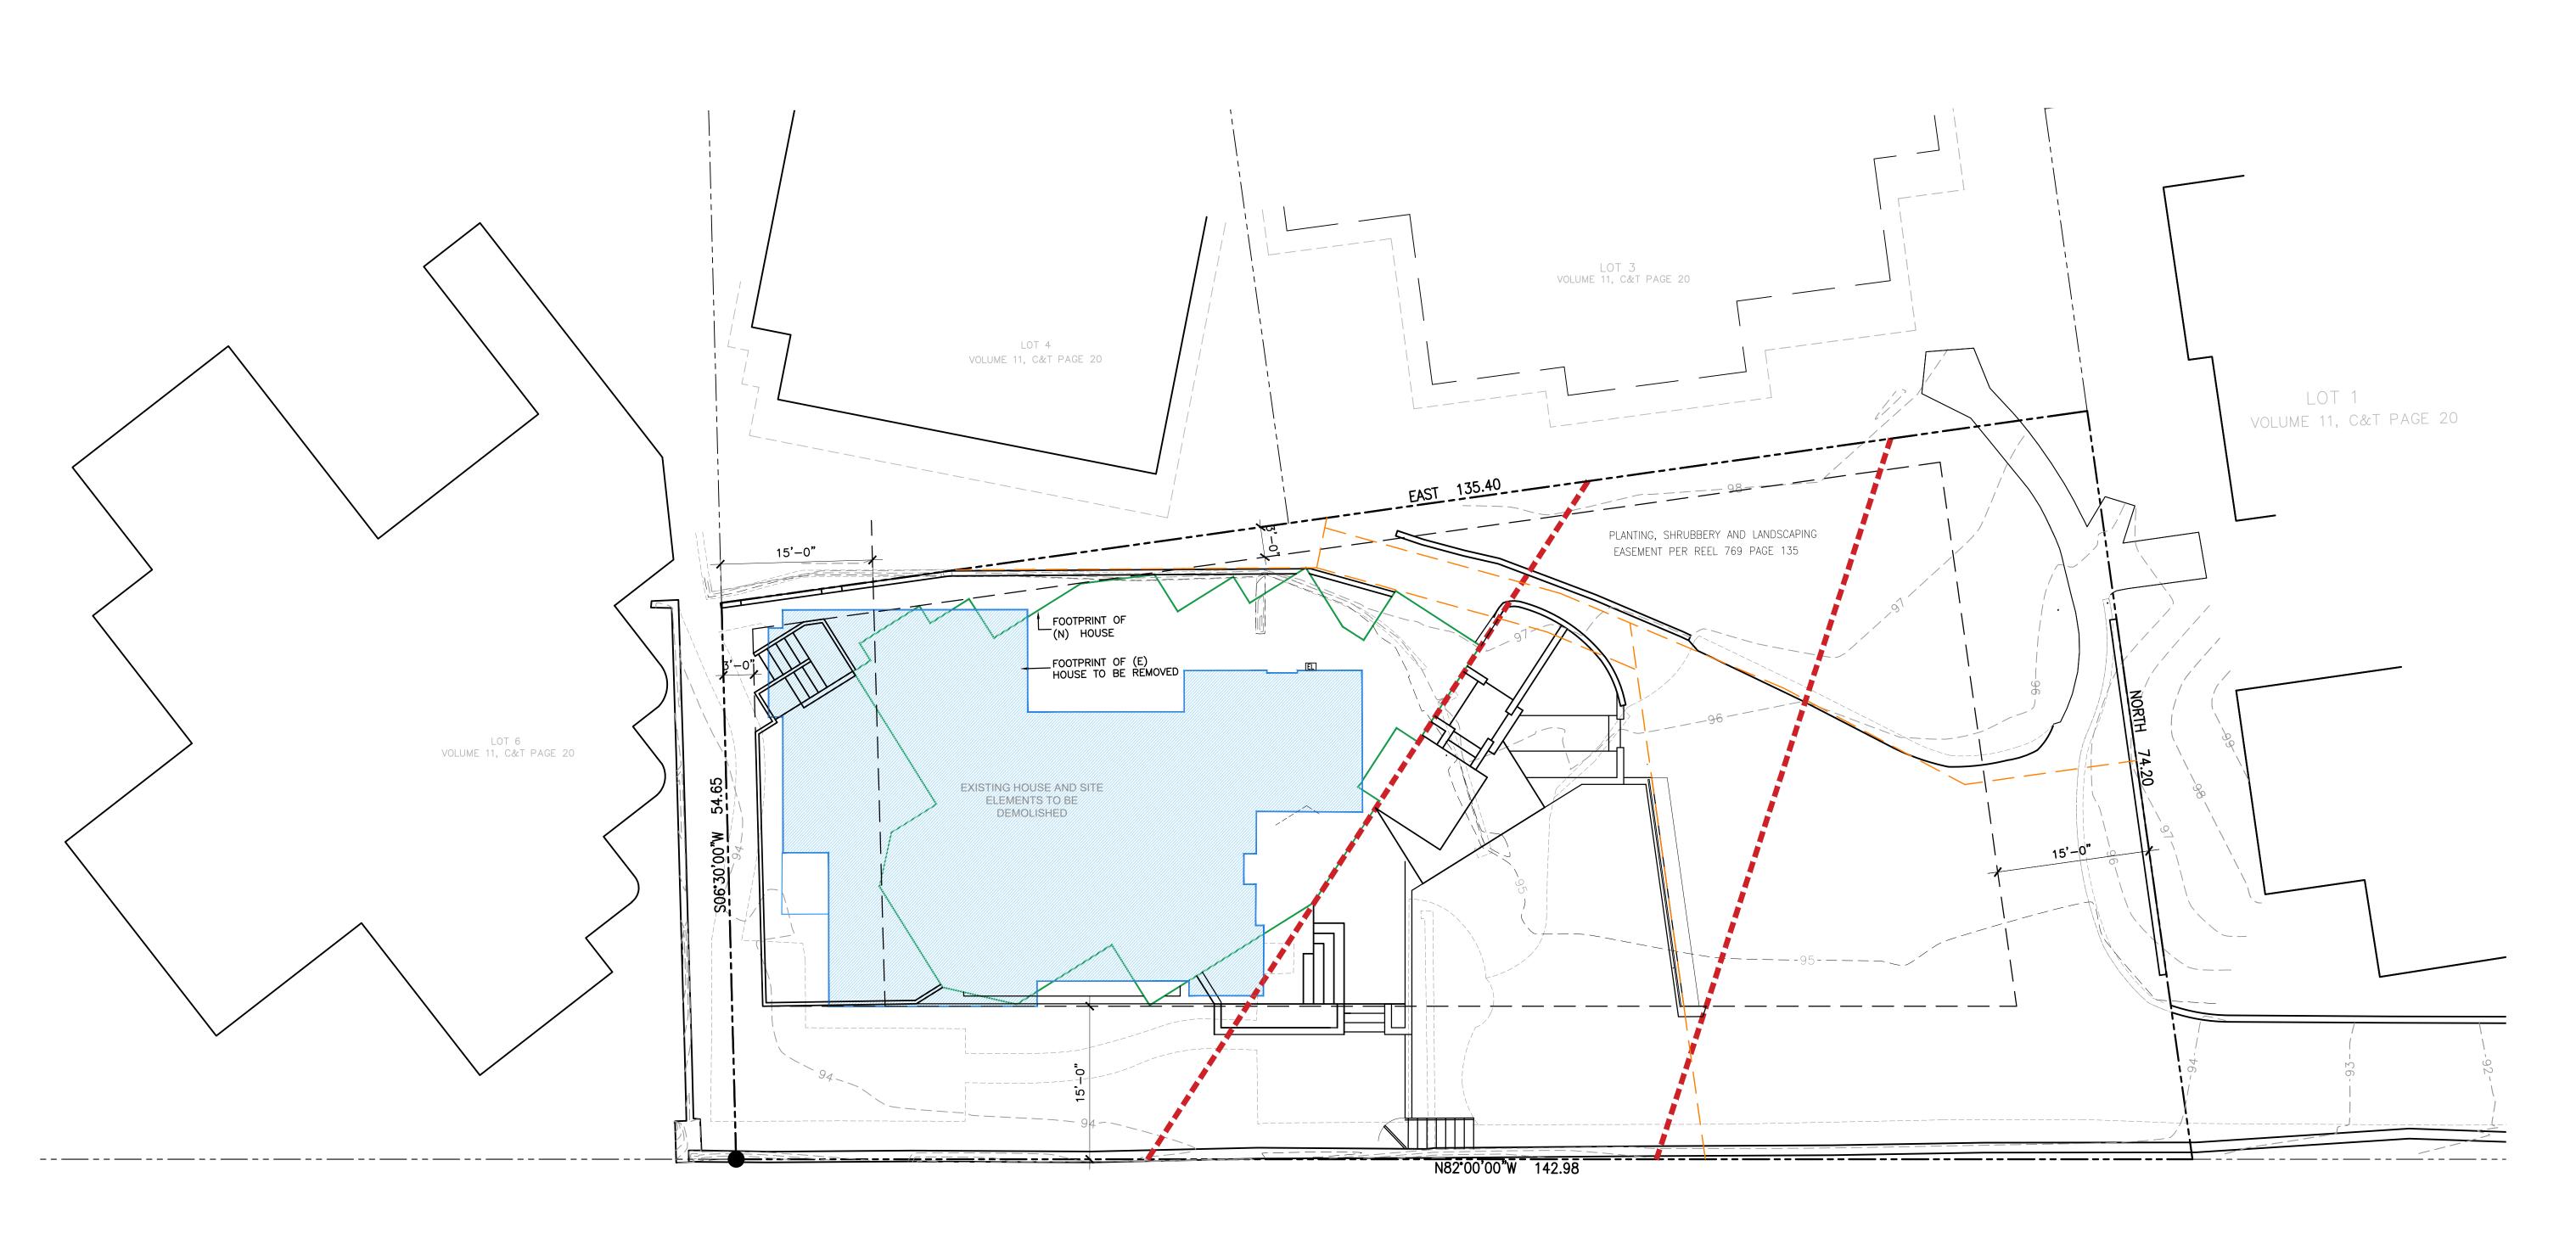
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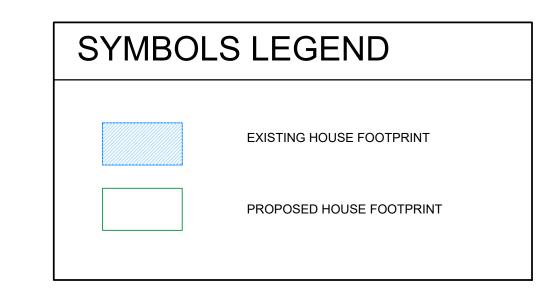
Description: SITE OVERLAY

Sheet No:

SCALE: 1/8"=1'-0"









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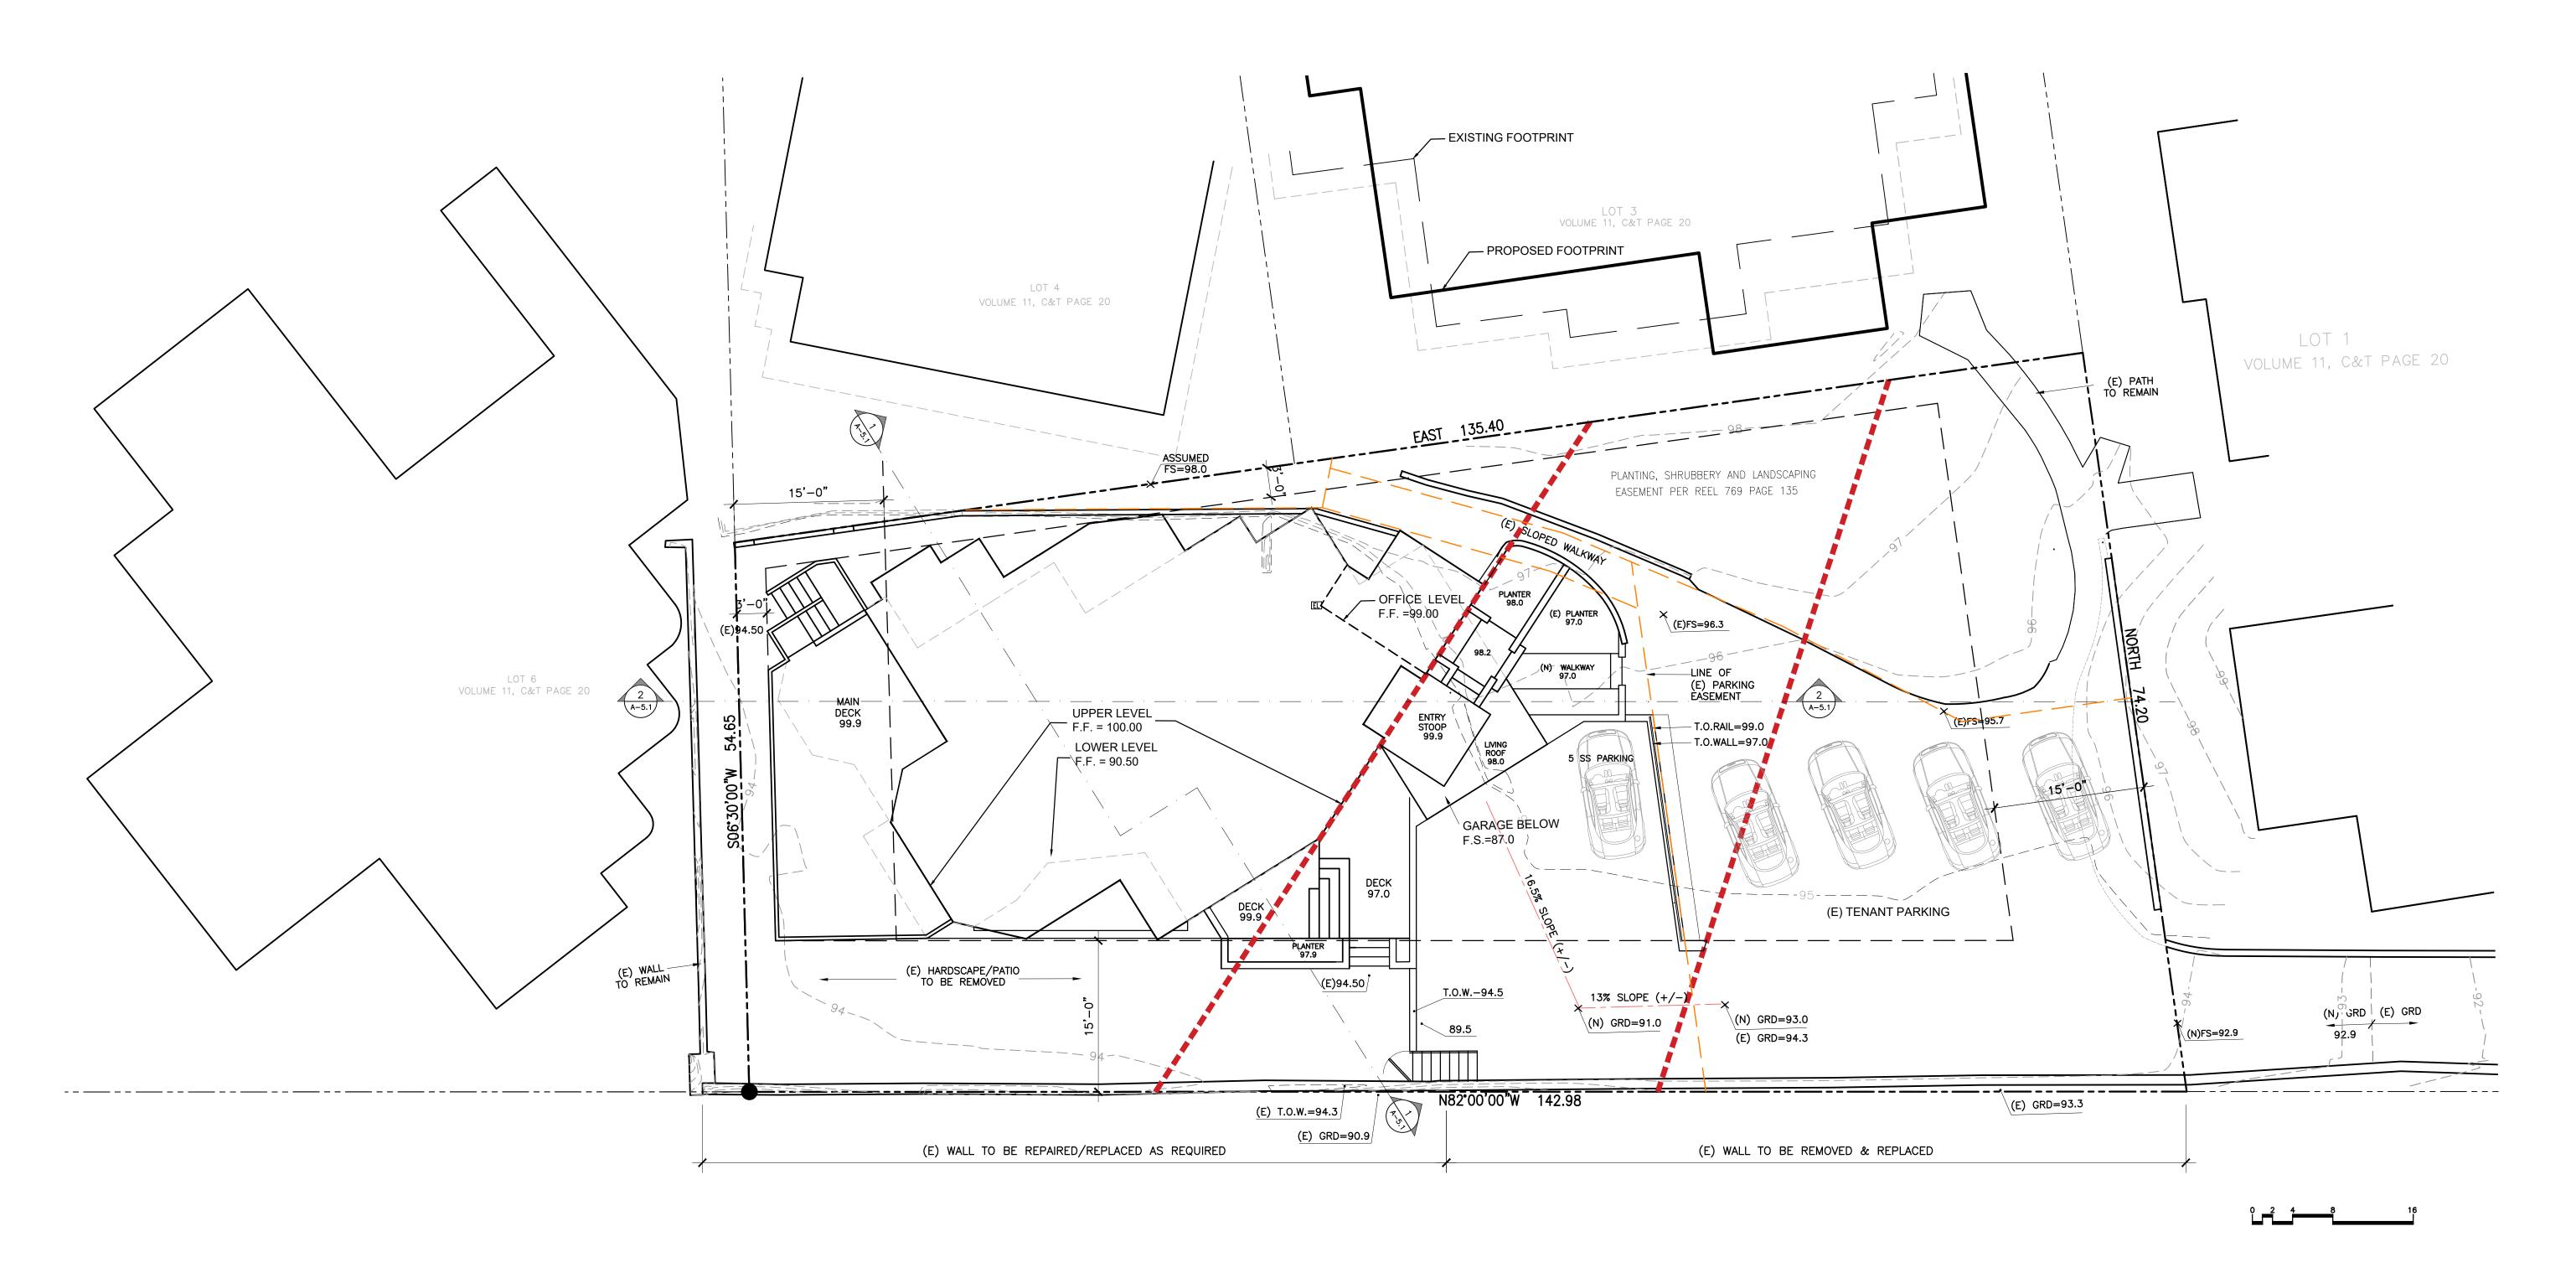
Date: 03.05.19

Scale: 1/8"=1'-0"

Drawn:

Description:
SITE PLAN

Sheet No: **A-1.2** 




SYMBOLS LEGEND

PROPOSED LOWER FLOOR FOOTPRINT

PROPOSED MAIN LEVEL FOOTPRINT

SCALE: 1/8"=1'-0"

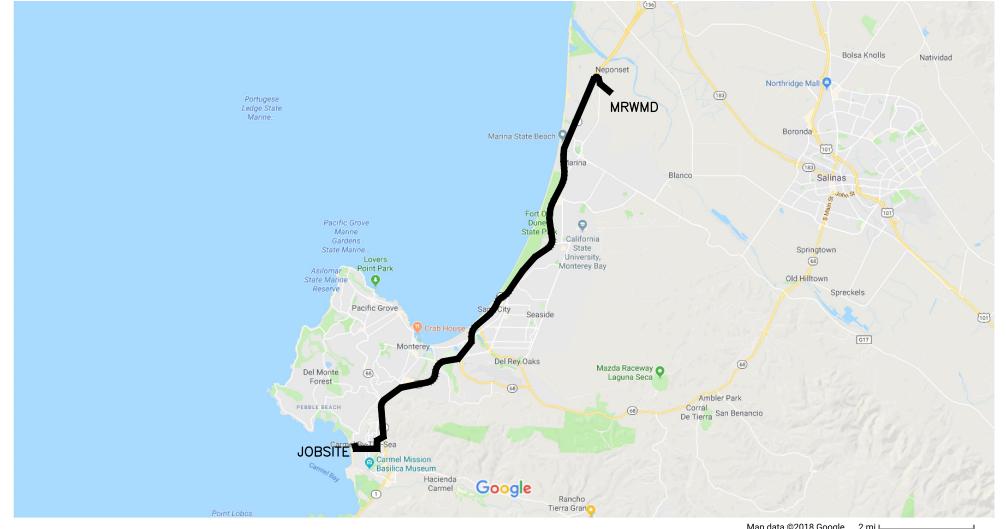

### TRUCK HAULING ROUTE

### FROM JOBSITE:

SOUTH (RIGHT) ON SAN ANTONIO EAST (LEFT) ON OCEAN AVENUE NORTH (LEFT) ON CARPENTER NORTH (LEFT) ON HIGHWAY ONE RIGHT EXIT AT DEL MONTE AVENUE ARRIVAL AT MRWMD

Map data ©2018 Google 2 mi ∟

TRUCK HAULING ROUTE VOLUME 11, C&T PAGE 20 NOT TO SCALE LOT 4 VOLUME 11, C&T PAGE 20 15**'**-0" LANTING, SHRUBBERY AND LANDSCAPING EASEMENT PER REEL 769 PAGE 135 15'-0" AREA AREA AREA ~ -**B**. 〔 AREA AREA AREA 

### CONSTRUCTION SUPPORT PLAN

SCALE: 1/8"=1'-0"

### **CONSTRUCTION NOTES**

- 1. ALL WORK SHALL TAKE PLACE DURING DAYLIGHT HOURS, MONDAY SATURDAY, 8AM TO 5PM (EXCLUDING NATIONAL HOLIDAYS)
- 2. THE SIGNED PERMITS AND THE APPROVED CONSTRUCTION PLANS SHALL BE MAINTAINED IN A CONSPICUOUS LOCATION AT THE CONSTRUCTION JOB SITE AT ALL TIMES, AND THAT SUCH COPIES ARE AVAILABLE FOR AGENCY REVIEW ON REQUEST. ALL PERSONS INVOLVED WITH THE CONSTRUCTION SHALL BE BRIEFED ON THE CONTENT AND MEANING OF THE PERMITS AND THE APPROVED CONSTRUCTION PLANS, AND THE PUBLIC REVIEW
- REQUIREMENTS APPLICABLE TO THEM, PRIOR TO COMMENCEMENT OF CONSTRUCTION. 3. EQUIPMENT WASHING, REFUELING AND SERVICING SHALL TAKE PLACE ONLY ONSITE. APPROPRIATE BEST MANAGEMENT PRACTICES SHALL BE USED TO ENSURE THAT NO SPILLS OF PETROLEUM PRODUCTS OR OTHER CHEMICALS TAKE PLACE DURING THESE ACTIVITIES.
- 4. THE CONSTRUCTION SITE SHALL MAINTAIN GOOD CONSTRUCTION SITE HOUSEKEEPING CONTROLS AND PROCEDURES (E.G. CLEANUP ALL LEAKS, DRIPS, AND OTHER SPILLS IMMEDIATELY; KEEP MATERIALS COVERED AND OUT OF THE RAIN, INCLUDING COVERING EXPOSED PILES OF SOIL AND WASTES; DISPOSE OF ALL WASTES PROPERLY, PLACE TRASH RECEPTACLES ON SITE FOR THAT PURPOSE, AND COVER OPEN TRASH RECEPTACLES
- DURING WET WEATHER). 5. ALL EROSION AND SEDIMENT CONTROLS SHALL BE IN PLACE PRIOR TO THE COMMENCEMENT OF CONSTRUCTION AS WELL AS AT THE END OF EACH WORKDAY. AT A MINIMUM, SILT FENCES, OR EQUIVALENT APPARATUS, SHALL BE INSTALLED AT THE PERIMETER OF THE CONSTRUCTION SITE TO PREVENT CONSTRUCTION-RELATED RUNOFF
- AND/OR SEDIMENT FROM LEAVING THE SITE. 6. THE CONTRACTOR SHALL IMPLEMENT THE FOLLOWING MEASURES TO CONTROL FUGITIVE DUST EMISSIONS DURING CONSTRUCTION (MM AQ C1 - DUST CONTROL):
- 6.1. WATER ALL ACTIVE CONSTRUCTION AREAS AT LEAST TWICE DAILY. FREQUENCY SHOULD BE BASED ON THE TYPE OF OPERATION, SOIL, AND WIND EXPOSURE.
- PROHIBIT ALL GRADING ACTIVITIES DURING PERIODS OF HIGH WIND MORE THAN 15 MILES PER HOUR.
- APPLY CHEMICAL SOIL STABILIZERS ON INACTIVE CONSTRUCTION AREAS SUCH AS DISTURBED LANDS WITHIN CONSTRUCTION PROJECTS THAT ARE UNUSED FOR AT LEAST FOUR CONSECUTIVE DAYS.
- APPLY NON-TOXIC BINDERS LIKE LATEX ACRYLIC COPOLYMER TO EXPOSED AREAS AFTER CUT AND FILL OPERATIONS AND HYDROSEED AREA.
- MAINTAIN AT LEAST 2 FEET OF FREEBOARD ON HAUL TRUCKS.
- COVER ALL TRUCKS HAULING DIRT SAND OR LOOSE MATERIALS.
- PLANT TREE WINDBREAKS ON THE WINDWARD PERIMETER OF CONSTRUCTION PROJECTS IF ADJACENT TO OPEN LAND, PRIOR TO CONSTRUCTION (N/A).
- PLANT VEGETATIVE GROUND COVER IN DISTURBED AREAS AS SOON AS POSSIBLE. COVER INACTIVE STORAGE PILES.
- INSTALL WHEEL WASHERS AT THE ENTRANCE TO CONSTRUCTION SITES FOR ALL EXITING
- 6.11. SWEEP STREETS IF VISIBLE SOIL MATERIAL IS CARRIED OUT FROM THE CONSTRUCTION
- SITE AND CHECK AT LEAST ONCE DAILY. 6.12. POST A PUBLICLY VISIBLE SIGN THAT SPECIFIES THE TELEPHONE NUMBER AND PERSON TO CONTACT REGARDING DUST COMPLAINTS. THIS PERSON WILL RESPOND TO COMPLAINTS AND TAKE CORRECTIVE ACTION WITHIN 48 HOURS. THE PHONE NUMBER OF THE MBUAPCD WILL BE VISIBLE TO ENSURE COMPLIANCE WITH RULE 402
- 6.13. LIMIT THE AREA UNDER CONSTRUCTION AT ANY ONE TIME. THE CONSTRUCTION CONTRACTOR WILL ENSURE THESE MEASURES ARE IMPLEMENTED DURING CONSTRUCTION AS VERIFIABLE UPON COUNTY INSPECTION.
- THE CONTRACTOR SHALL IMPLEMENT THE FOLLOWING MEASURES TO CONTROL CONSTRUCTION RELATED EXHAUST EMISSIONS FROM HEAVY DUTY OFF ROAD DIESEL POWERED CONSTRUCTION EQUIPMENT DURING CONSTRUCTION (MM AQ C2 - EMISSION
- LIMIT USE OF EQUIPMENT.
- REPLACE DIESEL POWERED EQUIPMENT WITH GASOLINE POWERED EQUIPMENT.
- MODIFY ENGINE WITH ARB VERIFIED RETROFIT. REPOWER WITH CURRENT STANDARD DIESEL TECHNOLOGY.
- REPOWER WITH COMPRESSED NATURAL GAS AND OR LIQUID NATURAL GAS TECHNOLOGY.
- THE APPLICANT WILL ENSURE THAT THE CONSTRUCTION SPECIFICATIONS REQUIRE CONSTRUCTION CONTRACTORS TO RETROFIT AND INSTALL DIESEL PARTICULATE INSTALL DIESEL PARTICULATE FILTERS CAPABLE OF ACHIEVING AN 85 PERCENT REDUCTION IN PM10 EXHAUST EMISSIONS LEVEL 3 ON ALL OFF ROAD CONSTRUCTION EQUIPMENT AND DIESEL 85 PERCENT REDUCTION IN PM10 EXHAUST EMISSIONS LEVEL 3 ON ALL OFF ROAD CONSTRUCTION EQUIPMENT AND DIESEL OXIDATION CATALYSTS AND LEVEL 3 DPFS ON ALL ON ROAD SOIL HAULING, HAULING, THE CONSTRUCTION CONTRACTOR WILL ENSURE THESE MEASURES ARE IMPLEMENTED DURING
- CONSTRUCTION AS VERIFIABLE UPON COUNTY INSPECTION. 8. THE CONTRACTOR SHALL INCLUDE THE FOLLOWING THREE BEST MANAGEMENT PRACTICES DURING CONSTRUCTION, TO THE EXTENT FEASIBLE, TO REDUCE CONSTRUCTION RELATED
- 1. USE ALTERNATIVE FUELED LIKE BIODIESEL AND ELECTRIC CONSTRUCTION VEHICLES AND EQUIPMENT FOR AT LEAST 15 PERCENT OF THE FLEET. 2. USE LOCAL BUILDING MATERIALS WHERE REASONABLY AVAILABLE WITHIN THE GENERAL
- MONTEREY BAY AREA DEFINED AS MONTEREY COUNTY, SANTA CRUZ COUNTY, AND SAN BENITO COUNTY. 3. RECYCLE AT LEAST 65 PERCENT OF CONSTRUCTION WASTE OR DEMOLITION MATERIALS.
- 9. PRIOR TO THE INITIATION OF ANY SITE PREPARATION AND OR START THE CONTRACTOR WILL ENSURE THAT ALL STATIONARY NOISE GENERATING EQUIPMENT, SUCH AS PUMPS AND GENERATORS ARE LOCATED AS FAR AS POSSIBLE FROM NEARBY NOISE SENSITIVE RECEPTORS AS PRACTICABLE. WHERE POSSIBLE, NOISE GENERATING EQUIPMENT WILL BE SHIELDED FROM NEARBY NOISE SENSITIVE RECEPTORS BY NOISE ATTENUATING BUFFERS SUCH AS STRUCTURES OR HAUL TRUCK TRAILERS. STATIONARY NOISE SOURCES LOCATED CLOSER THAN 500 FEET FROM NOISE SENSITIVE RECEPTORS WILL BE EQUIPPED WITH NOISE REDUCING ENGINE HOUSINGS. PORTABLE ACOUSTIC BARRIERS WILL BE PLACED AROUND NOISE GENERATING EQUIPMENT LOCATED WITHIN 200 FEET OF RESIDENCES. WATER TANKS AND EQUIPMENT STORAGE, STAGING, AND WARM-UP AREAS WILL BE LOCATED AS FAR FROM NOISE SENSITIVE RECEPTORS AS POSSIBLE. 15. THE CONTRACTOR WILL ENSURE ALL CONSTRUCTION EQUIPMENT POWERED BY GASOLINE OR DIESEL ENGINES HAS SOUND CONTROL DEVICES AT LEAST AS EFFECTIVE AS THOSE ORIGINALLY PROVIDED BY THE MANUFACTURER. NO EQUIPMENT WILL BE PERMITTED TO HAVE AN UNMUFFLED EXHAUST.
- 10. THE APPLICANT WILL ENSURE THE CONSTRUCTION SPECIFICATIONS SPECIFY THAT ANY IMPACT TOOLS USED DURING DEMOLITION OF EXISTING INFRASTRUCTURE ARE SHROUDED OR SHIELDED. THESE REQUIREMENTS WILL BE INCLUDED IN ALL RELEVANT CONSTRUCTION CONTRACTS AND SHOWN ON CONSTRUCTION PLANS.
- 11. THE APPLICANT WILL ENSURE THE CONSTRUCTION SPECIFICATIONS SPECIFY THAT ANY MOBILE NOISE-GENERATING EQUIPMENT OR MACHINERY IS SHUT OFF WHEN NOT IN USE. THESE REQUIREMENTS WILL BE INCLUDED IN ALL RELEVANT CONSTRUCTION CONTRACTS AND SHOWN ON CONSTRUCTION PLANS, AND WILL BE IMPLEMENTED DURING CONSTRUCTION. 12. THE CONTRACTOR TO ENSURE THAT CONSTRUCTION VEHICLES ACCESSING THE SITE USE

DO NOT EXPOSE ADDITIONAL RECEPTORS TO NOISE. SEE APPROVED CONSTRUCTION

MANAGEMENT PLAN. 13. THE APPLICANT AND THE CONTRACTOR WILL ENSURE THAT RESIDENTS WITHIN 500 FEET OF THE CONSTRUCTION AREA ARE NOTIFIED OF THE CONSTRUCTION SCHEDULE IN WRITING BEFORE CONSTRUCTION BEGINS. THE PROJECT APPLICANT AND CONTRACTOR WILL DESIGNATE A NOISE DISTURBANCE COORDINATOR WHO IS RESPONSIBLE FOR RESPONDING TO COMPLAINTS REGARDING CONSTRUCTION NOISE. THE COORDINATOR WILL DETERMINE THE CAUSE OF ANY COMPLAINT AND ENSURE THAT REASONABLE MEASURES ARE IMPLEMENTED TO CORRECT THE PROBLEM. A CONTACT TELEPHONE NUMBER FOR THE NOISE DISTURBANCE COORDINATOR WILL BE POSTED CONSPICUOUSLY ON CONSTRUCTION SITE FENCES AND WILL

BE INCLUDED IN THE WRITTEN NOTIFICATION OF THE CONSTRUCTION SCHEDULE SENT TO

THE SHORTEST POSSIBLE ROUTE TO AND FROM LOCAL FREEWAYS, PROVIDED THE ROUTES

- 14. THROUGHOUT THE CONSTRUCTION PERIOD, THE CONTRACTOR WILL IMPLEMENT ADDITIONAL NOISE MITIGATION MEASURES AT THE REQUEST OF THE COUNTY AS NEEDED SUCH THAT CONSTRUCTION NOISE LEVELS DO NOT EXCEED 85 DBA AT THE NEAREST OUTDOOR ACTIVITY AREA OF A NOISE-SENSITIVE LAND USE. ADDITIONAL MEASURES MIGHT INCLUDE CHANGING THE LOCATION OF STATIONARY NOISE GENERATING EQUIPMENT, SHUTTING OFF IDLING EQUIPMENT, RESCHEDULING CONSTRUCTION ACTIVITY, INSTALLING ACOUSTIC BARRIERS AROUND STATIONARY SOURCES OF CONSTRUCTION NOISE, TEMPORARILY RELOCATING RESIDENTS WHERE PRACTICABLE, USING ALTERNATIVE EQUIPMENT OR CONSTRUCTION METHODS THAT PRODUCE LESS NOISE, AND OTHER SITE-SPECIFIC MEASURES AS APPROPRIATE
- 15. A TRAFFIC CONTROL PLAN, INCLUDING A COMPREHENSIVE SET OF TRAFFIC CONTROL MEASURES, WILL BE PREPARED BY THE CONSTRUCTION CONTRACTOR, SUBMITTED TO MONTEREY COUNTY FOR REVIEW AND APPROVAL, BEFORE ISSUANCE OF GRADING OR BUILDING PERMITS. THE PLAN WILL INCLUDE PROCEDURES FOR SCHEDULING MAJOR TRUCK TRIPS AND DELIVERIES TO AVOID SPECIAL EVENT ACTIVITY IN DEL MONTE FOREST AND MINIMIZE PEAK HOUR ACTIVITY ON ROADS OPERATING BELOW LOS SIGNIFICANCE THRESHOLDS. LANE CLOSURE PROCEDURES, INCLUDING SIGNS, CONES, AND OTHER WARNING DEVICES FOR DRIVERS, WILL BE IDENTIFIED AS APPROPRIATE. USE OF STEEL PLATES TO MAINTAIN THROUGH TRAFFIC ON ROADS WILL BE CONSIDERED, AND CONSTRUCTION ACCESS ROUTES WILL BE IDENTIFIED. CONSTRUCTION STAGING IS ANTICIPATED TO OCCUR ONSITE FOR ALL PROJECT COMPONENTS AND WILL BE VERIFIED BY THE COUNTY. ONSITE PARKING WILL BE PROVIDED FOR ALL CONSTRUCTION WORKERS TO MINIMIZE THE IMPACT ON AREA ROADS. WHEN ONSITE PARKING CANNOT BE PROVIDED, ALTERNATIVE PARKING AND SHUTTLE SYSTEMS WILL BE DEVELOPED AND VERIFIED BY THE



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Date: 10.23.18

Scale: AS SHOWN

Drawn:

Description: CONSTRUCTION MANAGEMENT PLAN

Sheet No:

**LEGEND** 

AREA A: SCREENED PORTABLE TOILET

**CONSTRUCTION SCHEDULE** 

18-24 MONTHS

8AM TO 5 PM

BE ENCOURAGED TO CARPOOL

10 DAILY WORKERS

VEHICLES: NO VEHICLES TO REMAIN ON SITE

DURING CONSTRUCTION. ALL VEHICLES FOR

MUST BE MOVED AS SOON AS THEIR JOB IS

**CONSTRUCTION COORDINATOR** 

THE CONTRACTOR SHALL PROVIDE A CONSTRUCTION

COORDINATOR TO HANDLE ALL ASPECTS OF LOGISTICS

AND SCHEDULING DURING THE CONSTRUCTION PHASE

CONSPICUOUSLY POSTED AT THE JOB SITE IN A MANNER

THAT THE CONTACT INFORMATION IS VISIBLE FROM A

PUBLIC VIEWING AREA. THE POSTING SHALL INDICATE

THAT THE CONSTRUCTION COORDINATOR SHOULD BE

DURING CONSTRUCTION - BOTH FOR GENERAL INQUIRIES

NUMBER AND NATURE OF QUESTION OR COMPLAINT AND

CONTACTED TO ANSWER ANY QUESTION THAT ARISE

AND FOR EMERGENCIES. THE COORDINATOR SHALL

MAKE A RECORD OF ALL CALLS BY NAME, PHONE

RECEIPT OF THE INQUIRY OR COMPLAINT.

TAKE ACTION IF NECESSARY, WITHIN 24 HOURS OF

THE COORDINATOR'S PHONE NUMBER SHALL BE

DELIVERING, TOILET CLEANING, HAULING, ETC.

CONTRACTOR TO PROVIDE A VAN CARPOOL. ALL

SUB-CONTRACTORS AND THEIR EMPLOYEES WILL

DURATION:

COMPLETE.

HOURS:

AREA B: LOCKED TOOL BOX

AREA C: DELIVERY AND DUMP TRUCK PARKING

TO BE STAGED SO ONLY 1 AT A TIME AREA D: MATERIAL STOCKPILE

AREA E: DUMPSTER AREA F: STAGING AREA

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Action:

Date: 01.31.19


Scale: 1/8"=1'-0"

Drawn:

Description:
DEMOLITION
PLAN


Sheet No: **A-1.4** 


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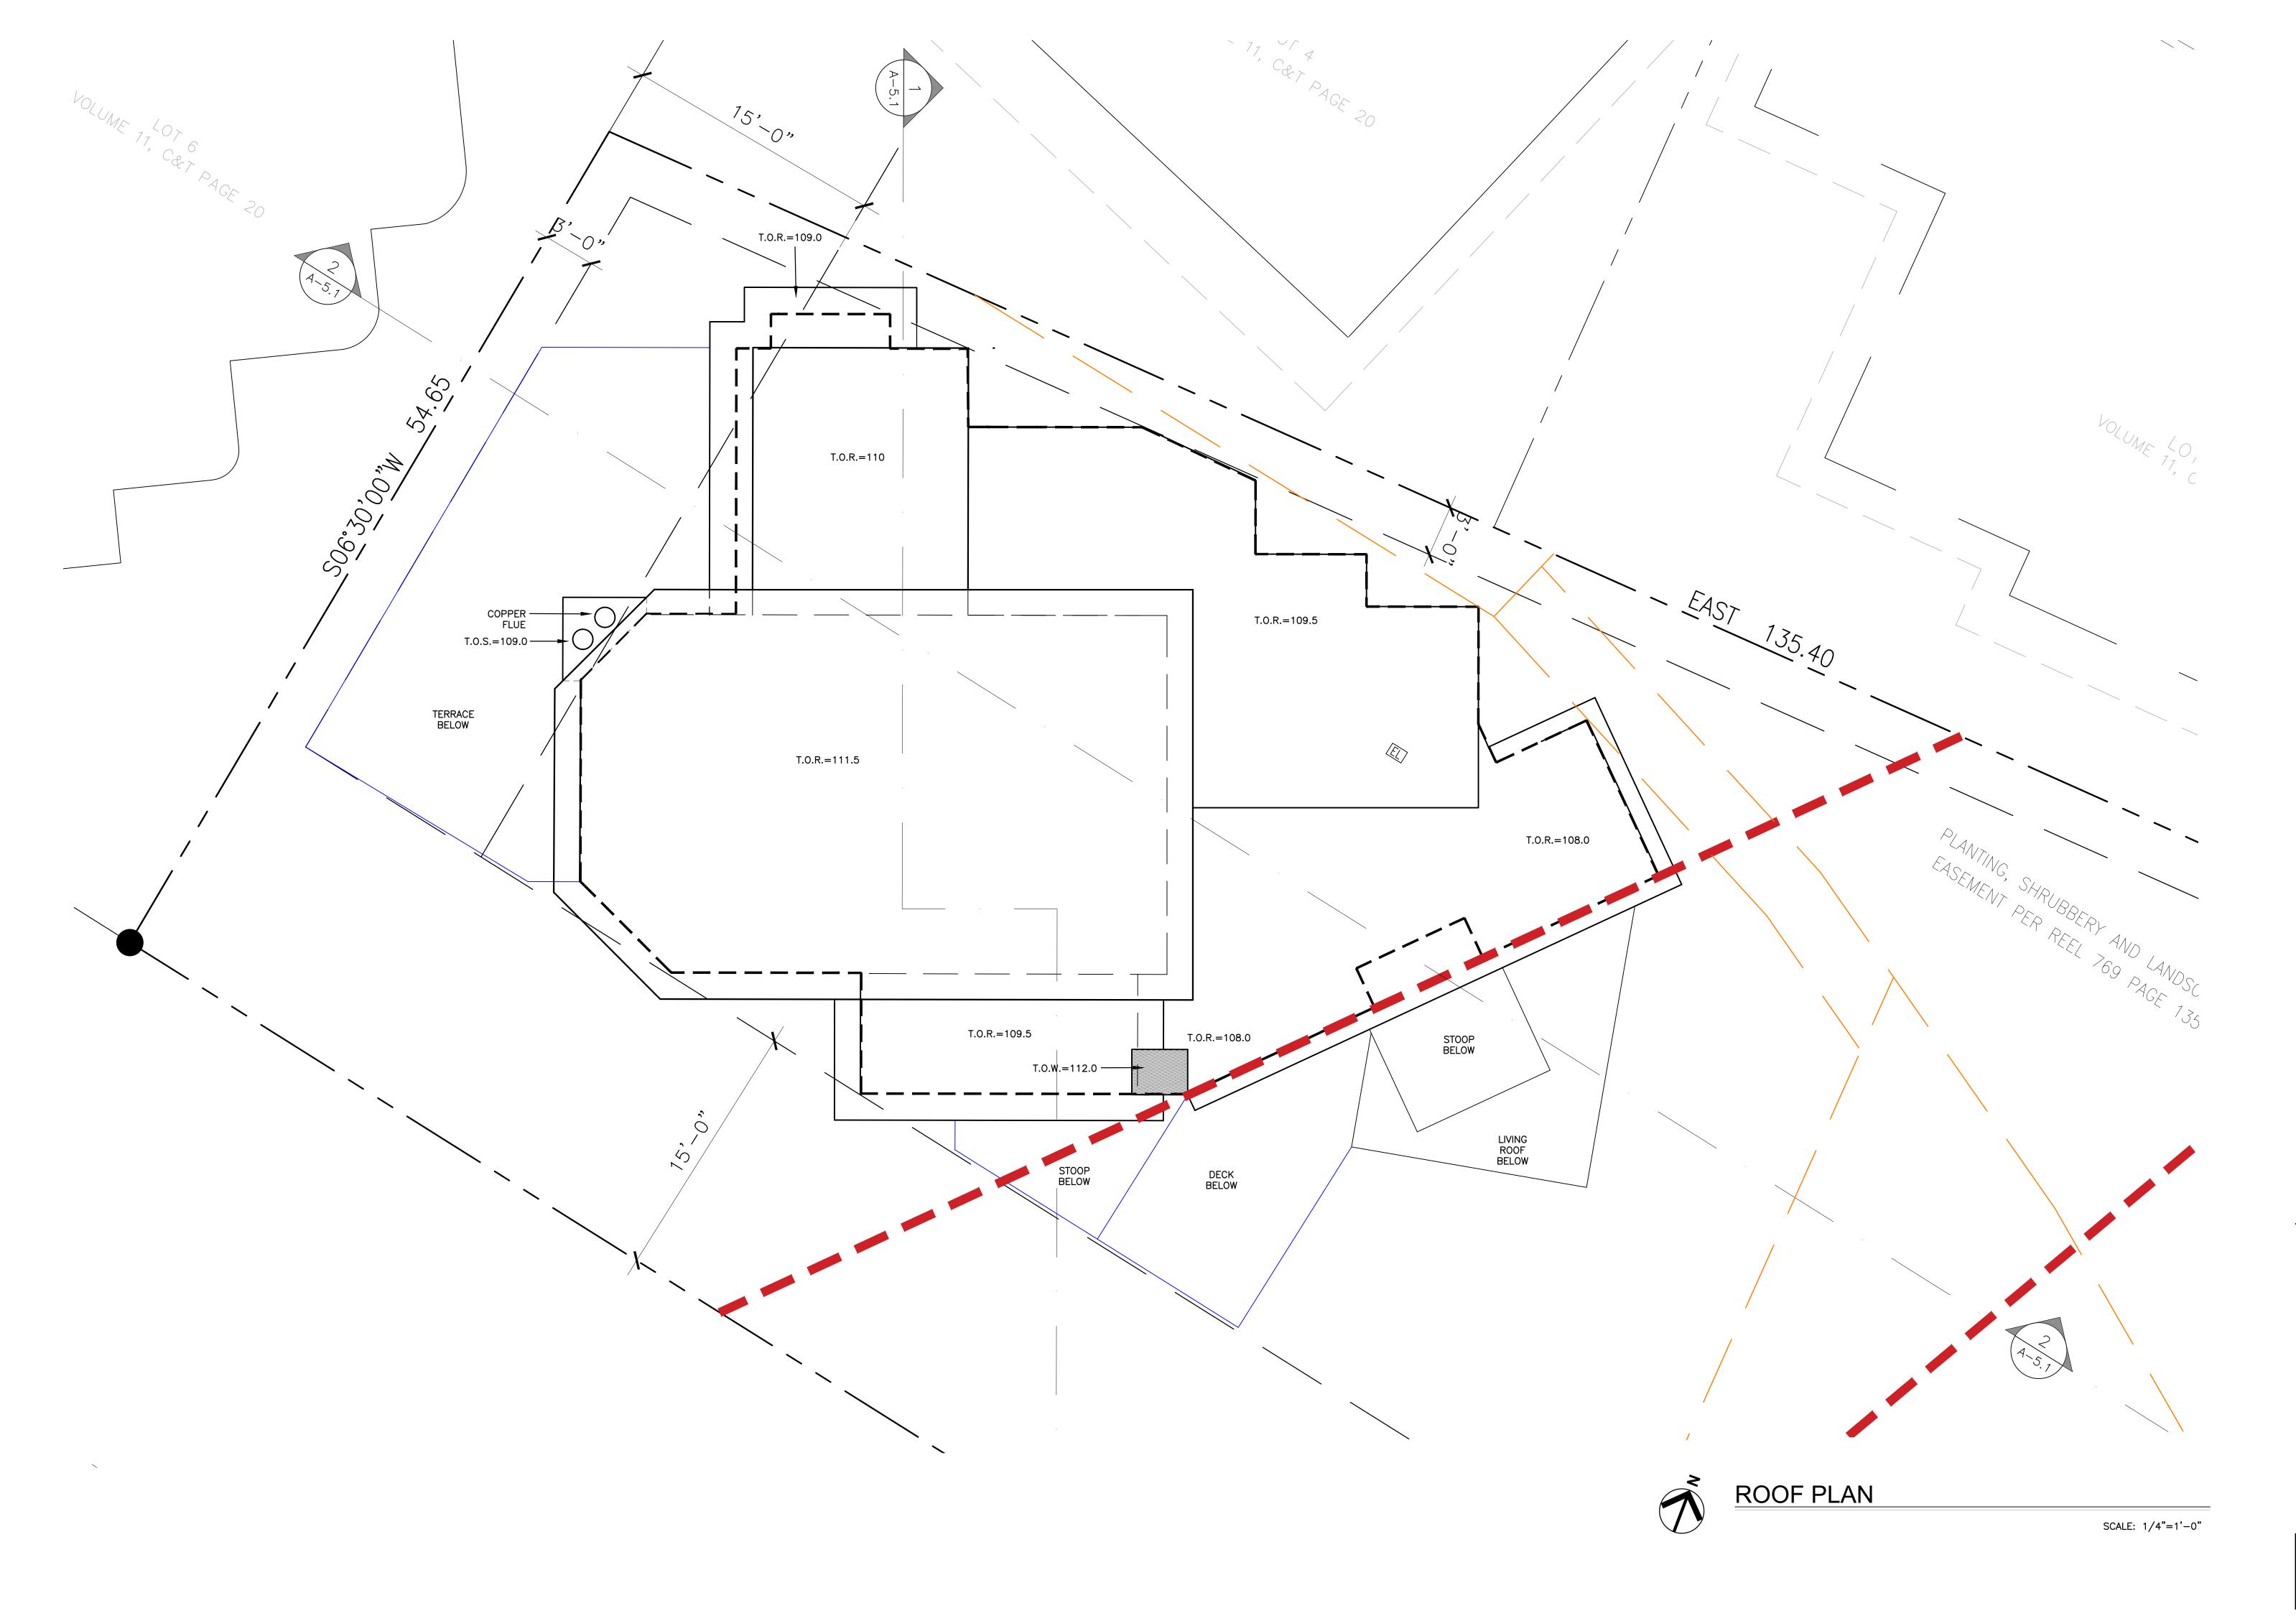

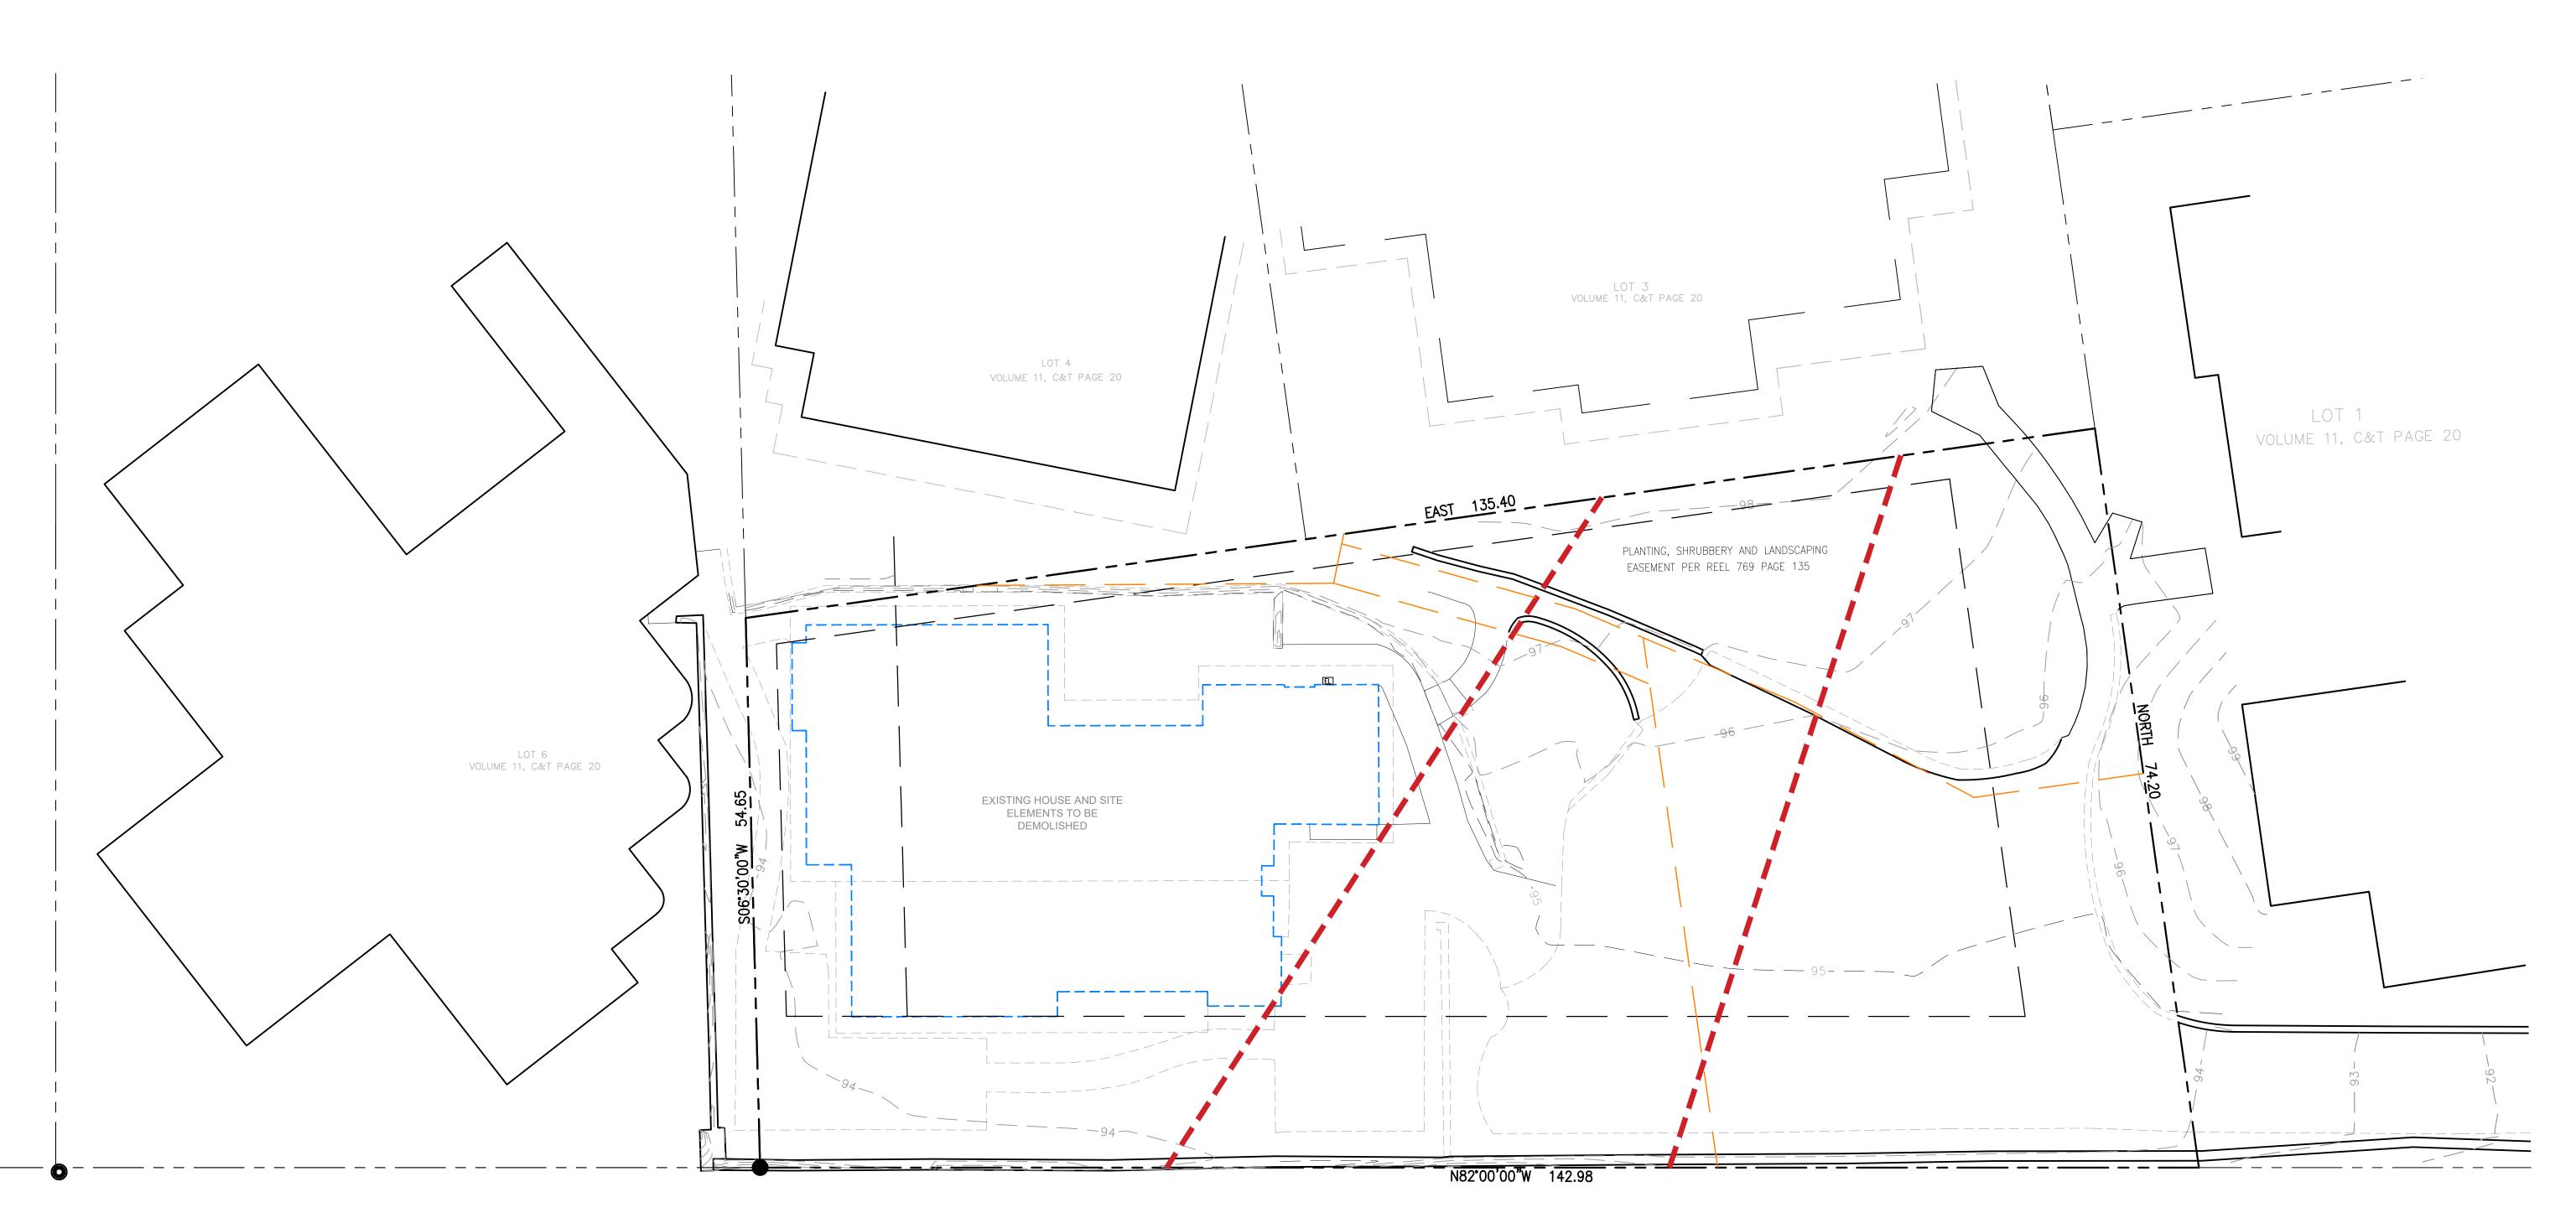
# **DEMOLITION NOTES**

- 1. ALL UTILITIES MUST BE DISCONNECTED PRIOR TO START OF DEMOLITION.
- 2. CONTRACTOR SHALL PROVIDE SAFE SUPPORT FOR FLOOR AND ROOF BEARING POINTS DURING AND AFTER REMOVAL UNTIL SECURELY RESUPPORTED WITH WEIGHT TRANSFER TO PROPER SIZED FOOTING.
- 3. CONTRACTOR SHALL COORDINATE RECYCLING OF SALVAGEABLE BUILDING MATERIALS WITH LOCAL NONPROFIT OR OTHER.
- 4. SUFFICIENTLY WET THE STRUCTURE PRIOR TO DECONSTRUCTION OR DEMOLITION. CONTINUE WETTING AS NECESSARY DURING ACTIVE DECONSTRUCTION OR DEMOLITION AND THE DEBRIS REDUCTION PROCESS.
- 5. DEMOLISH THE STRUCTURE INWARD TOWARD THE BUILDING PAD. LAY DOWN ROOF AND WALLS SO THAT THEY FALL INWARD AND NOT AWAY FROM THE BUILDING.
- 6. COMMENCEMENT OF DECONSTRUCTION OR DEMOLITION ACTIVITIES SHALL BE PROHIBITED WHEN THE PEAK WIND SPEED EXCEEDS 15 MILES PER HOUR.
- 7. DURING DEMOLITION, THE OWNER/APPLICANT/CONTRACTOR SHALL OBTAIN ANY REQUIRED AIR DISTRICT PERMITS AND THE AIR DISTRICT SHALL CONDUCT ALL DECONSTRUCTION OR DEMOLITION INSPECTION ACTIVITIES AS RQUIRED BY THE AIR DISTRICT.



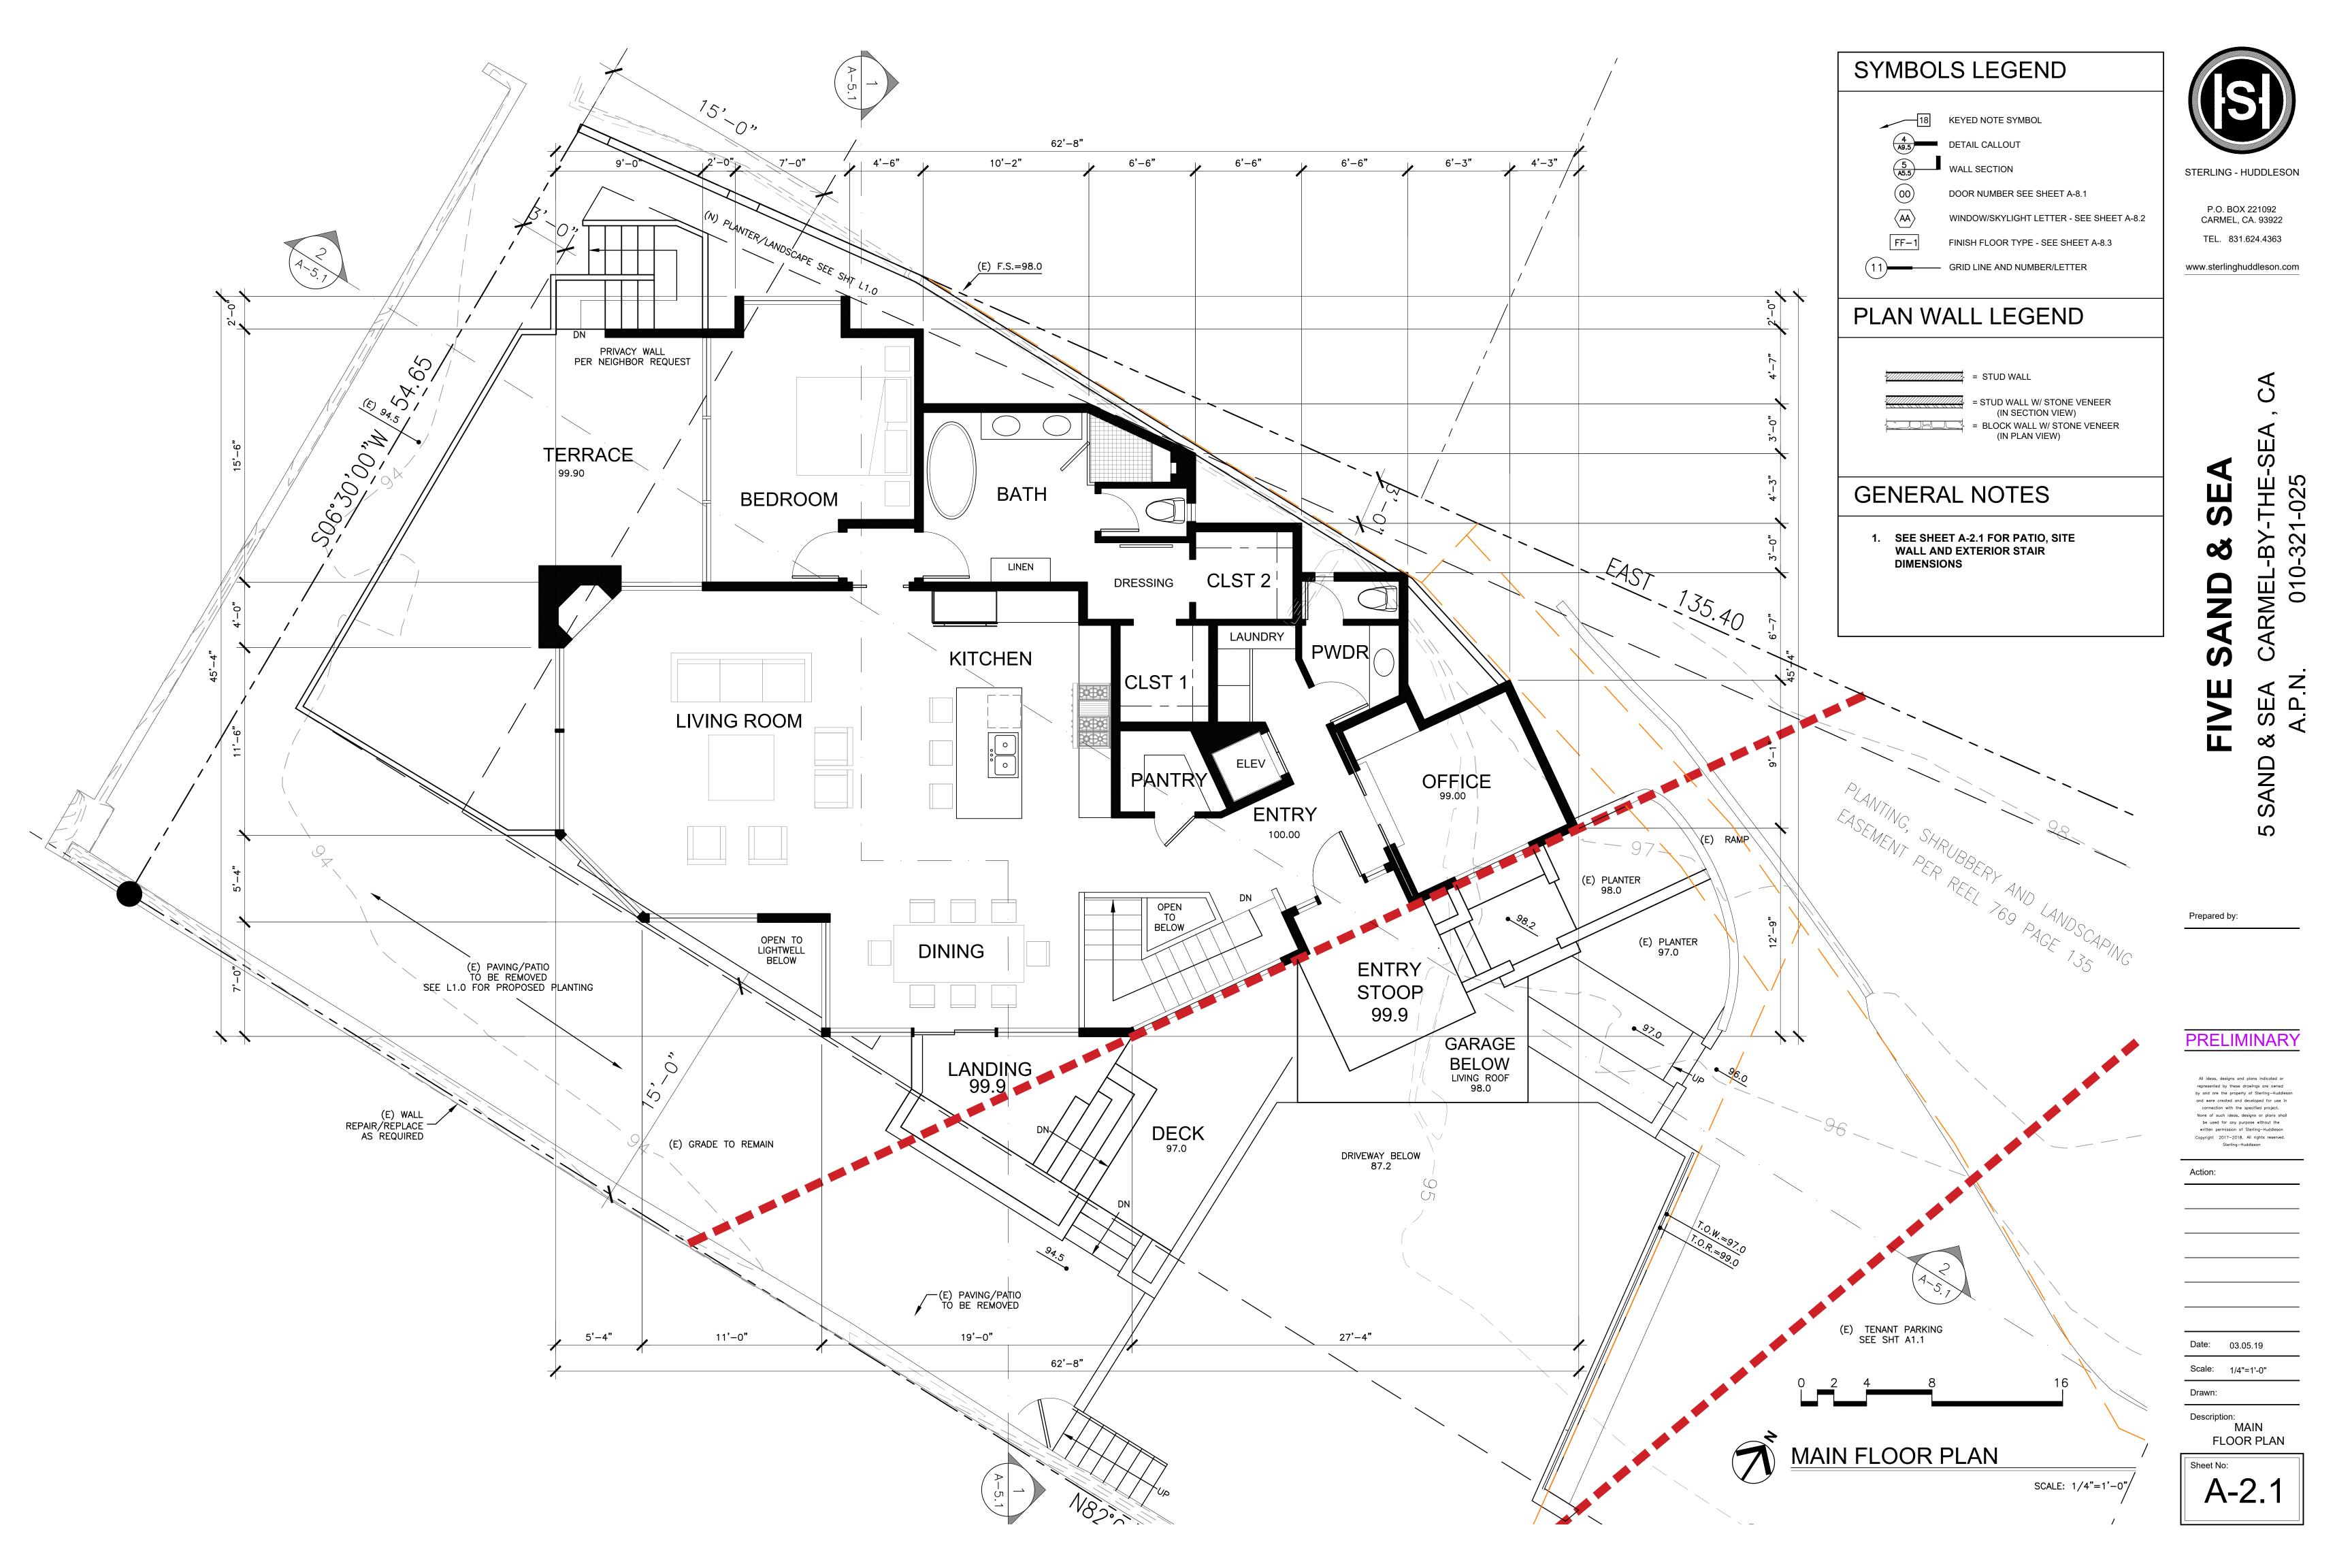

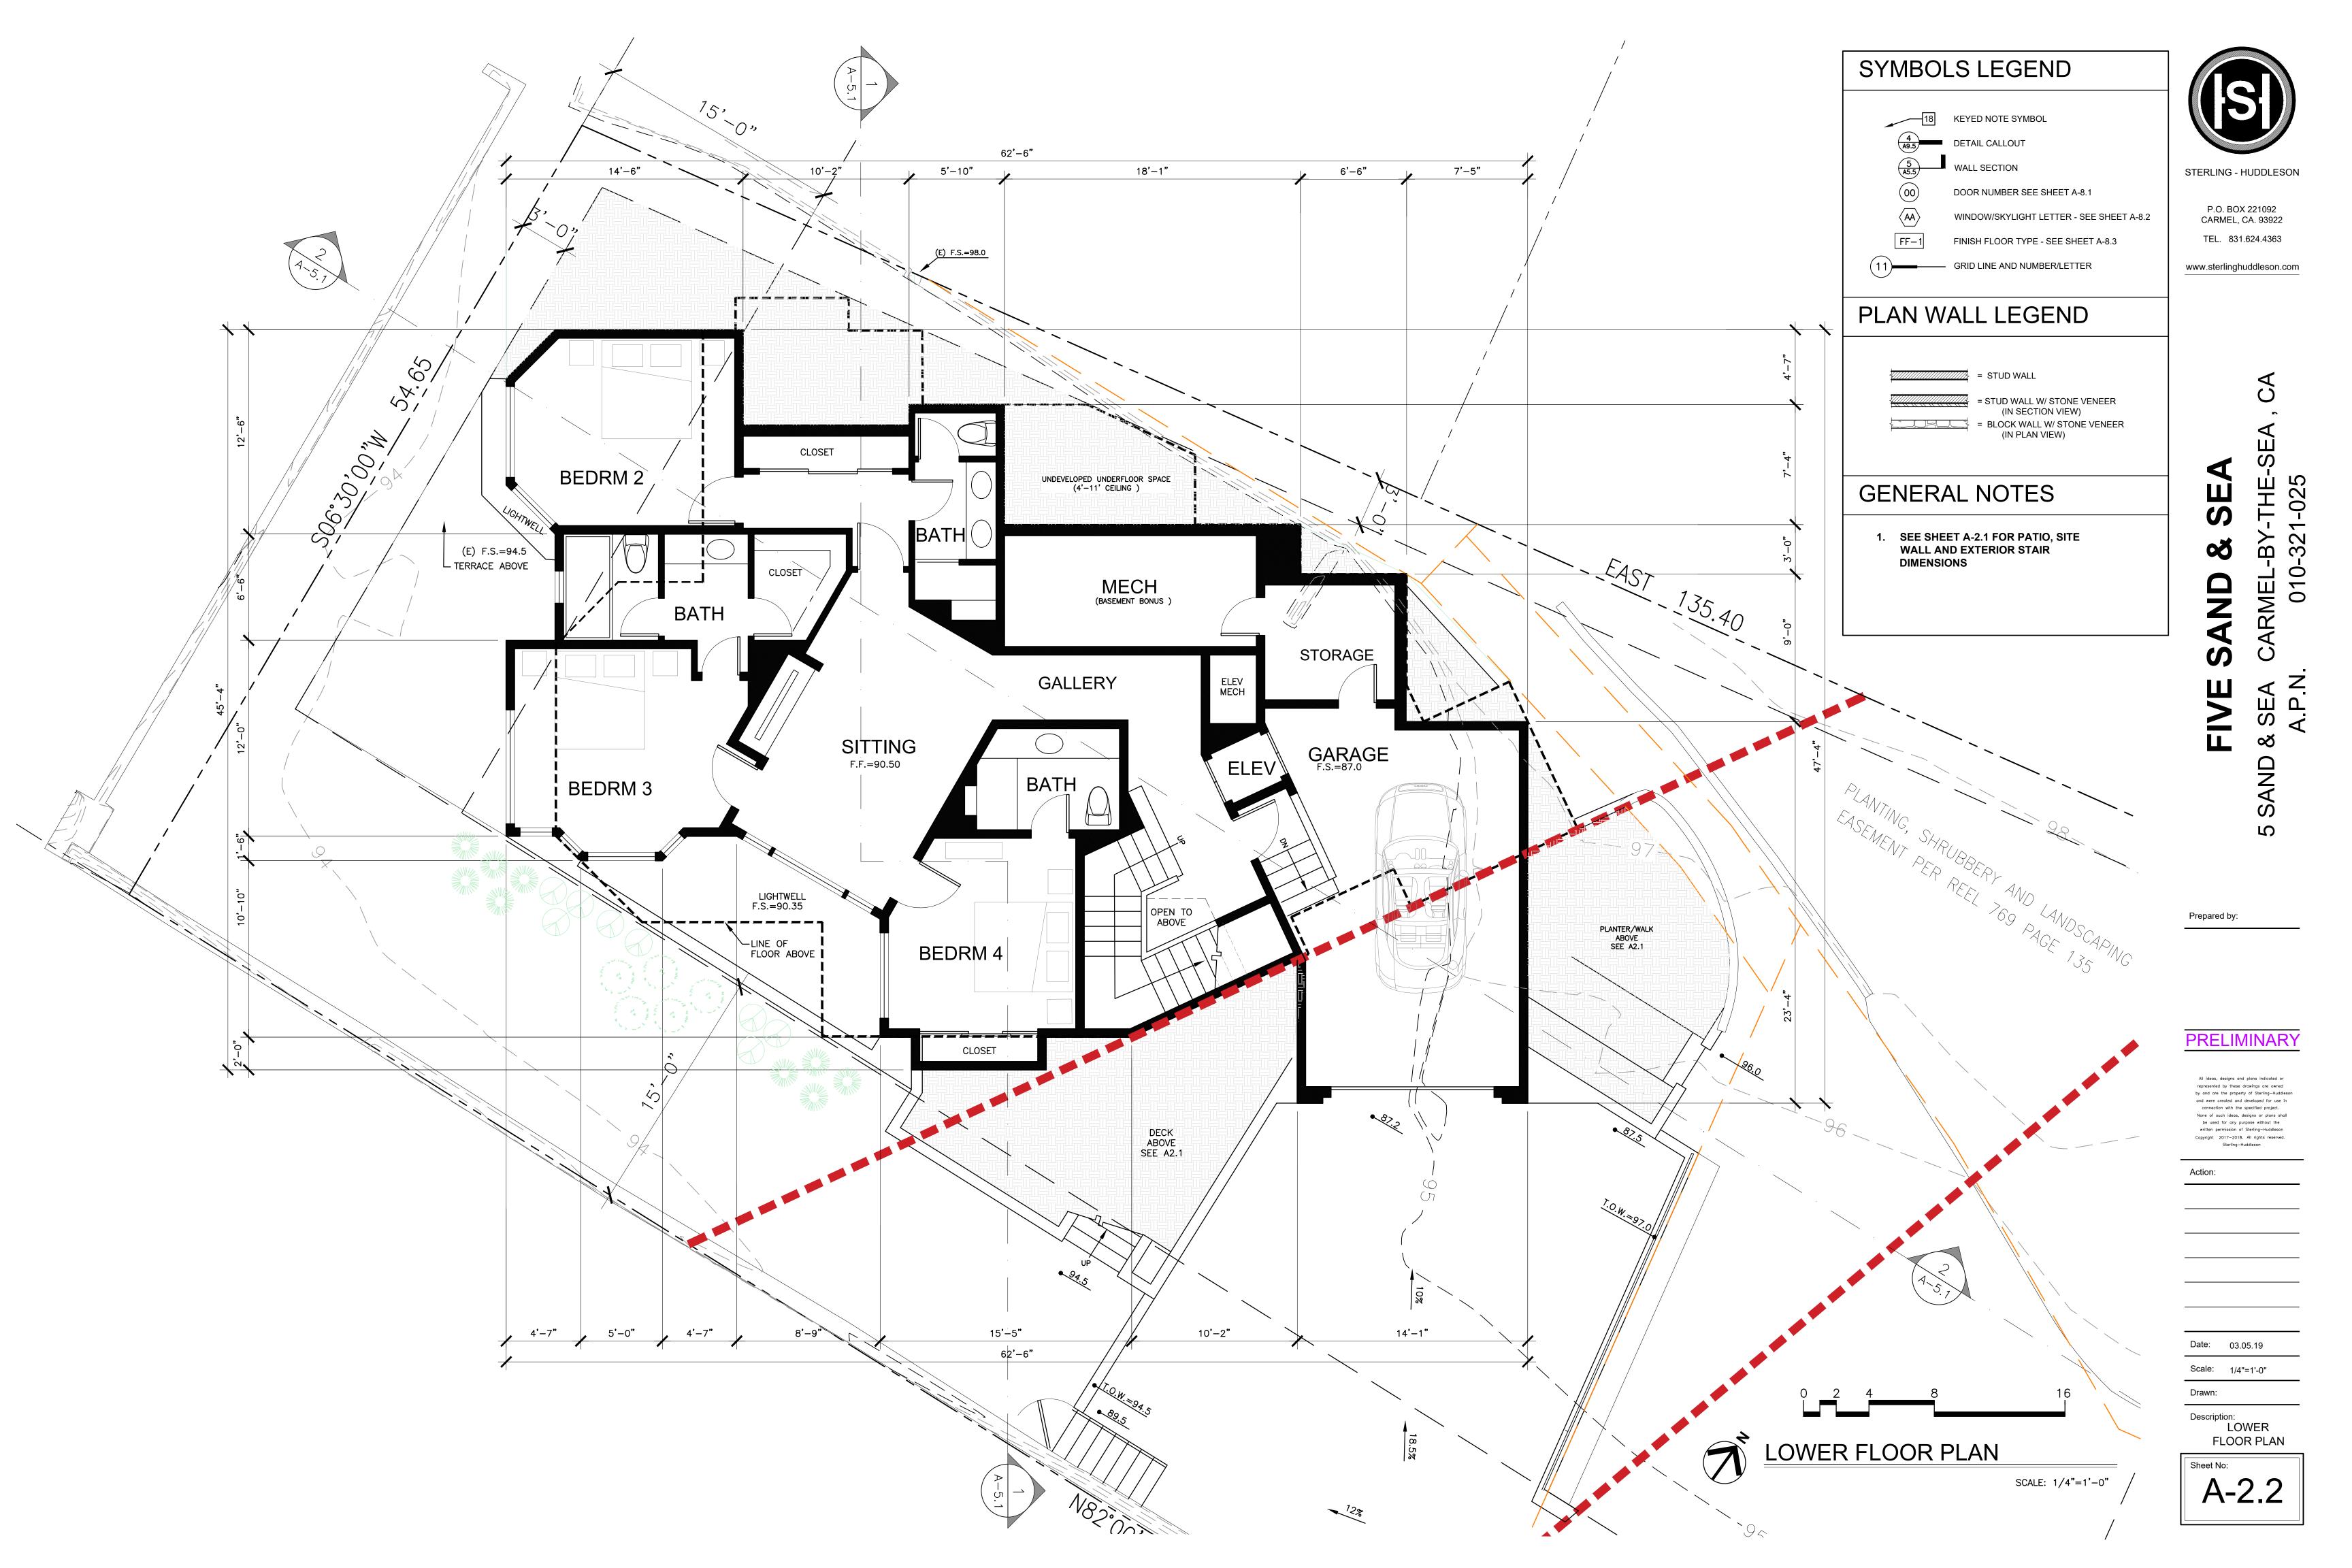



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**SAND & SEA**CARMEL-BY-THE-SEA,

010-321-025

Prepared by:

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Action:

Date: 01.03.19


Scale: 1/4"=1'-0"

Drawn:

Description:

MAIN
FLOOR PLAN

Sheet No:

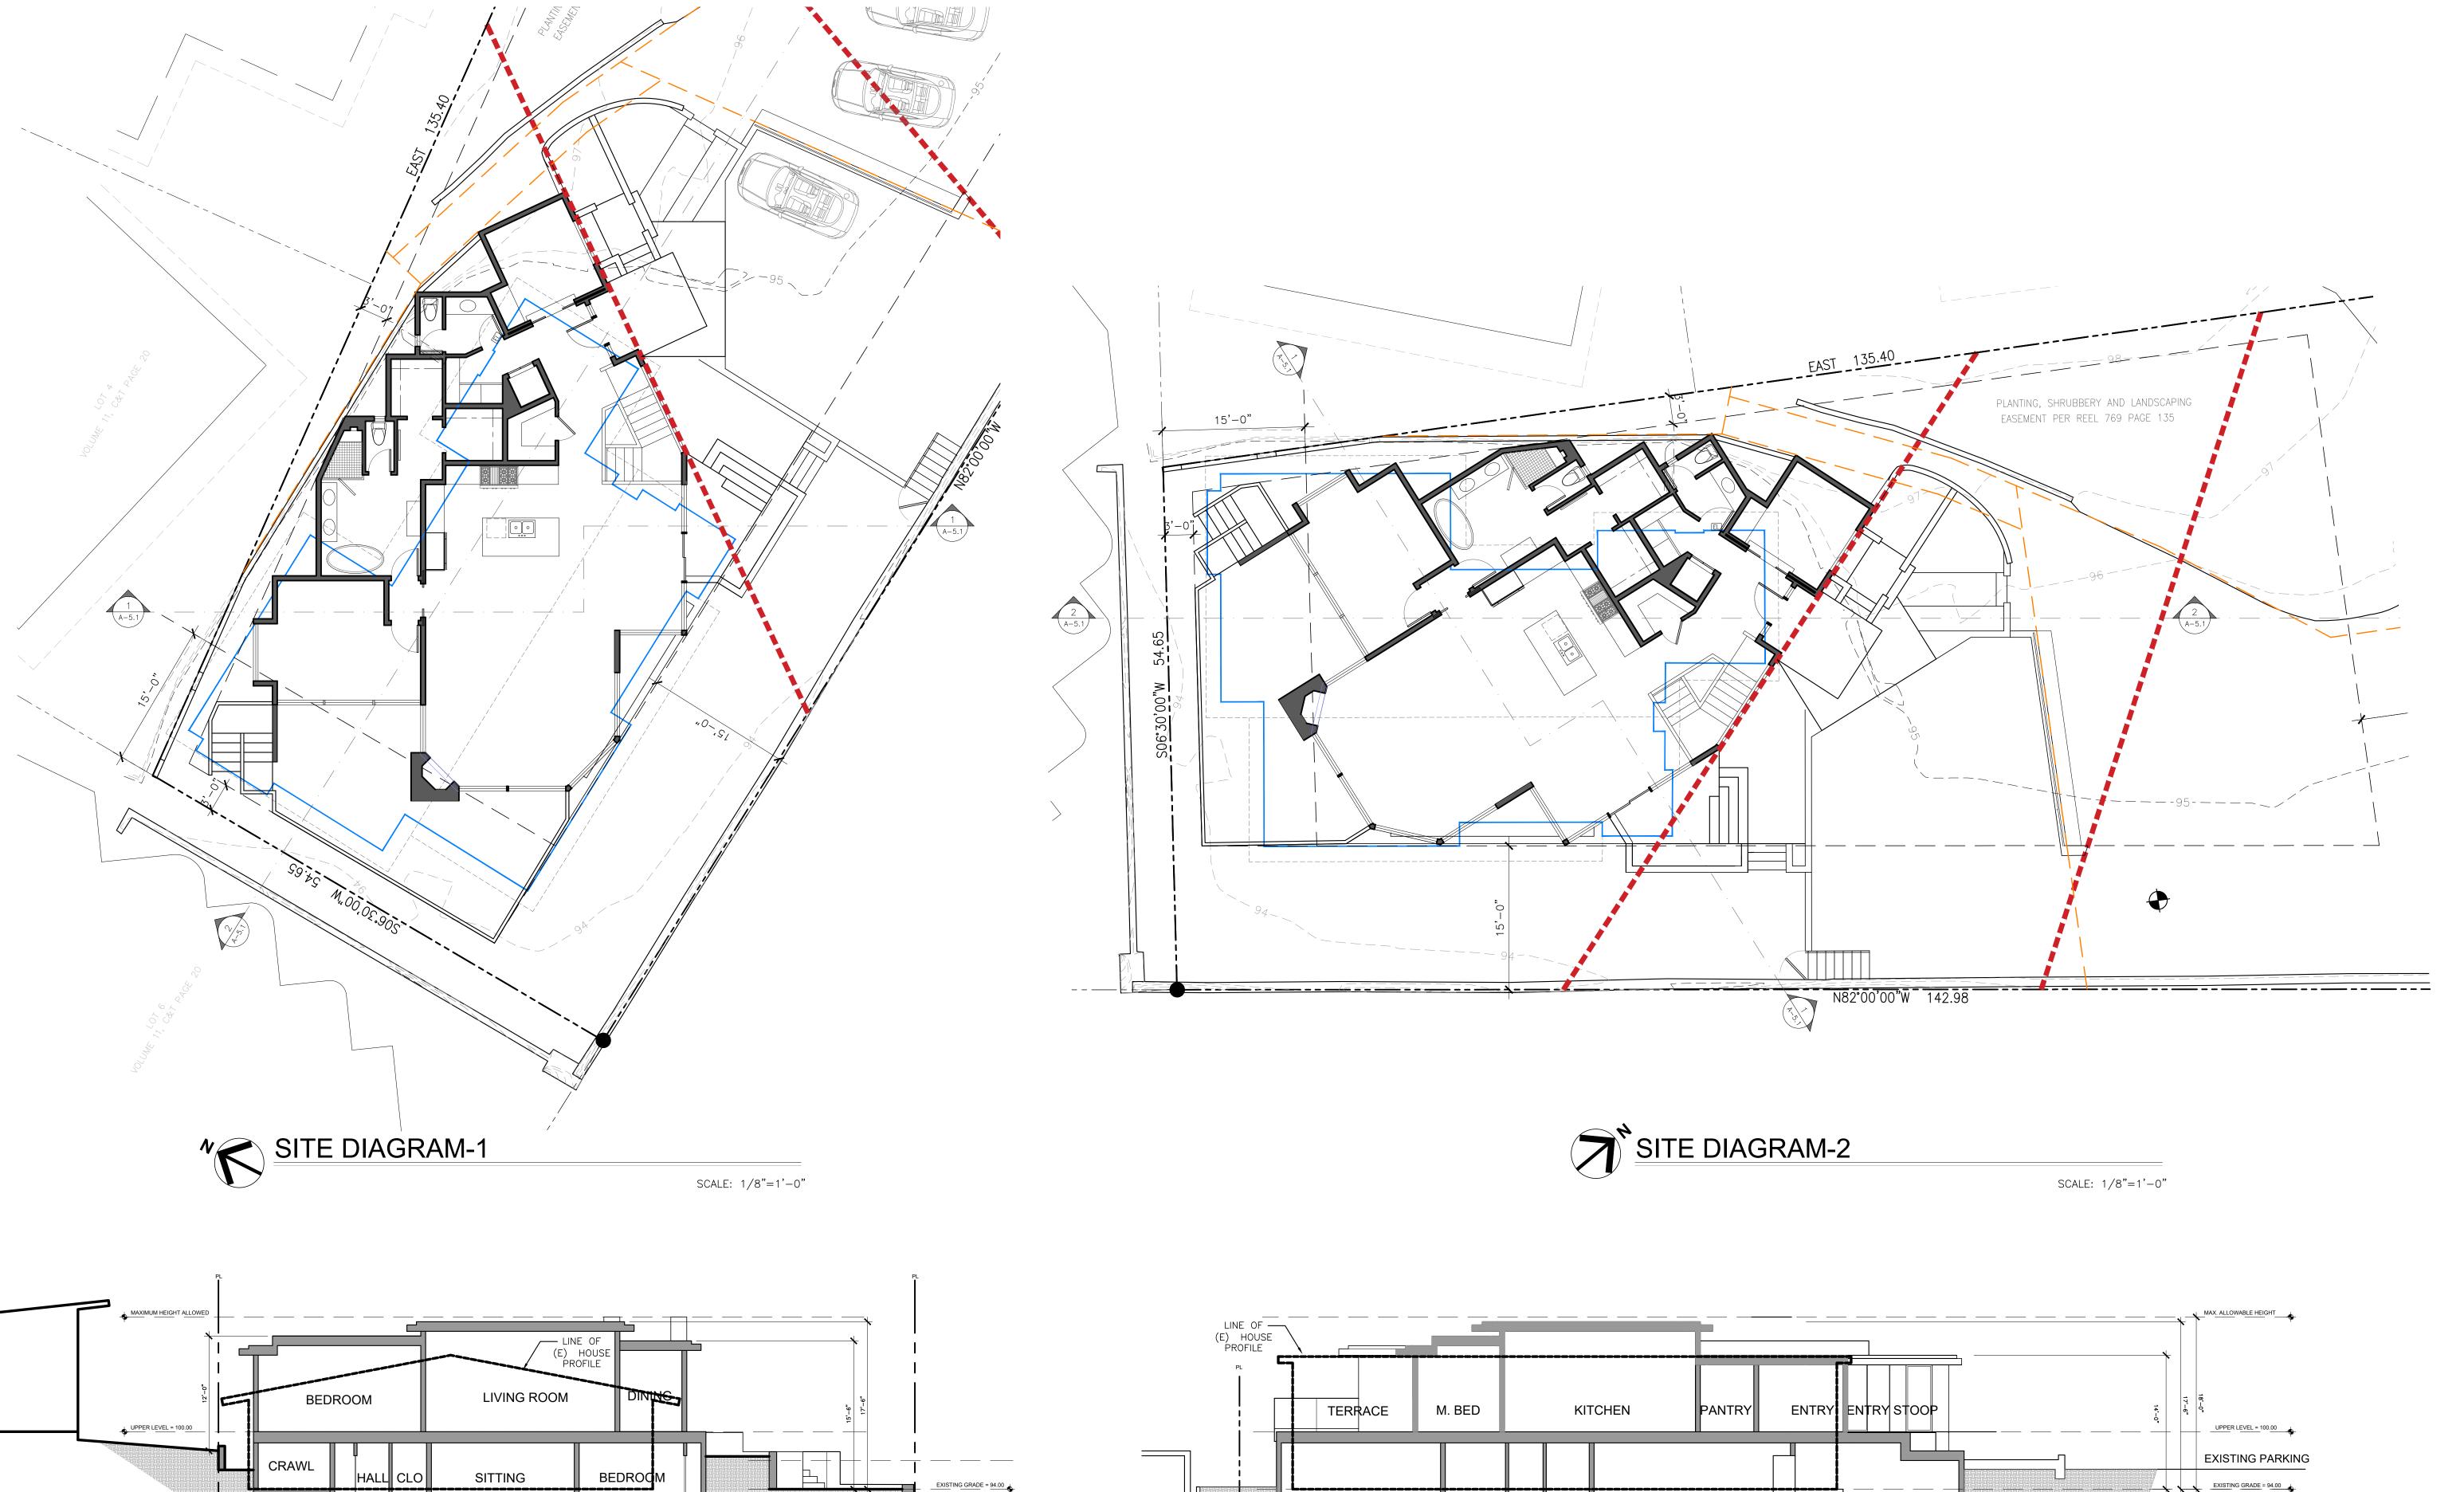

CLOS. BED 2 GALLERY GARAGE \_\_\_\_\_ LOWER LEVEL = 90.50 \_\_\_\_\_ GARAGE LEVEL = 87.00

SECTION 1-1

SCALE: 1/8"=1'-0"

SECTION 1-1

A-5.1 SCALE: 1/8"=1'-0"

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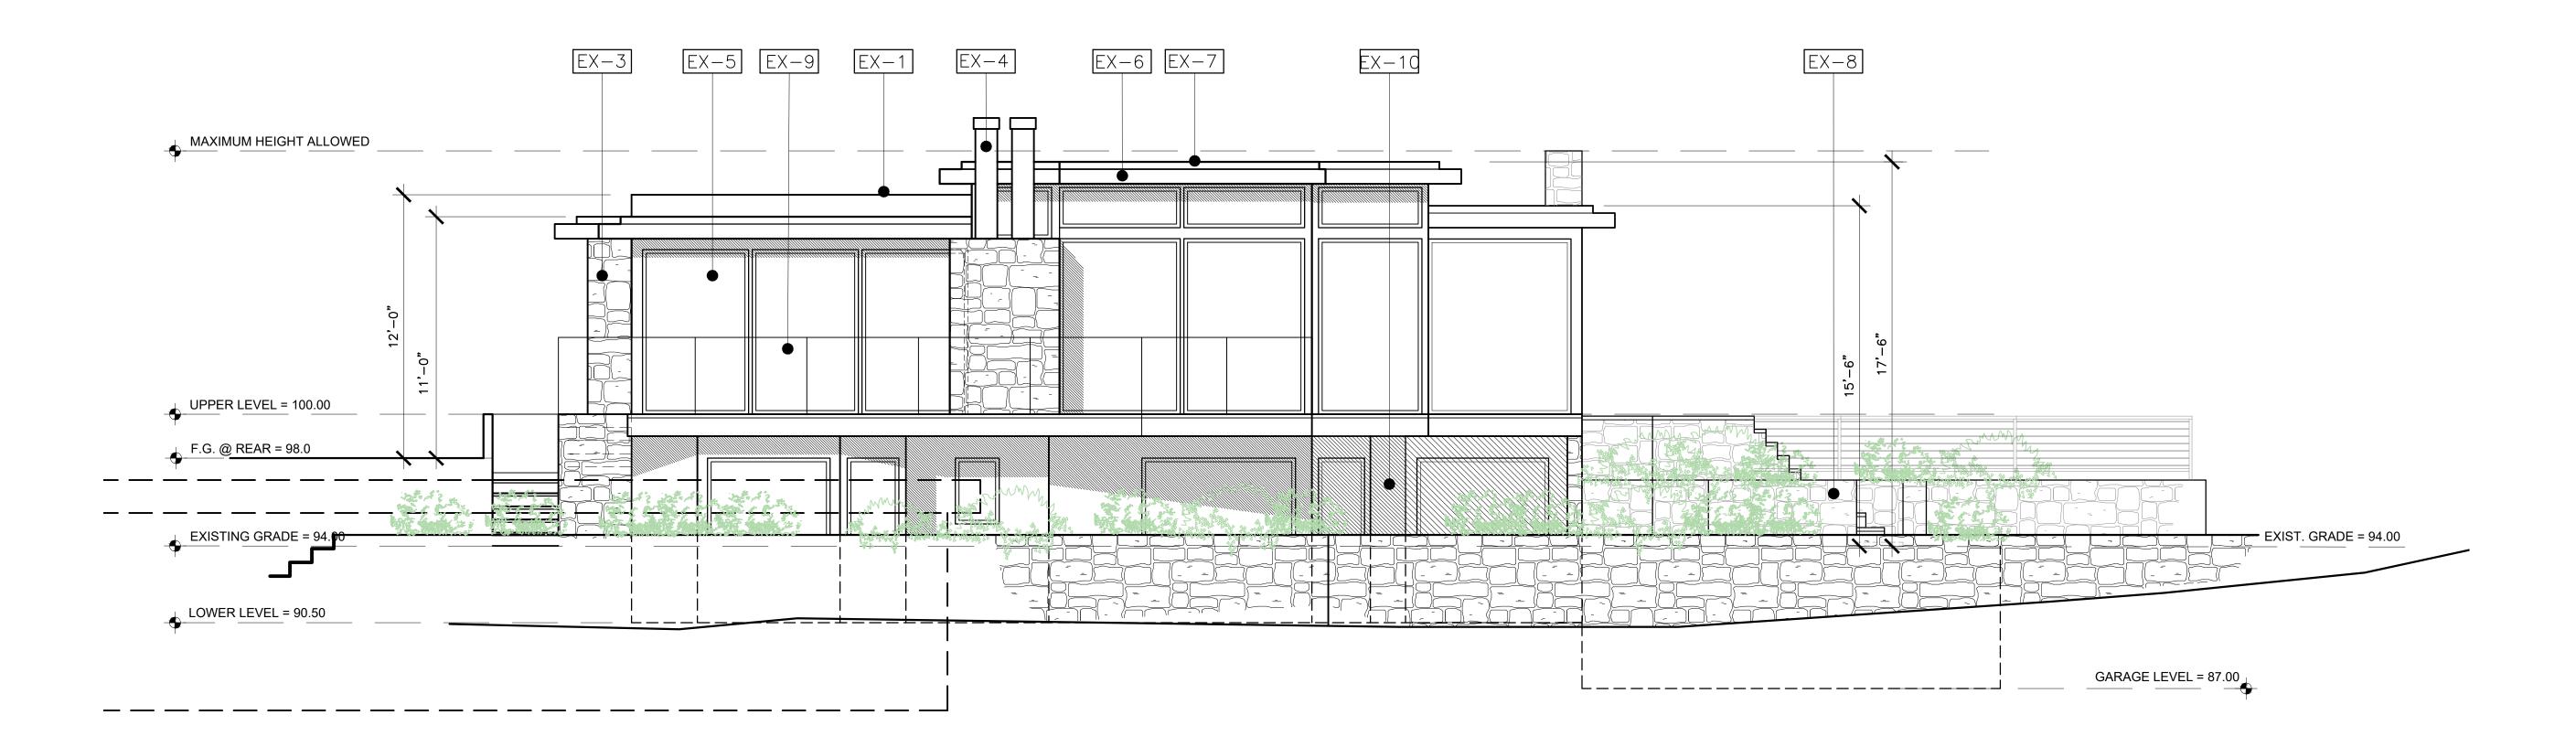
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BUILDING/SITE SECTION



### SOUTHWEST ELEVATION

SCALE: 1/4"=1'-0"



### **ELEVATION KEY NOTES**

EX-1 FLAT ROOF W/ 'GOLDEN' D.G. OVERLAY

EX-2 NATURAL CEDAR SIDING

EX-3 CARMEL STONE WALLS

EX-4 BRONZE CHIMNEY SHROUD

EX-5 wood doors & wiindows

EX-6 COPPER GUTTER & DOWNSPOUTS

EX-7 SOLID BODY STAINED WOOD FASCIA

EX-8 LANDSCAPE/RETAINING WALL STUCCO OR STONE

EX-9 TEMPERED GLASS RAILING

EX-10 INTEGRAL COLOR STUCCO

## SOUTHWEST PERSPECTIVE

SCALE: NONE



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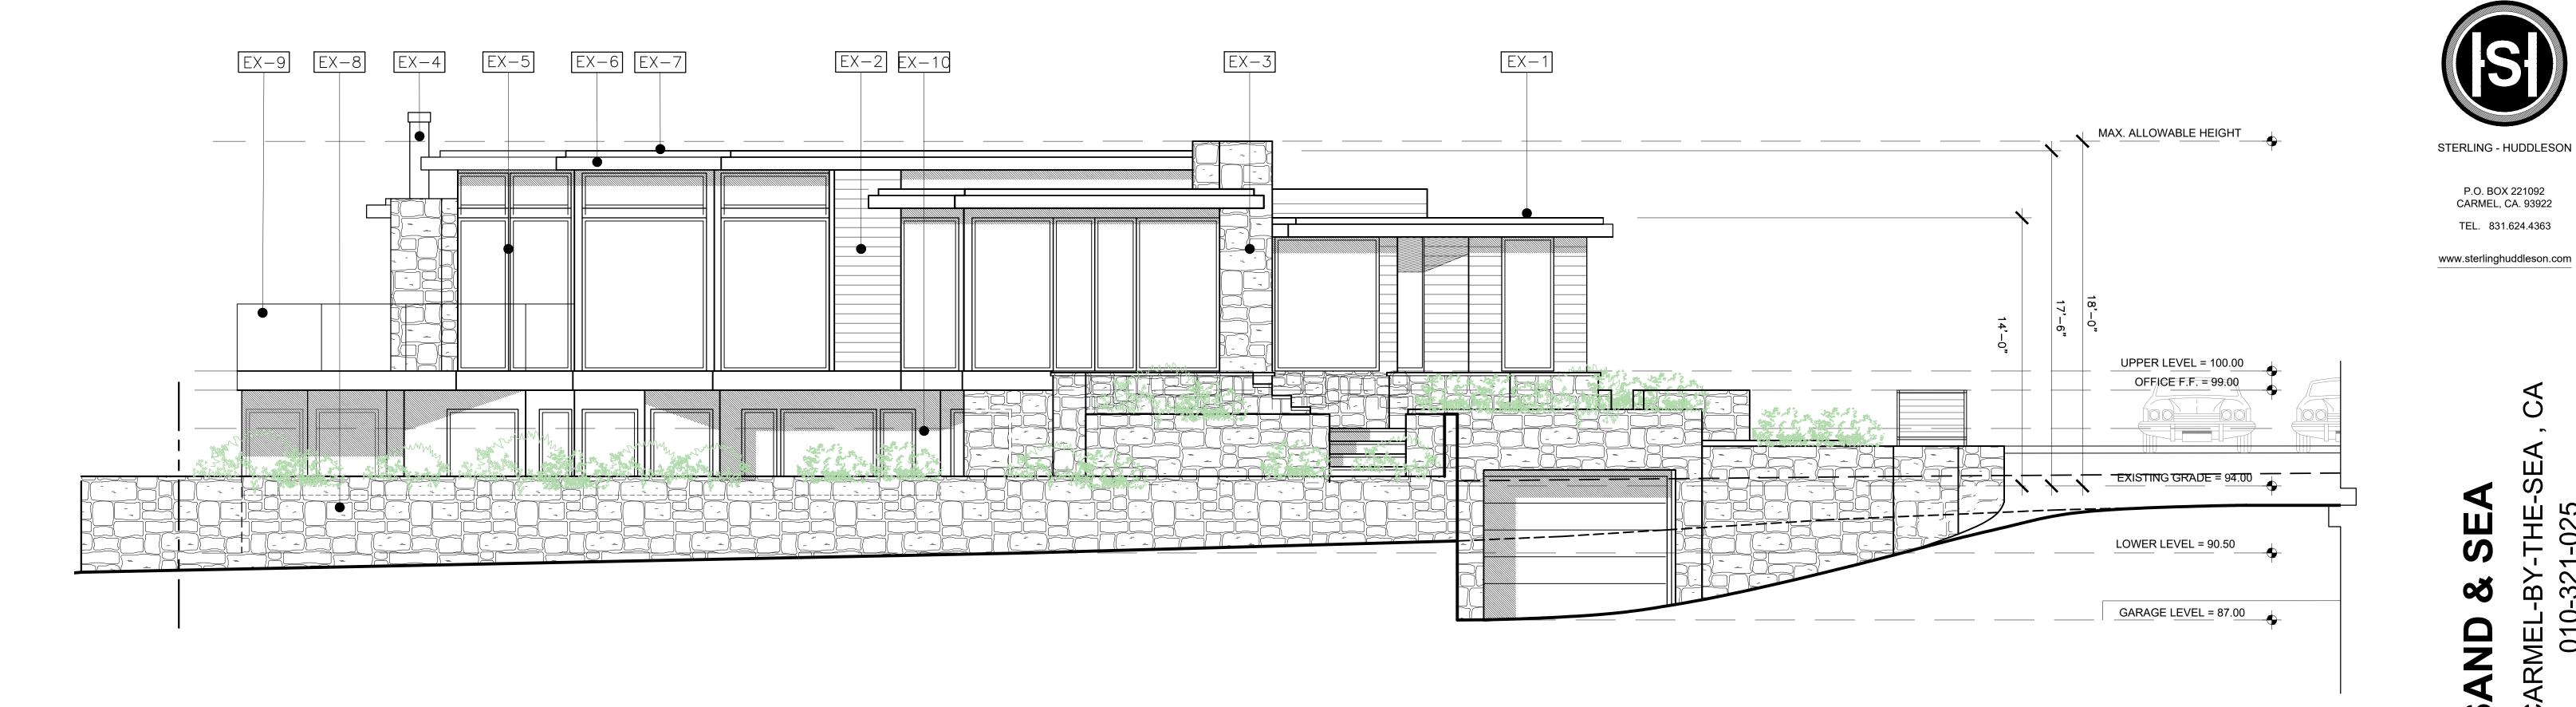
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Date: 03.05.19

Scale: 1/4"=1'-0"

Description: EXTERIOR ELEVATION

Sheet No: A-6.1





### SOUTH PERSPECTIVE

SCALE: NONE

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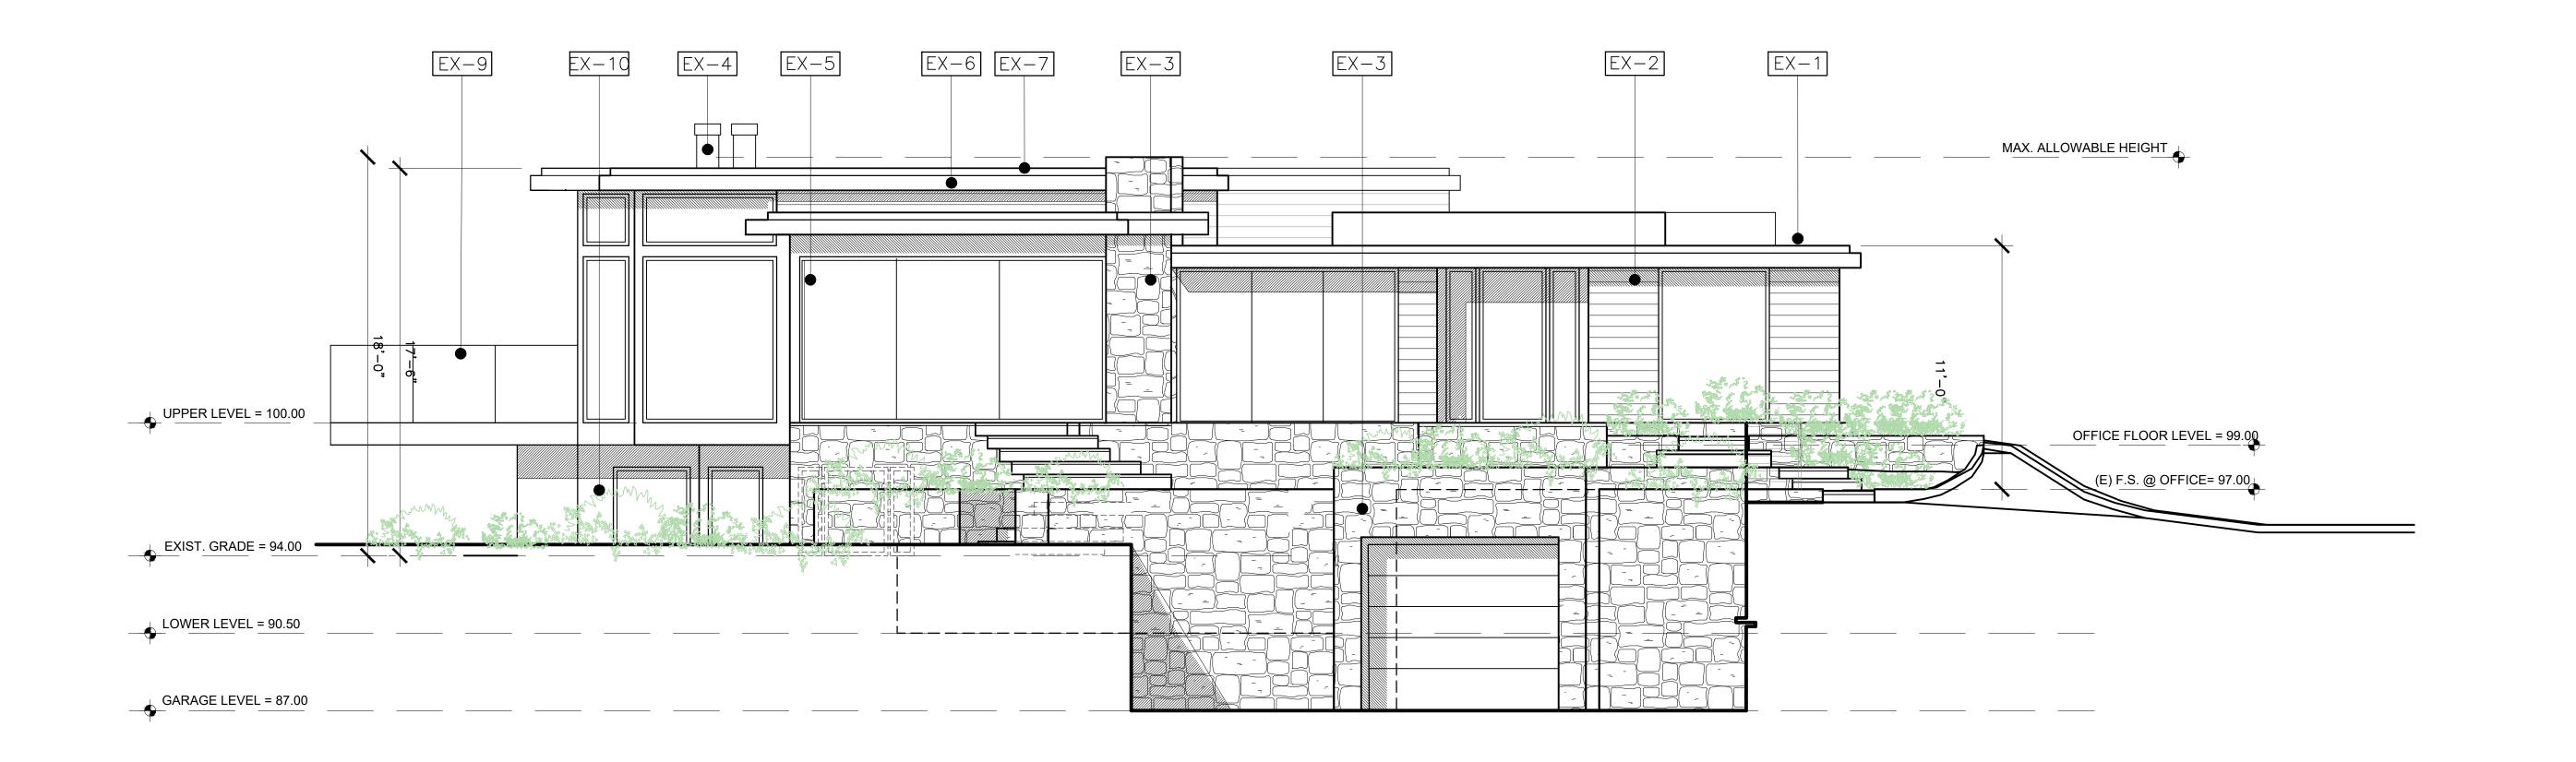
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Description:
EXTERIOR
ELEVATION


A-6.2



### SOUTHEAST ELEVATION

SCALE: 1/4"=1'-0"

SCALE: 1/4"=1'-0"

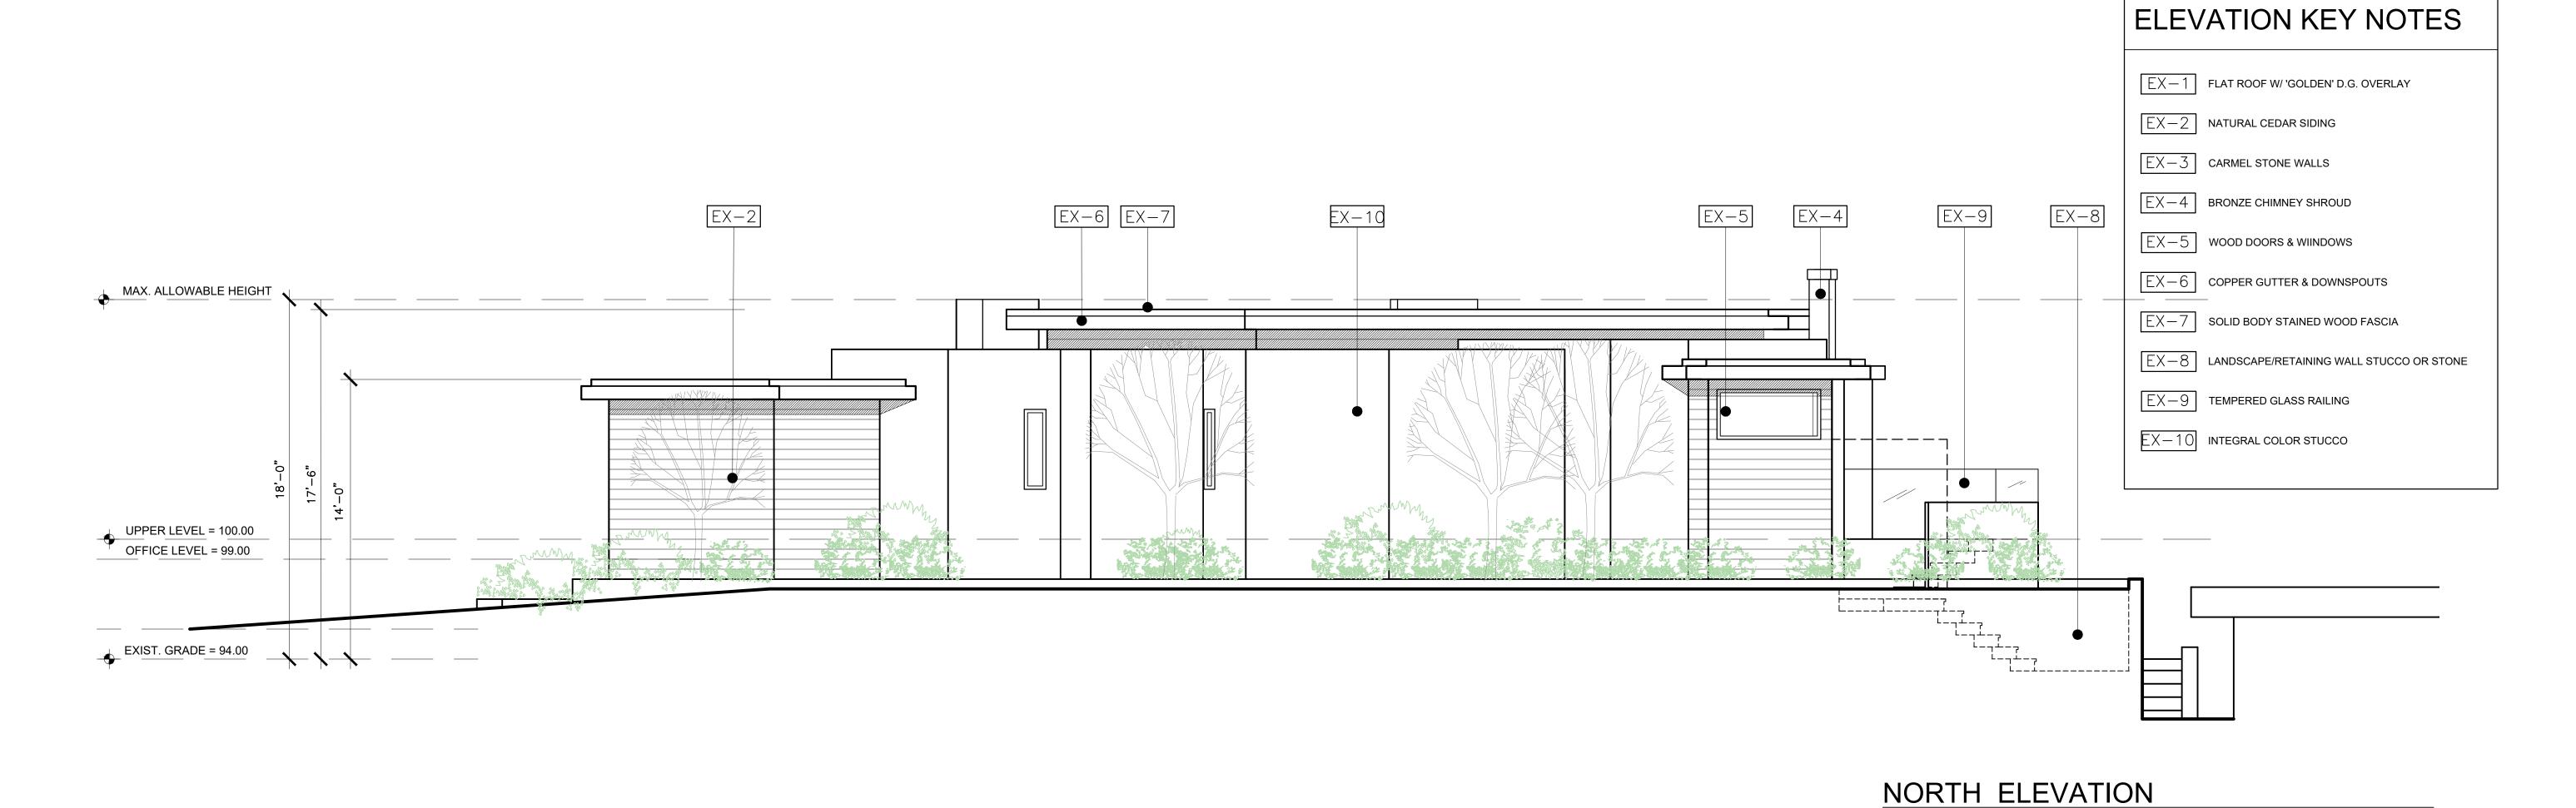

Scale: 1/4"=1'-0"

Description: EXTERIOR ELEVATION

Sheet No: A-6.3

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Date: 03.05.19


Drawn:

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Description:
BEACHSCAPI

Sheet No: **A-6.4** 



### BEACHSCAPE ELEVATION

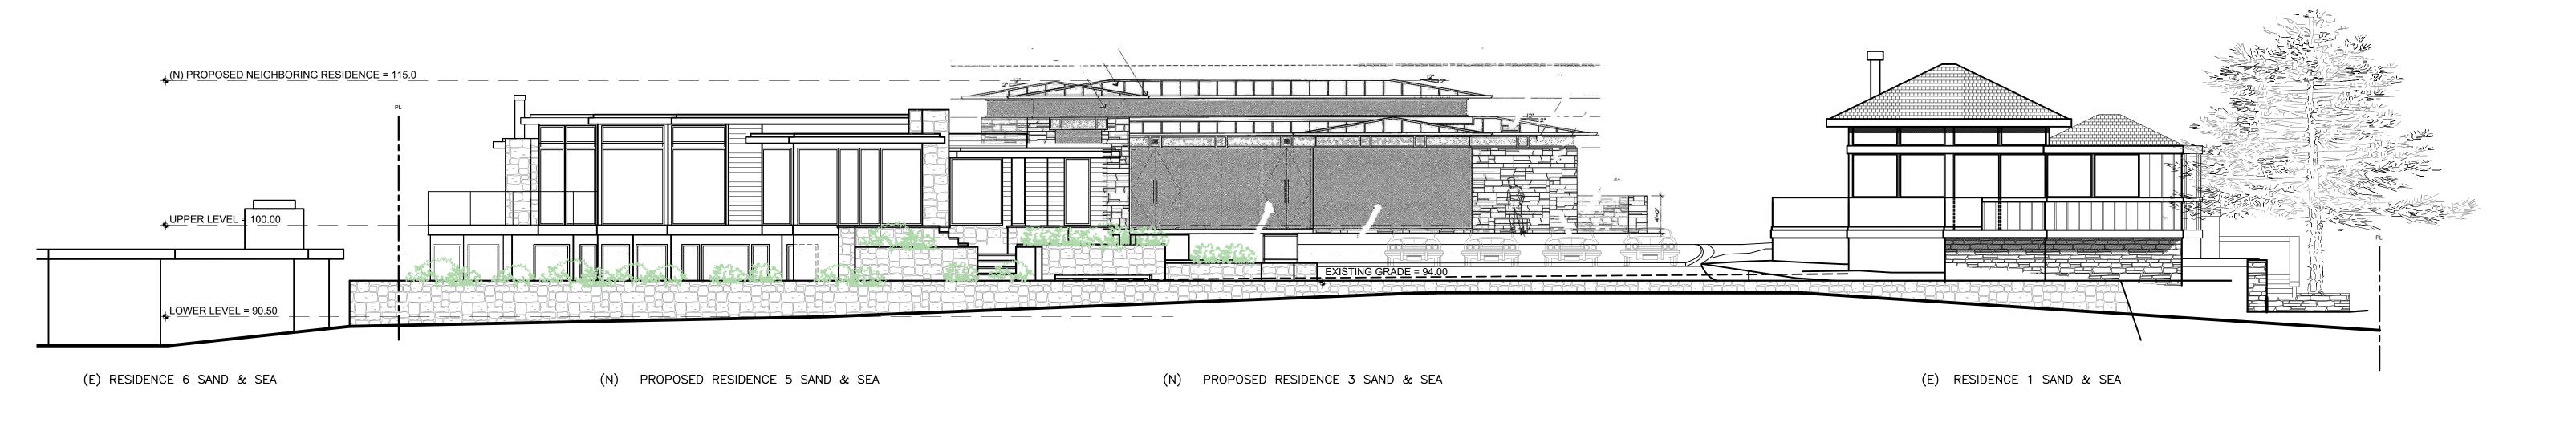SCALE: 1/8"=1'-0"



### BEACHSCAPE RENDERING

SCALE: NONE



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# SAND

Prepared by:

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Date: 03.05.19



# ELEVATION KEY NOTES

EX-1 FLAT ROOF W/ 'GOLDEN' D.G. OVERLAY

EX-2 NATURAL CEDAR SIDING

EX-3 CARMEL STONE WALLS

EX-4 BRONZE CHIMNEY SHROUD

EX-5 wood doors & wiindows

EX-6 COPPER GUTTER & DOWNSPOUTS


EX-7 SOLID BODY STAINED WOOD FASCIA

EX-8 LANDSCAPE/RETAINING WALL STUCCO OR STONE

EX-9 TEMPERED GLASS RAILING

EX-10 INTEGRAL COLOR STUCCO

EX-11 IRON GUARDRAIL

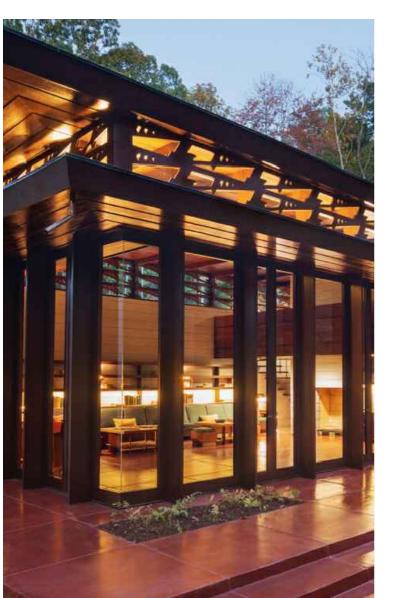

[EX-5]



[EX-7]



EX-9





EX - 11


[EX-3]

EX-2

EX-10 EX-8

Scale: NONE

Description: EXTERIOR MATERIALS

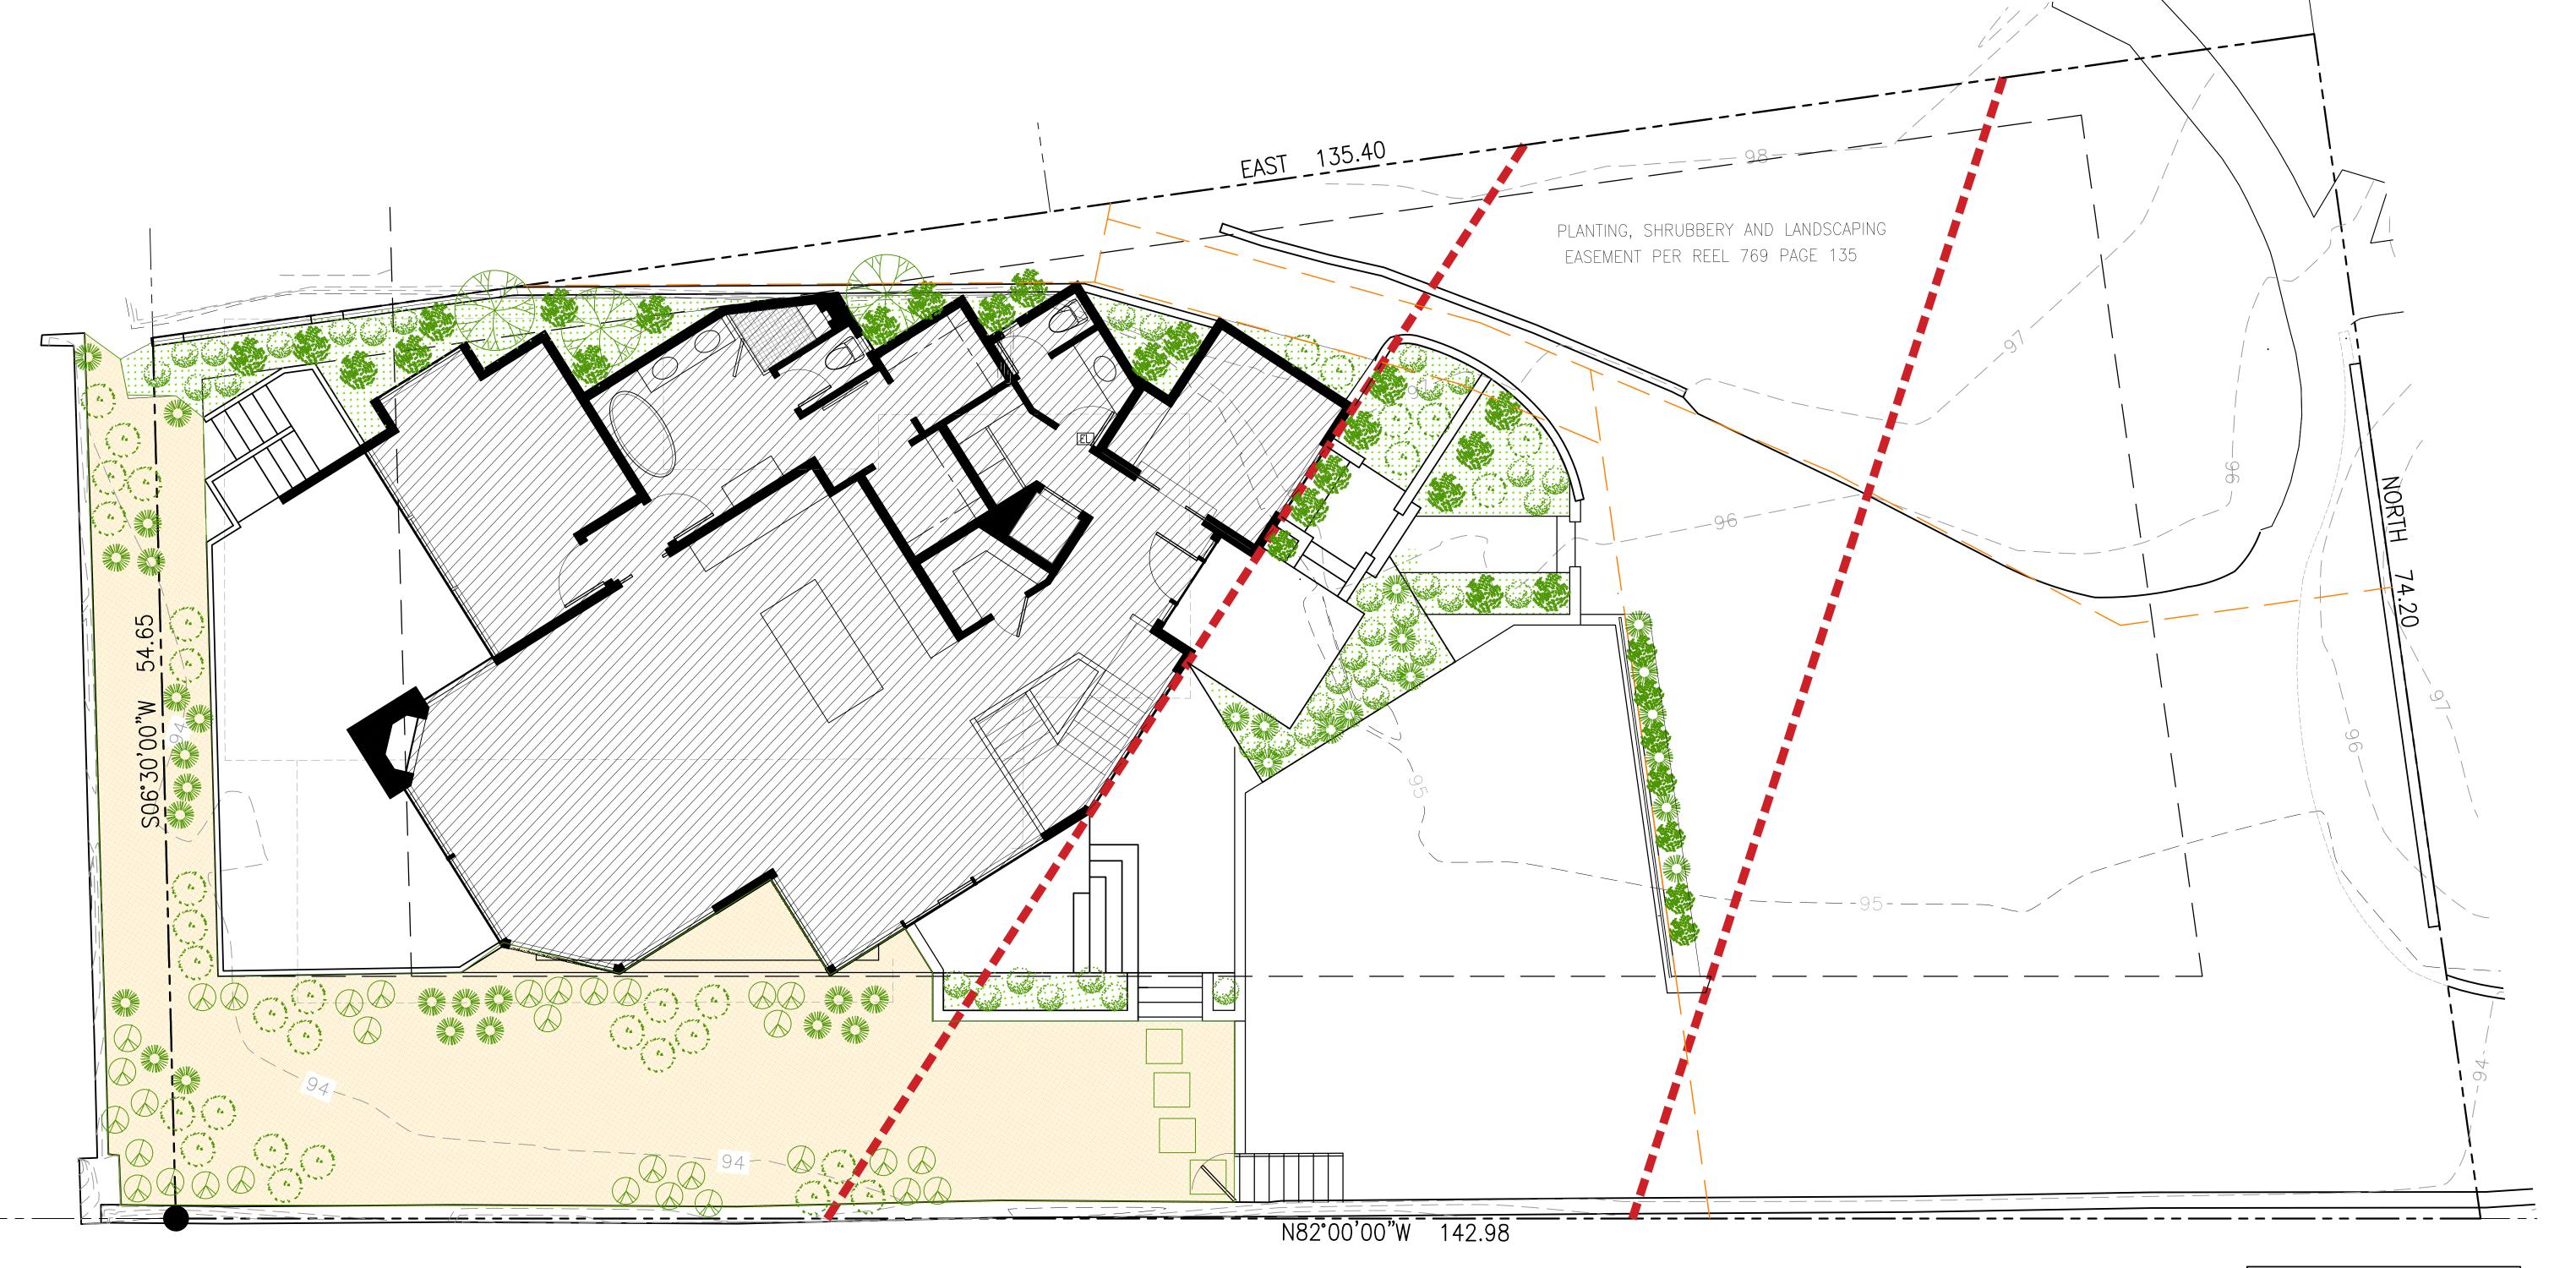



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Date: 03.05.19

Scale: 1/8"=1'-0" Drawn:

Description: LANDSCAPE PLAN

Sheet No: L-1.0



PLANT LEGEND

LARGE SHRUB:

PERENNIALS:

DUNES PLANT:

DUNES PLANT::

LEPTOSPERMUM LAEVIGATUM AUSTRALIAN TEA TREE

ERIGERON GLAUCUS SEASIDE DAISY

AGROSTIS PALLENS SEASIDE BENTGRASS

MORELLA CALIFORNICA PACIFIC WAX-MYRTLE

ERICAMERIA ERICOIDES

CEANOTHUS THYRSIFLORUS
CARMEL CEANOTHUS

SCALE: 1/8"=1'-0"

MOCK HEATHER


GROUNDCOVER:

ARCTOSTAPHYLOS 'CARMEL SUR'-MANZANITA FRAGARIA CHILOENSIS - NATIVE STRAWBERRY

DUNE RESTORATION







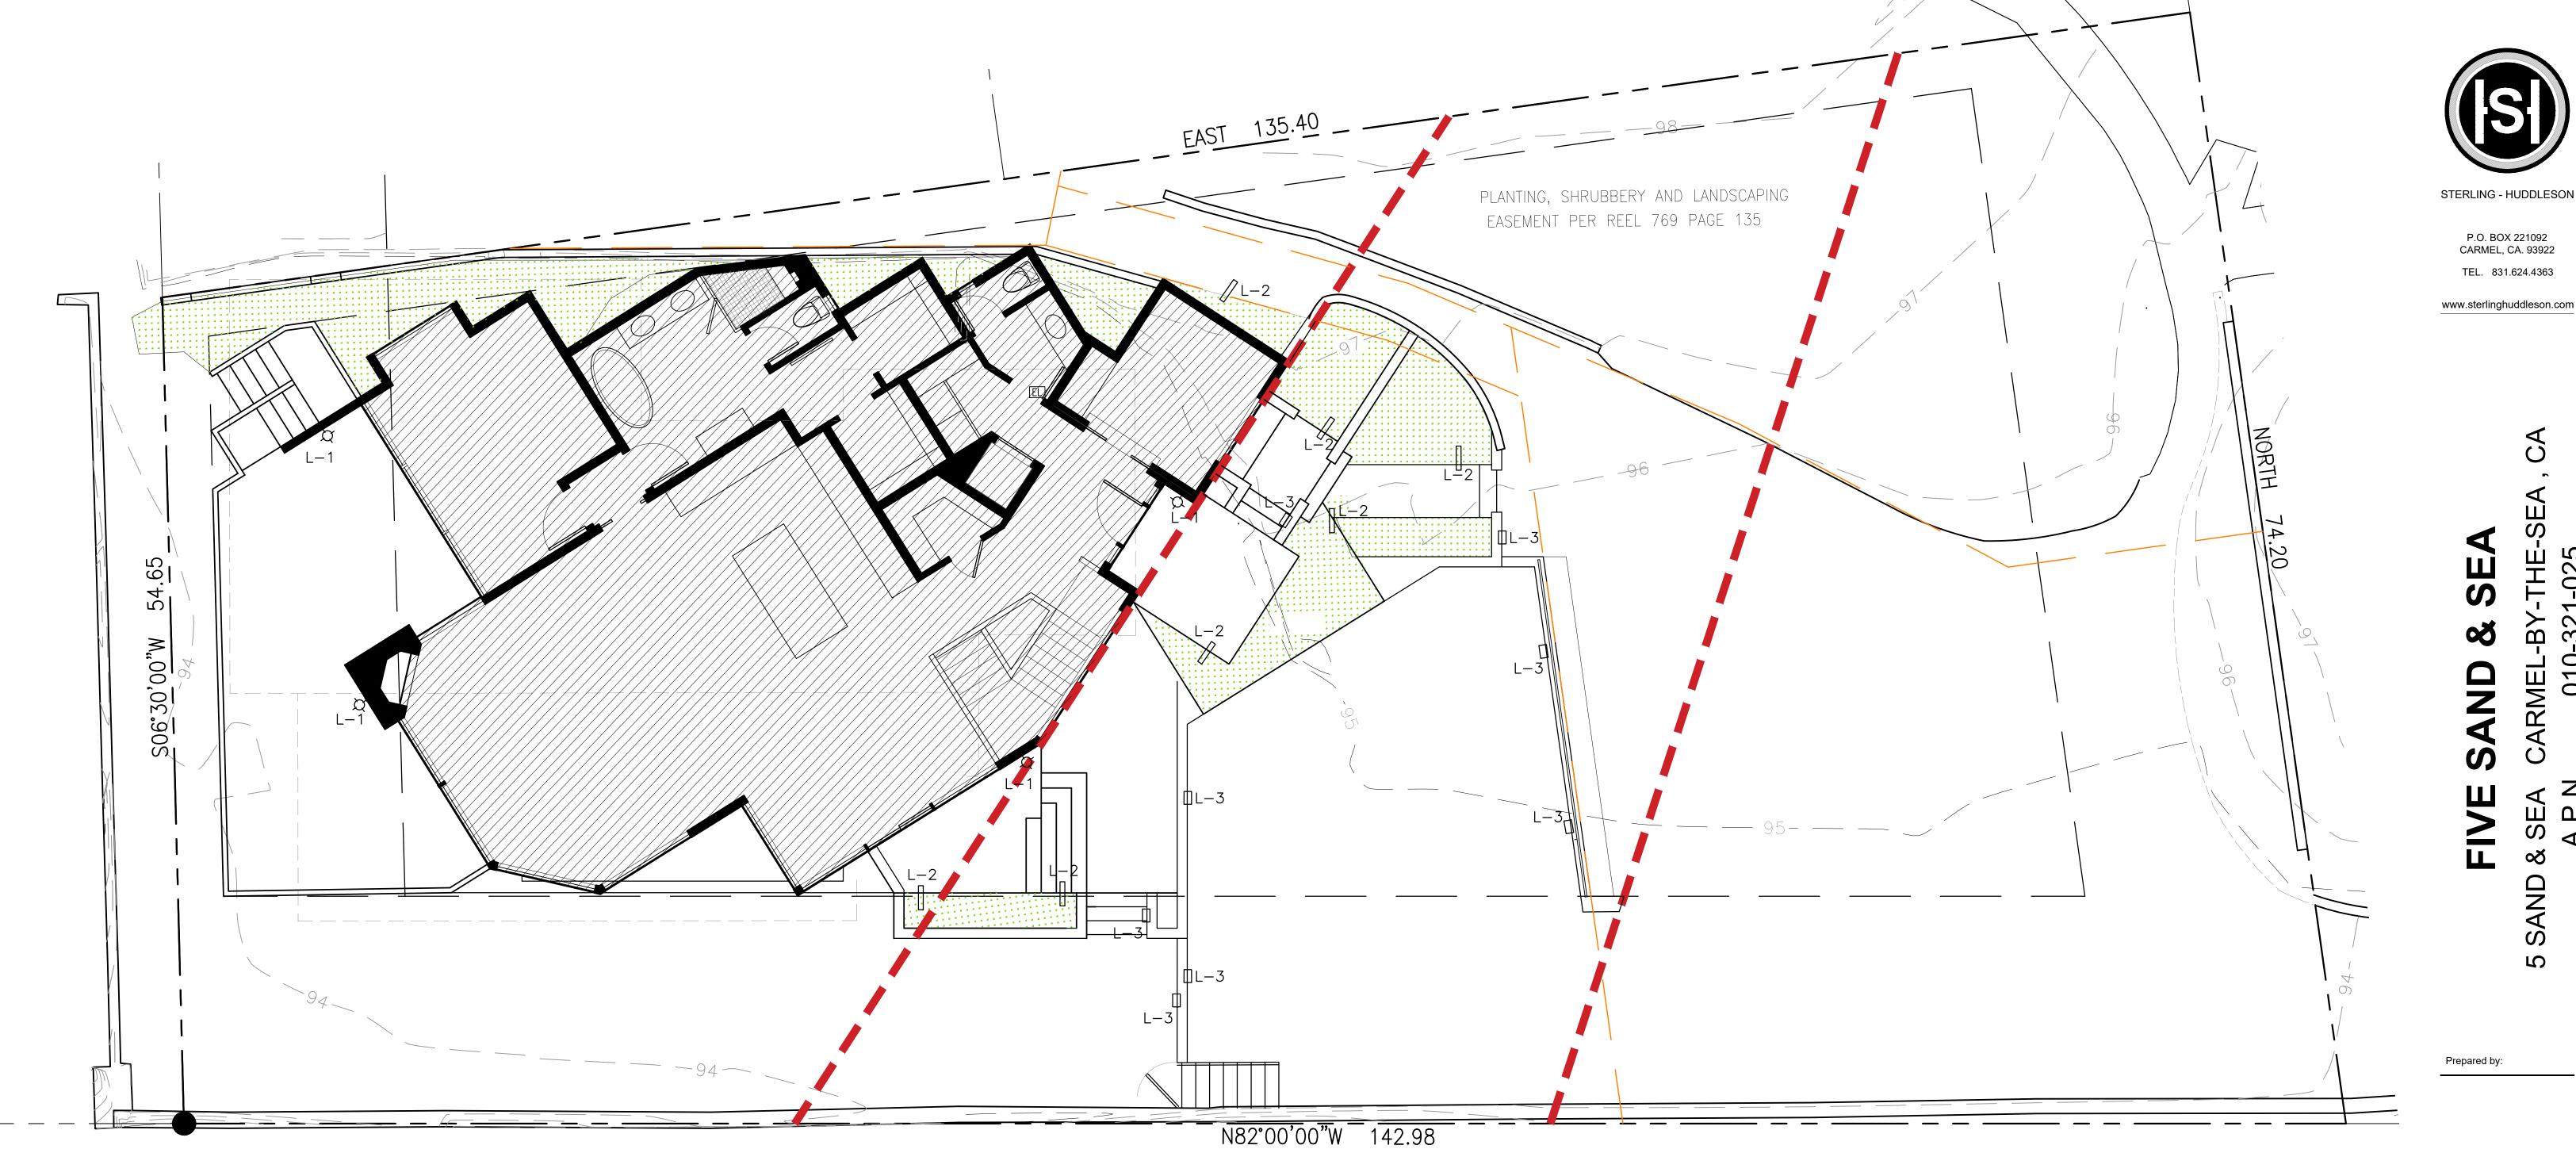



L-1 FIXTURE

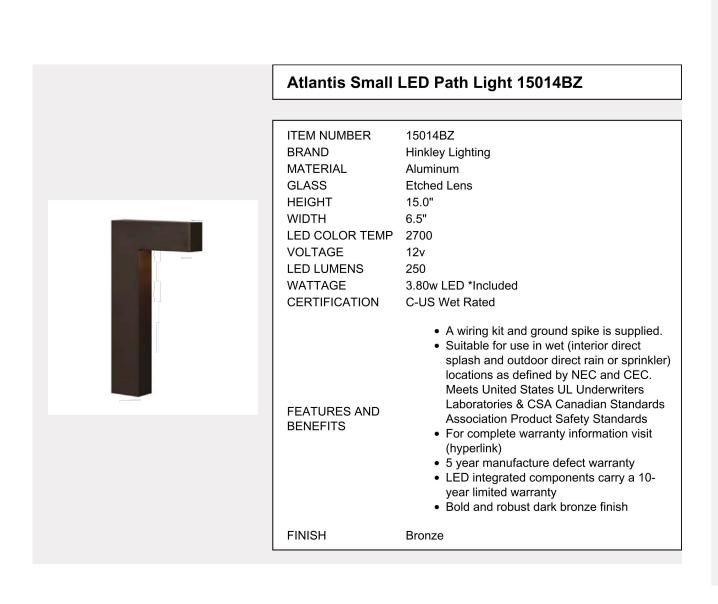

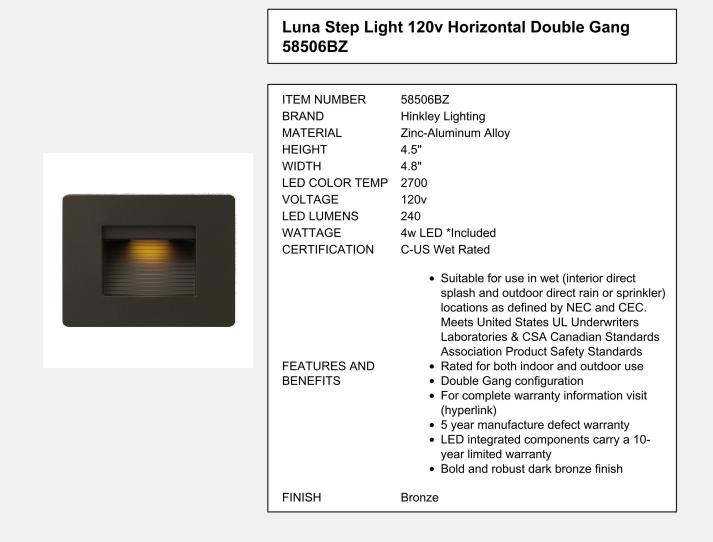

# LEGEND:

QTY.	SYM.	DESCRIPTION	
4	_ - - -	25 WATT MAX. INCANDESCENT WEATHERPROOF EXTERIOR WALL LIGHT	
7	L-2	15 WATT MAX. LOW VOLTAGE WATERPROOF PATH LIGHT	
8	L-3	15 WATT MAX. LOW VOLTAGE WATERPROOF STEP/WALL LIGHT	

### NOTE:

ALL EXTERIOR LIGHTING SHALL BE UNOBTRUSIVE, HARMONIOUS WITH THE LOCAL AREA CONSTRUCTED OR LOCATED SO THAT ONLY THE INTENDED AREA IS ILLUMINATED AND OFF-SITE GLARE IS FULLY CONTROLLED.

# PROPOSED EXTERIOR LIGHTING PLAN

L-2.0 SCALE: 1/8"=1'-0"

L-3 FIXTURE L-2 FIXTURE

S:\Client Files\NORTHPOINT\FIVE SAND SEA\DWG\1023.18 FIVE SAND AND SEA.dwg, 3/6/2019 11:44:43 AM

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Date: 01.03.19

Scale: 1/8"=1'-0" Drawn:

Description: EXTERIOR

LIGHTING PLAN Sheet No: