CITY OF CARMEL-BY-THE-SEA HISTORIC RESOURCES BOARD

HISTORIC RESOURCES BOARD RESOLUTION NO. 2025-001-HRB

A RESOLUTION OF THE HISTORIC RESOURCES BOARD OF THE CITY OF CARMEL-BY-THE-SEA ISSUING A DETERMINATION OF CONSISTENCY WITH THE SECRETARY OF THE INTERIOR'S STANDARDS FOR THE TREATMENT OF HISTORIC PROPERTIES FOR DESIGN STUDY APPLICATION 24276 (JOHNSON) FOR A 323-SQUARE-FOOT DETACHED GARAGE AND ASSOCIATED SITE IMPROVEMENTS AT THE HISTORIC "LAS ABUELAS" PROPERTY LOCATED AT THE NORTHWEST CORNER OF SAN CARLOS STREET AND SANTA LUCIA AVENUE IN THE SINGLE-FAMILY RESIDENTIAL (R-1) DISTRICT, APN: 010-165-044-000

WHEREAS, on September 11, 2024, Erik Dyar, Architect ("Applicant") submitted an application on behalf of Hal and Allison Johnson of FLYING J INTERESTS LP ("Owner") for the construction of a 323-square-foot detached garage and associated site improvements under Design Study DS 24276 (Johnson) described herein as ("Application"); and

WHEREAS, the Application has been submitted for the property located at the northwest corner of San Carlos Street and Santa Lucia Avenue in the Single-Family Residential (R-1) District (Block 143, Lot 35); and

WHEREAS, the project site contains a historic resource listed as "Las Abuelas" on the Carmel Inventory of Historic Resources; and

WHEREAS, the Applicant is proposing to construct a 323-square-foot detached garage at the northwest corner of the property; and

WHEREAS, the Applicant is also proposing site improvements including a stone-clad garden wall and new landscaping; and

WHEREAS, in accordance with CMC Section 17.32.040.A (Residential District Track One Design Review), exterior alterations and additions that do not increase the existing floor area by more than 10 percent are eligible for track one design review; and

WHEREAS, in accordance with CMC Section 17.32.140 (Determination of Consistency with the Secretary's Standards), all major and minor alterations to historic resources shall require a determination of consistency with the Secretary's Standards; and

WHEREAS, in accordance with CMC Section 17.32.160 (Historic Evaluation Process for Major Alterations), a major alteration includes a substantial alteration as defined in CMC 17.70.030 and additions exceeding two percent of the existing floor area or volume; and

WHEREAS, in accordance with CMC Section 17.32.160.B, a determination of consistency for major alterations shall be prepared by a qualified professional; and

WHEREAS, Margaret Clovis, a qualified professional, prepared a Phase Two Historic Assessment and found the project consistent with all applicable Secretary's Standards for Rehabilitation; and

WHEREAS, the proposed alterations would not compromise the integrity of the historic resource or result in a substantial modification that would render the resource ineligible for continued listing on the Carmel Inventory of Historic Resources; and

WHEREAS, on February 14, 2025, a notice of public hearing was published in the Carmel Pine Cone for the February 24, 2025, Historic Resources Board meeting in compliance with State law (California Government Code 65091) and mailed to owners of real property within a 300-foot radius of the project indicating the date and time of the public hearing; and

WHEREAS, on or before February 14, 2025, the Applicant posted the public notice on the project site and hand-delivered a copy of the public notice to each property within a 100-foot radius of the project site indicating the date and time of the public hearing; and

WHEREAS, on or before February 21, 2025, the meeting agenda was posted in three locations in compliance with State law indicating the date and time of the public hearing; and

WHEREAS, on February 24, 2025, the Historic Resources Board held a duly noticed public hearing to receive public testimony regarding the Application, including, without limitation, the information provided to the Board by City staff and through public testimony on the project; and

WHEREAS, this Resolution and its findings are made based upon the evidence presented to the Board at the hearing, including, without limitation, the staff report and attachments submitted by the Community Planning and Building Department; and

WHEREAS, the Historic Resources Board did hear and consider all said reports, attachments, recommendations, and testimony herein above set forth and used their independent judgment to evaluate the project; and

WHEREAS, the California Environmental Quality Act (California Public Resources Code §§ 21000, et seq., "CEQA"), together with State Guidelines (14 California Code Regulations §§ 15000, et seq., the "CEQA Guidelines") and City Environmental Regulations (CMC 17.60) require that certain projects be reviewed for environmental impacts and that environmental documents be prepared; and

WHEREAS, pursuant to CEQA regulations, the Application is "not be a project" pursuant to section 15378 of the CEQA Guidelines. The issuance of a determination of consistency does not

Resolution No. 2025-001-HRB Page 3 of 3

grant any permits or entitlements approving a project that would result in a direct or indirect physical change in the environment; and

WHEREAS, the facts set forth in the recitals are true and correct and are incorporated herein by reference.

NOW, THEREFORE, BE IT RESOLVED that the Historic Resources Board of the City of Carmel-By-The-Sea does hereby ADOPT a Determination of Consistency with the Secretary of the Interior's Standards for the Treatment of Historic Properties for Design Study Application 24276 (Johnson) for construction of a 323-square-foot detached garage and associated site improvements at the historic "Las Abuelas" property located at the northwest corner of San Carlos Street and Santa Lucia Avenue in the Single-Family Residential (R-1) District, APN: 010-165-044-000.

PASSED, APPROVED, AND ADOPTED BY THE HISTORIC RESOURCES BOARD OF THE CITY OF CARMEL-BY-THE-SEA this 24th day of February 2025, by the following vote:

APPROVED:	ATTEST:
ABSTAIN: Dyar	
ABSENT:	
NOES:	
AYES: Goodhue, Gualtieri, Pomeroy, Chr	roman



NOTICE OF APPROVAL

The Department of Community Planning & Building of the City of Carmel-by-the-Sea has approved a Project pursuant to the City's Municipal Code. Persons interested in the project may review additional materials available at the Department of Community Planning & Building located at City Hall on Monte Verde Street between Ocean and 7th Avenues, phone number 831-620-2010.

The decision to approve this project may be appealed within 10 days from the date of the
by filing a written appeal with the Department of Community Planning & Building.
Planning Case #: Design Study 24276
Owner Name: FLYING J INTERESTS LP
Case Planner: Katherine Wallace, Associate Planner
Date Posted:
Date Approved: 02/28/2025
Project Location: NW Corner of San Carlos and Santa Lucia
APN #: 010165044000 BLOCK/LOT: 143/35
Applicant: Erik Dyar, Architect
Project Description: This approval of Design Study (DS 24276, Johnson) authorizes a new 323-square-foot detached garage and site improvements at the "Las Abuelas" property, listed on the Carmel Historic Inventory and located at the northwest corner of San Carlos and Santa Lucia in the Single-Family Residential (R-1) District, APN 010165044000, as depicted in the plans drawn by Dyar Architecture, dated January 6, 2025, stamped approved February 28, 2025 and on file at the Community Planning and Building Department, unless modified by the conditions of approval contained herein. No changes are proposed to the main residence or guesthouse, and no trees are proposed for removal.
Can this project be appealed to the Coastal Commission? Yes □ No ✓

Upon completion of the 10 calendar-day appeal period, please return this form, along with the Affidavit of Posting, to the case planner noted above.

	CONDITIONS OF APPROVAL									
No.	Standard Conditions									
1.	Authorization. This approval of Design Study (DS 24276, Johnson) authorizes a new 323-square-foot detached garage and site improvements at the "Las Abuelas" property, listed on the Carmel Historic Inventory and located at the northwest corner of San Carlos and Santa Lucia in the Single-Family Residential (R-1) District, APN 010165044000, as depicted in the plans drawn by Dyar Architecture, dated January 6, 2025, stamped approved February 28, 2025 and on file at the Community Planning and Building Department, unless modified by the conditions of approval contained herein. No changes are proposed to the main residence or guesthouse, and no trees are proposed for removal.									
2.	Codes and Ordinances. The project shall be constructed in conformance with all requirements of the R-1 zoning district. All adopted building and fire codes shall be adhered to in preparing the working drawings. If any codes or ordinances require design elements to be changed, or if any other changes are requested when such plans are submitted, such changes may require additional environmental review and subsequent approval by the Planning Division.									
3.	Permit Validity. In accordance with CMC Section 17.52.170 (Time Limits on Approvals and Denials), a residential design study approval remains valid for a period of 12 months from the date of action. During this times, the project must be implemented, or the approval becomes void. Implementation is effected by erecting, installing, or beginning the installation of the improvement authorized by the permit, as determined by the Director. Extensions to this approval may be granted consistent with CMC 17.52.170.C.									
4.	Water Use. Approval of this application does not permit an increase in water use on the project site without adequate supply. Should the Monterey Peninsula Water Management District determine that adequate water is unavailable for this site, this permit will be scheduled for reconsideration, and appropriate findings will be prepared for review and adoption by the Planning Commission.									
5.	 Setback and Height Certifications. A State licensed surveyor shall survey and certify the following in writing: The footing locations are in conformance with the approved plans prior to footing/foundation inspection; The roof heights and plate heights of each building are in conformance with the approved plans prior to the roof sheathing inspection. Roofs and plates shall not exceed the elevation points as identified in the approved project plans, and the roofs include an appropriate allowance for roofing material thickness. Written certifications prepared, sealed, and signed by the surveyor shall be provided prior to footing/foundation inspection and roof sheathing inspection. In the event that multiple footing/foundation pours are required, a survey letter shall be submitted for each separate section. 									
6.	Service Laterals. Prior to final inspection, all electrical service laterals to any new building or structure, or to any building or structure being remodeled when such remodeling									

requires the relocation or replacement of the main service equipment, shall be placed underground on the premises upon which the building or structure is located. Undergrounding will not be required when the project valuation is less than \$200,000, or the City Forester determines that undergrounding will damage or destroy significant trees(s) (CMC 15.36.020).

- 7. **Utility Meter Locations.** The placement of all utility meters shall be consistent with the locations identified in the approved plans. Changes to the location of any utility meter location shall require written approval of the Community Planning and Building Department prior to the change of the location.
- 8. **Modifications.** The Applicant shall submit in writing, with revised plans, to the Community Planning and Building staff any proposed changes to the approved project plans prior to incorporating those changes. If the Applicant changes the project without first obtaining City approval, the Applicant will be required to submit the change in writing, with revised plans, within two weeks of the City being notified. A cease work order may be issued at any time at the discretion of the Director of Community Planning and Building until a) either the Planning Commission or Staff has approved the change, or b) the property owner has eliminated the change and submitted the proposed change in writing, with revised plans, for review. The project will be reviewed for its compliance with the approved plans prior to the final inspection.
- 9. **Exterior Revisions to Planning Approval Form.** All proposed modifications that affect the exterior appearance of the building or site elements shall be submitted on the "Revisions to Planning Approval" form on file in the Community Planning and Building Department. Any modification incorporated into the construction drawings not listed on this form shall not be deemed approved upon issuance of a building permit.
- 10. **Conflicts Between Planning Approvals and Construction Plans.** It shall be the responsibility of the Owner, Applicant, and Contractor(s) to ensure consistency between the project plans approved by the Planning Staff, the Planning Commission, or the City Council on appeal and the construction plans submitted to the Building Division as part of the Building Permit review. Where inconsistencies between the Planning approval and the construction plans exist, the Planning approval shall govern unless otherwise approved in writing by the Community Planning & Building Director or their designee.

When changes or modifications to the project are proposed, the Applicant shall clearly list and highlight each proposed change and bring each change to the City's attention. Changes to the project incorporated into the construction drawings that were not clearly listed or identified as a proposed change shall not be considered an approved change. Should conflicts exist between the originally approved project plans and the issued construction drawings that were not explicitly identified as a proposed change, the plans approved as part of the Planning Department Review, including any Conditions of Approval, shall prevail.

11. **Exterior Lighting.** Prior to the issuance of a building permit, the Applicant shall include in the construction drawings the manufacturer's specifications, including illumination information, for all exterior light fixtures. All fixtures shall be shielded and down-facing.

Exterior wall-mounted lighting shall be limited to 25 watts or less (incandescent equivalent or 375 lumens) per fixture and shall be installed no higher than 10 feet above the ground or walking surface.

Landscape lighting shall not exceed 18 inches above the ground nor more than 15 watts (incandescent equivalent or 225 lumens) per fixture and shall be spaced no closer than 10 feet apart. Landscape lighting shall not be used as accent lighting, nor shall it be used to illuminate trees, walls, or fences. The purpose of landscape lighting is to safely illuminate walkways and entrances to the subject property and outdoor living spaces.

- 12. Indemnification. The Applicant agrees, at his or her sole expense, to defend, indemnify, and hold harmless the City, its public officials, officers, employees, and assigns from any liability; and shall reimburse the City for any expense incurred, resulting from, or in connection with any project approvals. This includes any appeal, claim, suit, or other legal proceedings to attack, set aside, void, or annul any project approval. The City shall promptly notify the Applicant of any legal proceeding and cooperate fully in the defense. The City may, at its sole discretion, participate in any such legal action, but participation shall not relieve the Applicant of any obligation under this condition. Should any party bring any legal action in connection with this project, the Superior Court of the County of Monterey, California, shall be the situs and have jurisdiction for resolving all such actions by the parties hereto.
- 13. Cultural Resources. Throughout construction, all activities involving excavation shall immediately cease if cultural resources are discovered on the site, and the Applicant shall notify the Community Planning & Building Department within 24 hours. Work shall not be permitted to recommence until such resources are properly evaluated for significance by a qualified archaeologist. If the resources are determined to be significant, prior to the resumption of work, a mitigation and monitoring plan shall be prepared by a qualified archaeologist and reviewed and approved by the Community Planning and Building Director. In addition, if human remains are unearthed during the excavation, no further disturbance shall occur until the County Coroner has made the necessary findings regarding origin and distribution pursuant to California Public Resources Code (PRC) Section 5097.98.
- 14. **Truck Haul Route.** Prior to the issuance of a building permit, the Applicant shall submit for review and approval by the Community Planning & Building Director, in consultation with the Public Works and Public Safety Departments, a truck-haul route and any necessary traffic control measures for the grading activities. The Applicant shall be responsible for ensuring adherence to the truck-haul route and implementation of any required traffic control measures.

- 15. **USA North 811.** Prior to any excavation or digging, the Applicant shall contact the appropriate regional notification center (USA North 811) at least two working days, but not more than 14 calendar days, prior to commencing that excavation or digging. No digging or excavation is authorized to occur on-site until the Applicant has obtained a Ticket Number and all utility members have positively responded to the dig request. (Visit USANorth811.org for more information)
- 16. **Conditions of Approval.** Prior to the issuance of a building permit, the Applicant shall print a copy of the Conditions of Approval signed by the applicant and property owner(s) on a full-size sheet within the construction plan set submitted to the Building Safety Division.
- 17. **Conditions of Approval Acknowledgement.** Prior to the issuance of a building permit revision, a completed Conditions of Approval Acknowledgment form shall be included in the construction drawings. The form shall be signed by the Property Owner, Applicant, and Contractor prior to the issuance of a building permit.

Landscape Conditions

- 18. Landscape Plan Required. Prior to the issuance of a building permit, the Applicant shall submit a landscape plan for review and approval by the Community Planning & Building Department and the City Forester. The landscape plan shall be included in the construction drawings and will be reviewed for compliance with the landscaping standards contained in the Zoning Code, including, but not limited to, the following:
 - 1) All new landscaping shall be 75% drought-tolerant;
 - 2) Landscaped areas shall be irrigated by a drip/sprinkler system set on a timer; and
 - 3) The project shall meet the City's recommended tree density standards unless otherwise approved by the City based on on-site conditions.

The landscape plan shall identify the location where new trees will be planted when new trees are required to be planted by the City code, the Forest and Beach Commission, or the Planning Commission.

- 19. **Tree Removal Prohibited.** Throughout construction, the Applicant shall protect all trees identified for preservation by methods approved by the City Forester. Trees on or adjacent to the site shall only be removed upon the approval of the City Forester or Forest and Beach Commission.
- 20. **Tree Protection Measures.** Requirements for tree preservation shall adhere to the following tree protection measures on the construction site.
 - Prior to grading, excavation, or construction, the developer shall clearly tag or mark all trees to be preserved.
 - Excavation within 6 feet of a tree trunk is not permitted.
 - No attachments or wires of any kind, other than those of a protective nature, shall be attached to any tree.
 - Per Municipal Code Chapter 17.48.110, no material may be stored within the dripline of a protected tree, including the drip lines of trees on neighboring parcels.


- Tree Protection Zone. The Tree Protection Zone shall be equal to dripline or 18 inches radially from the tree for every one inch of trunk diameter at 4.5 feet above the soil line, whichever is greater. A minimum of 4-foot-high transparent fencing is required unless otherwise approved by the City Forester. Tree protection shall not be resized, modified, removed, or altered in any manner without written approval. The fencing must be maintained upright and taught for the duration of the project. No more than 4 inches of wood mulch shall be installed within the Tree Protection Zone. When the Tree Protection Zone is at or within the drip line, no less than 6 inches of wood mulch shall be installed 18 inches radially from the tree for every one inch of trunk diameter at 4.5 feet above the soil line outside of the fencing.
- Structural Root Zone. The Structural Root Zone shall be 6 feet from the trunk or 6 inches radially from the tree for every one inch of trunk diameter at 4.5' above the soil line, whichever is greater. Any excavation or changes to the grade shall be approved by the City Forester prior to work. Excavation within the Structural Root Zone shall be performed with a pneumatic excavator, hydro-vac at low pressure, or another method that does not sever roots.
- If roots greater than 2 inches in diameter or larger are encountered within the approved Structural Root Zone, the City Forester shall be contacted for approval to make any root cuts or alterations to structures to prevent roots from being damaged.
- If roots larger than 2 inches in diameter are cut without prior City Forester approval or any significant tree is endangered as a result of construction activity, the building permit will be suspended, and all work stopped until an investigation by the City Forester has been completed, and mitigation measures have been put in place.
- 21. **Foundation Work Near Significant Trees.** All foundations within 15 feet of significant trees shall be excavated by hand. If any tree roots larger than two inches (2") are encountered during construction, the City Forester shall be contacted before cutting the roots. The City Forester may require the roots to be bridged or may authorize the roots to be cut. If roots larger than two inches (2") in diameter are cut without prior City Forester approval or any significant tree is endangered as a result of construction activity, the building permit will be suspended and all work stopped until an investigation by the City Forester has been completed. Six inches (6") of mulch shall be evenly spread across the inside the dripline of all trees prior to the issuance of a building permit.


Environmental Compliance Conditions


Drainage Plan. Prior to the issuance of a building permit, the Applicant shall submit for review and approval by the Community Planning & Building and Public Works Departments a drainage plan that meets the requirements of the City's drainage guidance, SOG 17-07. At a minimum, new and replaced impervious area drainage must be dispersed around the site rather than focused on one corner of the property; infiltration features must be sized appropriately and located at least 6 feet from neighboring properties. The


Design Study 24276 (Johnson) Conditions of Approval February 28, 2025

	drainage plan shall include inform	ation on drainage from new i	mpervious areas and semi-								
	pervious areas.										
23.	BMP Tracking Form. Prior to issuance of a building permit, the Applicant shall submit fo										
	review and approval by the (ilding and Public Works								
	Departments a completed BMP T										
24.	Semi-Permeable Surfaces. Prior to issuance of a building permit, the Applicant shall submit										
	for review and approval by the	e Community Planning & B	uilding and Public Works								
	Departments cross-section details	Departments cross-section details for all semi-permeable surfaces.									
25.	Erosion and Sediment Control Plan. Prior to issuance of a building permit, the Applican										
	shall submit for review and appr	•	· ·								
	Works Departments an erosion a	and sediment control plan th	nat includes locations and								
	installation details for erosion an	id sediment control BMPs, m	naterial staging areas, and								
	stabilized access.										
	S	pecial Conditions									
26.	Copper Gutters & Downspouts Not Permitted. Prior to the issuance of a building permit,										
	the applicant shall submit a revised plan for review and approval by the Planning Divisi										
	identifying an alternative material for the gutters and downspouts.										
27.	Construction Management Plan. Prior to the issuance of a building permit, the Applicant										
	shall submit a Construction Management Plan for review and approval by the Community										
	Planning & Building Director.										
Ackno	owledgment and acceptance of con	ditions of approval:									
Appli	cant Signature	Printed Name	Date								
Prope	erty Owner Signature	Printed Name	 Date								
	,		Date								

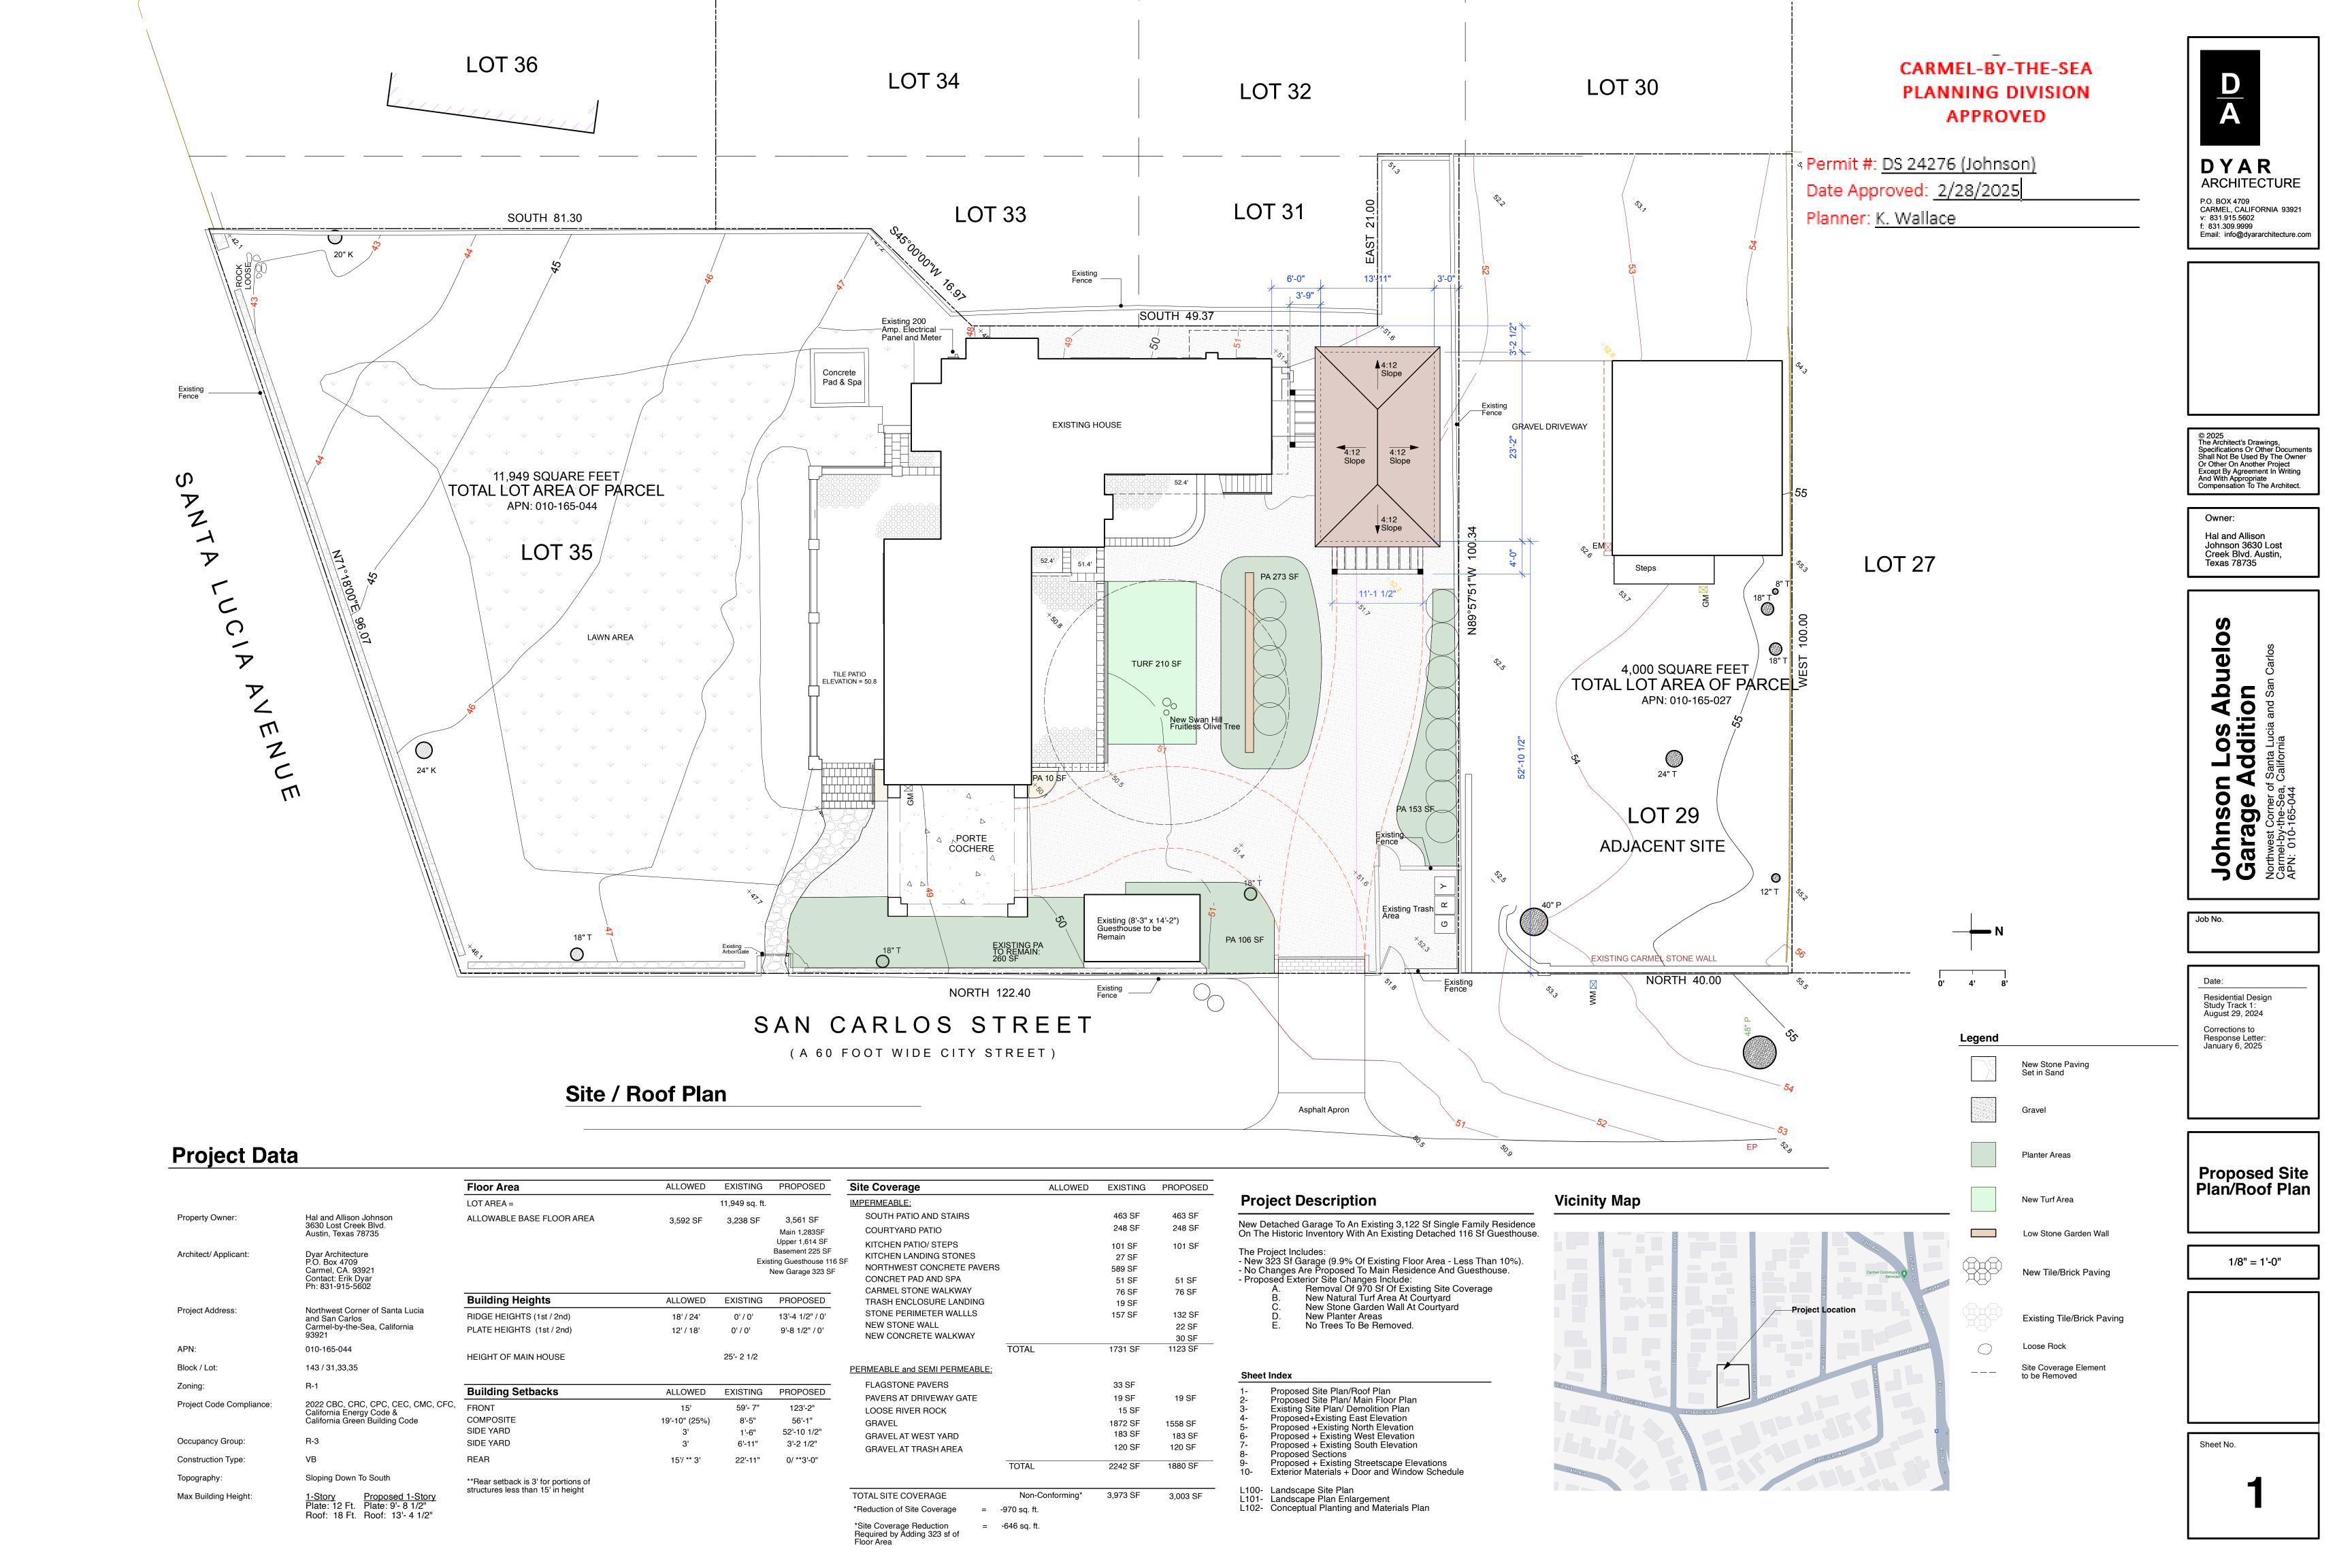

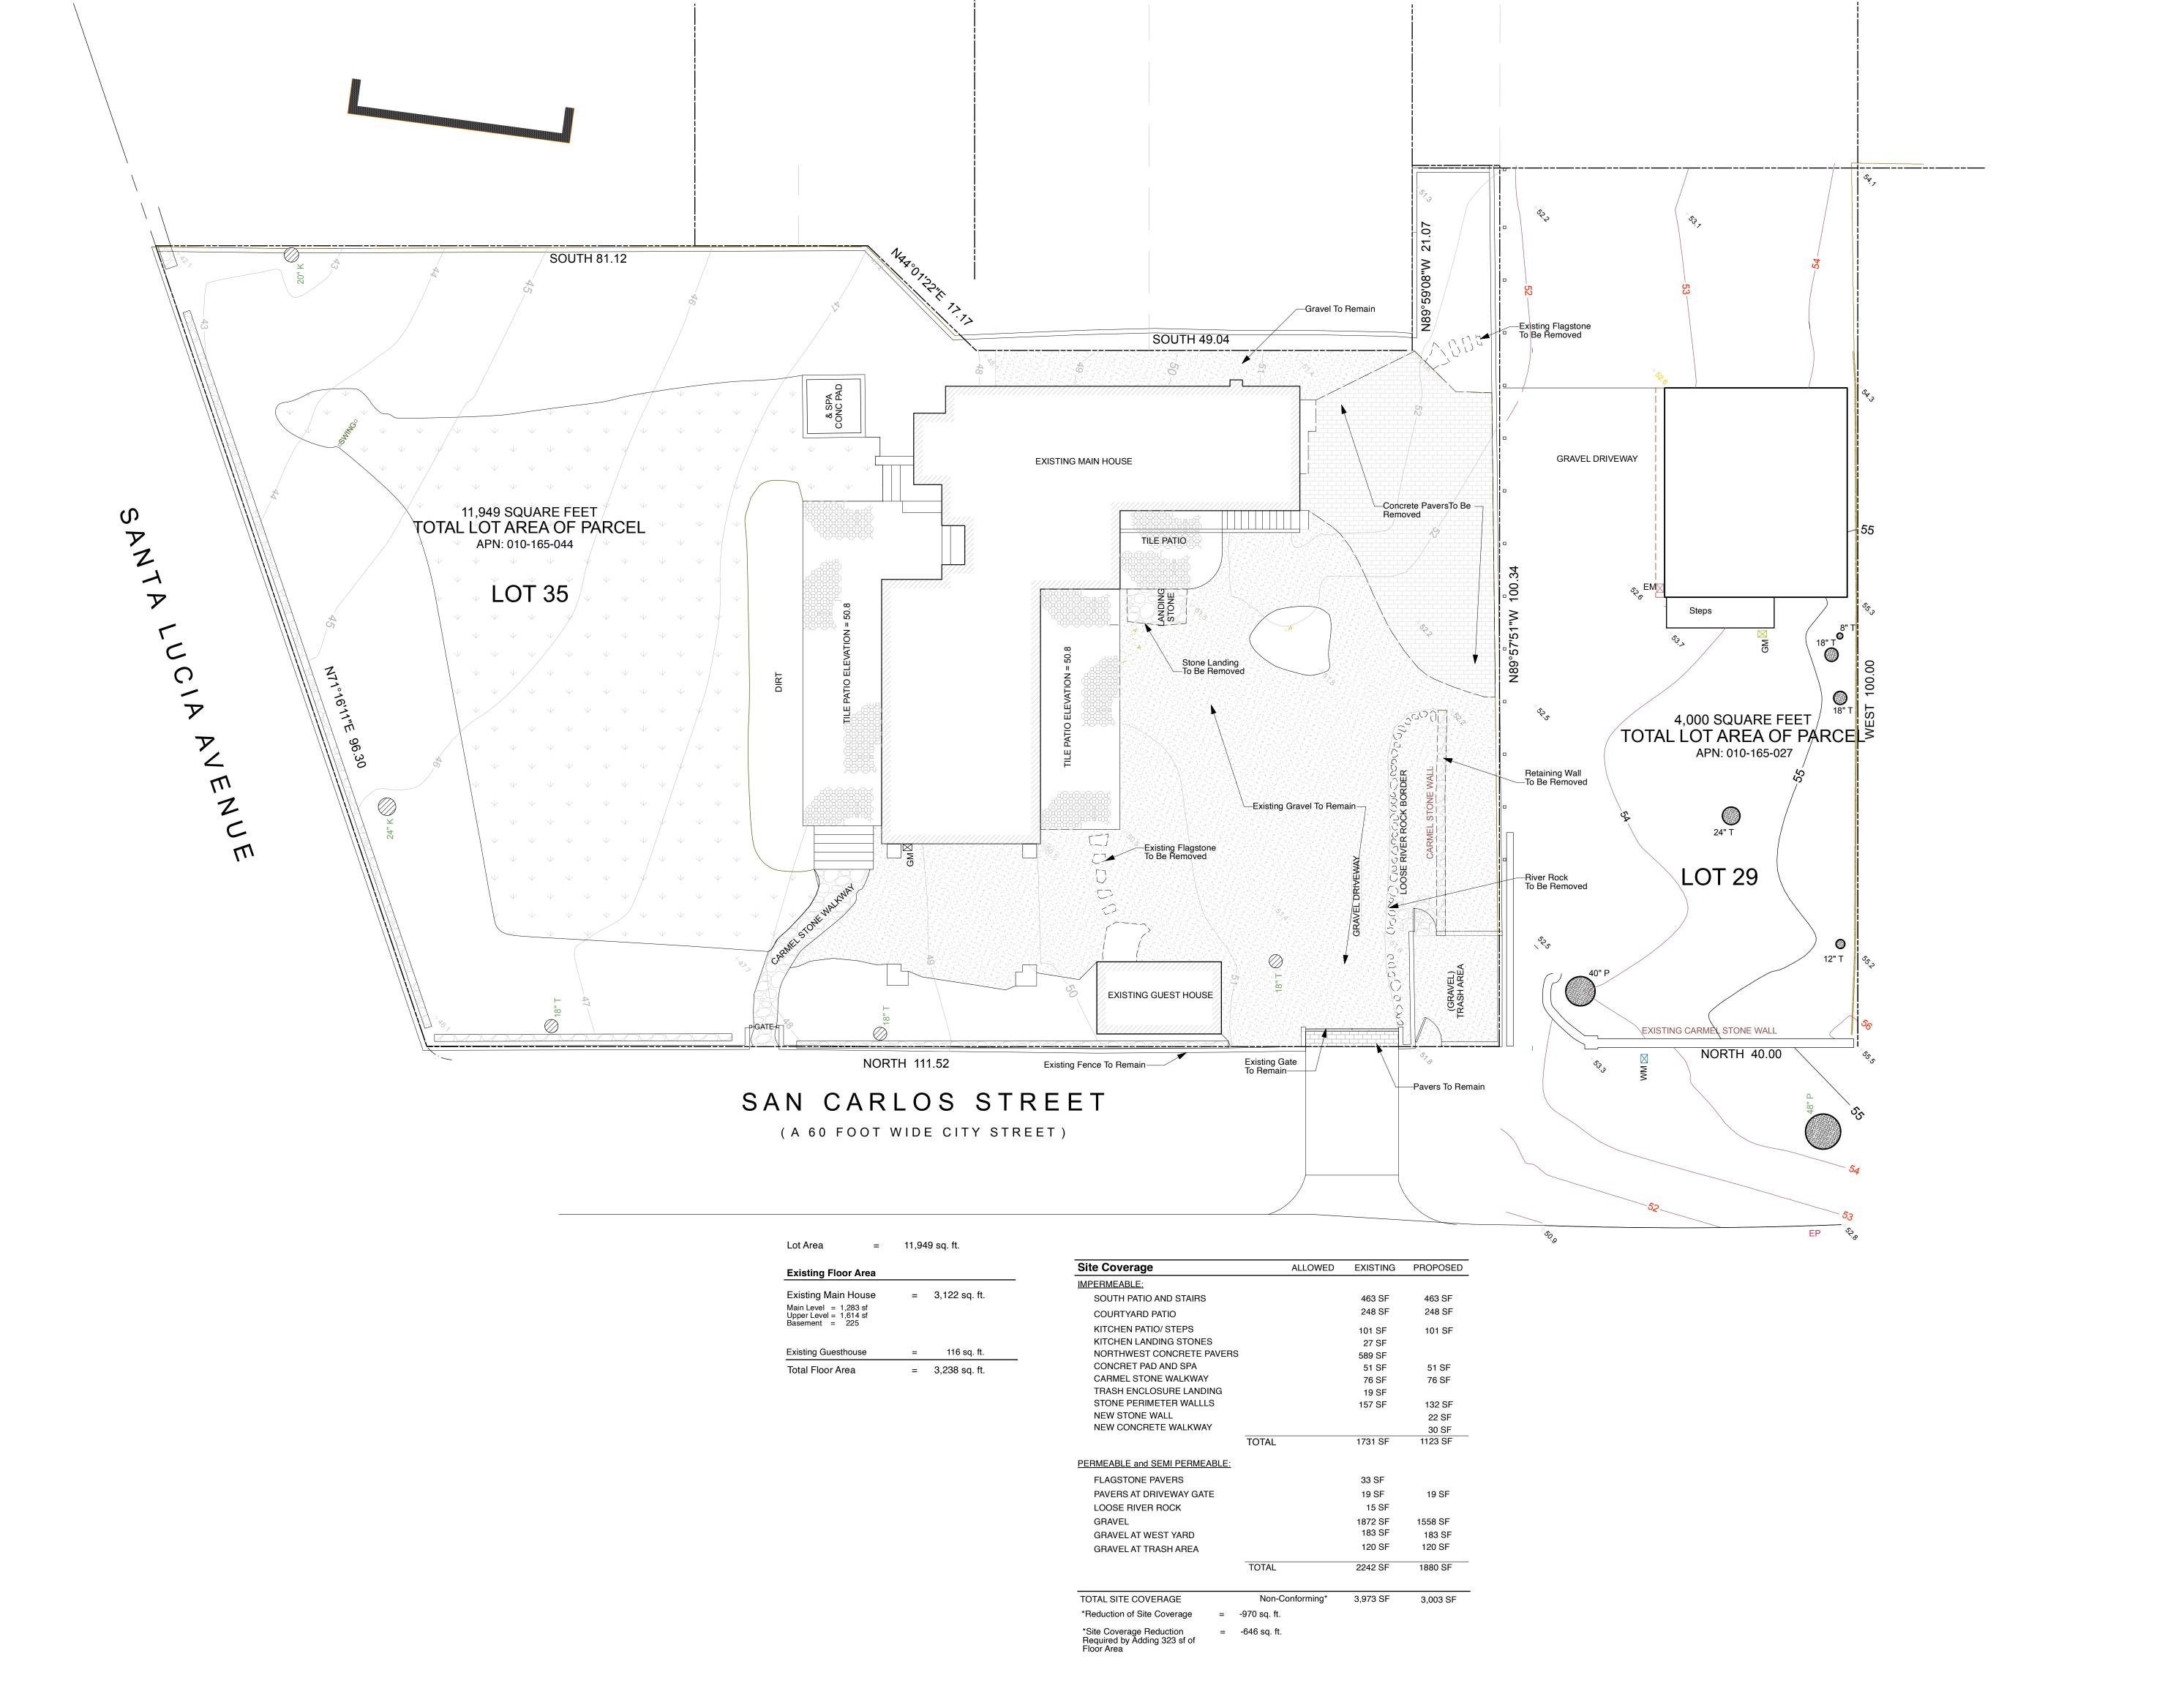

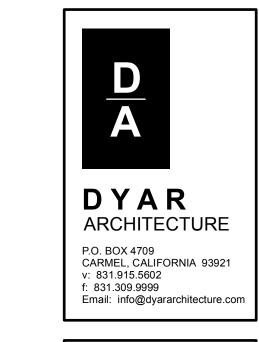

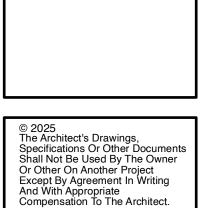

Owner:
Hal and Allison
Johnson 3630 Lost
Creek Blvd. Austin,
Texas 78735

Johnson Los Abuelo Garage Addition Northwest Corner of Santa Lucia and San Carlos Carmel-by-the-Sea, California APN: 010-165-044

Job No.

Date:


Residential Design
Study Track 1:
August 29, 2024

Corrections to
Response Letter:
January 6, 2025

Existing + Demolition Site Plan

1/8" = 1'-0"

Sheet No.

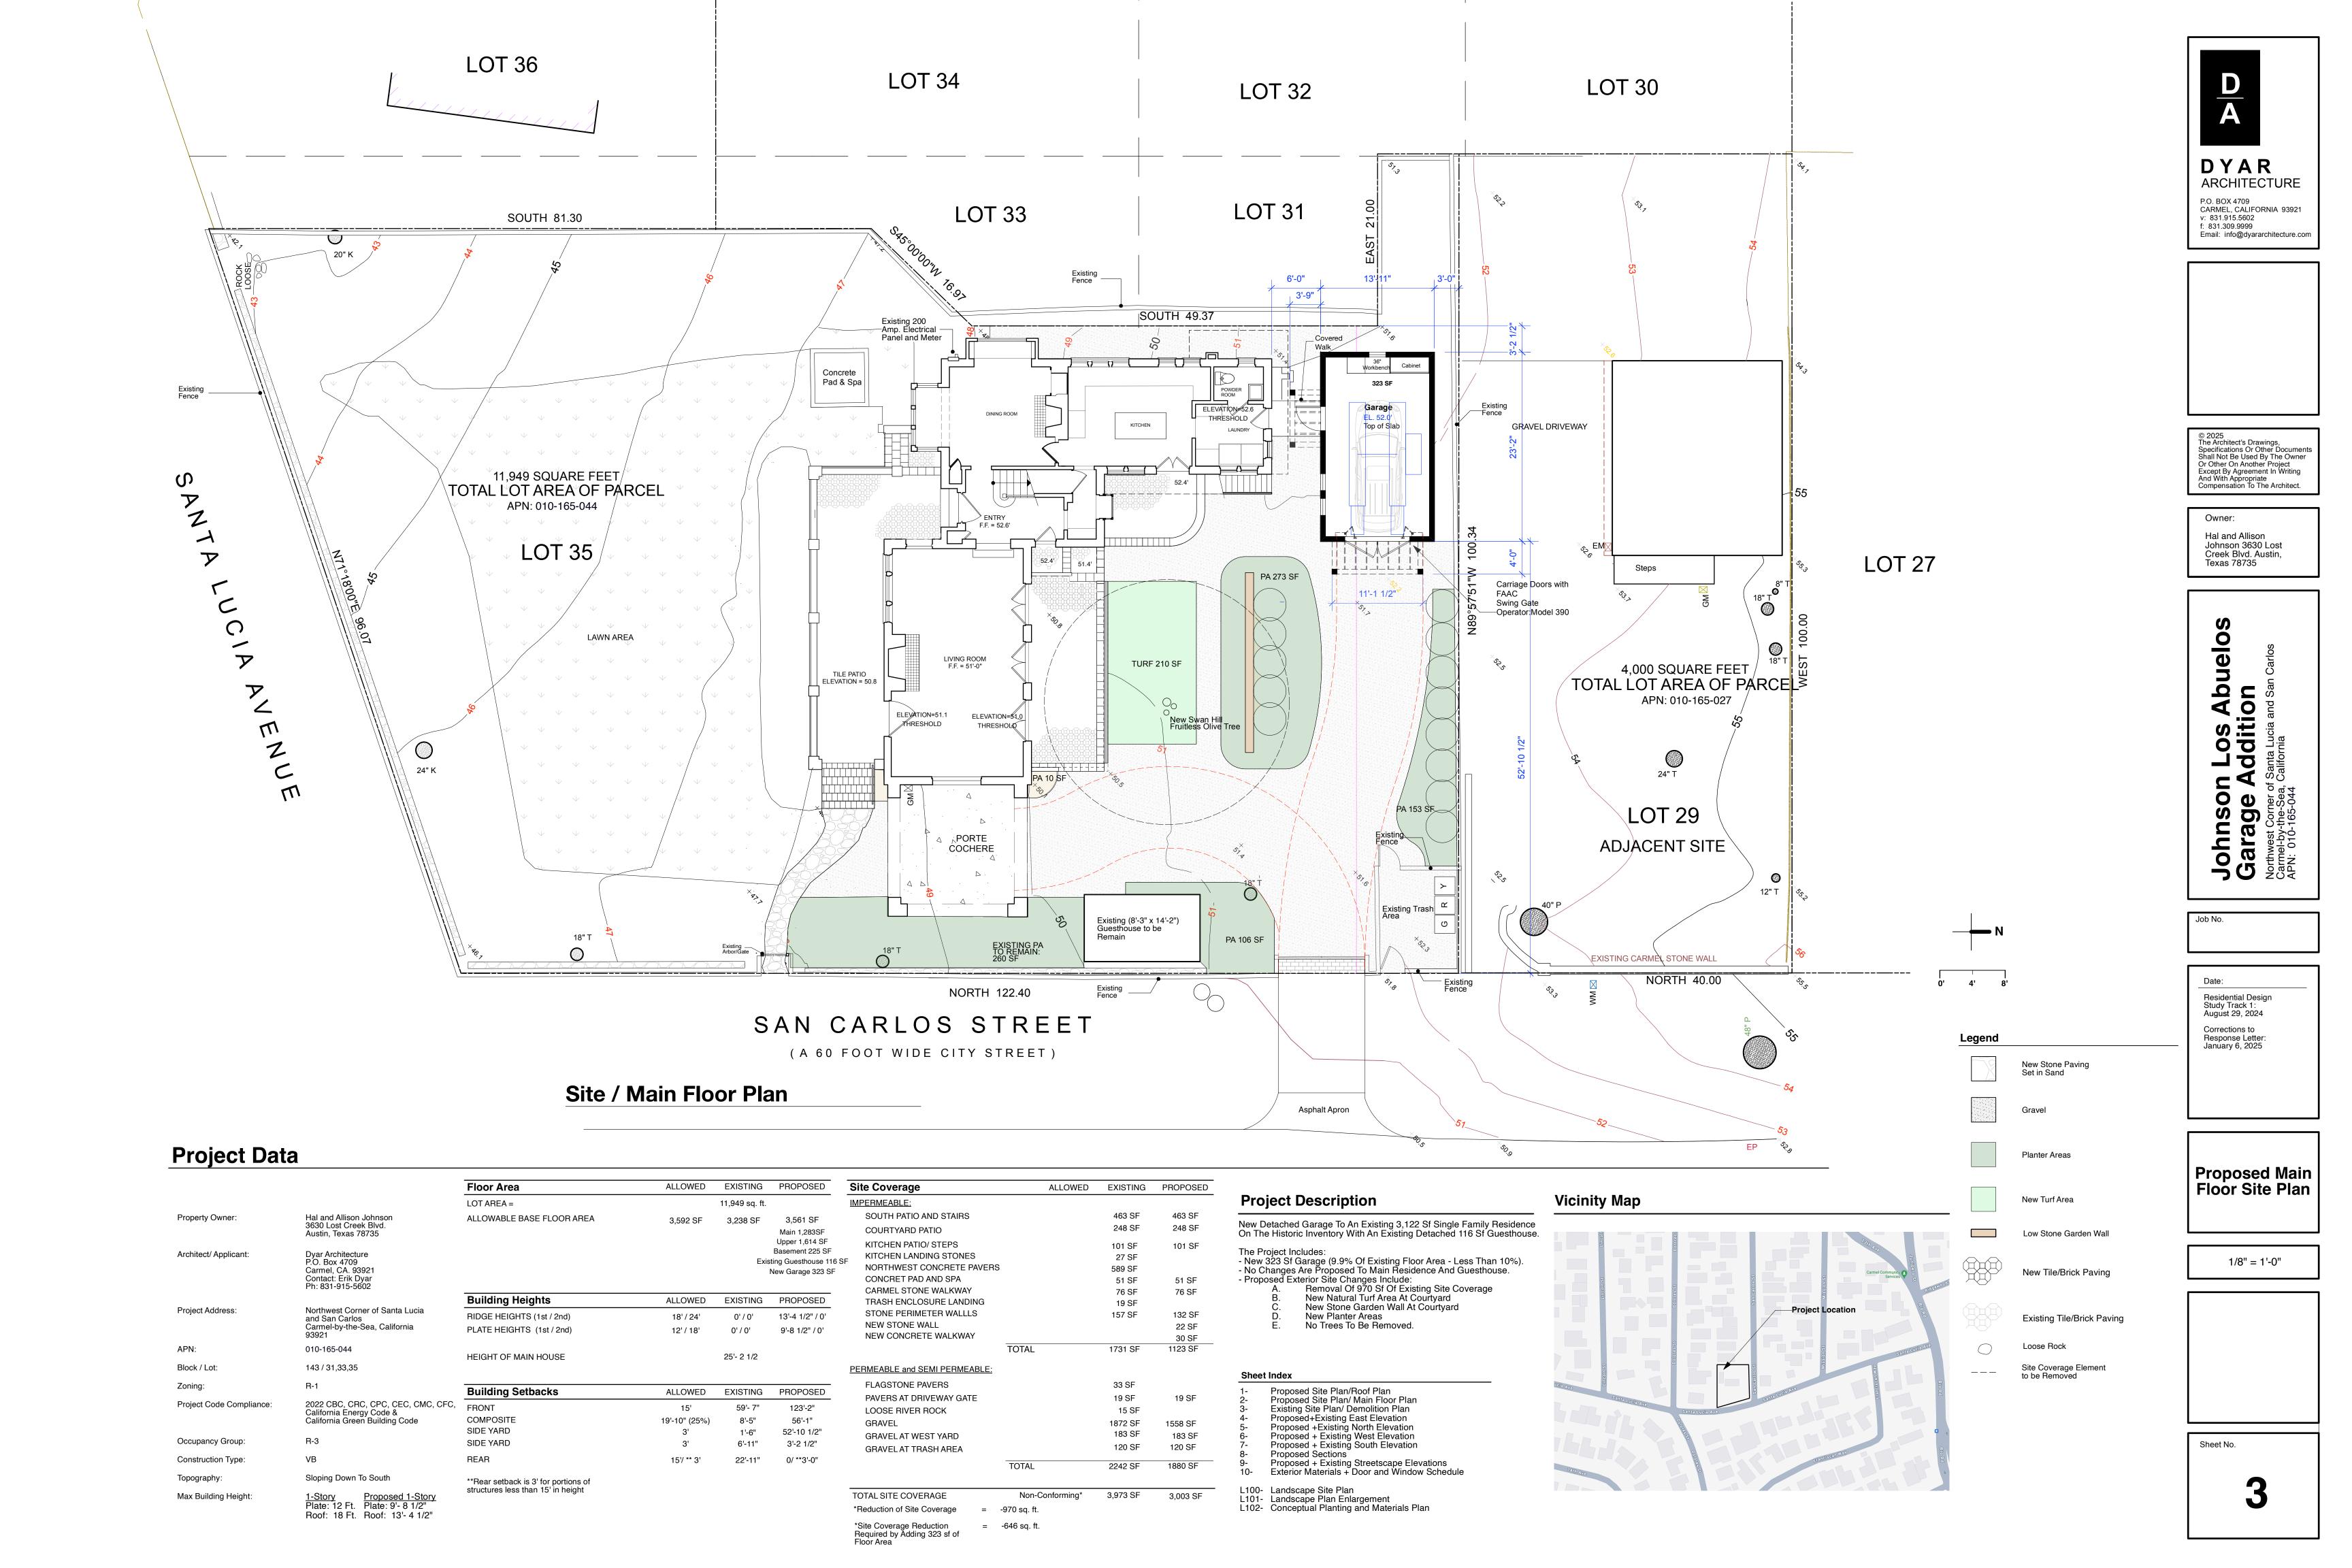






Existing East Elevation

Scale: 1/4"=1'-0"

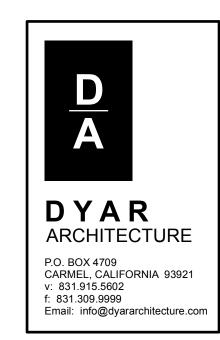

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Specifications Or Other Documents
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Or Other On Another Project
Except By Agreement In Writing
And With Appropriate
Compensation To The Architect.


Owner: Hal and Allison Johnson 3630 Lost Creek Blvd. Austin, Texas 78735

Johnson Los Abuelos Garage Addition
Northwest Corner of Santa Lucia and San Carlos
Carmel-by-the-Sea, California
APN: 010-165-044

Residential Design Study Track 1: August 29, 2024 Corrections to Response Letter: January 6, 2025

Proposed +
Existing East
Elevations

1/4" = 1'-0"

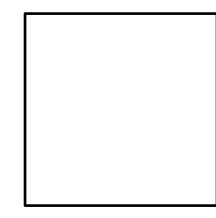


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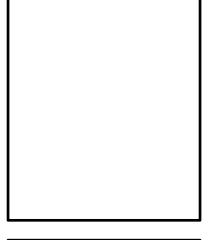


Proposed North Elevation

Scale: 1/4"=1'-0"





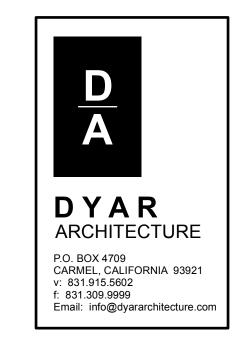

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And With Appropriate
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Owner:
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Creek Blvd. Austin,
Texas 78735

Johnson Los Abuelos Garage Addition
Northwest Corner of Santa Lucia and San Carlos
Carmel-by-the-Sea, California
APN: 010-165-044

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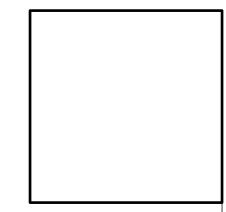
Date:

Residential Design
Study Track 1:
August 29, 2024

Corrections to
Response Letter:
January 6, 2025

Proposed +
Existing North
Elevations

1/4" = 1'-0"




Sheet No.





DYAR
ARCHITECTURE

P.O. BOX 4709
CARMEL, CALIFORNIA 93921
v: 831.915.5602
f: 831.309.9999
Email: info@dyararchitecture.com

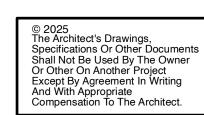

Owner:
Hal and Allison
Johnson 3630 Lost
Creek Blvd. Austin,
Texas 78735

Johnson Los Abuelos Garage Addition Northwest Corner of Santa Lucia and San Carlos Carmel-by-the-Sea, California APN: 010-165-044

ob No.

Date:


Residential Design
Study Track 1:
August 29, 2024

Corrections to
Response Letter:
January 6, 2025

Proposed +
Existing West
Elevations

1/4" = 1'-0"


Sheet No.

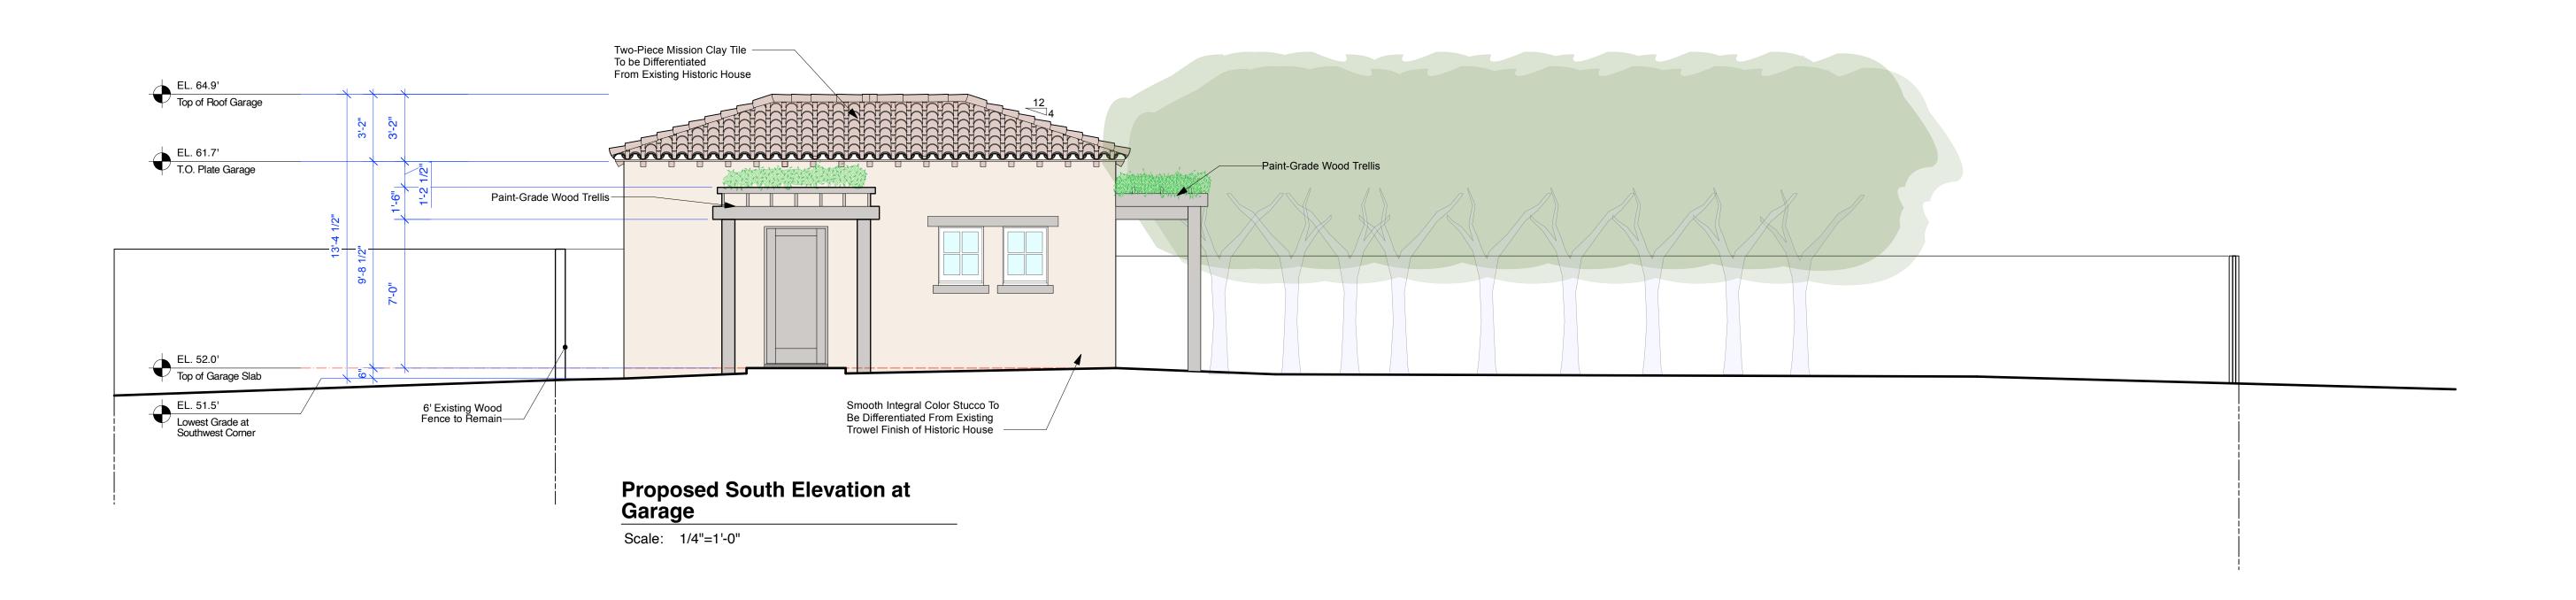



Exising South Elevation

Scale: 1/4"=1'-0"

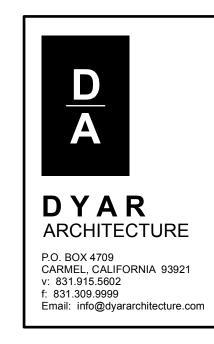

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Or Other On Another Project
Except By Agreement In Writing
And With Appropriate
Compensation To The Architect.

Owner:

Hal and Allison
Johnson 3630 Lost
Creek Blvd. Austin,
Texas 78735

Johnson Los Abuelos Garage Addition
Northwest Corner of Santa Lucia and San Carlos
Carmel-by-the-Sea, California
APN: 010-165-044

No.


Date:

Residential Design
Study Track 1:
August 29, 2024


Corrections to
Response Letter:
January 6, 2025


Proposed +
Existing South
Elevations

1/4" = 1'-0"

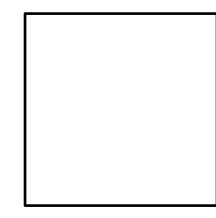

Sheet No.

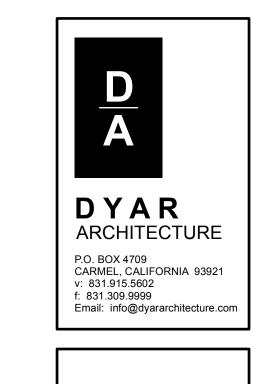

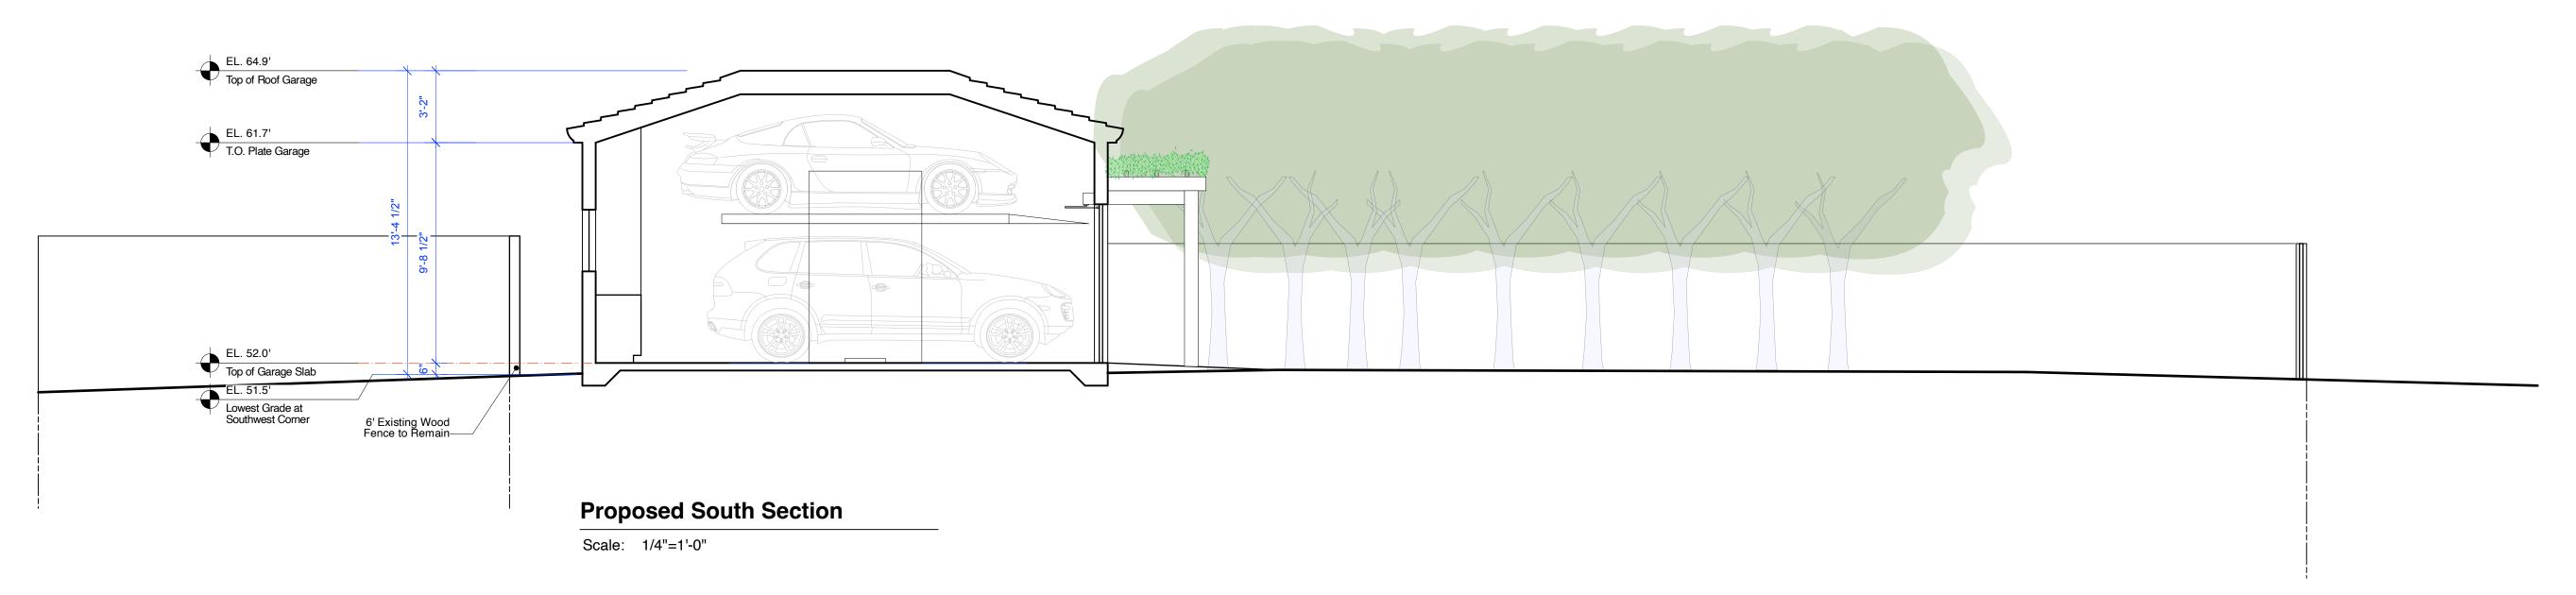

At Marian

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Specifications Or Other Documents
Shall Not Be Used By The Owner
Or Other On Another Project
Except By Agreement In Writing
And With Appropriate
Compensation To The Architect.

Owner:
Hal and Allison
Johnson 3630 Lost
Creek Blvd. Austin,
Texas 78735

Johnson Los Abuelos Garage Addition Northwest Corner of Santa Lucia and San Carlos Carmel-by-the-Sea, California APN: 010-165-044

16-07

Date:

Residential Design
Study Track 1:
August 29, 2024

Corrections to
Response Letter:
January 6, 2025

Proposed Sections

1/4" = 1'-0"

Sheet No.



Proposed San Carlos Street Elevation

Scale: 3/16"=1'-0"



Existing San Carlos Street Elevation

Scale: 3/16"=1'-0"

DYAR

ARCHITECTURE

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Owner: Hal and Allison Johnson 3630 Lost Creek Blvd. Austin, Texas 78735

> Johnson Los Abuelos Garage Addition
> Northwest Corner of Santa Lucia and San Carlos
> Carmel-by-the-Sea, California
> APN: 010-165-044

No.

Date:

Residential
Design Study
Track 1:
August 29, 2024

Corrections to
Response Letter:
January 6, 2025

Proposed +
Existing
Street
Elevations

3/16" = 1'-0"




Shee



Two-Piece Mission Clay Tile
Redland Clay Tile To Be Differentiated From Existing Historic House



Integral Color Stucco - Smooth Finish
Off-White Color (See Color Sample Above) To Be Differentiated From Existing Trowel Finish of Historic House

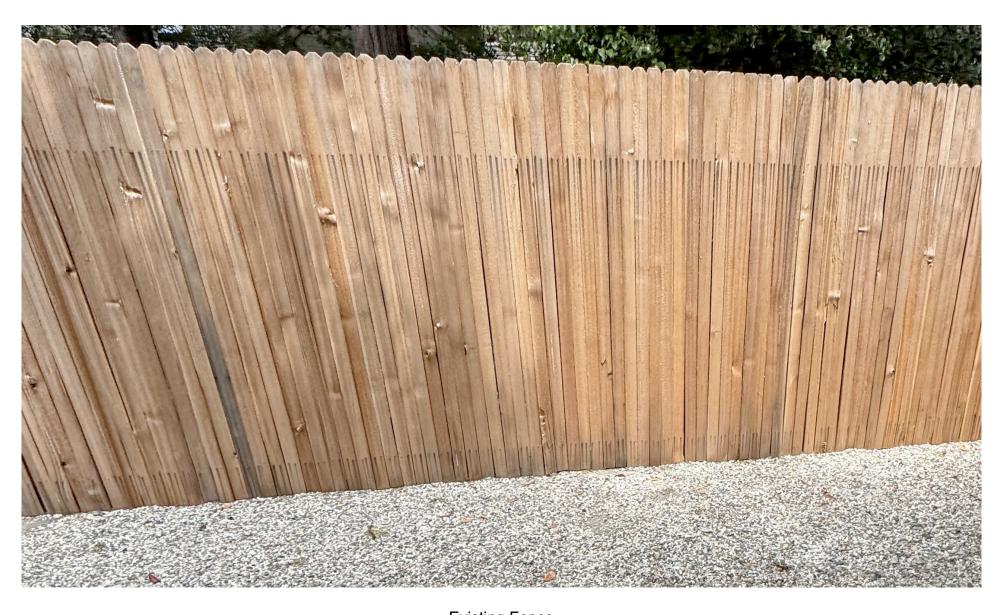


Existing Fence
Existing 6' Fence to Remain

Window Schedule Glass Type Garage 1" Insulated Glass, Tempered Casement Yes Wood 100 2'-1 1/2" Wood 1" Insulated Glass, Tempered Casement Yes Wood 3 Garage 100 2'-1 1/2" 2'-8" **A** Casement 1" Insulated Glass, Tempered




Type 'A'Casement Wood Window

Door S	Door Schedule								
Door No.	Location	Room No.	Frame Width	Frame Height	Door Thickness	Туре	Door Material	Frame / Jamb Remarks	
Garage									
1	Garage	100	8'-0"	7'-0"	1-3/4"	Α	Stained-Grade Wood	Stained-Grade Wood	Carriage Doors with FAAC Swing Gate Operator:Model 390
2	Garage	100	3'-0"	6'-8"	1-3/4"	В	Stained-Grade Wood	Stained-Grade Wood	Exterior Swing Door

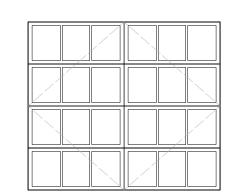



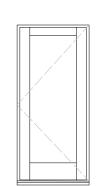

Type 'B'Exterior Swing Door Solid Core Stained-Grade

Finish Materials + Door/Window Schedule

DYAR ARCHITECTURE

P.O. BOX 4709 CARMEL, CALIFORNIA 93921 v: 831.915.5602 f: 831.309.9999 Email: info@dyararchitecture.com

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The Architect's Drawings,
Specifications Or Other Documents
Shall Not Be Used By The Owner
Or Other On Another Project
Except By Agreement In Writing
And With Appropriate
Compensation To The Architect.

Hal and Allison Johnson 3630 Lost Creek Blvd. Austin, Texas 78735

Owner:

Los Abuelos Addition


son Je A


Johns Garag Northwest Corn Carmel-by-the-3 APN: 010-165-

Residential Design Study Track 1: August 29, 2024

Corrections to Response Letter: January 6, 2025

Sheet No.

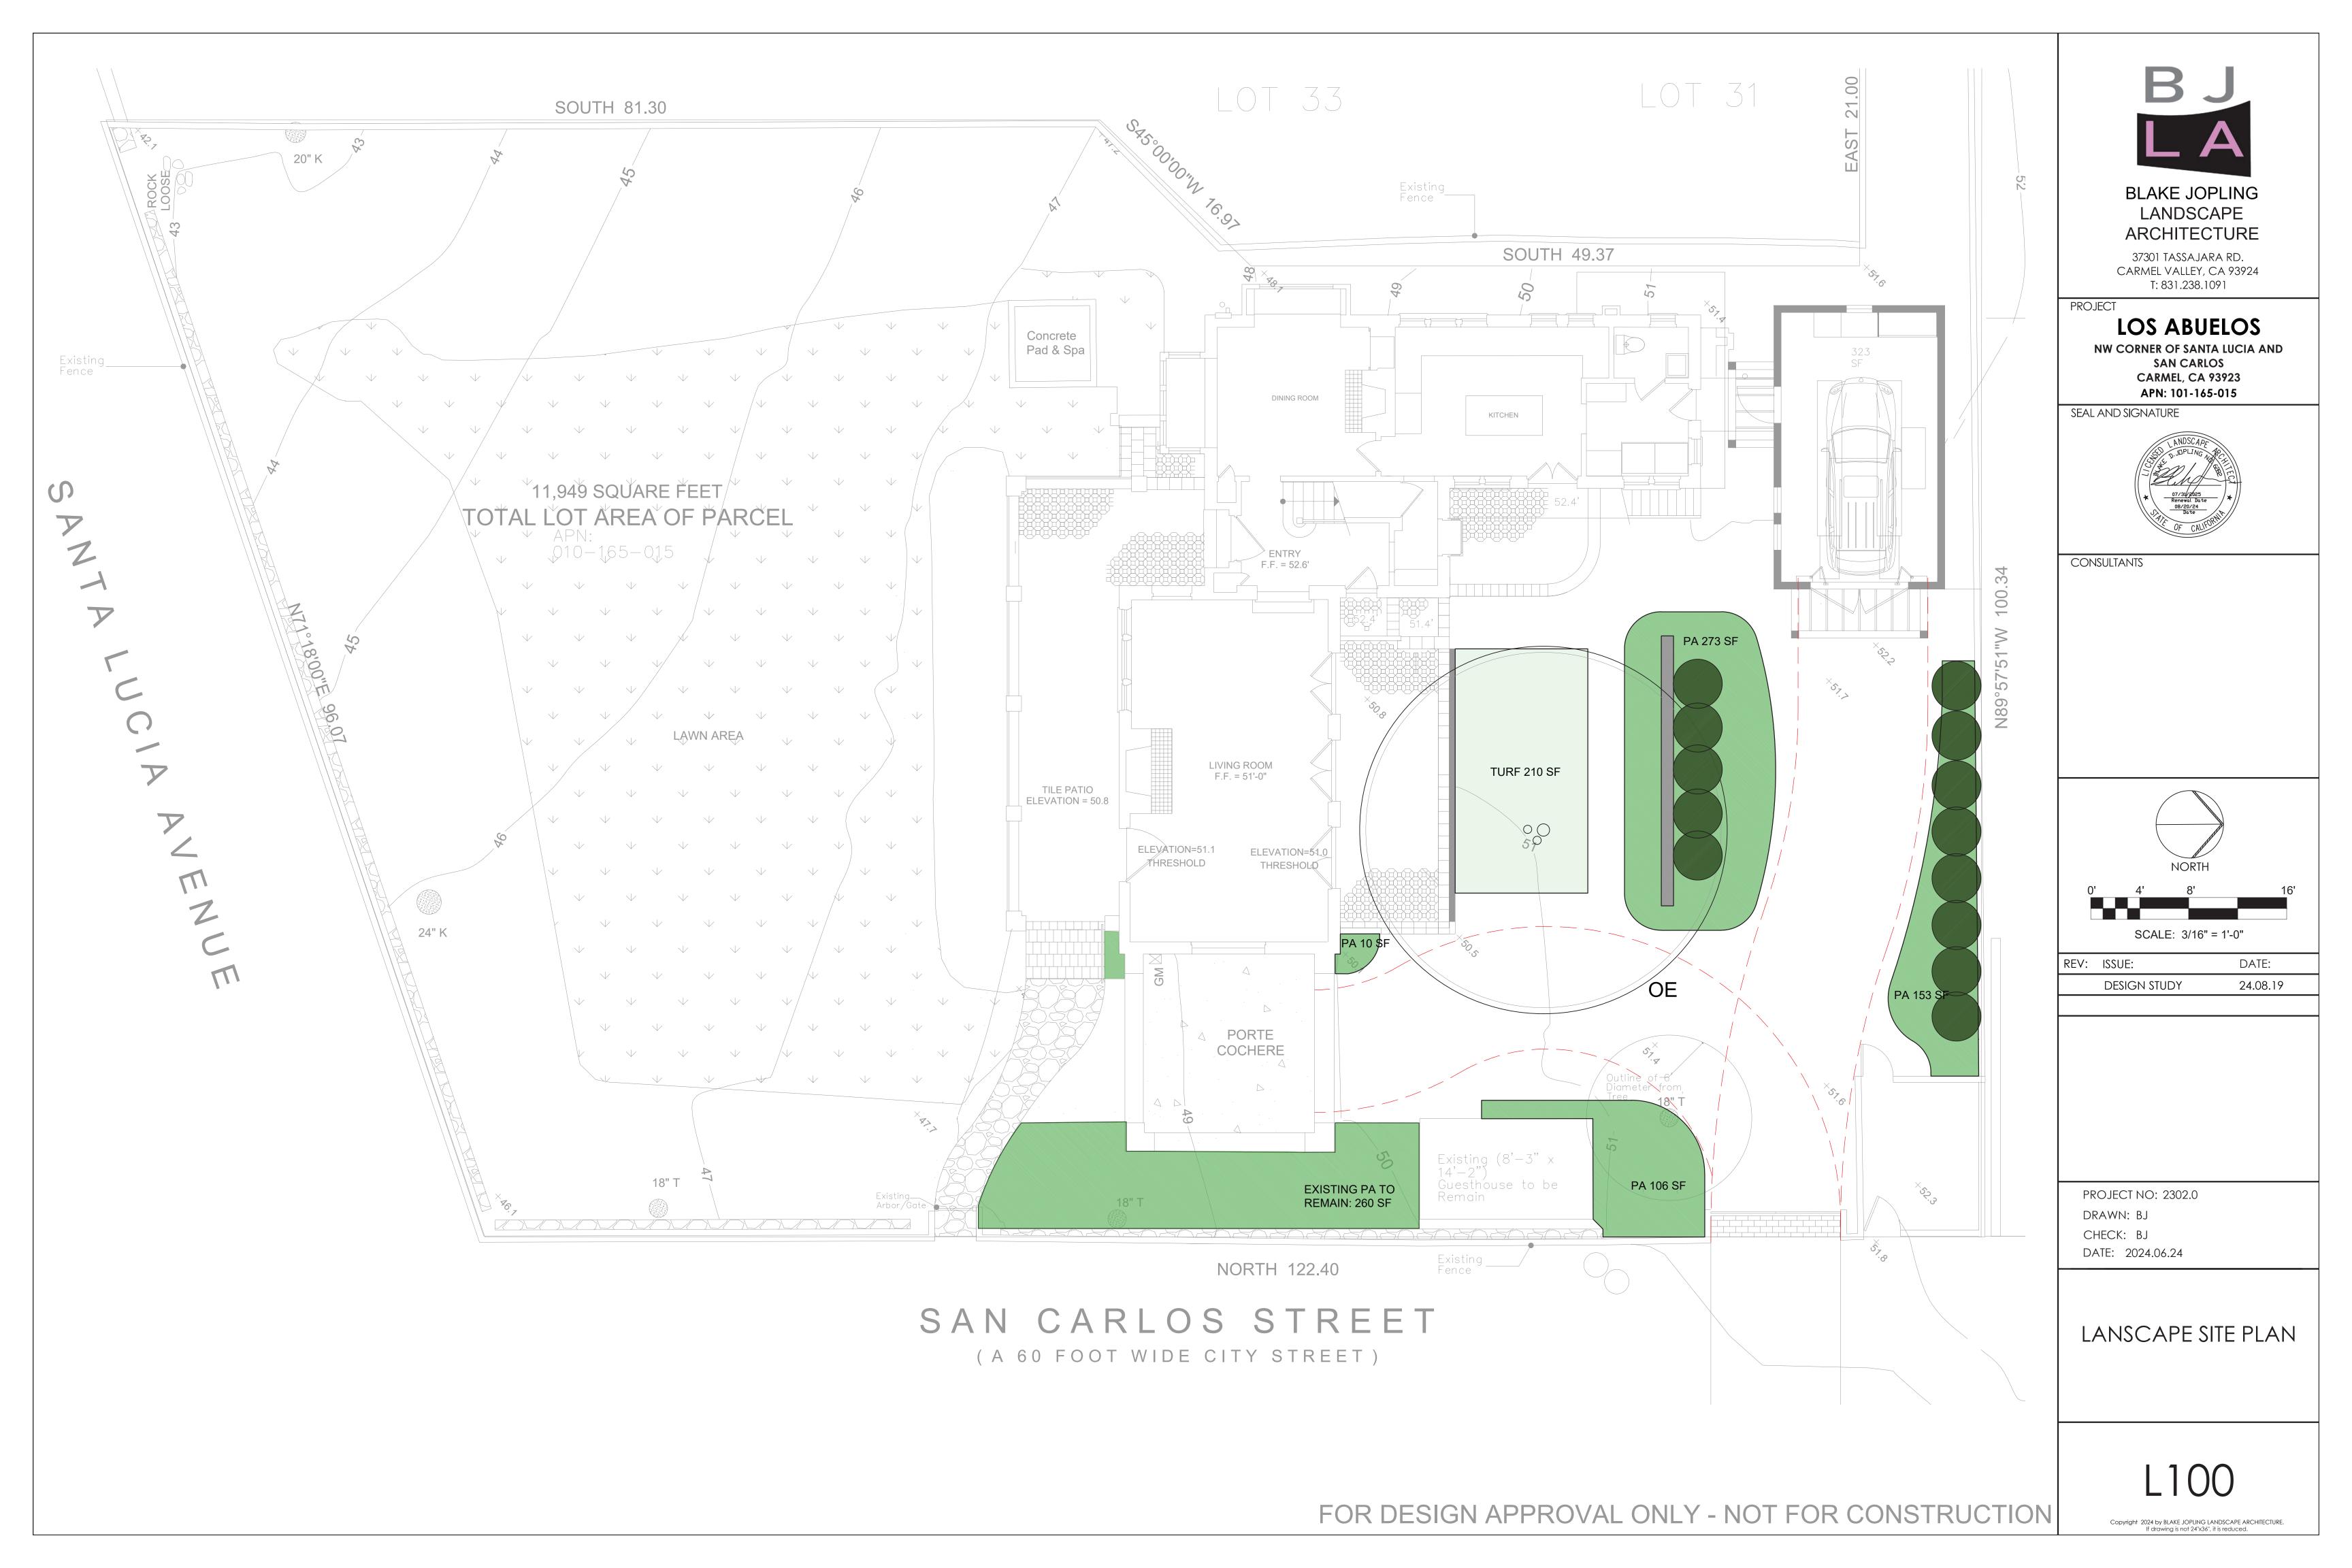

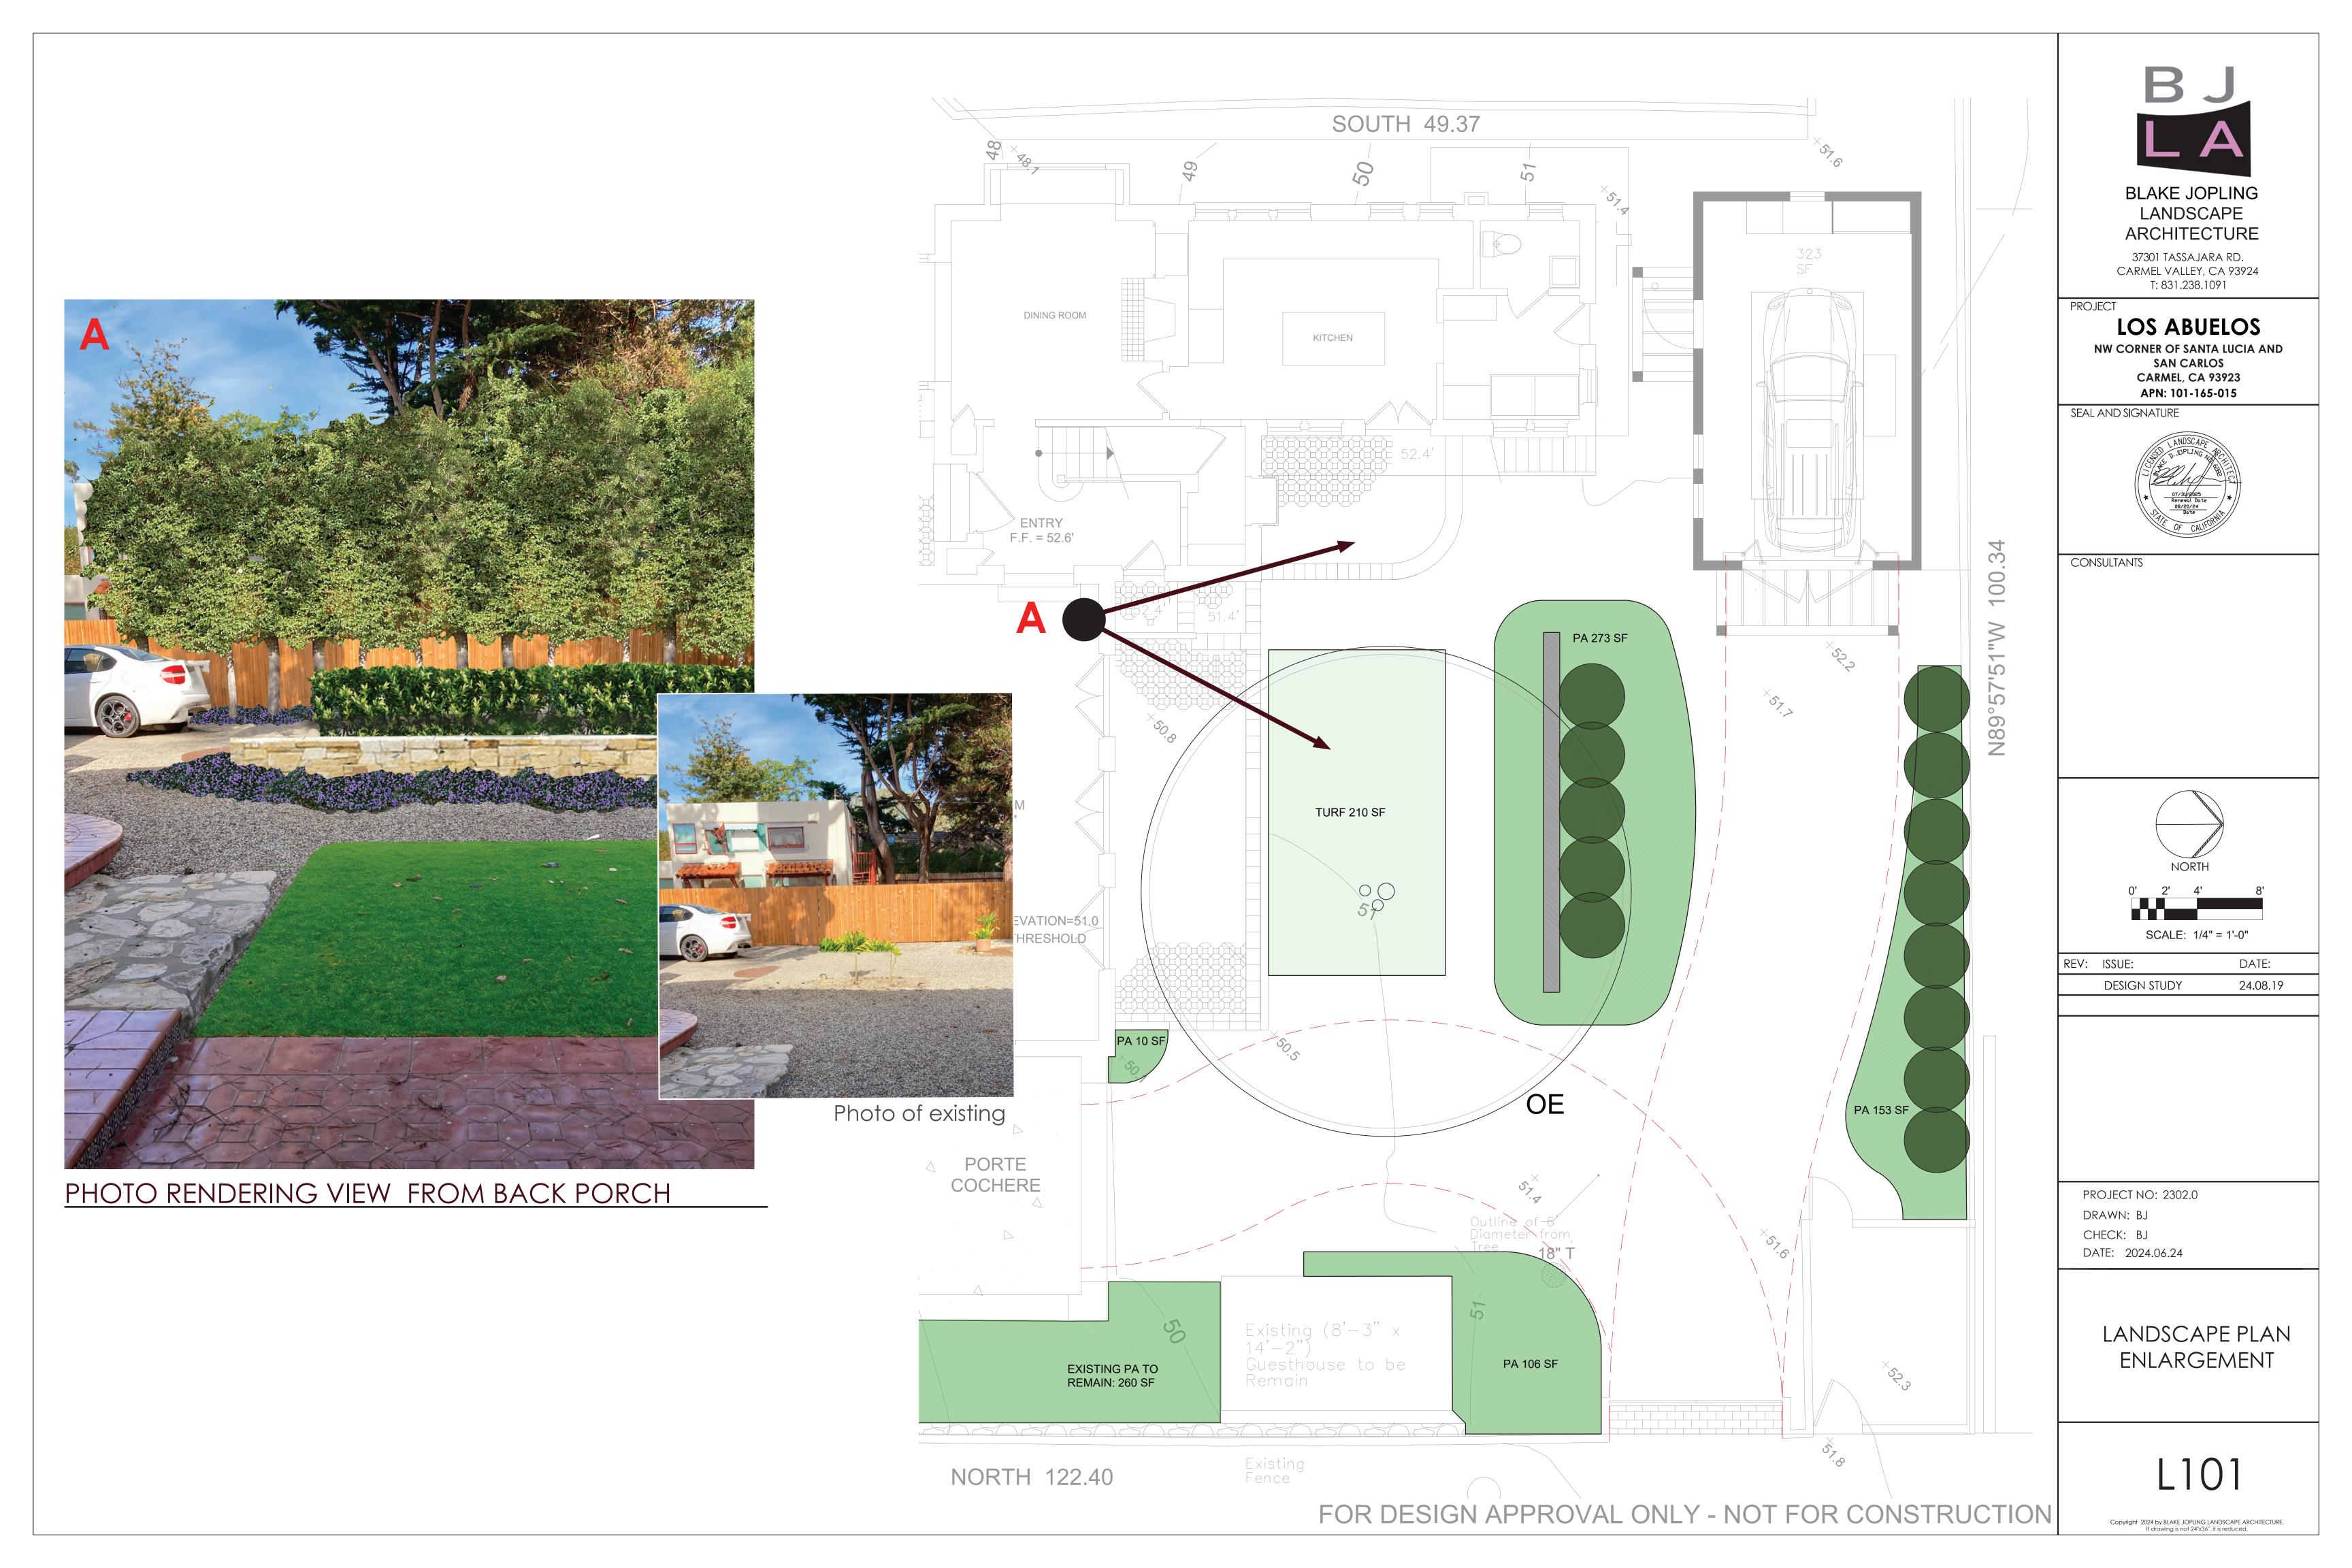

PLANT LEGEND

Scientific Name	Common Name	Container Size	Spacing (OC)	Water Requirements (WUCOLS)	
Trees					
Olea europaea 'Swan Hill'	Swan Hill Fruitless Olive	48" box	N/A	Low	
Low Hedge (4')					
Laurus nobilis	Grecian bay	5 gal	36"	Low	
Scren Hedge (4'-12')					
Pittosporum tobira	Tobira pittosporum	5 gal	36"	Moderate	
Groundcover/Ornamental /Accent ((Sun)				
Acanthus mollis	Bears Breeches	l gal	36"	Low	
Aeonium arboreum 'Zwartkop'	Black Rose aeonium	l gal	24"	Low	
Armeria meritima	Sea Thrift	l gal	12"	Low	
Carex divulsa	Eurpoean sedge	I gal	18"	Moderate	
Lantana montevidensis	Trailing Lantana	l gal	36"	Low	
Rubus pentalobus	s pentalobus Creeping Rasberry		36"	Moderate	
Salvia numrosa 'Cardonna'	Woodland Sage	l gal	24"	Moderate	
Stachys byzantina	Lamb's Ears	l gal	24"	Low	
Perennial/Ornamental /Accent (Sha	ide)				
Helleborus foetidus	Bearsfood Hellebore	5 gal	24"	Moderate	
Heuchera sanguinium	Coral Bells	l gal	18"	Moderate	
Hydrangea querquafolia	drangea querquafolia Oak-leaf Hydrangea		48"	Moderate	
Nephrolepis cordifolia	Sword Fern	5 gal	36"	Moderate	
Turf					
Enduro Dwarf Tall Fescue 90/10	-	Sod	-	High	
Vines (for Garage trellis)					
Bouganvilla 'San Diego'	San Diego Bougainvilla	I5 gal	N/A	Moderate	


LANDSCAPE MATERILAS PALETTE



EXISTING GRAVEL (TO REMAIN)


WALL FACIA: RHYOLITE NATURAL STONE

LANDSCAPE IMPROVEMENTS DIAGRAM

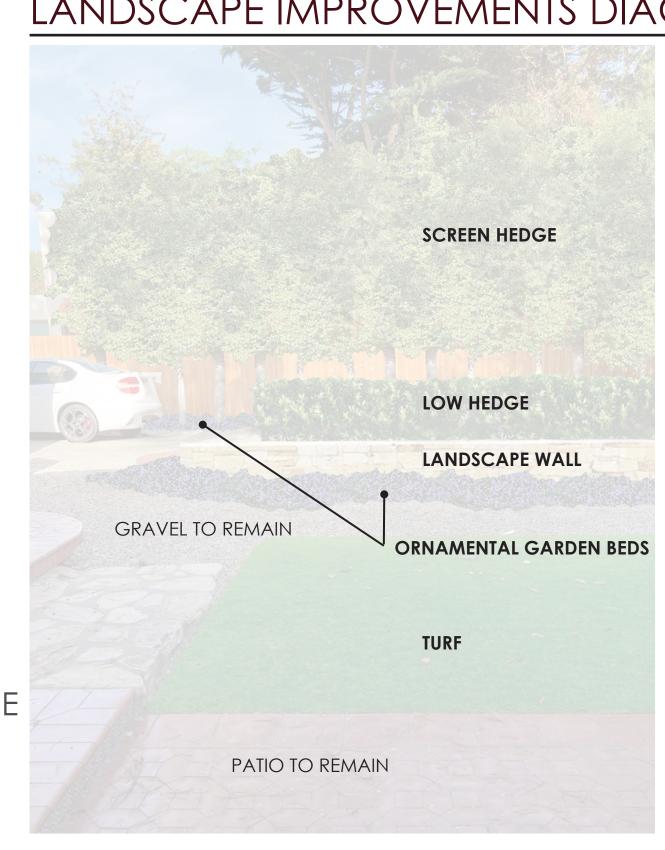

PLANTING AND IRRIGATION NOTES

- 1. All planting and irrigation comply with California's WELO ordinance.
- 2. Planting shall be watered the use of an automated drip irrigation system equipped with automatic rain shut off device.
- 3. Refer to legend for plant species water requirements.
- 4. All landscape areas shall receive 3" mulch layer. A sample of the mulch shall be submitted for owner/landscapre architect's approval.
- 5. Contractor to perform soil tests and submit amendment recommendations to landscape architect.
- 6. Planting under CA native trees shall not receive irrigation during the dry season (May-Oct.)
- 7. Plants within the drip line of existing live oaks shall be adapted to dry summer conditions.

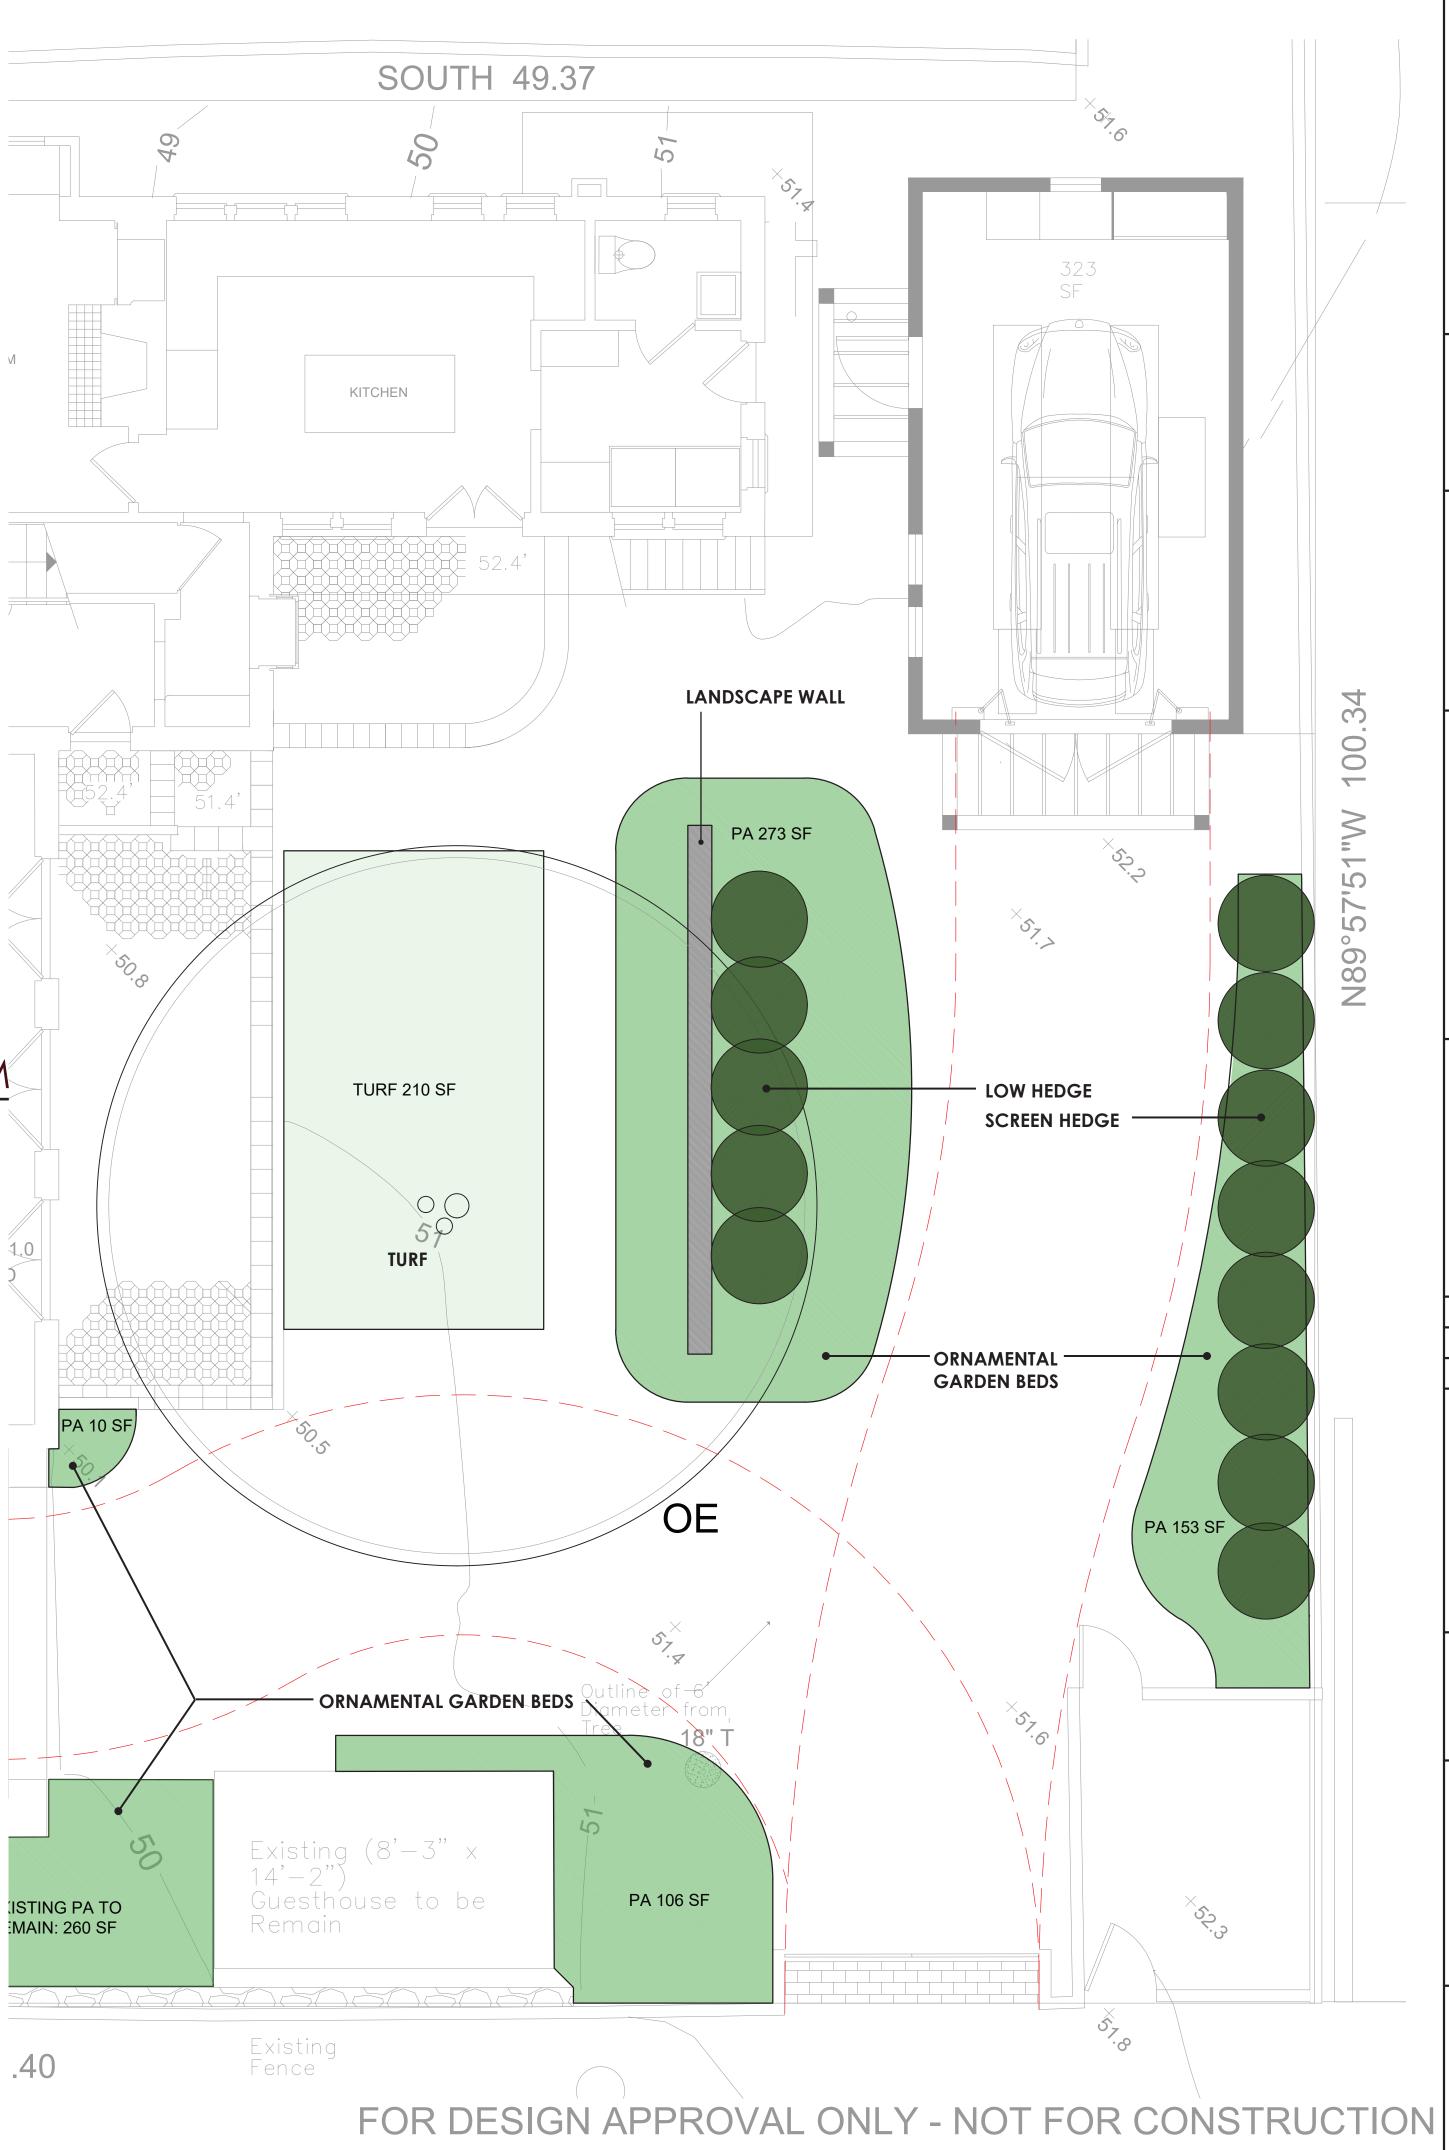



BLAKE JOPLING LANDSCAPE ARCHITECTURE

37301 TASSAJARA RD. CARMEL VALLEY, CA 93924 T: 831.238.1091

PROJECT


LOS ABUELOS

NW CORNER OF SANTA LUCIA AND SAN CARLOS CARMEL, CA 93923 APN: 101-165-015

SEAL AND SIGNATURE



CONSULTANTS

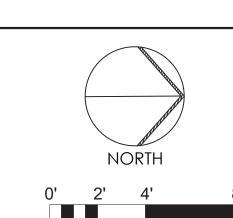

REV: ISSUE: DATE: DESIGN STUDY 24.08.19

SCALE: 1/4" = 1'-0"

PROJECT NO: 2302.0 DRAWN: BJ CHECK: BJ DATE: 2024.06.24

> CONCEPTUAL PLANTING AND MATERIALS PLAN

> > L102