

NOTICE OF APPROVAL & NOTICE OF WAIVER OF PUBLIC HEARING

The Department of Community Planning & Building of the City of Carmel-by-the-Sea has approved an application for a Track 1 Minor Design Study located in the Coastal Commission Appeal Jurisdiction and meets the findings for a public hearing waiver. This Notice of Application Approval and Public Hearing Waiver for Minor Development has been prepared in accordance with CMC 17.52.120.D.1. Any persons interested in the project are encouraged to contact the Project Planner listed below.

Planning Application: DS 24127 (Hermle & Collins)

Project Planner: Jacob Olander, Assistant Planner, <u>Jolander@ci.carmel.ca.us</u>, (831)620-2027

Date Approved: August 9, 2024

Date Posted:

Project Location: San Antonio Street 2 SE of 10th Avenue

Block: W **Lot:** 4 & 6 **APN:** 010-278-019

Applicant: William Mefford, Architect

Approved Project Description:

This approval of Design Study (DS 24127) authorizes the demolition of the side porch, construction of a paver patio, the replacement of windows and doors, replacement of the driveway, and other site improvements to an existing single-family residence located at San Antonio Street 2 SE of 10th Avenue in the Single-Family Residential (R-1) District and Beach/Riparian (BR) Overlay, APN: 010-278-019-000 as depicted in the plans prepared by William C Mefford Architect as approved by City of Carmel-by-the-Sea Planning Division on August 9, 2024 unless modified by the conditions of approval contained herein.

Approved Project Plans are available on the City's website at:

https://ci.carmel.ca.us/post/current-planning-applications

Is this project appealable to the Coastal Commission?: Yes

The decision to approve this project may be appealed to the Planning Commission within 15 business days from the date the notice circulated by filing a written appeal with the Department of Community Planning & Building.

No hearing will be held on this item unless one is requested in writing – no fee shall be assessed for request of a hearing. Failure by a person to request a public hearing may result in the loss of that person's ability to appeal to the Coastal Commission any action taken by the City on the permit application.



FINDINGS AND CONDITIONS

Project: DS 24127/CDP 24183 (Hermle & Collins)

Location: 2905 Franciscan Way, Carmel, CA 93921; 009-382-017-000

Date of Action: August 8, 2024

Project Description:

DS 24127 (Hermle & Collins) authorize the Design Study Applications (DS 24127, Hermle & Collins) Coastal Development Permit (CDP 24183, Hermle-Collins) approval for the demolition of the side porch, construction of a paver patio, replacement of the roof, replacement of windows, installation of new doors, and other site improvements located at San Antonio Street 2 SE of 10th Avenue in the Single-Family (R-1) District and the Beach and Riparian (BR) Overlay. APN: 010-278-019

The proposed changes include:

• The demolition of the side porch, construction of a paver patio, replacement of the roof, replacement of windows, installation of new doors, and other site improvements.

FINDINGS REQUIRED FOR DESIGN STUDY APPROVAL

The Director shall have the authority to approve, approve with modifications and/or conditions, or deny an application for design review based on written findings stating the reasons for the action. Findings shall be based on information in the record. CMC 17.58.060.A.

For each of the required findings listed below, the staff has indicated whether the application, either as proposed or with conditions, supports adopting the findings. For all findings checked "no," staff discusses the issues to facilitate the Director's decision-making. Findings checked "yes" may or may not be discussed depending on the issue(s).

CMC 17.58.060.B Findings for Design Review Approval		
Before approving an application for design review in any district, the Director shall find that the final		
design plans:		
1. Conform to the applicable policies of the General Plan and the Local Coastal Program;	✓	
2. Comply with all applicable provisions of this code; and	√	
3. Are consistent with applicable adopted design review guidelines.	√	

Additional Staff Analysis/Discussion:

None required. The project meets the findings as proposed with the associated conditions.

FINDINGS REQUIRED FOR COASTAL DEVELOPMENT PERMIT APPROVAL

CMC 17.064.110.B. Coastal Development Permits. All decisions on coastal development permits shall be accompanied by written findings:

For each of the required findings listed below, the staff has indicated whether the application, either as proposed or with conditions, supports adopting the findings. For all findings checked "no," staff discusses the issues to facilitate the Director's decision-making. Findings checked "yes" may or may not be discussed depending on the issue(s).

CMC 17.64.010.B, Coastal Development Permits			
1. That the project as described in the application and accompanying materials, as modified by any	✓		
conditions of approval, conforms with the certified City of Carmel-by-the-Sea Local Coastal			
Program.			

2. If the project is located between the first public road and the sea, that the project is in conformity with the public access and recreation policies of Chapter 3 of the Coastal Act of 1976 (commencing with Sections 30200 of the Public Resources Code).

Additional Staff Analysis/Discussion:

None required. The project meets the findings as proposed with the associated conditions.

ENVIRONMENTAL REVIEW

The California Environmental Quality Act (California Public Resources Code §§ 21000, et seq., "CEQA"), together with State Guidelines (14 California Code Regulations §§ 15000, et seq., the "CEQA Guidelines") and City Environmental Regulations (CMC 17.60) require that certain projects be reviewed for environmental impacts and that environmental documents be prepared.

Finding: The Community Planning and Building Department finds that pursuant to CEQA regulations, the project is categorically exempt under Section 15301 (Class 1) – Existing Facilities, and no exceptions to the exemption exist pursuant to section 15300.2 of the CEQA Guidelines.

Additional Staff Analysis/Discussion: The project consists of the demolition of the side porch and the replacement of a paver patio, replacement of the roof, replacement of windows, installation of new doors, and other site improvements to an existing Single-Family Home and the project does not result in any expansion of use.

	CONDITIONS OF APPROVAL
No.	Standard Conditions
1.	Authorization. This approval of Design Study (DS 24127) authorizes the demolition of the side porch, construction of a paver patio, the replacement of windows and doors, replacement of the driveway, and other site improvements to an existing single-family residence located at San Antonio Street 2 SE of 10th Avenue in the Single-Family Residential (R-1) District and Beach/Riparian (BR) Overlay, APN: 010-278-019-000 as depicted in the plans prepared by William C Mefford Architect as approved by City of Carmel-by-the-Sea Planning Division on August 9, 2024 unless modified by the conditions of approval contained herein.
2.	Codes and Ordinances. The project shall be constructed in conformance with all requirements of the R-1 zoning district. All adopted building and fire codes shall be adhered to in preparing the working drawings. If any codes or ordinances require design elements to be changed, or if any other changes are requested when such plans are submitted, such changes may require additional environmental review and subsequent approval by the Planning Division.
3.	Permit Validity. In accordance with CMC Section 17.52.170 (Time Limits on Approvals and Denials), a residential design study approval remains valid for a period of 12 months from the date of action. During this time, the project must be implemented, or the approval becomes void. Implementation is effected by erecting, installing, or beginning the installation of the improvement authorized by the permit, as determined by the Director. Extensions to this approval may be granted consistent with CMC 17.52.170.C.
4.	Water Use. Approval of this application does not permit an increase in water use on the project site without adequate supply. Should the Monterey Peninsula Water

Management District determine that adequate water is unavailable for this site, this permit will be scheduled for reconsideration, and appropriate findings will be prepared for review and adoption by the Planning Commission.

- 5. **Setback and Height Certifications.** If request by the Community Planning and Building Department, a State licensed surveyor shall survey and certify the following in writing:
 - The footing locations are in conformance with the approved plans prior to footing/foundation inspection;
 - The roof heights and plate heights of each building are in conformance with the approved plans prior to the roof sheathing inspection. Roofs and plates shall not exceed the elevation points as identified in the approved project plans, and the roofs include an appropriate allowance for roofing material thickness.

Written certifications prepared, sealed, and signed by the surveyor shall be provided prior to footing/foundation inspection and roof sheathing inspection. In the event that multiple footing/foundation pours are required, a survey letter shall be submitted for each separate section.

- 6. **Service Laterals.** Prior to final inspection, all electrical service laterals to any new building or structure, or to any building or structure being remodeled when such remodeling requires the relocation or replacement of the main service equipment, shall be placed underground on the premises upon which the building or structure is located. Undergrounding will not be required when the project valuation is less than \$200,000, or the City Forester determines that undergrounding will damage or destroy significant trees(s) (CMC 15.36.020).
- 7. **Utility Meter Locations.** The placement of all utility meters shall consistent with the locations identified in the approved plans. Changes to the location of any utility meter location shall require written approval of the Community Planning and Building Department prior to the change of the location.
- 8. **Fire Sprinklers Residential.** Additions, alterations, or repairs to existing structures that involve the addition, removal, or replacement of 50 percent or more of the linear length of the walls (interior and exterior) within a 5-year period shall require the installation of an automatic residential fire sprinkler system in accordance with the California Building and Fire Codes (CMC 15.08.135).
- 9. **Modifications.** The Applicant shall submit in writing, with revised plans, to the Community Planning and Building staff any proposed changes to the approved project plans prior to incorporating those changes. If the Applicant changes the project without first obtaining City approval, the Applicant will be required to submit the change in writing, with revised plans, within two weeks of the City being notified. A cease work order may be issued at any time at the discretion of the Director of Community Planning and Building until a) either the Planning Commission or Staff has approved the change, or b) the property owner has eliminated the change and submitted the proposed change in writing, with revised plans, for review. The project will be reviewed for its compliance with the approved plans prior to the final inspection.
- 10. **Exterior Revisions to Planning Approval Form.** All proposed modifications that affect the exterior appearance of the building or site elements shall be submitted on the "Revisions to Planning Approval" form on file in the Community Planning and Building Department.

Any modification incorporated into the construction drawings not listed on this form shall not be deemed approved upon issuance of a building permit.

11. **Conflicts Between Planning Approvals and Construction Plans.** It shall be the responsibility of the Owner, Applicant, and Contractor(s) to ensure consistency between the project plans approved by the Planning Staff, the Planning Commission, or the City Council on appeal and the construction plans submitted to the Building Division as part of the Building Permit review. Where inconsistencies between the Planning approval and the construction plans exist, the Planning approval shall govern unless otherwise approved in writing by the Community Planning & Building Director or their designee.

When changes or modifications to the project are proposed, the Applicant shall clearly list and highlight each proposed change and bring each change to the City's attention. Changes to the project incorporated into the construction drawings that were not clearly listed or identified as a proposed change shall not be considered an approved change. Should conflicts exist between the originally approved project plans and the issued construction drawings that were not explicitly identified as a proposed change, the plans approved as part of the Planning Department Review, including any Conditions of Approval, shall prevail.

12. **Exterior Lighting.** If new lighting is proposed, the Applicant shall include in the construction drawings the manufacturer's specifications, including illumination information, for all exterior light fixtures, prior to the issuance of a building permit. All fixtures shall be shielded and down-facing.

Exterior wall-mounted lighting shall be limited to 25 watts or less (incandescent equivalent or 375 lumens) per fixture and shall be installed no higher than 10 feet above the ground or walking surface.

Landscape lighting shall not exceed 18 inches above the ground nor more than 15 watts (incandescent equivalent or 225 lumens) per fixture and shall be spaced no closer than 10 feet apart. Landscape lighting shall not be used as accent lighting, nor shall it be used to illuminate trees, walls, or fences. The purpose of landscape lighting is to safely illuminate walkways and entrances to the subject property and outdoor living spaces.

- 13. **Aluminum-Clad Wood Frame Windows and Doors.** Prior to the issuance of a building permit, the Applicant shall include the manufacturer's specifications for the approved aluminum-clad wood windows and doors. The window style shall be consistent with authentic wood windows and doors with divided lights that appear to be true divided light, including the use of internal and external mullions and muntins on insulated windows. Any window pane dividers, which are snap-in or otherwise superficially applied, are not permitted. The painted finish shall be matte or low gloss.
- 14. **Indemnification.** The Applicant agrees, at his or her sole expense, to defend, indemnify, and hold harmless the City, its public officials, officers, employees, and assigns from any liability; and shall reimburse the City for any expense incurred, resulting from, or in connection with any project approvals. This includes any appeal, claim, suit, or other legal proceedings to attack, set aside, void, or annul any project approval. The City shall promptly notify the Applicant of any legal proceeding and cooperate fully in the defense.

- The City may, at its sole discretion, participate in any such legal action, but participation shall not relieve the Applicant of any obligation under this condition. Should any party bring any legal action in connection with this project, the Superior Court of the County of Monterey, California, shall be the situs and have jurisdiction for resolving all such actions by the parties hereto.
- 15. **Driveway.** Prior to the issuance of a building permit, the Applicant shall clearly identify on the construction drawings the driveway material and asphalt connection to the paved street edge. The driveway material shall be extended beyond the property line into the public right-of-way to connect to the paved street edge. A minimal asphalt connection at the street edge may be required by the Superintendent of Streets or the Building Official, depending on site conditions, to accommodate the drainage flow line of the street. If the driveway material is proposed to be sand set, a dimensioned construction detail showing the base material shall be included in the construction drawings.
- 16. **Hazardous Materials Waste Survey.** Prior to the issuance of a demolition permit, the Applicant shall submit a hazardous materials waste survey to the Building Division in conformance with the Monterey Bay Unified Air Pollution Control District.
- 17. **Cultural Resources.** Throughout construction, all activities involving excavation shall immediately cease if cultural resources are discovered on the site, and the Applicant shall notify the Community Planning & Building Department within 24 hours. Work shall not be permitted to recommence until such resources are properly evaluated for significance by a qualified archaeologist. If the resources are determined to be significant, prior to the resumption of work, a mitigation and monitoring plan shall be prepared by a qualified archaeologist and reviewed and approved by the Community Planning and Building Director. In addition, if human remains are unearthed during the excavation, no further disturbance shall occur until the County Coroner has made the necessary findings regarding origin and distribution pursuant to California Public Resources Code (PRC) Section 5097.98.
- 18. **Truck Haul Route.** Prior to the issuance of a building permit, the Applicant shall submit for review and approval by the Community Planning & Building Director, in consultation with the Public Works and Public Safety Departments, a truck-haul route and any necessary traffic control measures for the grading activities. The Applicant shall be responsible for ensuring adherence to the truck-haul route and implementation of any required traffic control measures.
- 19. **USA North 811.** Prior to any excavation or digging, the Applicant shall contact the appropriate regional notification center (USA North 811) at least two working days, but not more than 14 calendar days, prior to commencing that excavation or digging. No digging or excavation is authorized to occur on-site until the Applicant has obtained a Ticket Number and all utility members have positively responded to the dig request. (Visit USANorth811.org for more information)
- 20. **Conditions of Approval.** Prior to the issuance of a building permit, the Applicant shall print a copy of the Resolution adopted by the Planning Commission and signed by the property owner(s) and applicant on a full-size sheet within the construction plan set submitted to the Building Safety Division.

Landscape Conditions

- 21. **Landscape Plan Required.** Prior to the issuance of a building permit, if new landscaping is proposed the Applicant shall submit a landscape plan for review and approval by the Community Planning & Building Department and the City Forester. The landscape plan shall be included in the construction drawings and will be reviewed for compliance with the landscaping standards contained in the Zoning Code, including, but not limited to, the following:
 - 1) All new landscaping shall be 75% drought-tolerant;
 - 2) Landscaped areas shall be irrigated by a drip/sprinkler system set on a timer; and
 - 3) The project shall meet the City's recommended tree density standards unless otherwise approved by the City based on on-site conditions.

The landscape plan shall identify the location where new trees will be planted when new trees are required to be planted by the City code, the Forest and Beach Commission, or the Planning Commission.

- 22. **Tree Planting Requirements.** Prior to issuance of a building permit, the Applicant shall identify on the landscape plan the location, size, and species of required tree plantings. All new trees shall be installed prior to the final inspection. Trees shall be recorded and monitored for at least five years to ensure their establishment and growth to maturity. Trees that do not survive or are removed shall be replaced with new trees that are equivalent in size to the measured or projected growth of the original trees and shall be planted in the same location unless otherwise directed by the City Forester or Forest & Beach Commission.
- 23. **Tree Removal Prohibited.** Throughout construction, the Applicant shall protect all trees identified for preservation by methods approved by the City Forester. Trees on or adjacent to the site shall only be removed upon the approval of the City Forester or Forest and Beach Commission.
- 24. **Tree Protection Measures.** Requirements for tree preservation shall adhere to the following tree protection measures on the construction site.
 - Prior to grading, excavation, or construction, the developer shall clearly tag or mark all trees to be preserved.
 - Excavation within 6 feet of a tree trunk is not permitted.
 - No attachments or wires of any kind, other than those of a protective nature, shall be attached to any tree.
 - Per Municipal Code Chapter 17.48.110, no material may be stored within the dripline of a protected tree, including the drip lines of trees on neighboring parcels.
 - Tree Protection Zone. The Tree Protection Zone shall be equal to dripline or 18 inches radially from the tree for every one inch of trunk diameter at 4.5 feet above the soil line, whichever is greater. A minimum of 4-foot-high transparent fencing is required unless otherwise approved by the City Forester. Tree protection shall not be resized, modified, removed, or altered in any manner without written approval. The fencing must be maintained upright and taught for the duration of the project. No more than 4 inches of wood mulch shall be installed within the Tree Protection Zone. When the Tree Protection Zone is at

- or within the drip line, no less than 6 inches of wood mulch shall be installed 18 inches radially from the tree for every one inch of trunk diameter at 4.5 feet above the soil line outside of the fencing.
- Structural Root Zone. The Structural Root Zone shall be 6 feet from the trunk or
 6 inches radially from the tree for every one inch of trunk diameter at 4.5' above
 the soil line, whichever is greater. Any excavation or changes to the grade shall
 be approved by the City Forester prior to work. Excavation within the Structural
 Root Zone shall be performed with a pneumatic excavator, hydro-vac at low
 pressure, or another method that does not sever roots.
- If roots greater than 2 inches in diameter or larger are encountered within the approved Structural Root Zone, the City Forester shall be contacted for approval to make any root cuts or alterations to structures to prevent roots from being damaged.
- If roots larger than 2 inches in diameter are cut without prior City Forester approval or any significant tree is endangered as a result of construction activity, the building permit will be suspended, and all work stopped until an investigation by the City Forester has been completed, and mitigation measures have been put in place.
- 25. **Foundation Work Near Significant Trees.** All foundations within 15 feet of significant trees shall be excavated by hand. If any tree roots larger than two inches (2") are encountered during construction, the City Forester shall be contacted before cutting the roots. The City Forester may require the roots to be bridged or may authorize the roots to be cut. If roots larger than two inches (2") in diameter are cut without prior City Forester approval or any significant tree is endangered as a result of construction activity, the building permit will be suspended and all work stopped until an investigation by the City Forester has been completed. Six inches (6") of mulch shall be evenly spread across the inside the dripline of all trees prior to the issuance of a building permit.

Environmental Compliance Conditions

- 26. **Drainage Plan.** Prior to the issuance of a building permit, the Applicant shall submit for review and approval by the Community Planning & Building and Public Works Departments a drainage plan that meets the requirements of the City's drainage guidance, SOG 17-07. At a minimum, new and replaced impervious area drainage must be dispersed around the site rather than focused on one corner of the property; infiltration features must be sized appropriately and located at least 6 feet from neighboring properties. The drainage plan shall include information on drainage from new impervious areas and semi-pervious areas.
- 27. **BMP Tracking Form.** Prior to issuance of a building permit, the Applicant shall submit for review and approval by the Community Planning & Building and Public Works Departments a completed BMP Tracking form.
- 28. **Semi-Permeable Surfaces.** Prior to issuance of a building permit, the Applicant shall submit for review and approval by the Community Planning & Building and Public Works Departments cross-section details for all semi-permeable surfaces.
- 29. **Erosion and Sediment Control Plan.** Prior to issuance of a building permit, the Applicant shall submit for review and approval by the Community Planning & Building and Public Works Departments an erosion and sediment control plan that includes locations and

DS 24127 (Hermle & Collins) Findings and Conditions August 9, 2024 Page 8 of 8


Applicant Signature

	installation details for erosion and sediment control BMPs, material staging areas, ar stabilized access.
	Special Conditions
30.	Conditions of Approval Acknowledgement . Prior to the issuance of a building perm revision, a completed Conditions of Approval Acknowledgment form shall be included in the construction drawings. The form shall be signed by the Property Owner, Applicant and Contractor prior to the issuance of a building permit.
31.	Construction Management Plan. Prior to the issuance of a building permit, the Applican shall submit a Construction Management Plan for review and approval by the Communit Planning & Building Director.
32.	Pre-Construction Meeting. The contractor overseeing the project shall schedule a proconstruction meeting with the project Planner and the Building Inspector prior to issuance of the building permit for the purpose of reviewing the conditions of approval are expectations during construction.
33.	Driveway Area Landscaping. Applicant shall plant Dymondia or a similar landscape ground cover in the area of the driveway currently labelled as dirt in the plans as a mear to enhance the forested edge consistent with the Residential Design Guideline Alternative may be considered through the submittal of a landscape plan, which means the requirements of the Residential Design Guidelines and Conditions #22.
34.	Building Permit . The applicant shall obtain a Building Permit from the Building Safe Division prior to commencement of work.
Ackno	rledgement and acceptance of conditions of approval:
Prope	y Owner Signature Printed Name Date

Once signed, please email to jolander@ci.carmel.ca.us.


Printed Name

Date

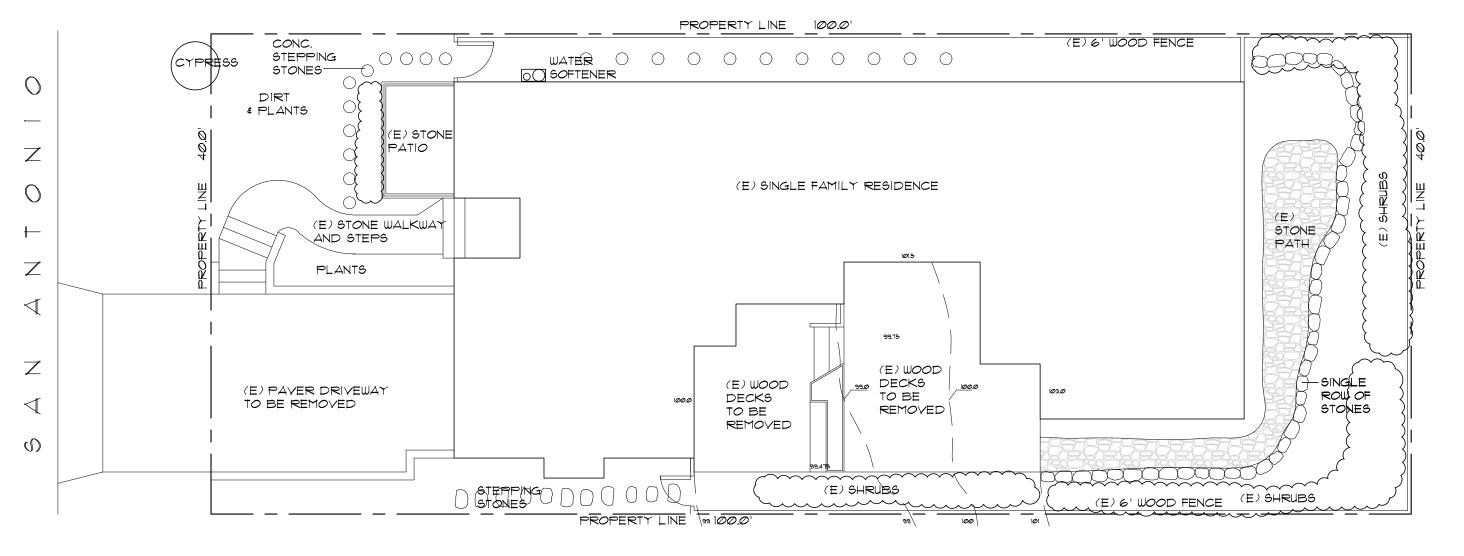





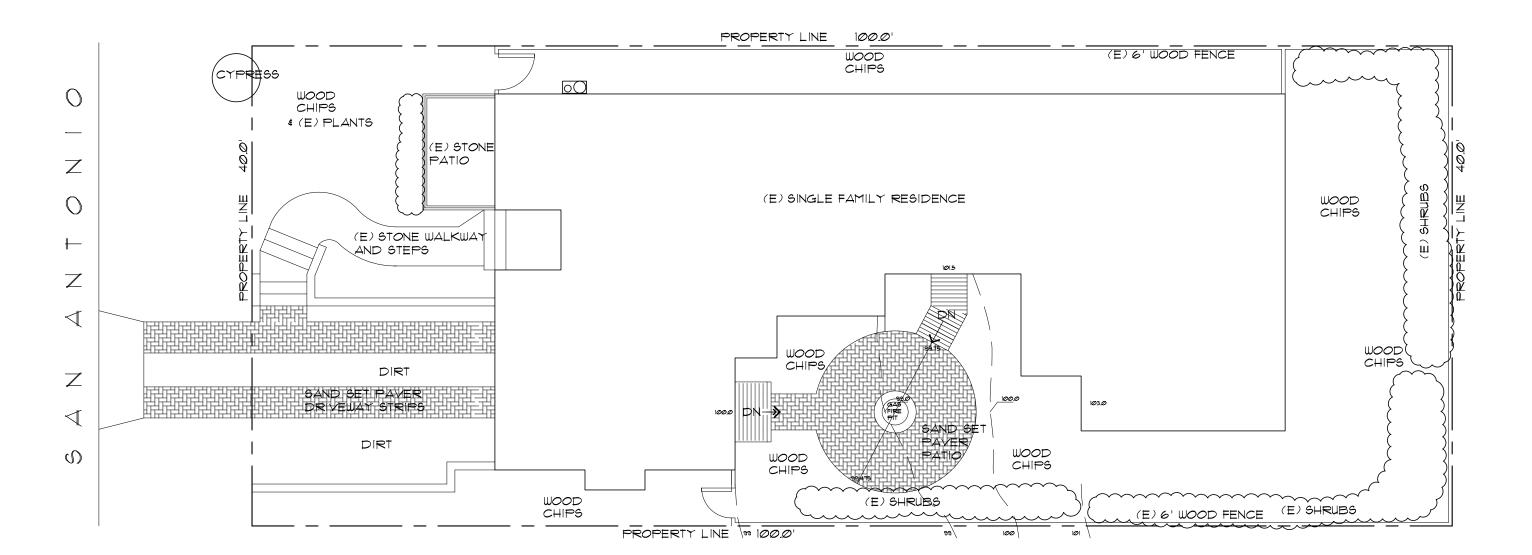

PROPOSED SITE PLAN 1/8" = 1'-0"





STREET VIEW



DAVINCI SHAKE MOUNTAIN



AND PAINTED GUTTERS # DOWNSPOUTS # RAILINGS SHERWIN WILLIAMS ENDURING BRONZE SW7Ø55



STUCCO WINDOWS & DOORS SHERWIN WILLIAMS SW6385 1 STANDARD CASEMENT





STONE WALL AT PATIO SIERRA PACIFIC CARMEL OR SANTA MARIA STONE



FRONT DOOR

DUTCH DOOR

42" WIDE

FINISH

CONC. PAYERS BELGARD

DUBLIN

NATURAL WOOD COLOR-VICTORIAN

GARAGE DOOR NATURAL WOOD FINISH

PROJECT DATA

OWNER:	LYNNE HERMLE & CRAIG COLLINS
	155 SAN RAFAEL WAY

SAN FRANCISCO, CA 94127 (415) 987-5640

craigjosephcollins@gmail.com SAN ANTONIO 2 SE OF 10TH

SITE ADDRESS: CARMEL, CA APN: Ø1Ø-278-Ø19

SITE AREA: 4000 SF

ZONING CONSTRUCTION TYPE: VΒ

SPRINKLERS:

PROJECT SCOPE:

STORIES: CODES: 2022 CRC, TITLE 24, 2022 CMC, 2022 CPC,

YES

2022 CEC, 2022 CEnC, 2022 CGBC, 2022 CFC AND CALIFORNIA ENERGY CODE

> REPLACE EXISTING WOOD SHAKE ROOF WITH DAYINCI SHAKES, REPLACE ALL WINDOWS WITH SIERRA PACIFIC WINDOWS, PAINT EXTERIOR REMOVE EXISTING WOOD DECK AND DRIVEWAY

PAYERS. REPLACE WITH PAYER PATIO AND PAYER DRIVEWAY STRIPS, REMODEL INTERIOR

NONE TREE REMOVAL


GRADING CUT FILL

WATER SUPPLY BY CAL AM SEWAGE DISPOSAL BY CARMEL WASTE WATER DISTRICT

DRAWING INDEX

- SITE PLANS,PROJECT DATA, VICINITY MAP
- FLOOR PLANS A-2
- A-3 EXTERIOR ELEVATIONS


	EXISTING	ADD	REMOVE	PROPOS	BED
EXISTING SITE ARA	4000 SF			4000	SF
GROUND FLOOR AREA	1600 SF			1600	SF
GARAGE AREA	200 SF			200	SF
TOTAL FLOOR AREA	1800 SF			1800	SF
STONE PATIO (IMPERMEABLE)	58 SF			58	SF
STONE WALK & STAIRS (IMPERMEABLE)	116 SF			116	SF
RETAINING WALL (IMPERMEABLE)	30 SF			3Ø	SF
CONC. STEPPING STONES (IMPERMEABLE)	18 SF		18 SF	Ø	SF
STONE WALKWAYS (IMPERMEABLE)	188 SF		188 SF	Ø	SF
STEPPING STONES (IMPERMEABLE)	14 SF		14 SF	Ø	SF
STONE ROW "RETAINING" WALL (IMPERMEABLE)	58 SF		58 SF	Ø	SF
WOOD DECK (PERMEABLE)	406 SF		406 SF	Ø	SF
PAVER DRIVEWAY (PERMEABLE)	293 SF		133 SF	160	SF
PAVER PATIO (PERMEABLE)	Ø SF	154 SF		154	SF
WOOD LANDINGS (PERMEABLE)	Ø SF	38 SF		38	SF
COVERAGE AREA (IMPERMEABLE)	482 SF		278 SF	204	SF
COVERAGE AREA (PERMEABLE)	699 SF	192 SF	539 SF	352	SF
TOTAL SITE COVERAGE	1131 SF	192 SF	817 SF	556	SF

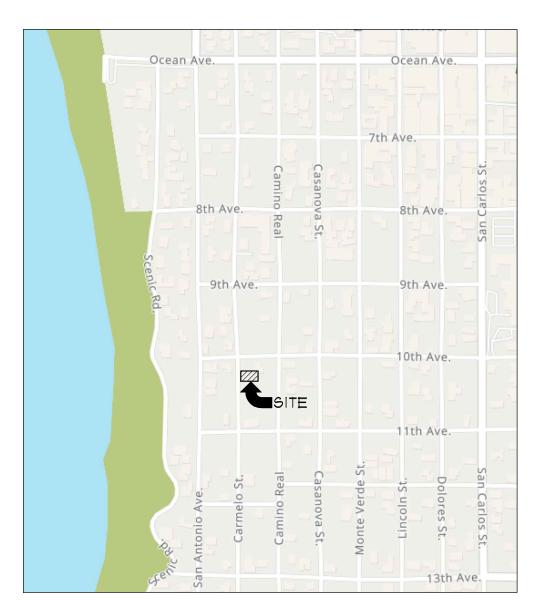

VICINITY MAP

NTS



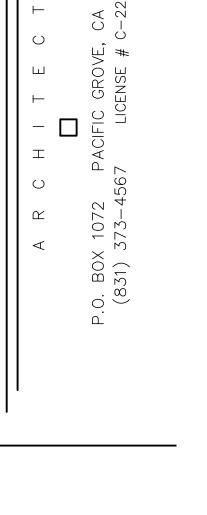

REVISIONS

DATE

7/11/2*0*24 PROJECT NO. 2*400*5 DRAWN BY:

CHECKED BY:

SHEET TITLE:

SITE PLAN

SHEET NO.

OF THREE

Approved 8/9/2024 DS 24127 (Hermle & Collins) Carmel-by-the-Sea Community Planning and Building Jacob Olander, Assistant Planner PRIMARY CLOSET (E) BREAKFAST KITCHEN BEDROOM DINING DECK >-ROOM ______ L==== DASHED LINES INDICATE
WALLS, CABINETS, FIXTURES
BEING REMOVED. CAP OFF
UTILITIES AS REQUIRED | | | | LIVING ROOM WOOD DECK rt = = = = = EXISTING/DEMO PLAN 1/4" = 1'-0" (Q) 11'-Ø" PRIMARY (E) DECK CLOSET DINING KITCHEN BEDROOM 2 BEDROOM (101) $\langle c \rangle$ SAND SET PAVER DRIVE STRIPS

SAND SET PAVER

LIVING/DINING

 $\langle A \rangle$

(104)

STONE FACE ON SHORT VERTICAL FACE

1/4" = 1'-0"

BATH

PRIMARY BEDROOM

SHOWER

PRIMARY

PRIMARY

100.0 G

PATIO # WALKS

PROPOSED PLAN

BEDROOM

CHECKED BY:

SHEET TITLE:

SHEET NO. A = 2

OF THREE



PROPOSED WEST

1/4" = 1'-0"

	DOOR SCHEDULE							
MARK	SIZE	LOCATION	MATERIAL	CORE	TYPE	REMARKS	HARDWR	MODEL
101	3'-6"x6'-8"	LIVING ROOM	W00D	WD/GLS	SWING	$ ^34$ " THICK, TEMP'D , DUTCH DOOR	ENTRY	
1Ø2	2'-8"×6'-8"	DINING ROOM	WOOD	WD/GLS	SWING	SNGL LITE FR, TEMP'D, W/ FIXED SIDELITES 7' TOTAL	ENTRY 2	
103	10'-0"x6'-8"	LIVING ROOM	WOOD	WD/GLS	SLID'G	SNGL LITE FR, TEMP'D, PR 2'-6" SLIDING W/ 2 FIXED	ENTRY 2	
1004	PR 2'-6"x6'-8"	LIVING ROOM	WOOD	WD/GLS	SWING	SNGL LITE FR, TEMP'D	ENTRY 2	
105	2'-6"x9'-0"	HALLWAY	WOOD	WD/GLS	SWING	SNGL LITE FR, TEMP'D	ENTRY 2	

DOOR NOTES:

1. ALL GLAZING TO BE DOUBLE GLAZED, TEMP'D. U.O.N. 2. INTERIOR DOORS TO BE STAIN GRADE, CLEAR ALDER, U.O.N.

2. INTERIOR DOORS TO DE S	STAIN GRADE, CLEAR ALDER, GON.
3. EXTERIOR PATIO DOORS	AND SWINGING DOORS TO MATCH WINDOWS, U.O.N

PROF	OSED	SOUTH
1/4" = 1'-0"		

	WINDOW SCHEDULE						
MARK	SIZE	LOCATION	TYPE	REMARKS			
Д	(3) 2'-Ø"×4'-6"	LIVING ROOM	CSMT/FIX	xox			
В	(3) 2'-Ø"×4'-6"	LIVING ROOM	CSMT/FIX	xox			
С	4'-Ø"×4'-6"	STAIR	DBL CSMT	TEMP			
D	2'-6"×4-6"	HALLWAY	CASEMENT	TEMP			
E	2'-6"×7'-6"	HALLWAY	CASEMENT	TEMP			
F	(3) 2'-Ø"×4'-6"	BATH	CSMT/FIX	TEMP , XOX			
G	(3) 2'-Ø"×4'-6"	BATH	CSMT/FIX	TEMP , XOX			
H	PR 2'-6"x8'-Ø"	PRIMARY BEDRM	CASEMENT				
J	(4) 2'-Ø"×4'-6"	PRIMARY BEDRM	CSMT/FIX	xoox			
K	2'-6"×4-6"	PRIMARY BEDRM	CASEMENT	EGRESS			
L	2'-6"×4-6"	PRIMARY BEDRM	CASEMENT				
М	(3) 2'-Ø"×4'-6"	PRIMARY BATH	CSMT/FIX	TEMP , XOX			
N	2'-6"×4-6"	PRIMARY BATH	CASEMENT	TEMP			
P	4'-Ø"×4'-6"	BEDROOM 2	DBL CSMT	EGRESS			
Q	4'-Ø"×4'-6"	BEDROOM 1	DBL CSMT	EGRE66			

WINDOW NOTES:

- 1. ALL WINDOWS AND EXTERIOR DOORS TO BE SIERRA PACIFIC ALUMINUM CLAD, WOOD BRONZE COLOR
- 2. ALL GLAZING TO BE LOW "E" GLASS 3. PATIO AND EXTERIOR SWINGING DOORS TO MATCH SASH COLOR
- 4. ALL DOORS AND WINDOWS TO HAVE A 2" NAILING FIN.

REVISIONS

DATE

CHECKED BY: SHEET TITLE:

7/11/2*0*24

DATE:

PROJECT NO.

DRAWN BY:

EXTERIOR ELEVATIONS

SHEET NO.

OF THREE

Community Planning and Building
Jacob Olander, Assistant Planner

Exterior Colors for San Antonio 2 SE of 10th

Aluminum Gutters & Downspouts & Wood Trim Sherwin Williams Enduring Bronze SW 7055

Stucco Benjamin Moore - Bone OC-143

Sierra Pacific Windows Aluminum Clad Bronze #401

