

#### NOTICE OF APPROVAL

The Department of Community Planning & Building of the City of Carmel-by-the-Sea has approved a Project pursuant to the City's Municipal Code. Persons interested in the project may review additional materials available at the Department of Community Planning & Building located at City Hall on Monte Verde Street between Ocean and 7<sup>th</sup> Avenues, phone number 831-620-2010.

The decision to approve this project may be appealed within 10 days from the date of this by filing a written appeal with the Department of Community Planning & Building.

Planning Case #: Design Study 24126
Owner Name: FORDHAM STANFORD LP
Case Planner: Marnie R. Waffle, AICP, Principal Planner
Date Posted:
<b>Date Approved:</b> 06/26/2024
Project Location: San Antonio 4 NE of 4th
<b>APN</b> #: 010242012000 <b>BLOCK/LOT:</b> NN/LOTS 8 AND 10
Applicant: Kumaresh Sekaran, Architect
<b>Project Description:</b> This approval of Design Study application DS 24126 (Hoang-Nguyen) reauthorizes window modifications approved under Design Study DS 22-097 and subsequently omitted from Building Permit BP 23-075 and the installation of an additional skylight on the rear (east) roof plane for a single-family residence currently being remodeled at San Antonio 4 NE of 4th Avenue in the Single-Family Residential (R-1) District. All work shall be performed as depicted in the plans prepared by Studio Schicketanz, stamped approved, and on file in the Community Planning & Building Department unless modified by the conditions of approval. *Associated Design Study

Upon completion of the 10 calendar-day appeal period, please return this form, along with the Affidavit of Posting, to the case planner noted above.

No 🗸

approvals include DS 22-097 and DS 23-271.

Can this project be appealed to the Coastal Commission? Yes

	CONDITIONS OF APPROVAL
No.	Standard Conditions
1.	<b>Authorization.</b> This approval of Design Study application DS 24126 (Hoang-Nguyen) reauthorizes window modifications approved under Design Study DS 22-097 and subsequently omitted from Building Permit BP 23-075 and the installation of an additional skylight on the rear (east) roof plane for a single-family residence currently being remodeled at San Antonio 4 NE of 4 <sup>th</sup> Avenue in the Single-Family Residential (R-1) District. All work shall be performed as depicted in the plans prepared by Studio Schicketanz, stamped approved, and on file in the Community Planning & Building Department unless modified by the conditions of approval contained herein.
	*Associated Design Study approvals include DS 22-097 and DS 23-271.
2.	Codes and Ordinances. The project shall be constructed in conformance with all requirements of the R-1 zoning district. All adopted building and fire codes shall be adhered to when preparing the working drawings. If any codes or ordinances require design elements to be changed, or if any other changes are requested when such plans are submitted, such changes may require additional review and subsequent approval by the Director.
3.	Permit Validity. In accordance with CMC Section 17.52.170 (Time Limits on Approvals and Denials), a residential design study approval remains valid for a period of 12 months from the date of action. During this time, the project must be implemented, or the approval becomes void. Implementation is effected by erecting, installing, or beginning the installation of the improvement authorized by the permit, as determined by the Director. Extensions to this approval may be granted consistent with CMC 17.52.170.C.
4.	<b>Fire Sprinklers - Residential.</b> Additions, alterations, or repairs to existing structures that involve the addition, removal, or replacement of 50 percent or more of the linear length of the walls (interior and exterior) within a 5-year period shall require the installation of an automatic residential fire sprinkler system in accordance with the California Building and Fire Codes (CMC 15.08.135).
5.	Modifications. The Applicant shall submit in writing, with revised plans, to the Community Planning and Building staff any proposed changes to the approved project plans prior to incorporating those changes. If the Applicant changes the project without first obtaining City approval, the Applicant will be required to submit the change in writing, with revised plans, within two weeks of the City being notified. A cease work order may be issued at any time at the discretion of the Director of Community Planning and Building until a) either the Planning Commission or Staff has approved the change, or b) the property owner has eliminated the change and submitted the proposed change in writing, with revised plans, for review. The project will be reviewed for its compliance with the approved plans prior to the final inspection.
6.	<b>Exterior Revisions to Planning Approval Form.</b> All proposed modifications that affect the exterior appearance of the building or site elements shall be submitted on the "Revisions"

to Planning Approval" form on file in the Community Planning and Building Department. Any modification incorporated into the construction drawings not listed on this form shall not be deemed approved upon issuance of a building permit.

7. Conflicts Between Planning Approvals and Construction Plans. It shall be the responsibility of the Owner, Applicant, and Contractor(s) to ensure consistency between the project plans approved by the Planning Staff, the Planning Commission, or the City Council on appeal and the construction plans submitted to the Building Division as part of the Building Permit review. Where inconsistencies between the Planning approval and the construction plans exist, the Planning approval shall govern unless otherwise approved in writing by the Community Planning & Building Director or their designee.

When changes or modifications to the project are proposed, the Applicant shall clearly list and highlight each proposed change and bring each change to the City's attention. Changes to the project incorporated into the construction drawings that were not clearly listed or identified as a proposed change shall not be considered an approved change. Should conflicts exist between the originally approved project plans and the issued construction drawings that were not explicitly identified as a proposed change, the plans approved as part of the Planning Department Review, including any Conditions of Approval, shall prevail.

- 8. **Skylights & Skylight Shades.** Prior to the issuance of a building permit, the Applicant shall include in the construction drawings the manufacturer's specifications for all skylights and skylight shades. Skylights shall be low-profile and use non-reflective glass to minimize light and glare visible from adjoining properties. Skylight flashing shall match the roof color. Manual or automatic shades shall be installed in each skylight to reduce visible light transmission during the hours of darkness.
- 9. **Indemnification.** The Applicant agrees, at his or her sole expense, to defend, indemnify, and hold harmless the City, its public officials, officers, employees, and assigns from any liability; and shall reimburse the City for any expense incurred, resulting from, or in connection with any project approvals. This includes any appeal, claim, suit, or other legal proceedings to attack, set aside, void, or annul any project approval. The City shall promptly notify the Applicant of any legal proceeding and cooperate fully in the defense. The City may, at its sole discretion, participate in any such legal action, but participation shall not relieve the Applicant of any obligation under this condition. Should any party bring any legal action in connection with this project, the Superior Court of the County of Monterey, California, shall be the situs and have jurisdiction for resolving all such actions by the parties hereto.
- 10. **Conditions of Approval.** Prior to the issuance of a building permit, the Applicant shall print a copy of the Resolution adopted by the Planning Commission and signed by the property owner(s) on a full-size sheet within the construction plan set submitted to the Building Safety Division.

#### **Landscape Conditions**

- 11. **Tree Removal Prohibited.** Throughout construction, the Applicant shall protect all trees identified for preservation by methods approved by the City Forester. Trees on or adjacent to the site shall only be removed upon the approval of the City Forester or Forest and Beach Commission.
- 12. **Tree Protection Measures.** Requirements for tree preservation shall adhere to the following tree protection measures on the construction site.
  - Prior to grading, excavation, or construction, the developer shall clearly tag or mark all trees to be preserved.
  - Excavation within 6 feet of a tree trunk is not permitted.
  - No attachments or wires of any kind, other than those of a protective nature, shall be attached to any tree.
  - Per Municipal Code Chapter 17.48.110, no material may be stored within the dripline of a protected tree, including the drip lines of trees on neighboring parcels.
  - Tree Protection Zone. The Tree Protection Zone shall be equal to dripline or 18 inches radially from the tree for every one inch of trunk diameter at 4.5 feet above the soil line, whichever is greater. A minimum of 4-foot-high transparent fencing is required unless otherwise approved by the City Forester. Tree protection shall not be resized, modified, removed, or altered in any manner without written approval. The fencing must be maintained upright and taught for the duration of the project. No more than 4 inches of wood mulch shall be installed within the Tree Protection Zone. When the Tree Protection Zone is at or within the drip line, no less than 6 inches of wood mulch shall be installed 18 inches radially from the tree for every one inch of trunk diameter at 4.5 feet above the soil line outside of the fencing.
  - Structural Root Zone. The Structural Root Zone shall be 6 feet from the trunk or 6 inches radially from the tree for every one inch of trunk diameter at 4.5' above the soil line, whichever is greater. Any excavation or changes to the grade shall be approved by the City Forester prior to work. Excavation within the Structural Root Zone shall be performed with a pneumatic excavator, hydro-vac at low pressure, or another method that does not sever roots.
  - If roots greater than 2 inches in diameter or larger are encountered within the approved Structural Root Zone, the City Forester shall be contacted for approval to make any root cuts or alterations to structures to prevent roots from being damaged.
  - If roots larger than 2 inches in diameter are cut without prior City Forester approval or any significant tree is endangered as a result of construction activity, the building permit will be suspended, and all work stopped until an investigation by the City Forester has been completed, and mitigation measures have been put in place.

#### **Special Conditions**

13. **Conditions of Approval Acknowledgement**. Prior to the issuance of a building permit revision, a completed **Conditions of Approval Acknowledgment** form shall be included in the construction drawings. The form shall be signed by the Property Owner, Applicant, and Contractor prior to the issuance of a building permit.

DS 24126 (Hoang-Nguyen) Conditions of Approval June 26, 2024 Page 4 of 4

and obtain a building permit from the Community Planning & Building Department. Acknowledgment and acceptance of conditions of approval: Property Owner Signature Printed Name Date Property Owner Signature

Printed Name

Date

14. **Building Permit Required.** Prior to commencing work on-site, the applicant shall apply for

# **SCOPE OF WORK**

ADDITION OF (1) NEW SKYLIGHT AND (4) NEW WINDOWS TO THE APPROVED PERMIT # DS 23-271 AND # BP 23-075. ADDITION OF (N) KITCHEN SINK AND DISHWASHER IN HOME THEATER, ADDITION OF ONE (N) SHOWER HEAD IN BATHROOM ADJACENT TO HOME THEATER. NO FURTHER CHANGES TO THE ORIGINAL SCOPE OF WORK: INTERIOR REMODEL OF A SINGLE-FAMILY RESIDENCE OF 6372SFT; INCL REPLACEMENT OF DOORS & DEMOLITION OF CHIMNEYS. EXISTING FOOTPRINT & BLDG HT. SHALL REMAIN THE SAME. SCOPE OF WORK ENTAILS 1368 SF & IS LESS THAN 50% OF (E) STRUCTURE. NO ALTERATIONS TO EXISTING SITE PLAN/LANDSCAPE & FENCE. NO TREES TO BE REMOVED.

LOT SIZE IS 10,873 SFT (0.25 ACRES) AND EXISTING NON-CONFORMING LOT COVERAGE SHALL REMAIN THE SAME. EXISTING NON-CONFORMING IMPERMEABLE COVERAGE SHALL REMAIN THE SAME WITH NO CHANGES TO EXISTING LANDSCAPE.

EXISTING 2 STORIES SHALL REMAIN THE SAME AND NO CHANGE IN BLDG HEIGHT.

EXISTING LENGTH AND HEIGHT OF WOODEN FENCE ON LEFT/RIGHT/REAR SIDES SHALL

EXISTING ARCHITECTURAL STYLE OF STONE CLADDING/STUCCO WALLS WITH COMBINATION OF SLOPED/FLAT ROOFS SHALL REMAIN THE SAME. NEW DOORS/WINDOWS

'FINAL DOCUMENTATION FOR VALUATION OF CONSTRUCTION SHALL BE SUBMITTED TO THE

1.	TOTAL LENGTH OF ALL EXT. & INT. WALLS OF ORIGINAL EXISTING BLDG.	:	1330.58
2.	TOTAL LENGTH OF ALL WALLS TO BE REPLACED DURING REMODEL.	:	44.57
3.	TOTAL LENGTH OF ALL WALLS TO BE REMOVED & NOT REPLACED DURING REMODEL.	:	88.42
4.	TOTAL LENGTH OF ALL PROPOSED WALLS THAT HAVE NOT BEEN ALREADY COUNTED.	:	30.75
5.	TOTAL LENGTH OF WALLS GETTING REMODEL (ADD STEP 2, 3 & 4)	:	163.74
6.	PERCENTAGE OF REMODEL (DIVIDE STEP 5 TOTAL BY STEP 1 AND MULTIPLY VALUE BY 100.)	:	<u>12.30 %</u>

## **DRAWING INDEX DRAWING TITLE** 6 A0.1 COVER SHEET A0.2 CAL. GREEN A0.3 | CAL. GREEN - 2 & SUBMITTALS A0.4 PROJECT PLANNING CONDITIONS & GENERAL NOTES A1.0 SURVEY 6 3 A1.1 PROPOSED SITE PLAN A1.2 CONSTRUCTION MANAGEMENT PLAN A1.3 | CONSTRUCTION MANAGEMENT NOTES 6 \ A2.0 MAIN LEVEL EXISTING / DEMOLITION FLOOR PLAN A2.1 UPPER LEVEL EXISTING FLOOR PLAN 「6 丫 A2.2 MAIN LEVEL - PROPOSED FLOOR PLAN A2.3 ROOF PLAN A3.0 NORTH EXTERIOR ELEVATIONS 1 A3.1 EAST EXTERIOR ELEVATIONS A3.2 | SOUTH EXTERIOR ELEVATIONS A3.3 WEST EXTERIOR ELEVATION A3.5 MAIN RESIDENCE BUILDING SECTIONS A4.0 DOOR SCHEDULES AND TYPES A4.1 PLUMBING & APPLIANCE SCHEDULE A6.0 RCP - LEVEL 1 A8.0 WALL & FLOOR TYPES DTL, VENT DETAILS TRUCTURAL 4 S-1.0 GENERAL NOTES S-2.0 PROPOSED FOUNDATION PLAN S-2.1 PROPOSED CEILING FRAMING PLAN S-2.2 PROPOSED ROOF FRAMING PLAN S-3.1 PROPOSED SECTIONS S-3.2 PROPOSED ROOF FRAMING DETAILS T-1 ENERGY COMPLIANCE T-2 ENERGY COMPLIANCE T-3 2022 LOW-RISE RESIDENTIAL MANDATORY MEASURES SUMMARY

#### CARMEL-BY-THE-SEA PLANNING DEPARTMENT **APPROVED**


Permit #: DS 24126 (Hoang-Nguyen) Date Approved: June 26, 2024 Planner: \_M. Waffle \*Skylight

#### **ENTR.** ENTRANCE GT. **GLASS TILE** MTG. MEETING S. SOUTH T.S.S. TOP OF STRUCTURAL STEEL SAFB SOUND ATTENUATION FIRE BLANKET **EQ.** EQUAL GWB. GYPSUM WALL BOARD METAL TYP. TYPICAL EQP. EQUIPMENT GYP. NORTH SEALED CONCRETE SOLID CORE TZ TERRAZZO GYPSUM E.A. EACH SIDE HC. **HOLLOW CORE** NOT APPLICABLE SCH. SCHEDULE UNF. UNFINISHED **EST.** ESTIMATE **HD(R)** HEAD(ER) NAT. NATURAL SCP SKIM COAT PLASTER U.N.O. UNLESS NOTED OTHERWISE **EX.** EXISTING N.I.C. NOT IN CONTRACT SEC. S.F. **UPD**. UPHOLSTERED **HDWD** HARDWOOD **EXH.** EXHAUST HARDWARE NUMBER SQUARE FEET **VENT.** VENTILATION **EXP.** EXPANSION NOM. NOMINAL SHT. H.M. HOLLOW METAI SHEET **VERT.** VERTICAL HORZ. SIG. SOUND INSULATING GLASS VEST. VESTIBULE **EXT.** EXTERIOR HORIZONTAL NOISE REDUCTION COEFFICIENT SIM. F.A.I. FRESH AIR INTAKE N.T.S. NOT TO SCALE SIMILAR VERIFY IN FIELD HOUR **F.D.** FLOOR DRAIN H.S. **HEADED STUD** SIP STRUCTURAL INSULATED PANEL VENEER PLASTER O OVER V.R. FDN. FOUNDATION HT. HEIGHT O.C. ON CENTER S.J. SCORED JOINT VENETIAN PLASTER F.E. FIRE EXTINGUISHER HTG. HEATING O.D. OUTSIDE DIAMETER **SPKLR.** SPRINKLER WIDE, WIDTH FF FINISH FLOOR OR FINISHED FACE HTR. **HEATER SPKR.** SPEAKER W(O)/ WITH (OR WITHOUT) OFF. OFFICE **F.G.** FINISH GRADE HVAC HEATING VENTILATION & AIR CONDITIONING O.H. OPPOSITE HAND SQUARE WALNUT SQ. STUDIO SCHICKETANZ W.C. WATER CLOSET **FGL.** FIBER GLASS IMPERIAL BOARD **OPG** OPENING F.H. FIRE HYDRANT, FLAT HEAD INSIDE DIAMETER STAINLESS STEEL WD. F.H.C. FIRE HOSE CABINET SMI. INCHES **OVHD.** OVERHEAD SEE MNFR. INSTRUCTIONS WDW. WINDOW PERF. PERFORATED SED INSULATION SEE ENGINEERING DRAWINGS **WLP.** WALL PAPER SSD INV. **INVERT** PL. PLATE SEE STRUCTURAL DRAWINGS W.P. WATER PROOFING WEIGHT

MISC. MISCELLANEOUS

MOUNTED

MASONRY OPENING

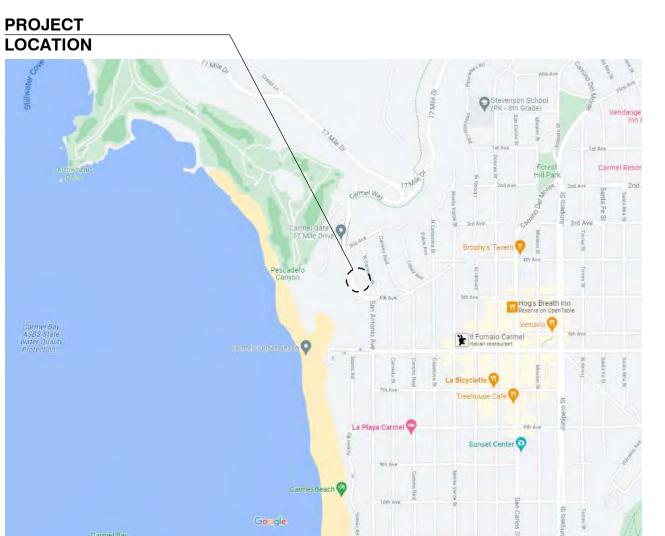

**VICINITY MAP** 

REV. DESCRIPTION DATE RFI#1 REV #1 08/23/23 REV#2 SKYLIGHT 08/28/23 4 REV#3 SKYLIGHT 08/09/23 5 REV#4 WINDOW 02/12/24 6 REV#5 WINDOW & 04/22/24 ADDITION **ARCHITECTURAL COVER SHEET** 

SEKARAN

C - 30015

Scale: Drawn By:

02/08/2023

DWG DRAWING EAST **EXISTING** EACH EA. **EXPANSION JOINT** E.J. **ELEVATION** EL. **ELEC.** ELECTRICAL **ELEV.** ELEVATOR **EMER.** EMERGENCY

**ARCHITECTURAL ABBREVIATIONS** 

C.J.

CPT.

CRS.

CT.

CTR.

CW

DBL.

DET.

DF.

DIA.

DIAG.

DIM.

DKG.

DN.

D.O.

DR.

D.S.

DTL.

ΑT

A.B.T. ANCHOR BOLT

2CP

3CP

A.C.

ACD.

ACT.

AD.

BLK.

BM.

B.M.

B.O.

BR.

BRK.

CAP.

CE.

C.L.

DIAMETER

2 COAT PLASTER

3 COAT PLASTER

AGREGATE BASE

ACCESS DOOR

ACOUSTIC TILE

AREA DRAIN

ADJUSTABLE

ALUMINUM

**ANOD.** ANODIZED

AVG. AVERAGE

A.P. ACCESS PANEL

BOARD

BEAM

BRASS

**B.U.R.** BUILT-UP ROOF

CAPACITY

CEDAR

**CEM.**, CEMENTITOUS

CATCH BASIN

CUBIC FEET/MN.

CAST IRON

CENTER LINE

C.C.F.L..CLOSED CELL FOAM INSULATION

BRICK

B.S. BOTH SIDES

**BSMT.** BASEMENT

CAB. CABINET

CAT. CATALOG

CER. CERAMIC

BLOCKING

BENCH MARK

BOTTOM OF

**BITUM.** BITUMINOUS

**BLDG.** BUILDING

ARCH. ARCHITECTURAL

A.F.F. ABOVE FINISH FLOOR

ASPHALT CONCRETE

A.D.A. AMERICANS W/ DISABILITIES ACT

CLG. CEILING

CLOS. CLOSET

CLR. CLEAR

**CNTR.** COUNTER

C.O. CLEANOUT

COL. COLUMN

CONC. CONCRETE

CORR. CORRIDOR

CONF. CONFERENCE

**COMM.** COMMUNICATION

**CONST. CONSTRUCTION** 

CARPET

COURSE

CENTER

DOUBLE

**CERAMIC TILE** 

COLD WATER

CONT. CONTINUOUS

**CLEAR FINISH WOOD** 

CONC. MASONRY UNIT

CONTROL JOINT

**DEMO** DEMOLITION FIN. FINISH FLR. FLOOR DETAIL DOUGLAS FIF FL. FLUORESCENT DIAMETER **F.O.** FACE OF DIAGONAL F.O.C. FACE OF CONC. DIMENSION F.O.M. FACE OF MASONRY DECKING F.O.S. FACE OF STUD DOWN **F.P.** FIRE PROOFING DOOR OPENING FR. FRAME / FIRE RATED DOOR **F.S.** FULL SIZE/ SCALE DOWNSPOUT **FT.** FOOT / FEET FTG. FOOTING DETAIL **FXTR.** FIXTURE **GA**. GAUGE **GALV.** GALVANIZED G.C. GENERAL CONTRACTOR GEN. GENERAL GFCI GROUND FAULT CIRCUIT INTERRUPTER MEZZ MEZZANINE

G.I. GALVANIZED IRON

**GL**. GLASS

**GLM.** GLUELAM

E.M.R. ELEVATOR MACHINE RM.

ENCL. ENCLOSURE, ENCLOSED

**ENGR.** ENGINEER

JAN. JT. LB L.G.

**JANITOR** JOINT ANGLE POUND LONG, LENGTH LAM. LAMINATE(ION) LAVATORY LAV. LONG LEG HORZ LLV LONG LEG VERT LT(G) LIGHT(ING) LVR. LOUVER MACH. MACHINE MAX.

**GLZT.** GLAZING

GRADE

GR.

MIN.

MINIMUM

GLASS MOSAIC TILE

MAXIMUM MECH. MECHANICAL **MEMB** MEMBRANE MANUFACTURER MAN HOLE

PLAS. PLASTER PLBG. PLUMBING PLG. PANELING PLY PLYWOOD PM. PERF. MT POL POLISH(ED) PR. PAINTED **PARTITION** PAINTED WOOD QUARRY TILE QTY. QUANTITY RADIUS/ RISER RETURN AIR **ROOF DRAIN** R.D.

REFRIGERATOR

**REINF.** REINFORCED

**REV.** REVISED(ION)

RES. RESIN

ST STONE TILE / STONE STL STEEL STC **STD** STANDARD **STOR.** STORAGE **STRUCT**STRUCTURA SUSP. SUSPENDED

**REQD.** REQUIRED

ROOM

**ROUGH OPENING** 

RM.

R.O.

WT. YD. SOUND TRANSMISSION COEFFICIENT STAINED WOOD TREAD TILE BACKER BOARD

T.O.P. TOP OF PLATE

T.O.S. TOP OF SLAB

T.O.W. TOP OF WALL

YARD

T.C. TERRA COTTA TEL. TELEPHONE **TEMP** TEMPORARY TERR. TERRACE TONGUE AND GROOVE T&G THK THICK

THRU. THROUGH

TME TO MATCH EXISTING

TEMPERED

REMAIN THE SAME. NO FENCE ON THE FRONT SIDE. BEING ADDED TO MATCH THE EXISTING WINDOWS.


NO INCREASE IN WATER FIXTURES COUNT

PROJECT SHALL COMPLY WITH 2022 CA RESIDENTIAL CODE

BUILDING DEPARTMENT PRIOR TO FINAL INSPECTION'.

#### FIRE SPRINKLER CALCULATION FORM

1.	TOTAL LENGTH OF ALL EXT. & INT. WALLS OF ORIGINAL EXISTING BLDG.	:	1330.58
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C - 30015

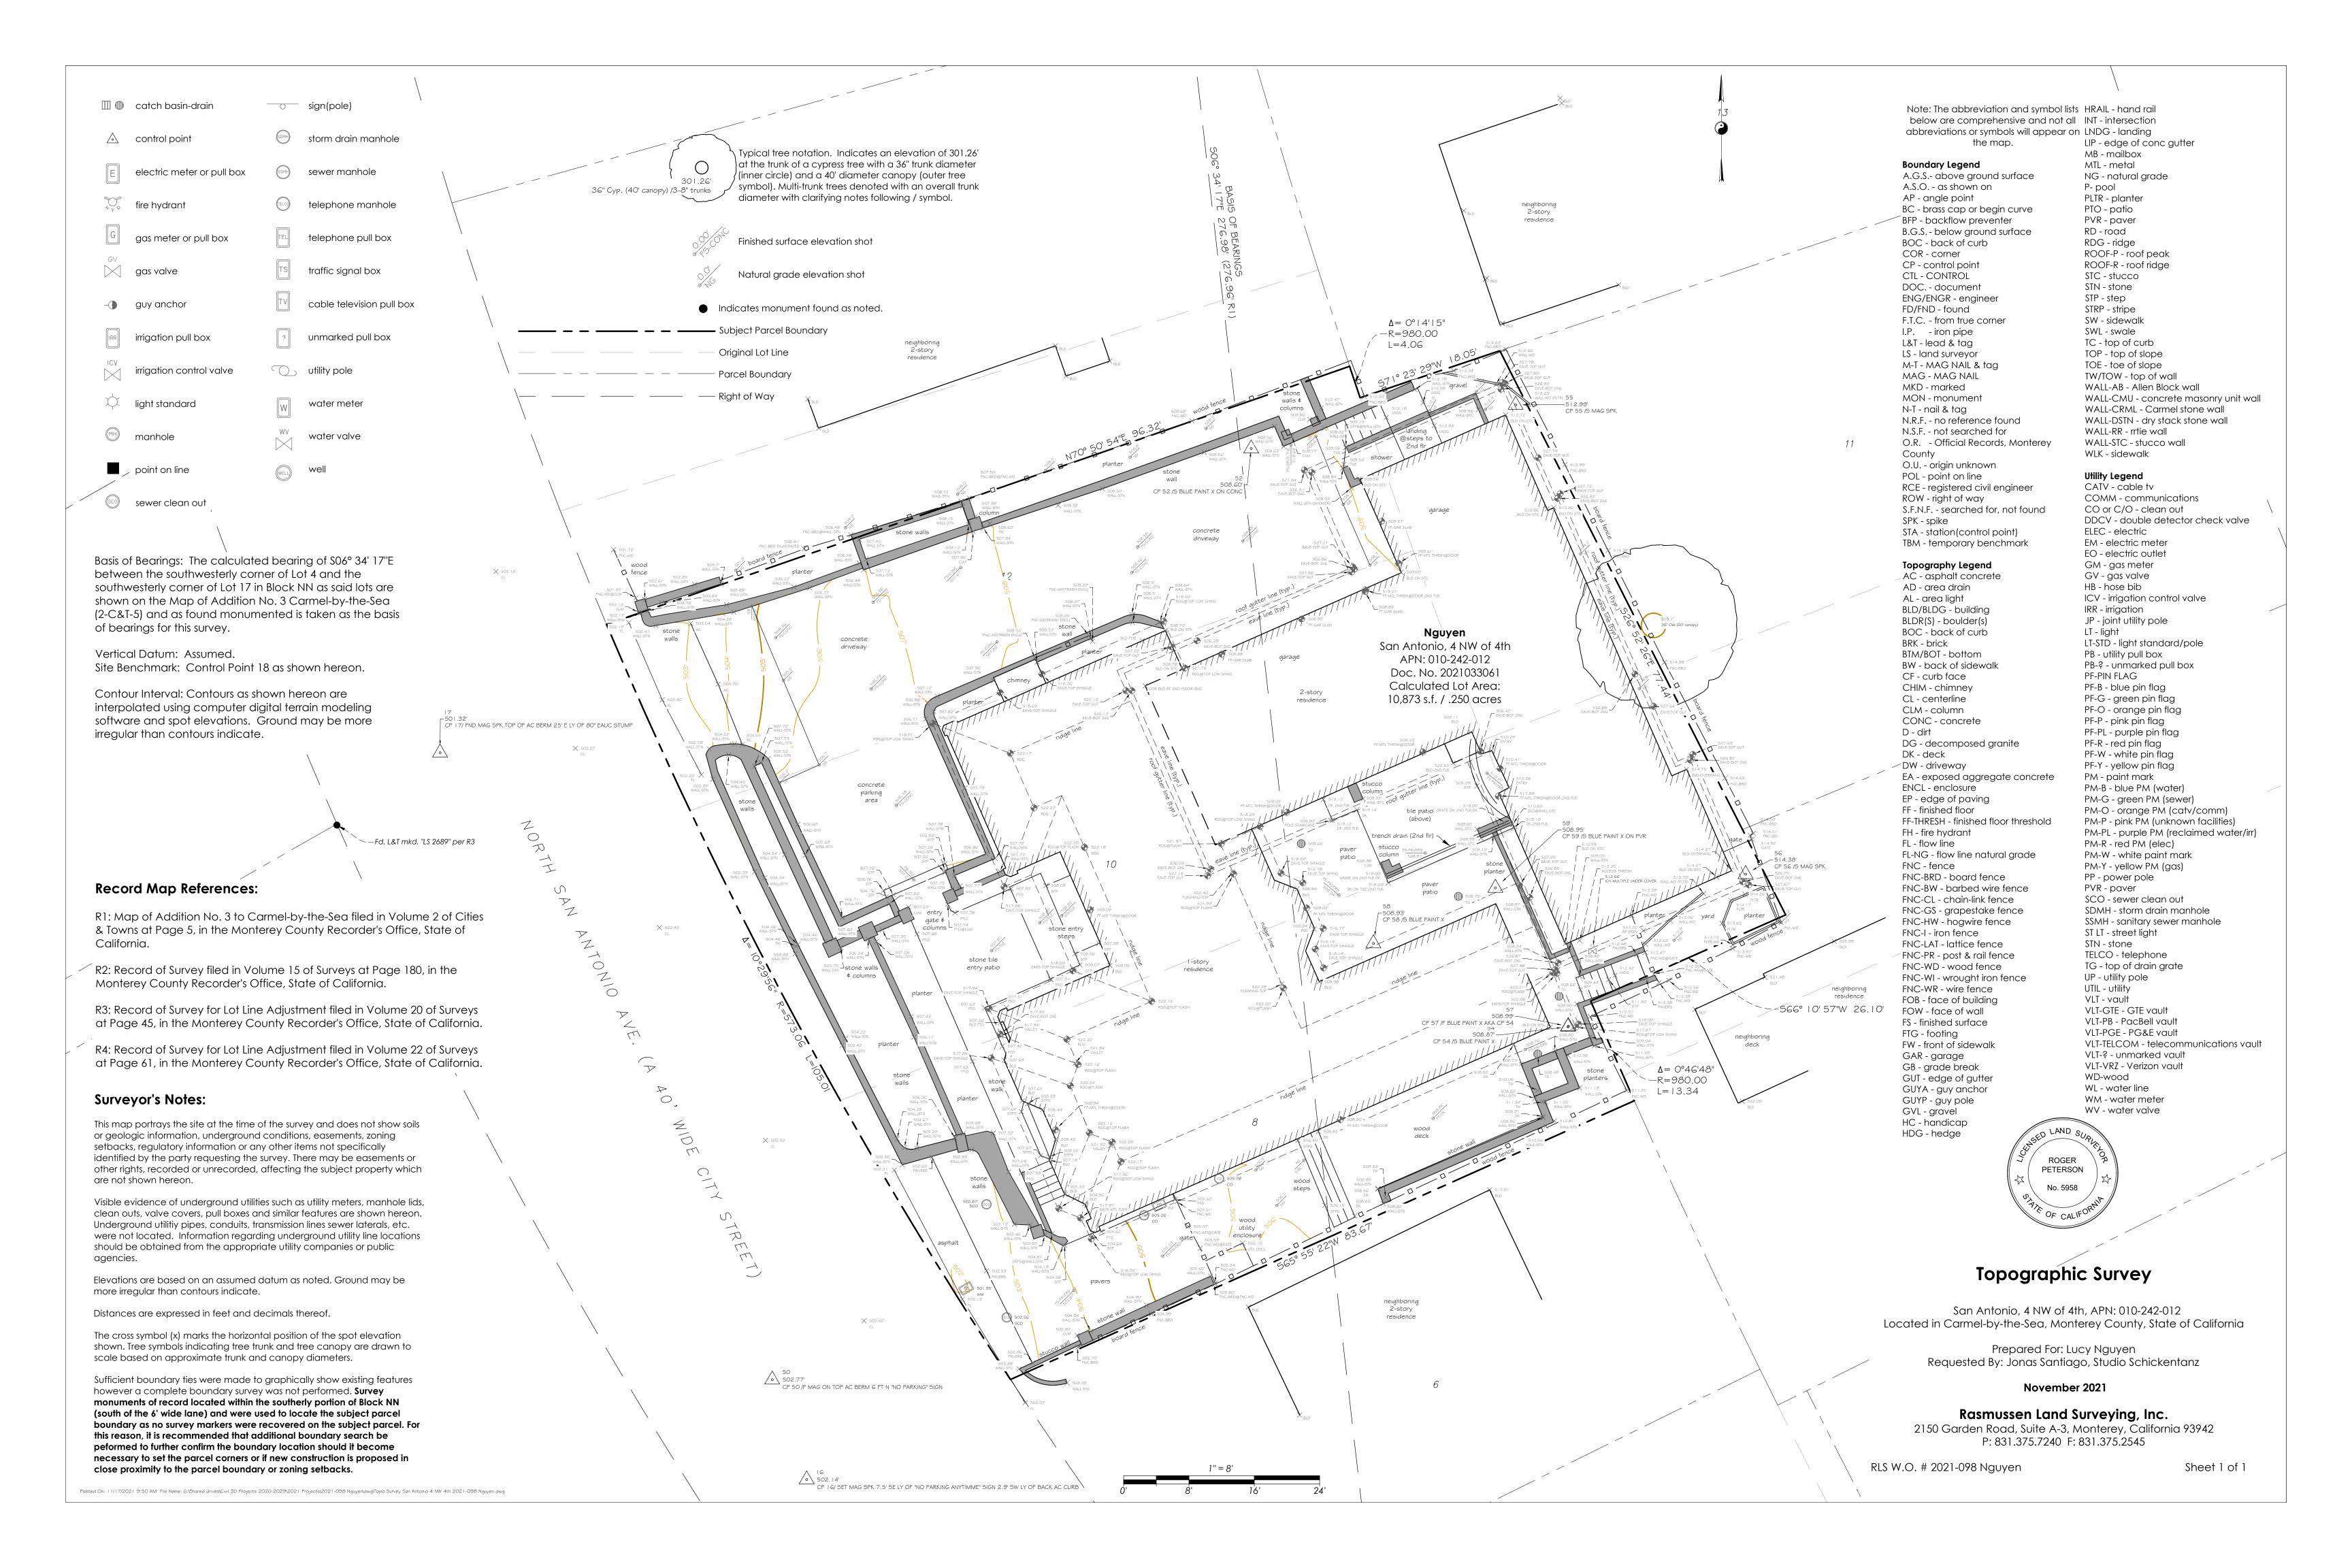STUDIO!

REV. DESCRIPTION DATE 6 REV#5 WINDOW & 04/22/24 SKYLIGHT ADDITION

ARCHITECTURAL

PROPOSED SITE **PLAN** 

Scale: As indicated Drawn By:

02/08/2023



RESIDENCE

NGUYEN - HOANG

F 4TH CARMEL BY THE SEA CA 93923

INGUYER SANDON OF THE SOUND SANDON OF THE SANDON OF THE

STUDIO SCHICKETANZ
P.O. Box 2704, Carmel, CA, 93921 831.622.9000

ARCHITECTURAL

ROOF PLAN

Scale: 1/4" = 1'-0"

Drawn By: AN

A2.3

02/08/2023

**DISCLAIMER** 

1/4" = 1'-0"

REV. DESCRIPTION DATE 1 RFI#1 04/25/23 5 REV#4 WINDOW 02/12/24 ADDITION


6 REV#5 WINDOW & 04/22/24 SKYLIGHT ADDITION

**EXTERIOR ELEVATIONS** 


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02/08/2023

PROPOSED NORTH ELEVATION

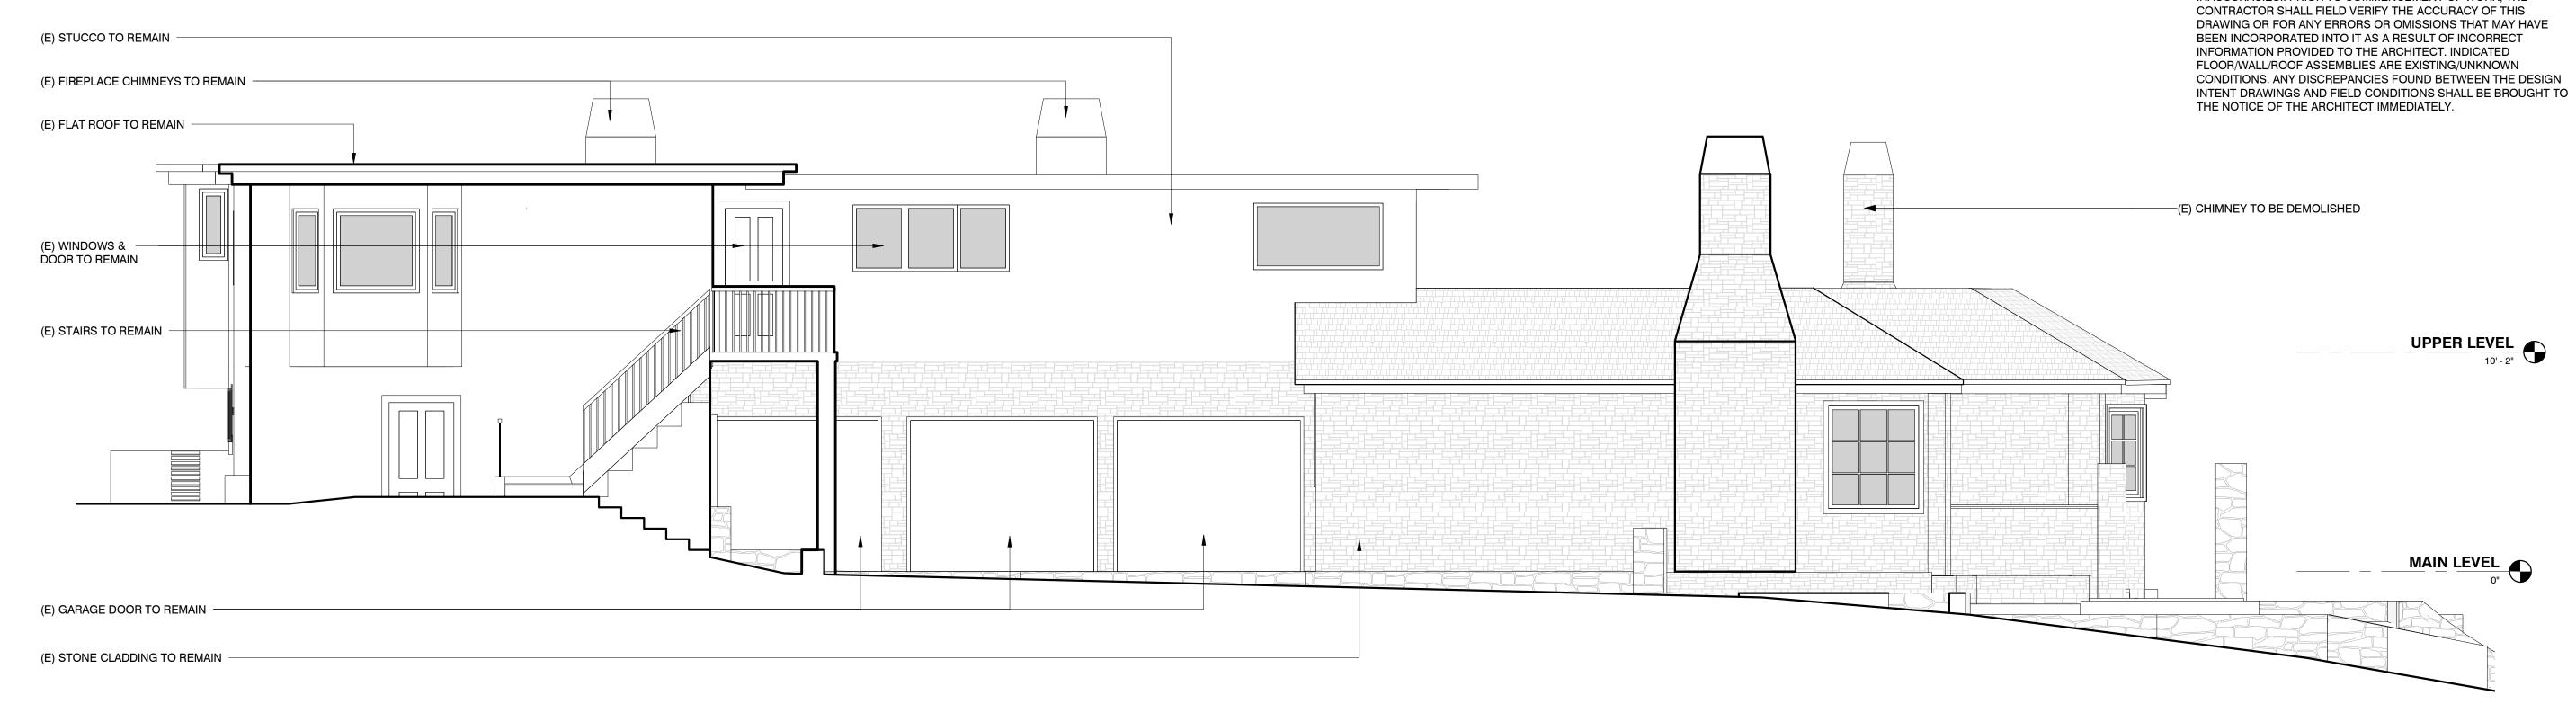

# **EXISTING NORTH ELEVATION**

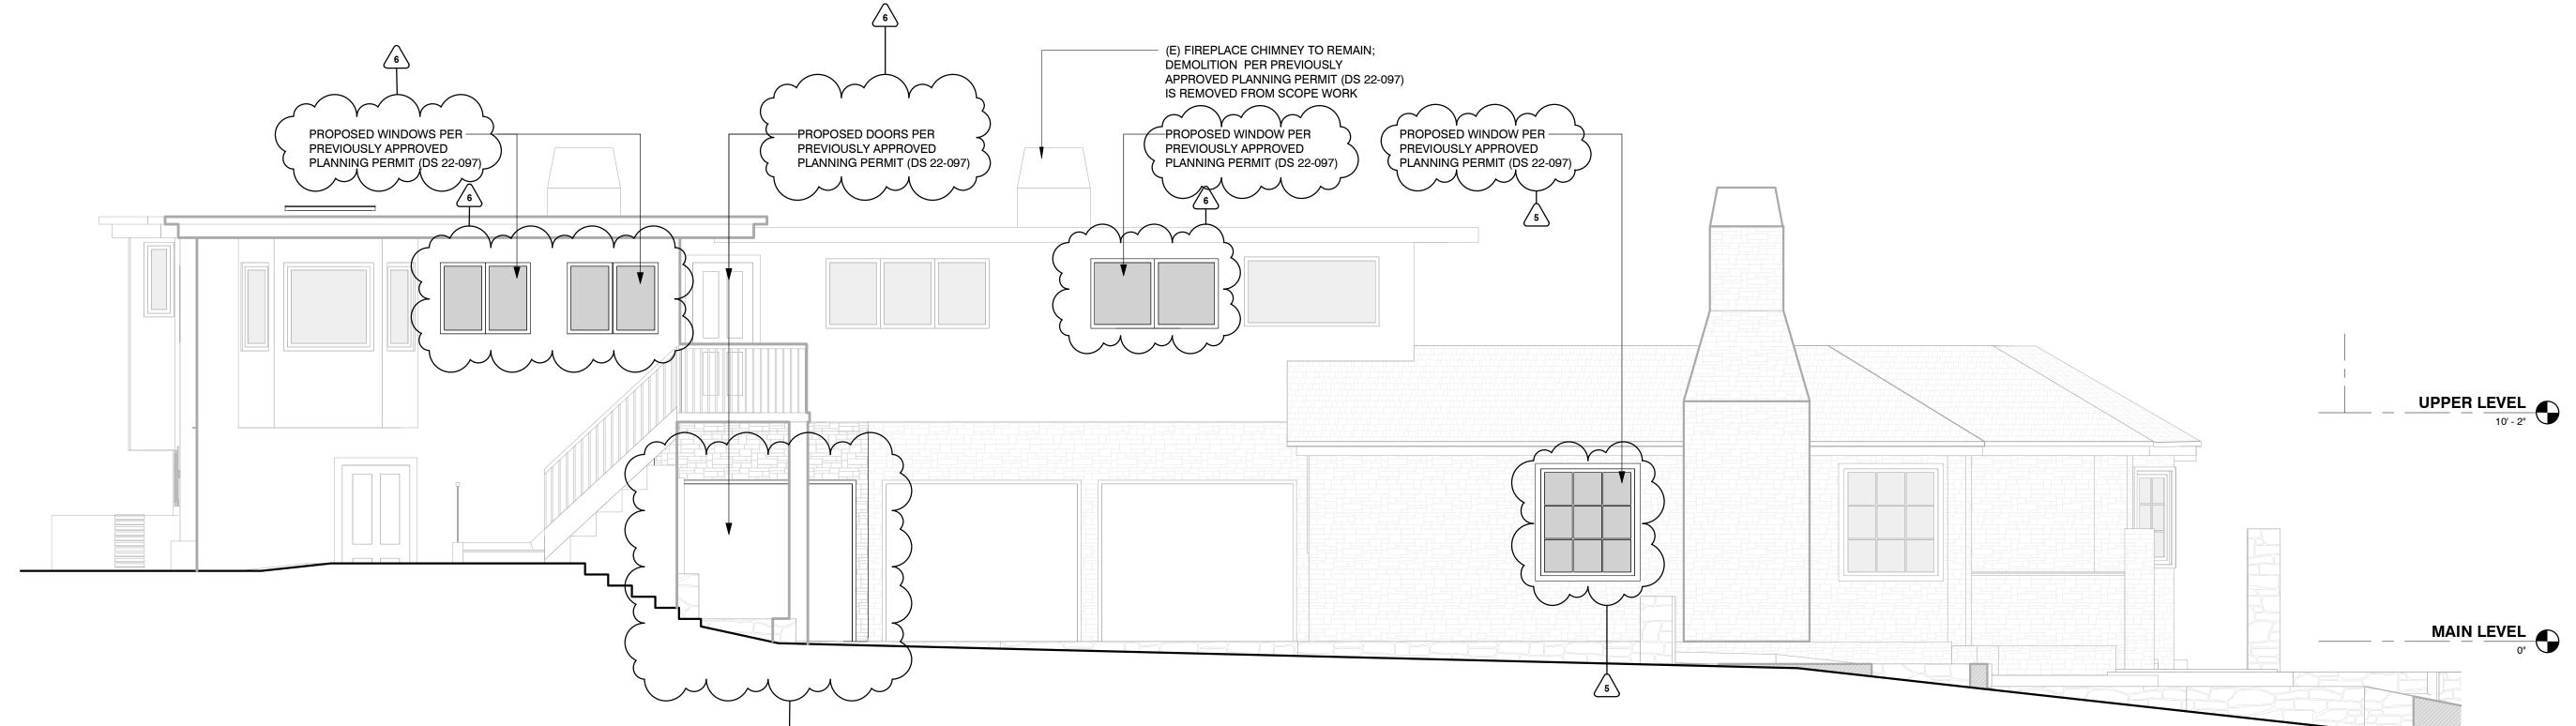



	Door Schedule															
			Si	ize	<u></u>	_		(əln						Manufacturer		
Revision	Door Number	LOCATION	Width	Height	Exterior. Frame & Sash Materi	Interior. Frame & Sash Material	Door Type	Hardware Group (See Schedu	Screens	Glass Type	Head	Jamb	Sill	Brand	Model	Numbered notes/ Remarks
	D02	PRIMARY BATH	3' - 0"	6' - 9"	MTL	MTL.	В							MARVIN DOORS AND WINDOWS OR APPROVED EQUAL		FINISH/COLOR TO MATCH EXISITNG
	D03	KITCHEN	3' - 0"	7' - 7"	MTL	MTL.	C							MARVIN DOORS AND WINDOWS OR APPROVED EQUAL		FINISH/COLOR TO MATCH EXISITING
	D08	PRIMARY BEDROOM	2' - 6"	7' - 0"	WD	WD	D							12 1 2 1 2 1 2 1 2 1 2 1 2 1 2 1 2 1 2		,
	D09	PRIMARY BATH	2' - 6"	6' - 9"	WD	WD	Е									
	D10	PRIMARY BATH W.C.	2' - 3"	7' - 0"	WD	WD	Е									
	D11	PRIMARY BATH SHOWER	2' - 3"	8' - 10"	GL	GL	G									

## DOOR ELEVATION TYPES


NOTE: COORDINATE W/ ARCHITECT & FIELD VERIFY DOOR HEAD ALIGNMENTS OF DOORS, MULLIONS & WINDOWS


REV 1: D01 IS REMOVED FROM SCOPE OF WORK.

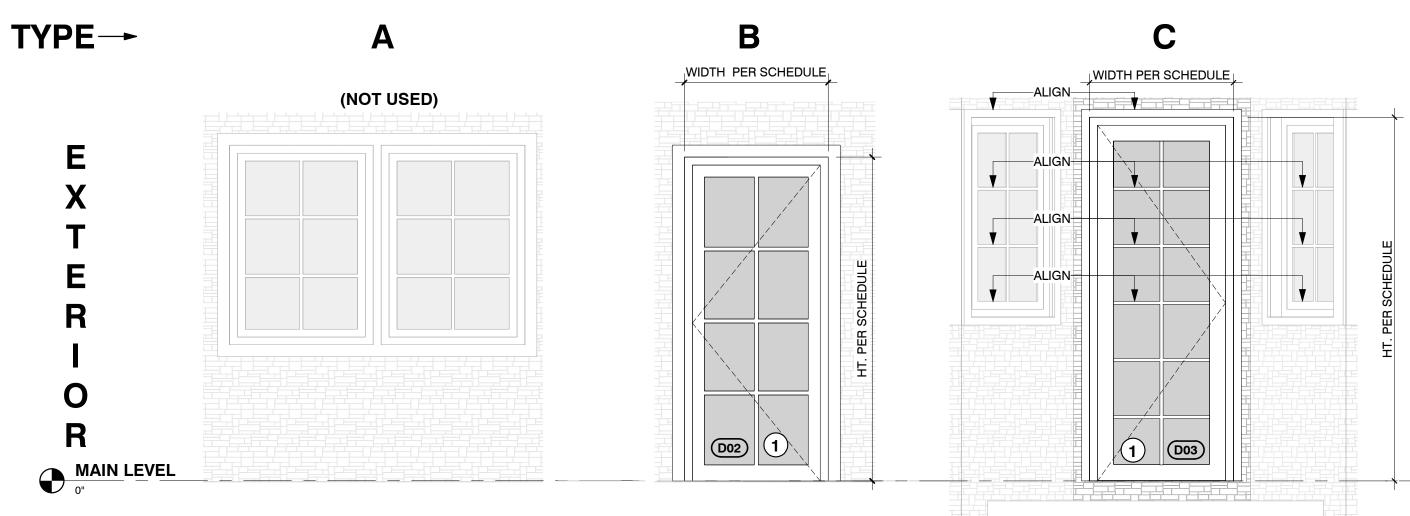

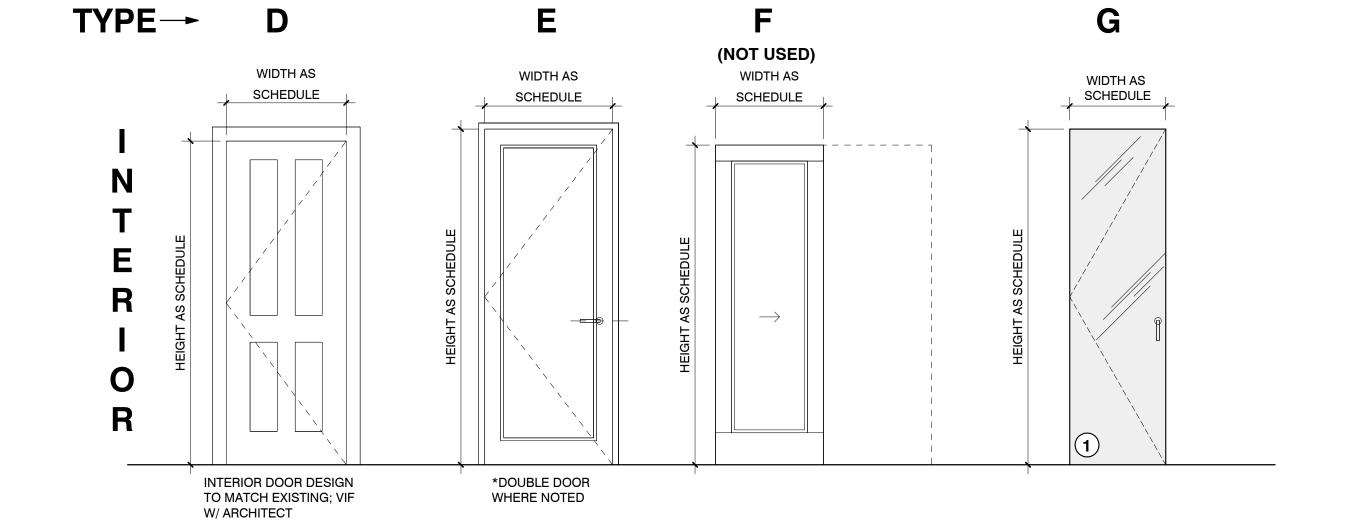

# **WINDOW ELEVATIONS**

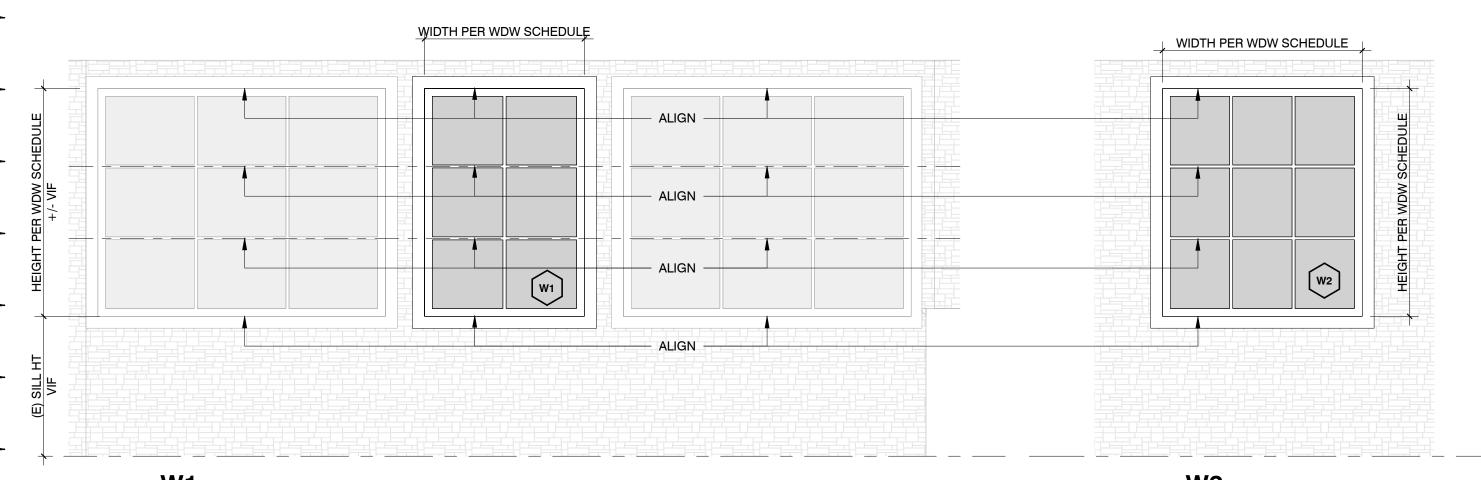

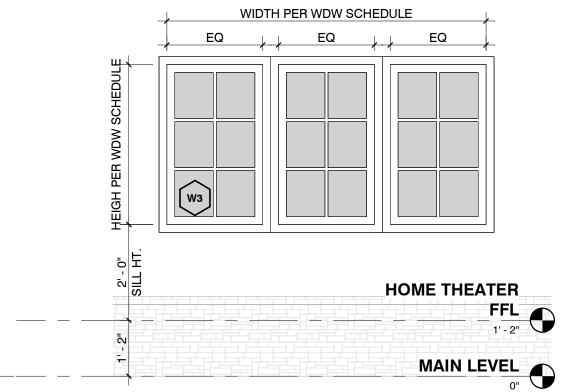

					VVI	na	ow Schedule		
	Wii	ndow S	ize		rial		Manufacturer		
Number	Width	Height	Sill Height	Hardware	Frame Mate	Screen	Brand	Model	Numbered Notes/ Remarks
14/4	01 411	41 011	<u> </u>		· ·	l NI-	MADVIN DOODO AND WINDOWO		ENIOLI / COL OR TO MATCH EVICTING
	• .								FINISH / COLOR TO MATCH EXISTING
								<b>!</b>	FINISH / COLOR TO MATCH EXISTING FINISH / COLOR TO MATCH EXISTING
	<b>Quny</b> W1 W2	Number Width	M1 3'-4" 4'-9" W2 4'-9" Height	M1 3'-4" 4'-9" W2 4'-5" Fig. 19 19 19 19 19 19 19 19 19 19 19 19 19	Number  Width  Height  Hardware	Number  Width  Hardware  Height  Hardware  Frame Materi	Number  Number  Width  Hardware  Frame Materia  Screen	Number Number Screen Hardware Water No Marvin Doors and windows	Mn         Mn         Model           W1         3'-4"         4'-9"         No         Marvin Doors and windows           W2         4'-2"         4'-9"         No         Marvin Doors and windows

## **SAFETY GLAZING NOTES:**

Provide required safety glazing [Hurricane rated] conforming to the human impact loads per CRC Sections R308.3 & R308.4 and listed below.

a) Fixed and operable panels of swinging, sliding and bi-fold door

- assemblies. b) Glazing in an individual fixed or operable panel adjacent to a door where the nearest vertical edge is within a 24-inch arc of the door in a closed position and whose bottom edge is less than 60 inches above the floor or walking surface.
- c) Glazing in an individual fixed or operable panel that meets all of the following conditions:
- 1. Exposed area of an individual pane greater than 9 square feet.
- 2. Bottom edge less than 18 inches above the floor. 3. Top edge greater than 36 inches above the floor.

inches above the plane of the adjacent walking surface.

4. One or more walking surfaces within 36 inches horizontally of the glazing. d) Glazing in enclosures or walls facing hot tubs, whirlpools, saunas, steam rooms, bathtubs and showers where the bottom edge of the glazing is less than 60 inches measured vertically above any standing or walking surface. e) Glazing adjacent to stairways, landings and ramps within 36 inches

horizontally of a walking surface when the surface of the glazing is less than 60

#### **DOOR - WINDOW SCHEDULE GENERAL NOTES**

SEE SPECS FOR GLASS INFO

- SEE ELEVATIONS FOR LOCATION AND OPERATION OF WINDOWS
- ALL DIMENSIONS ARE CLEAR OPENING SIZE AND NOMINAL, FINAL SIZE IS TO BE CONFIRMED IN THE SHOP DRAWING
- CONTRACTOR WILL COORDINATE TO ENSURE SWING AND SLIDING DOOR HEAD ALIGNMENT
- FOR WINDOW FINISH SEE FINISH SCHEDULE
- ALL GLASS WITHIN 18" OF FLOOR OR WALKING SURFACE TO BE TEMPERED
- CONTRACTOR TO VERIFY ALL WINDOW DIMENSIONS, FINAL DIMENSION MAY BE DEPENDENT
- ON FIELD CONDITIONS
- POCKET DOOR HARDWARE TO BE VERIFIED FOR POCKET SIZE PROVIDE SHOP DRAWINGS FOR ARCHITECTS REVIEW AND COMMENT PRIOR TO STARTING
- **FABRICATION OF WINDOWS** CONTRACTOR. WINDOW & DOOR MANUFACTURER SHALL SUBMIT BID THAT INCLUDES ALL
- REQUIRED ITEMS AND ACCESSORIES INCLUDING BUT NOT LIMITED TO: STRUCTURAL SUPPORT SYSTEMS, BREAK METAL SHAPES, METAL TUBING, SCREENS, GLASS ASSEMBLIES. G10 **DESIGN BASIS FOR EXTERIOR DOORS AND WINDOWS**:
  - THERMALLY BROKEN ALUMINUM MARVIN WINDOWS AND DOORS FINISH TO MATCH EXISTING DOORS AND WINDOWS

## SPECIAL CONDITIONS

**NUMBER NOTES** 

1. TEMPERED GLASS

2. PROVIDE SCREENS

12-7A-2. [§R337.8.2.1]

**HIGH FIRE HAZARD NOTE:** 

EXTERIOR WINDOWS AND EXTERIOR GLAZED DOORS SHALL BE MULTIPLAN

GLAZING WITH A MINIMUM OF ONE TEMPERED PANE, GLASS BLOCK UNITS,

HAVE A FIRE RESISTANCE RATING OF 20 MINUTES WHEN TESTED IN

ACCORDANCE WITH NFPA 257, OR MEET THE REQUIREMENTS OF SFM

ALL NEW OR REPLACED WINDOWS SHALL BE CONSISTENT IN STYLE AND MATERIAL WITH EXISTING WINDOWS TO MAINTAIN UNIFORMITY THROUGHOUT THE RESIDENCE.

SEE DOOR SCHEDULE THIS SHEET.

# **DISCLAIMER**

DOOR/WINDOW OPENING SIZES INDICATED REPRESENTS ARCHITECTS DESIGN INTENT ONLY & DOES NOT REPRESENT ACTUAL MANUFACTURED DOOR/WINDOW NET FRAME SIZES. THIS SCHEDULE DOES NOT CONSTITUTE AS AN ORDER LIST AND DOES NOT AUTHORIZE ANY EXPLICIT APPROVAL OF FABRICATION DIMENSIONS FOR PRODUCTION. IT SHALL BE THE FINAL RESPONSIBILITY OF THE GENERAL CONTRACTOR/MFR TO VERIFY ALL QUANTITIES/NET DIMENSIONS/SPECIFICATIONS PRIOR TO COMMENCEMENT OF ORDER/PRODUCTION. SINCE ROUGH OPENINGS MIGHT NOT BE IN PLACE AND FIELD VERIFICATION OF DIMENSIONS MIGHT NOT BE POSSIBLE IF BEING PRE-ORDERED, IT SHALL BE THE RESPONSIBILITY OF GC TO COMPLY WITH WORK PER THE REQUIRED ACCURACY / TOLERANCE LEVELS.

STUDIO P.O. Box 27

REV. DESCRIPTION DATE RFI#1 04/25/23 REV#4 WINDOW 02/12/24

**ARCHITECTURAL** 

**DOOR SCHEDULES AND** 

Scale: As indicated Drawn By:

**TYPES** 

02/08/2023