ABBREVIATIONS HEADER ALTERNATE HANGER APPROXIMATE HORIZ HORIZONTAL ARCHITECT INTERIOR JOIST BUILDING MAXIMUM M. B. MACHINE BOLT BOTTOM MALLEABLE IRON WASHER BETWEEN MINIMUM CLEAR NOT IN CONTRACT COLUMN NOT TO SCALE CONCRETE CONCRETE BLOCK CONC. BLK. ON CENTER CONNECTION OVER HANG/OVER HEAD CONSTRUCTION PLATE CONTINUOUS PANEL INDEX CENTER P. T. D. F. PRESSURE TREATED D.F. COUNTERSINK PLYMD. PLYMOOD DOUBLE REINFORCING DOUGLAS FIR REQUIRED REQ'D. DIAMETER REDWOOD RDMD. DRAWING SOLID BLOCKING S. B. EXISTING S. O. G. SLAB ON GRADE EDGE NAILING SCHED SCHEDULE SHTG. SHEATHING EXPANSION SIMILAR EXTERIOR SPECIFICATIONS SPECS. FINISH FLOOR SQUARE FINISH GRADE STANDARD FIELD NAILING SYMMETRICAL FOUNDATION T. & G. TONGUE & GROOVE FLOOR T. N. TOE NAIL FACE OF CONCRETE T. O. C. TOP OF CONCRETE FACE OF MASONRY T. O. W. TOP OF WALL FACE OF STUD TUBE STEEL FOOTING TYPICAL UNLESS OTHERWISE NOTED GAUGE U. O. N. GALVANIZED VERTICAL GALVANIZED IRON GLU-LAM. GLUE LAMINATED MITHOUT GYPSUM BOARD M. M. M. MELDED WIRE MESH OWNERSHIP NOTES

- OWNERSHIP AND USE OF THESE DRAWINGS AND SPECIFICATIONS
- TITLE AND ALL "COPYRIGHT" PRIVILEGES TO THESE DRAWINGS AND SPECIFICATIONS IS CLAIMED BY HOLDREN LIETZKE ARCHITECTURE HEREINAFTER REFERRED TO AS "DESIGNERS" WITHOUT PREJUDICE. VISUAL CONTACT MITH THESE SUBJECT DRAWINGS AND SPECIFICATIONS SHALL CONSTITUTE PRIMA FACIA EVIDENCE OF THE ACCEPTANCE OF THESE OWNERSHIP RIGHTS AND THE FOLLOWING RELATED RESTRICTIONS.
- THE USE OF THESE DRAWINGS AND SPECIFICATIONS SHALL BE SOLELY RESTRICTED TO THE ORIGINAL SITE FOR WHICH THEY WERE PREPARED AND THE DESIGNERS HEREBY STATE THAT THEY ARE NOT INTENDED FOR NOR SUITABLY ENGINEERED FOR ANY OTHER SITE. REPRODUCTION OF THESE DOCUMENTS IF THEREFORE EXPRESSLY LIMITED TO THIS INTENDED USE.
- THE DESIGNERS DISCLAIM ALL RESPONSIBILITY IF THESE DRAWINGS AND SPECIFICATIONS ARE USED, IN WHOLE OR IN PART, WITHOUT PRIOR WRITTEN PERMISSION, WHETHER OR NOT MODIFIED BY OTHERS FOR ANOTHER SITE
- IN THE EVENT OF UNAUTHORIZED USE BY ANY THIRD PARTY OF THESE DRAWINGS AND SPECIFICATIONS, THE CLIENT FOR WHICH THIS WORK WAS ORIGINALLY PREPARED HEREBY AGREES TO HOLD HARMLESS, INDEMNIFY AND DEFEND THE DESIGNERS FROM ANY CLAIMS ARISING FROM SUCH UNAUTHORIZED USE.

PLUMBING & ELECTRICAL NOTES

FOR ALL NEW PLUMBING AND ELECTRICAL ITEMS:

- SEE ELECTRICAL AND PLUMBING NOTES FOR FLOW RATE AND FLUSH CAPACITY REQUIREMENTS OF PLUMBING FIXTURES.
- $\label{top:local_panel} \mbox{HOMERUN ALL NEW CIRCUITS TO ELECTRICAL PANEL}.$ ALL KITCHEN AND BATHROOM ELECTRICAL OUTLETS SHALL HAVE GFCI PROTRECTION
- ALL BEDROOM ELECTRICAL OUTLETS SHALL HAVE AFCI PROTRECTION
- ALL ELECTRICAL ITEMS SHOWN ARE NEW UNLESS OTHERWISE NOTED. PROVIDE TWO SMALL-APPLIANCE BRANCH CIRCUITS FOR THE KITCHEN LIMITED TO SUPPLYING WALL AND
- PROVIDE SEPARATE BRANCH CIRCUITS AT EACH BEDROOM WITH THE REQUIRED ARC-FAULT CIRCUIT
- PROVIDE HARDWIRED SMOKE DETECTORS WITH BATTERY BACKUP IN EACH BEDROOM, HALLWAY & WHERE
- SMOKE DETECTORS SHALL BE INTER-CONNECTED TO SOUND AN ALARM AUDIBLE IN ALL BEDROOMS. USE WATER RESISTANT GYPSUM WALL BOARD BEHIND NEW TILE, SHOWER AND SINKS.
- INCANDESCENT LIGHTING FIXTURES RECESSED INTO INSULATED CEILINGS SHALL BE I.C. RATED BY UL OR OTHER APPROVED AGENCY.
- UNDERGROUND ALL PLUMBING AND POWER LINES TO THE (N) RESIDENCE. ANY EXTERIOR LIGHTING SHALL BE BURIED IN CONDUIT AND INSTALLED PER CURRENT ELECTRICAL CODE REQUIREMENTS.

GENERAL NOTES

- CONTRACTOR LICENSE: THE CONTRACTOR(S) PERFORMING THE WORK DESCRIBED BY THESE PLANS AND SPECIFICATIONS SHALL BE PROPERLY AND CURRENTLY LICENSED DURING THE EXECUTION OF THE PROJECT AND SHALL NOT PERFORM WORK OUTSIDE THE LEGAL SCOPE OF ANY LICENSE. SCOPE: THE CONTRACTOR SHALL PROVIDE AND PAY FOR ALL LABOR, MATERIALS, TOOLS, EQUIPMENT AND
- NECESSARY FOR THE PROPER EXECUTION AND TIMELY COMPLETION OF THE WORK. QUALITY CONTROL: IT IS THE EXPRESS INTENTION OF THESE PLANS AND SPECIFICATIONS TO REQUIRE REASONABLE CARE AND COMPETENCE IN THE EXECUTION OF THE CONSTRUCTION PROCESS AND PRODUCT. IF. IN THE OPINION OF THE CONTRACTOR, ANY PORTION OF THE DOCUMENTATION HEREIN IS INCONSISTEN

MACHINERY, TRANSPORTATION, WATER, HEAT, ELECTRICAL, TELEPHONE, AND ANY OTHER RELATED ITEMS

- MITH THIS, THE DESIGNERS SHALL BE NOTIFIED PRIOR TO EXECUTING THE WORK AND ALLOWED REVISION TIME MARRANTY: THE CONTRACTOR WARRANTS TO THE OWNER THAT ALL MATERIALS AND EQUIPMENT FURNISHED
- UNDER THIS CONTRACT WILL BE NEW UNLESS OTHERWISE SPECIFIED, AND THAT ALL WORK WILL BE OF GOOD QUALITY, FREE FROM FAULTS AND DEFECTS, AND IN CONFORMANCE WITH THE CONTRACT DRAWINGS AND
- PERMITS: UNLESS OTHERWISE INSTRUCTED, THE OWNER SHALL PAY ALL PERMIT FEES INCLUDING UTILITIES. THE CONTRACTOR SHALL SECURE THE BUILDING PERMIT AND ANY OTHER PERMITS PRIOR TO STARTING THE WORK AND COMPLY WITH ALL INSPECTION REQUIREMENTS THROUGH FINAL SIGN-OFF. LEGAL/NOTICES/CODE COMPLIANCE: THE CONTRACTOR SHALL GIVE ALL NOTICES AND COMPLY WITH ALL LAMS, ORDINANCES, BUILDING CODES, RULES, REGULATIONS AND OTHER LAWFUL ORDERS OF ANY PUBLIC AUTHORITY BEARING ON THE PERFORMANCE OF THE WORK. THE CONTRACTOR SHALL PROMPTLY NOTIFY

THE DESIGNERS IN WRITING IF THE DRAWINGS AND/OR SPECIFICATIONS ARE AT VARIANCE WITH ANY SUCH

- REQUIREMENTS. (2007 C.B.C.) RESPONSIBILITY: THE CONTRACTOR SHALL BE SOLELY RESPONSIBLE FOR ALL CONSTRUCTION MEANS, METHODS, TECHNIQUES, SEQUENCES AND PROCEDURES SELECTED TO EXECUTE THE WORK. THE CONTRACTOR SHALL COORDINATE ALL PORTIONS OF WORK WITHIN THE SCOPE OF THE CONTRACT.
- SAFETY: THE CONTRACTOR SHALL BE RESPONSIBLE FOR INITIATING, MAINTAINING AND PROPERLY SUPERVISING ADEQUATE INDUSTRY STANDARD SAFETY PRECAUTIONS AND PROGRAMS IN CONNECTION WITH THIS MORK AND SHALL ADHERE TO ALL FEDERAL, LOCAL, STATE & O.S.H.A. SAFETY REGULATIONS.
- INSURANCE: LIABILITY INSURANCE SHALL BE MAINTAINED BY THE CONTRACTOR TO PROTECT AGAINST ALL CLAIMS UNDER WORKMAN'S COMPENSATION ACTS, DAMAGES DUE TO BODILY INJURY INCLUDING DEATH, AND FOR ANY PROPERTY DAMAGES ARISING OUT OF OR RESULTING FROM THE CONTRACTOR'S OPERATIONS UNDER THE CONTRACT. THIS INSURANCE SHALL BE FOR LIABILITY LIMITS SATISFACTORY TO THE OWNER. THE OMNER HAS THE RIGHT TO REQUIRED CONTRACTUAL LIABILITY INSURANCE APPLICABLE TO THE CONTRACTOR'S OBLIGATIONS. CERTIFICATES OF SUCH INSURANCE SHALL BE FILED WITH THE OWNER PRIOR TO THE COMMENCEMENT OF WORK.
- INDEMNIFICATION: THE CONTRACTOR WHO AGREES TO PERFORM THIS WORK ALSO AGREES TO INDEMNIFY AND HOLD HARMLESS THE OWNER AND THE DESIGNERS FROM AND AGAINST ALL CONSEQUENTIAL CLAIMS / DAMAGES / LOSSES AND EXPENSES, INCLUDING ATTORNEY'S FEES AND LITIGATION COSTS, ARISING OUT OF OR RESULTING FROM THE PERFORMANCE OF THE WORK.
- CLEANING UP: THE CONTRACTOR SHALL KEEP THE PREMISES AND SITE FREE FROM ACCUMULATION OF WASTE MATERIALS DURING CONSTRUCTION BY PERIODIC CLEAN UP AND OFF-SITE DEBRIS REMOVAL. FINAL CLEANUP AND DEBRIS DISPOSITION SHALL BE TO THE SATISFACTION OF THE OWNER.
- CONTRACTOR SHALL VISIT THE SITE AND VERIFY ALL EXISTING CONDITIONS PRIOR TO ANY WORK AND NOTIFY THE DESIGNERS OF ANY DISCREPANCIES BETWEEN THESE DRAWINGS AND EXISTING CONDITIONS AFFECTING THE WORK OR NATURE OF SPECIFIED MATERIALS AND/OR SCOPE OF DESIGN.
- ALL NOTES, DIMENSIONS, ETC. INDICATE NEW MATERIALS OR CONSTRUCTION UNLESS OTHERWISE NOTED.
- NO LAND CLEARING OR GRADING SHALL OCCUR ON THE PROPERTY BETWEEN OCTOBER 15 AND APRIL 15 UNLESS AUTHORIZED BY THE DIRECTOR OF PLANNING AND BUILDING INSPECTION.
- SHOP DRAWINGS: PRIOR TO FABRICATION, THE CONTRACTOR SHALL SUBMIT TO THE DESIGNER FOR APPROVAL SHOP DRAWINGS FOR ALL STRUCTURAL STEEL, REINFORCING STEEL, GLUE LAMINATED BEAMS AND PREFABRICATED TRUSSES, WINDOW & DOORS, FINISH CARPENTRY. SHOP DRAWINGS ARE NOT CHANGE ORDERS, BUT RATHER SERVE TO DEMONSTRATE TO THE ENGINEER AND/OR DESIGNER THAT THE CONTRACTOR UNDERSTANDS THE REQUIREMENTS & DESIGN CONCEPTS OF THE PLAN, DETAILS &
- CHANGE ORDERS: NO VERBAL CHANGE ORDERS SHALL BECOME LEGAL AND BINDING. CONSTRUCTION, BRACING & SHORING: THE CONTRACTOR SHALL BE SOLELY RESPONSIBLE FOR ALL BRACING
- AND SHORING REQUIRED DURING CONSTRUCTION UNTIL ALL CONSTRUCTION IS COMPLETE. SIMILAR CONDITIONS: CONDITIONS NOT SPECIFICALLY DETAILED SHALL BE BUILT TO CONFORM WITH SIMILAR
- DISCREPANCIES: THE CONTRACTOR SHALL VERIFY ALL DIMENSIONS, ELEVATIONS, MATERIALS AND CONDITIONS PRIOR TO STARTING CONSTRUCTION. ANY DISCREPANCIES SHALL BE REPORTED TO THE ARCHITECT PRIOR TO ORDERING MATERIALS AND STARTING CONSTRUCTION.
- TECHNICAL SPECIFICATIONS: ALL TECHNICAL SPECIFICATIONS REFERRED TO IN THESE DRAWINGS ARE BY THIS

SPECIAL INSPECTIONS

SEE STRUCTURAL SHEETS FOR SPECIAL INSPECTIONS REQUIRED FOR THIS PROJECT. CONTRACTOR SHALL COORDINATE FORMS AND PROCEDURES WITH THE BUILDING DEPARTMENT

SPECIAL CONDITIONS

THE APPLICANT SHALL WORK WITH PLANNING STAFF AND THE CITY FORESTER ON EVALUATING OPTIONS FOR PLANTING ONE NEW UPPER-CANOPY TREE ON SITE. THE APPLICANT SHALL PLANT ONE UPPER-CANOPY TREE OF SUBSTANTIAL SIZE AND CALIBER IF DETERMINED APPROPRIATE FOR THE SITE BY THE CITY FORESTER. THE LOCATION, SIZE, AND SPECIES OF THIS TREE SHALL BE NOTED ON A REVISED LANDSCAPE PLAN, AND THIS PLAN SHALL BE SUBMITTED WITH THE BUILDING PERMIT APPLICATION PLAN SET. PRIOR TO ISSUANCE OF THE CERTIFICATE OF OCCUPANCY THE TREE SHALL BE PLANTED ON SITE LOCATED APPROX. 10 FT. FROM ANY BUILDING.



VICINITY MAP SCALE: N.T.S. TYPE OF CONSTRUCTION: V-B OCEAN LOCATION PROJECT CARMEL VALLEY RD.

BUILDING CODES: ALL CONSTRUCTION SHALL MEET THE REQUIREMENTS OF THE 2019 EDITION OF THE CALIFORNIA BUILDING, RESIDENTIAL, ELECTRICAL, MECHANICAL, PLUMBING, GREEN BUILDING STANDARDS, ENERGY, HISTORICAL, AND FIRE CODES, AND ALL LOCAL AMENDMENTS OF PRESIDING CITY OR COUNTY. 2. PROTECT ALL TREES DURING CONSTRUCTION PER THE TREE PROTECTION STANDARDS OF THE CITY OF CARMEL.

RIO RD.

- 3. MINIMUM CONCRETE COMPRESSIVE STRENGTH AT 28 DAYS SHALL BE 2,500 PSI.
- 4. ALL REINFORCING STEEL SHALL CONFORM TO THE A.S.T.M. A615 GRADE 60 UNLESS OTHERWISE NOTED ON PLANS.

WELDED WIRE FABRIC: WELDED WIRE FABRIC SHALL CONFORM TO A.S.T.M. A185-79.

- 5. LUMBER SPECIES AND GRADES SHALL CONFORM TO THE FOLLOWING U.O.N.: MAXIMUM MOISTURE CONTENT OF LUMBER SHALL BE 19%. ALL DOUGLAS FIR LUMBER WHICH IS EXPOSED TO WEATHER SHALL BE PRESSURE TREATED. ALL GRADING SHALL CONFORM TO THE RULES AND REGULATIONS OF THE M.M.P., R.A. & A.P.A. PLYWOOD SHALL BE D.F. CONFORMING TO U.S. PRODUCT STANDARDS PS 1-74 WITH EXTERIOR GLUE, GRADE STAMPED A.P.A. SEE FRAMING PLANS FOR ADDITIONAL REQUIREMENTS.
- 6. WALL CONSTRUCTION SHALL COMPLY WITH CBC SECTION R602 (FOR CONVENTIONAL CONSTRUCTION).
- 7. NAILING TO BE IN COMPLIANCE WITH CBC TABLE R602.3.1
- 8. ALL MANUFACTURER'S INSTALLATION GUIDES TO BE PROVIDED TO INSPECTOR AT TIME OF FIELD INSPECTION.
- 9. THE BUILDER/CONTRACTOR TO PROVIDE THE OWNER AND THE CITY OR CARMEL WITH A COPY OF THE CF-6R INSTALLATION CERTIFICATE AT THE TIME OF FINAL INSPECTION.

FIRE SAFETY REQUIREMENTS

- DEFENSIBLE SPACE REQUIREMENTS MANAGE COMBUSTIBLE VEGETATION WITHIN A MIN. OF 100 FEET OF STRUCTURES (OR THE PROPERTY LINE). LIMB TREES 6 FEET UP FROM GROUND. REMOVE LIMBS WITHIN 10 FEET OF CHIMNEYS.
- . FIRE PROTECTION EQUIPMENT & SYSTEMS FIRE APRINKLER SYSTEM THE BUILDINGS AND ATTACHED GARAGE SHALL BE FULLY PROTECTED WITH AUTOMATIC FIRE SPRINKLER SYSTEMS. INSTALLATION SHALL BE IN ACCORDANCE WITH THE APPLICABLE NFPA STANDARD.
- . SMOKE ALARMS (SINGLE FAMILY DWELLING) WHERE A HOUSEHOLD FIRE WARNING SYSTEM OR COMBINATION FIRE/BURGLAR ALARM SYSTEM IS INSTALLED IN LIEU OF SINGLE-STATION SMOKE ALARMS REQUIRED BY THE UBC THE ALARM PANEL SHALL BE REQUIRED TO BE PLACARDED AS PERMANENT BUILDING EQUIPMENT.
- 4. ROOF CONSTRUCTION ICBO CLASS 'A' ROOF ASSEMBLY CONSTRUCTION.

SURVEY AND GEOTECHNICAL NOTES

- 1. A LETTER FROM THE SURVEYOR THAT THE ROOF HEIGHT IS IN COMPLIANCE WITH THE APPROVED PLAN SHALL BE PROVIDED TO THE CITY OF CARMEL-BY-THE-SEA BUILDING SAFETY DIVISION PRIOR TO ROOF SHEATHING INSPECTION.
- 2. THE BOTTOM OF ALL EXCAVATIONS SHOULD BE OBSERVED BY A REPRESENTATIVE OF THE GEOTECHNICAL ENGINEERING FIRM PRIOR TO PROCESSING OR PLACING FILL. SEE GEOTECHNICAL REPORT F-100945, DATED FEBRUARY 21, 2014 FOR ADDITIONAL INFORMATION AND REQUIREMENTS.

PROJECT DATA

LOT 22 AND A PORTION OF LOT 20, BLOCK GG, CARMEL CITY, MONTEREY COUNTY, CALIFORNIA ZONING: R-1 LOT SIZE: 7,000 S.F. GRADE AT HIGHEST RIDGE: 112' TREE INFORMATION: NO EXISTING TREES TO BE REMOVED

OCCUPANCY GROUP: RESIDENCE: R-3 GARAGE: U

<u>SETBACKS</u> REQUIRED FRONT SETBACK = 15'-0" PROPOSED FRONT SETBACK = 20'-3" TO GARAGE, 31'-9" TO HOUSE REQUIRED SIDE SETBACKS = TOTAL OF 25% OF SITE WIDTH = 17'-6" PROPOSED SIDE SETBACKS TO FINISH = 8'-9" + 8'-9" = 17'-6"

REQUIRED REAR SETBACK = 5'-0" PROPOSED REAR SETBACK = 8'-0"

FLOOR AREA				
BUILDINGS				
MAIN FLOOR(S)	588 SQ. FT.	1,867 SQ. FT.		
	607 SQ. FT.			
LOWER FLOOR		563 SQ. FT.		
<u>GARAGE</u>		300 SQ. FT.		
TOTAL FLOOR AREA	1,195 SQ. FT.	2,730 SQ. FT.		
TOTAL ALLOWABLE FLOOR AREA = 2,730-50, ET.				
SITE COVERAGE	IMPERMIABLE:	MPERMIABLE:		
>				

EXISTING

SITE COVERAGE	IMPERMIABLE:	IMPERMIABLE:		
ENTRY PORCH & STEPS	109 SQ. FT.	128 SQ. FT.		
PATIOS	228 SQ. FT.	63 SQ. FT.		
FIREPIT/BB-Q PATIO		166 SQ. FT.		
STEPPING STONES		22 SQ. FT.		
(GENERATOR SLAB		17 SQ. FT.		
SITE STONE WALLS		93 SQ. FT.		
DRIVENAY	555 SQ. FT.			
MALKMAYS	297 SQ. FT.			
>	SEMI PERMIABLE:	SEMI PERMIABLE:		
DRIVEWAY		392 SQ. FT.		
SUBTOTALS SEMI PERMIABLE:		392 SQ. FT.		
IMPERMIABLE:	1,188 SQ. FT.	489 5Q. FT.		
TOTAL SITE COVERAGE	1,188 SQ. FT.	881 SQ. FT.		

TOTAL ALLOWABLE IMPERMIABLE SITE COVERAGE = 601 SQ. FT. + (4% FOR DRIVEWAY) 280 SQ. FT. = TOTAL ALLOWABLE SITE COVERAGE: 881 SQ. FT.

PROJECT TEAM

JEFF AND NOELLE NEWMAN 26022 ATHERTON DR CARMEL-BY-THE-SEA, CA 93923-8904 PH: 831-601-1522

SITE ADDRESS: CARMELO, 3 SE OF 4TH CARMEL-BY-THE-SEA, CA 93921

ARCHITECT: HOLDREN LIETZKE ARCHITECTURE 225 CANNERY ROW, SUITE A MONTEREY, CA 93940 PH: 831-649-6001

SURVEYOR: POLARIS CONSULTING P.O. BOX 1378 CARMEL VALLEY, CA 93924 PH: 831-659-9564

SOILS ENGINEER: BEACON GEOTECHICAL, INC. P.O. BOX 4814 PASO ROBLES, CA 93447 PH: 805-239-9457 SOILS REPORT F-100945, DATED FEB 21, 2014

PROPOSED

STRUCTURAL ENGINEER: UYEDA AND ASSOCIATES 2600 GARDEN ROAD, SUITE 305 MONTEREY, CA 93940 PH: 831-373-3181 CONTACT: YUTAKA UYEDA

MECHANICAL ENGINEER: MONTEREY ENERGY GROUP 26465 CARMEL RANCHO BLVD., SUITE 8 CARMEL, CA 93924 PH: 831-372-8328

SHEET INDEX

COVER SHEET, PROJECT DATA

SITE PLAN SURVEY 1 of 1

SITE / DRAINAGE PLAN WALL REMOVAL PLN., FLR. LEVEL MAP 71

EXISTING AND PROPOSED STREET ELEV. LOWER FLOOR PLAN

A2.2 MAIN FLOOR PLAN ROOF PLAN A3.0 EXISTING EXTERIOR ELEVATIONS)

EXTERIOR ELEVATIONS EXTERIOR ELEVATIONS A3.2

LANDSCAPE

HARDSCAPE/LIGHTING/IRRIGATION & DRAINAGE PLAN



Fax: 831.649.6003

www.hl-arc.com


DATE:	01.17.2024
SCALE:	
DRAWN:	LL
JOB NUMBER:	23.10
REVISION	
\wedge	PLANNING COMMEN


04/10/24





AN MM M Z 55

7

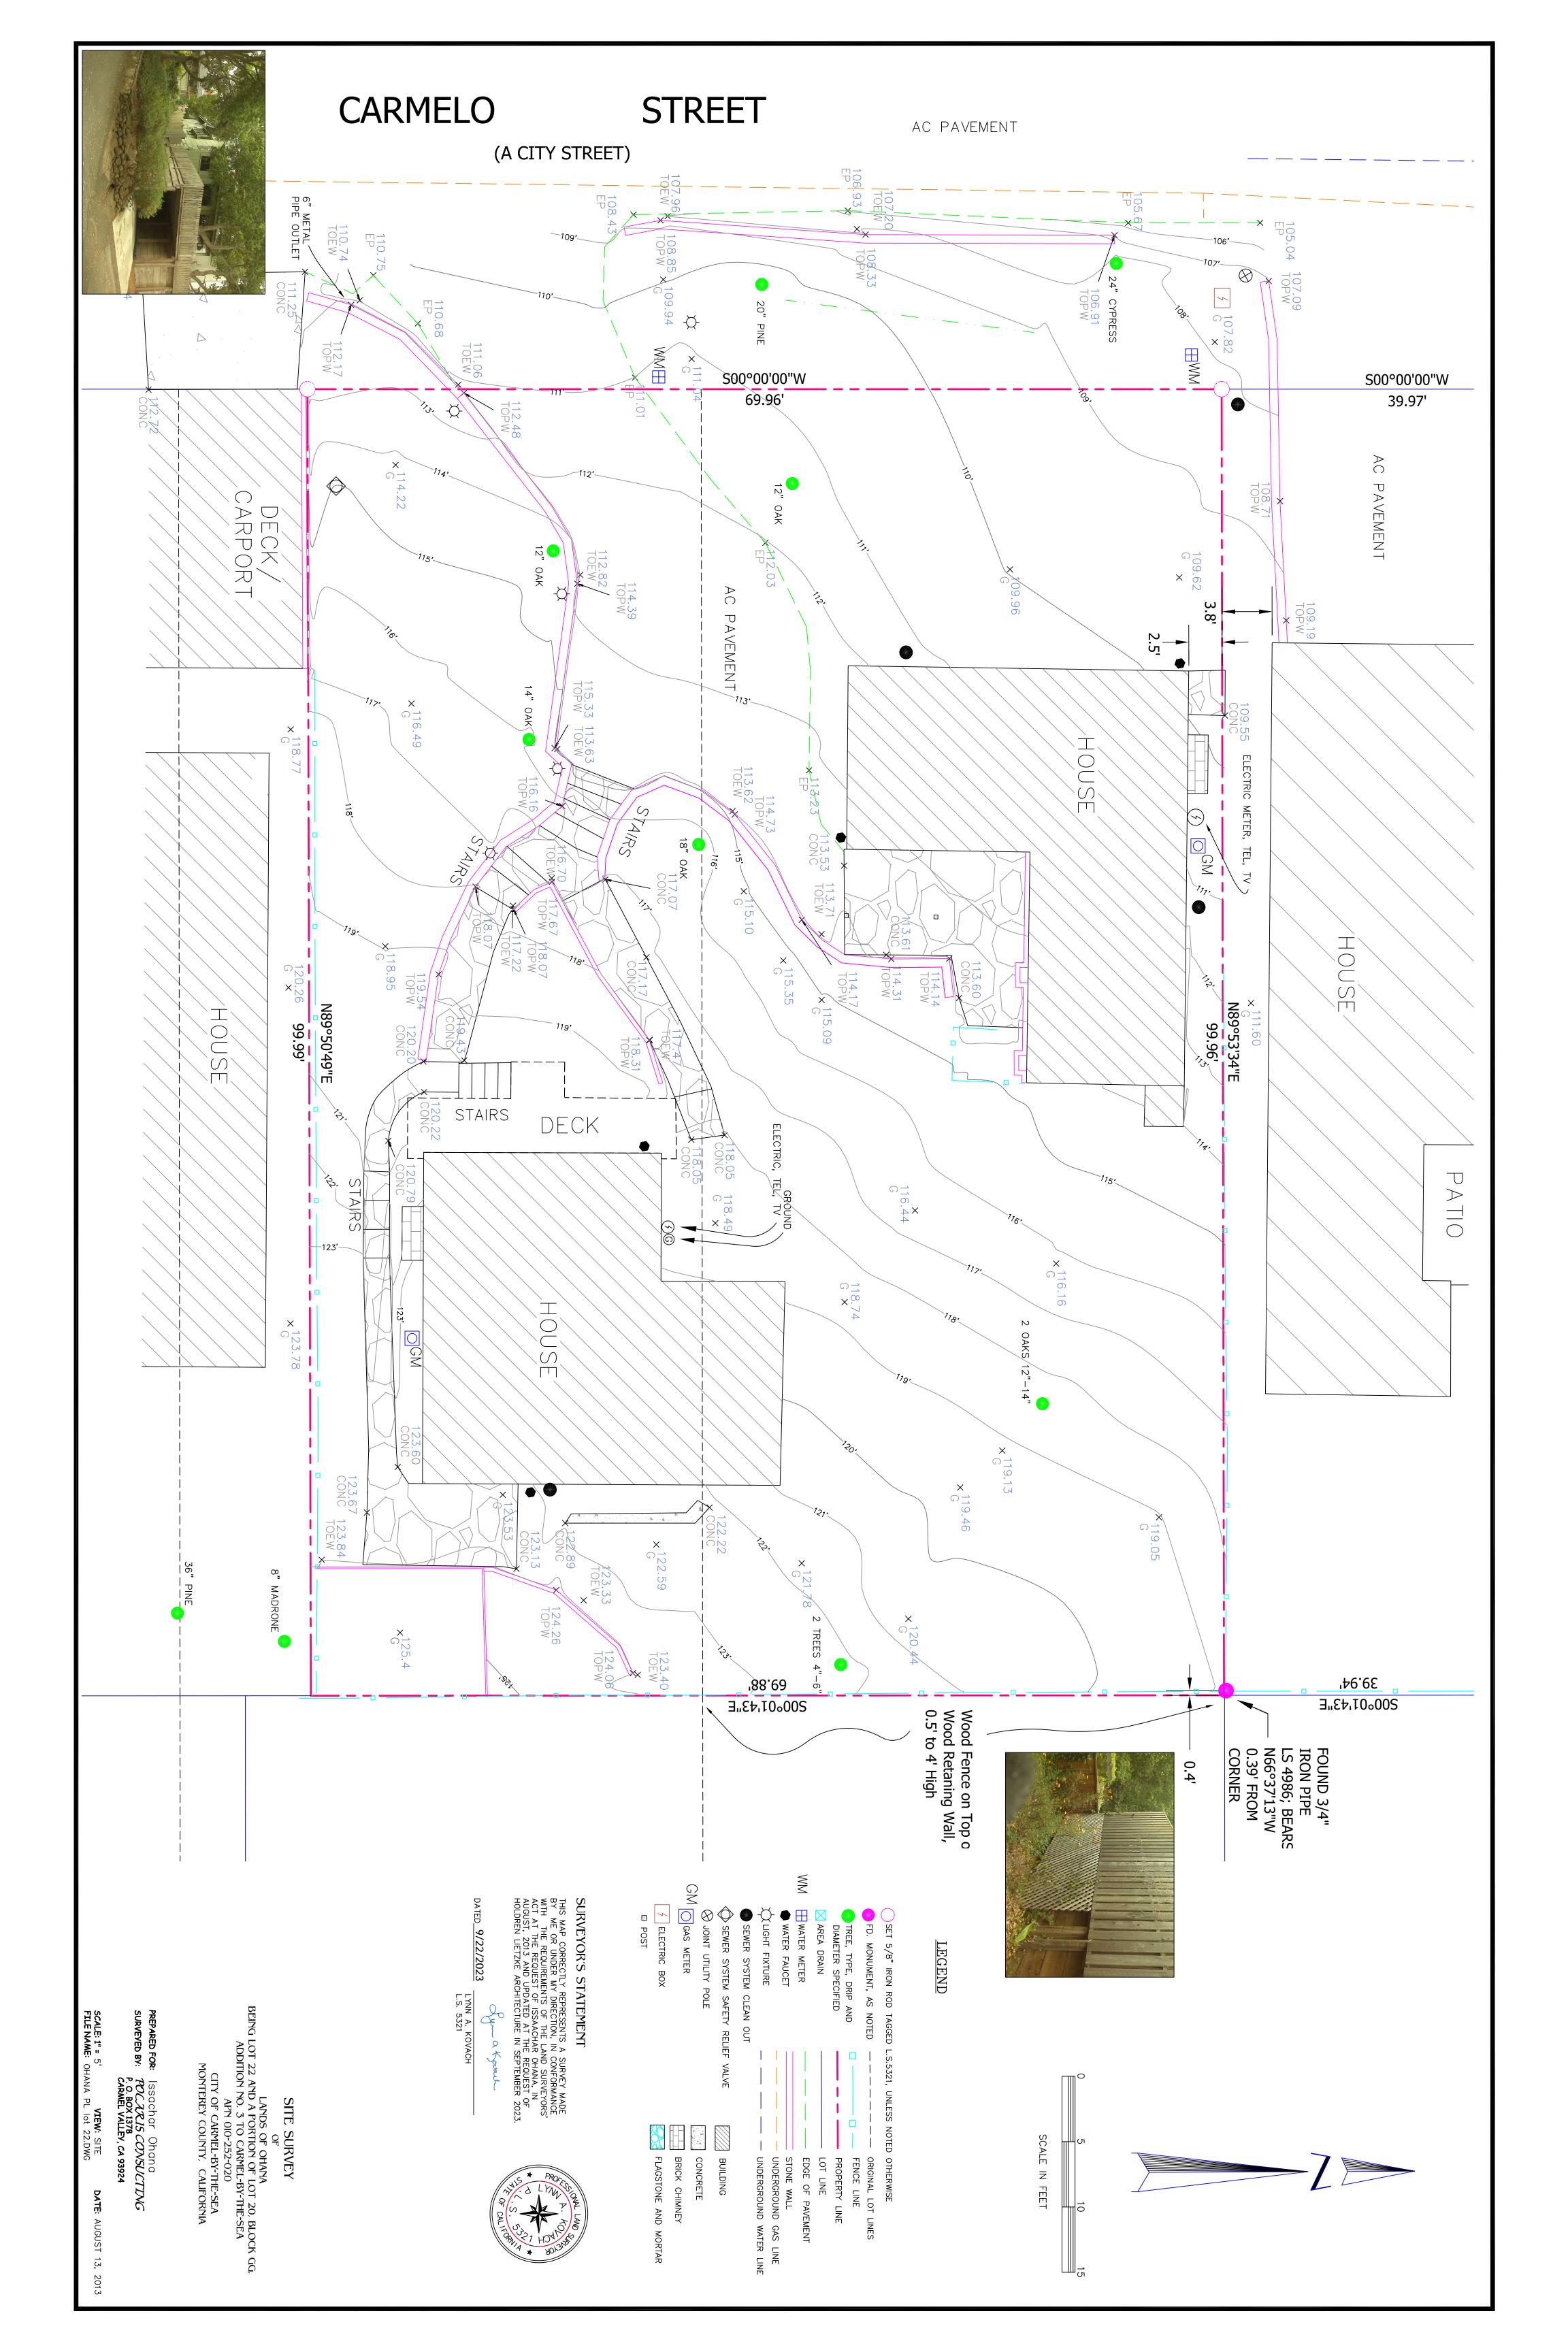


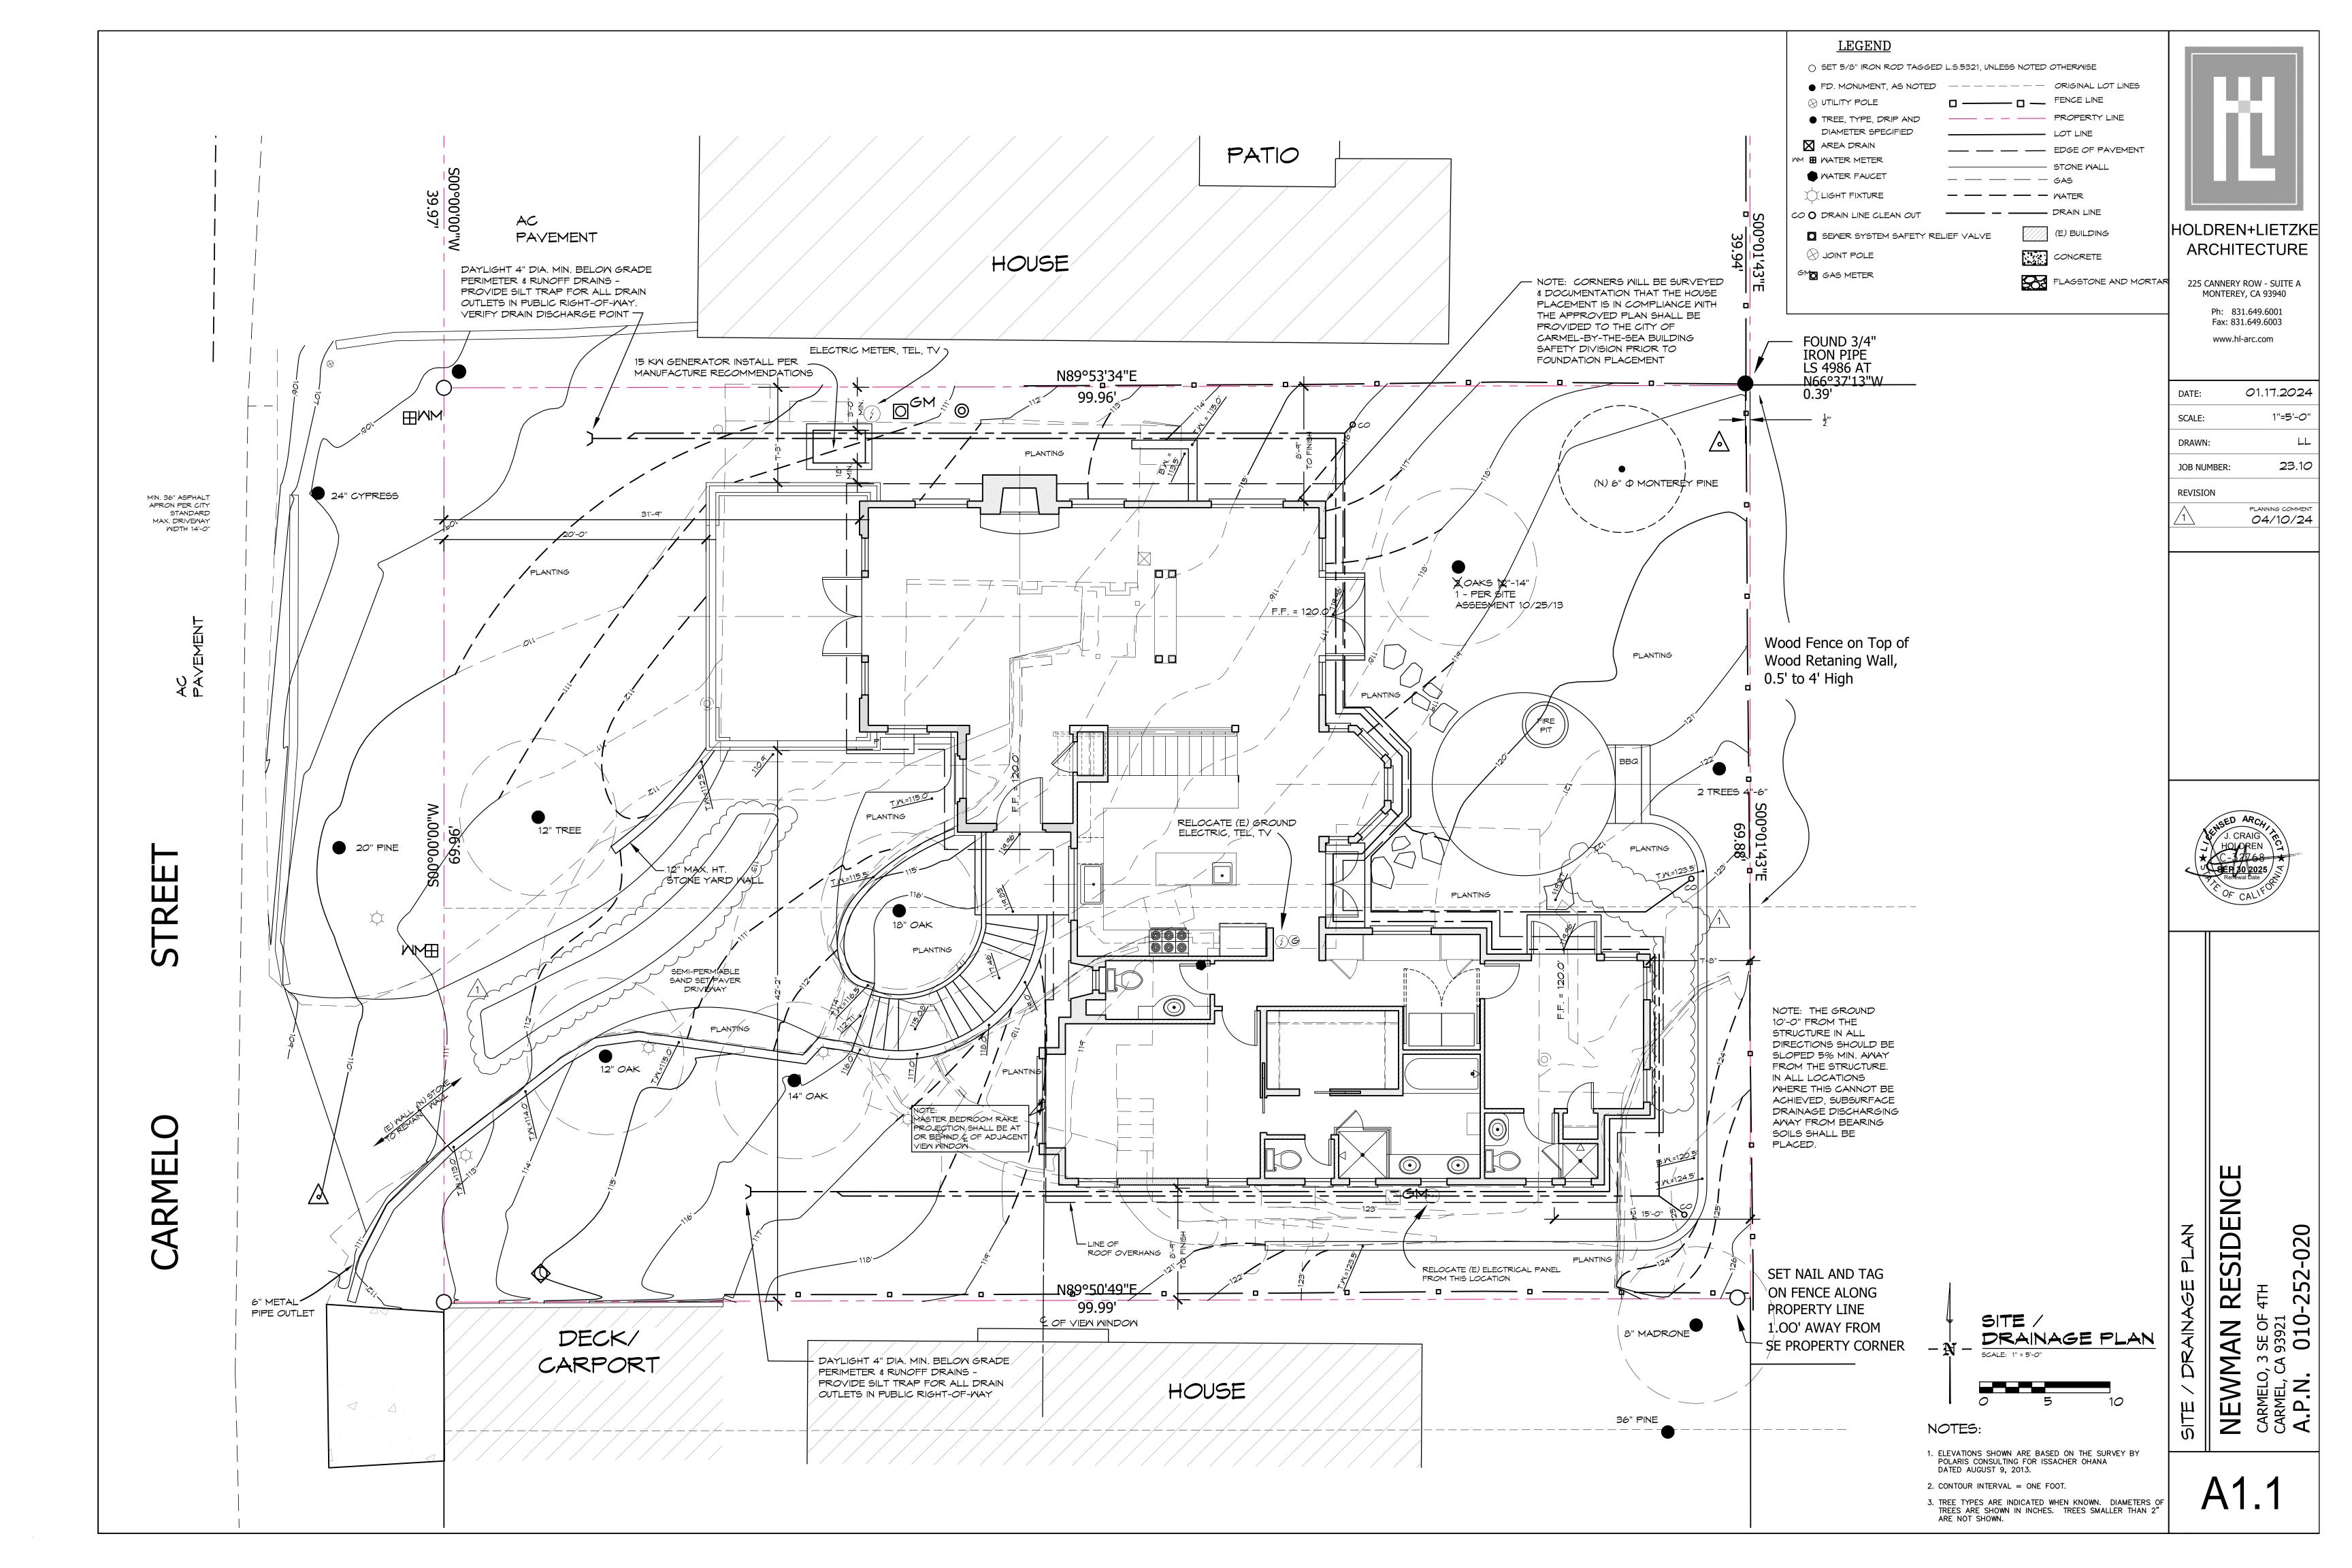

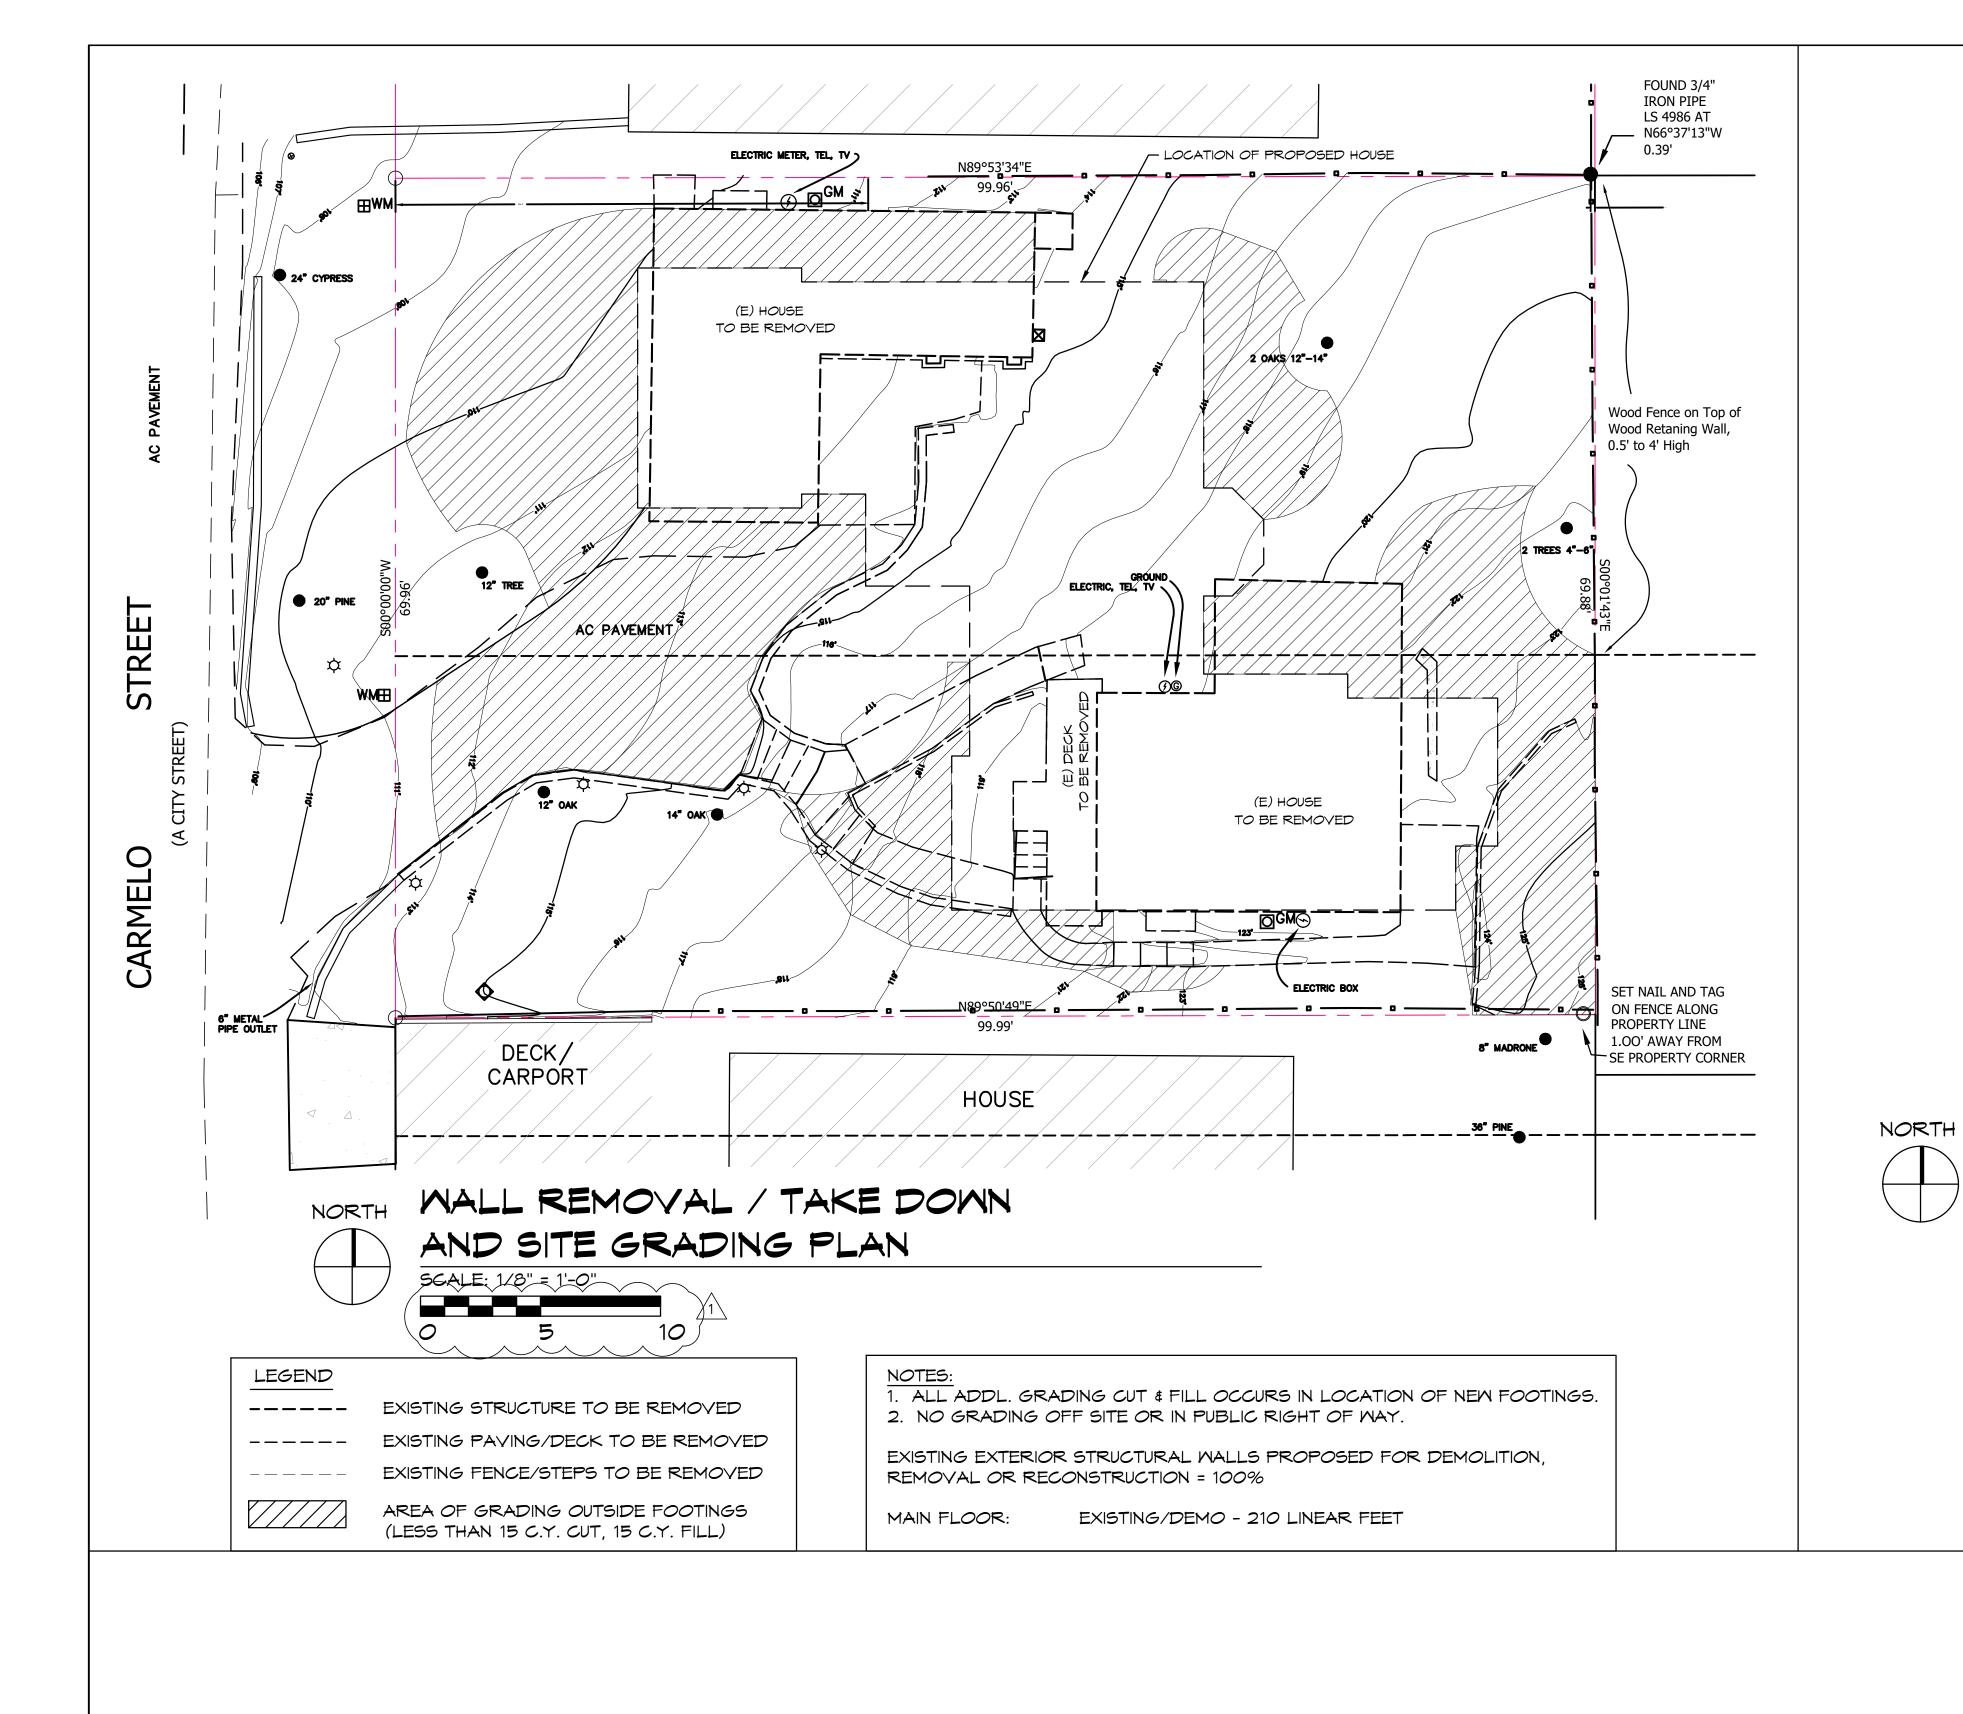

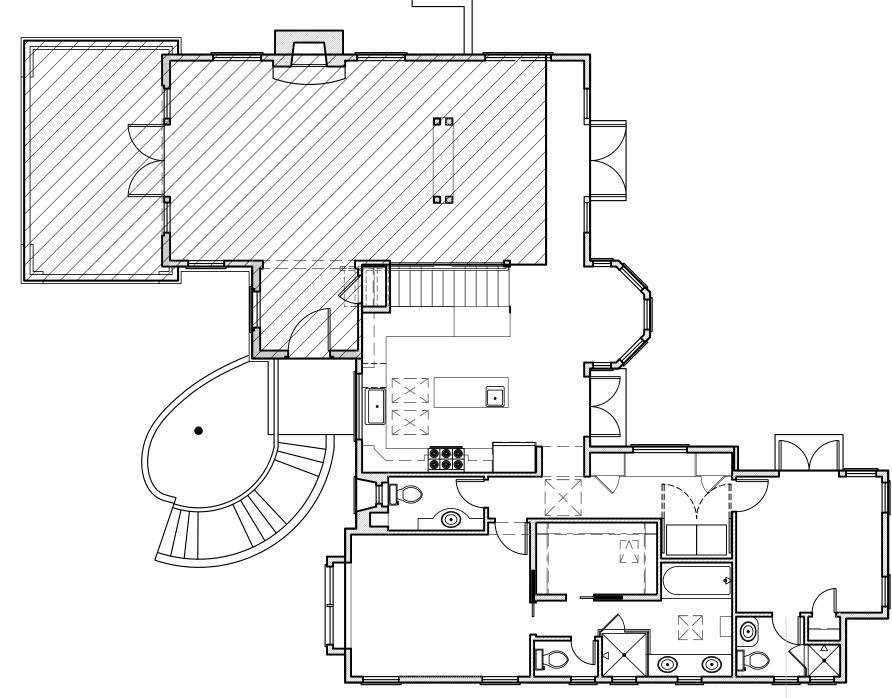

FLOOR LEVEL MAP

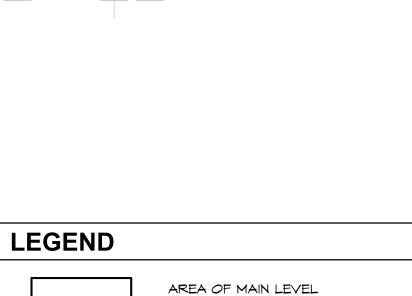



HOLDREN+LIETZKE

ARCHITECTURE

225 CANNERY ROW - SUITE A MONTEREY, CA 93940

Ph: 831.649.6001 Fax: 831.649.6003 www.hl-arc.com

DATE:

SCALE:

DRAWN:

JOB NUMBER:

REVISION

01.17.2024

AS_NOTED

PLANNING COMMEN 04/10/24

23.10


AREA OF LOWER LEVEL THAT IS COMPLETELY OVERLAPPED BY MAIN LEVEL (NOTE: 100% OF LOWER LEVEL IS OVERLAPPED BY FIRST LEVEL)

FLOOR AREA TABLE

MAIN FLOOR: 1,867 S.F. LOWER FLOOR (INCLUDING GARAGE): 864 S.F. AREA OF LOWER FLOOR THAT IS OVERLAPPED BY FIRST FLOOR: 864 S.F.

RESIDENCE NEWMAN F CARMELO, 3 SE OF 2 CARMEL, CA 93921 A.P.N. 010-

-252-020

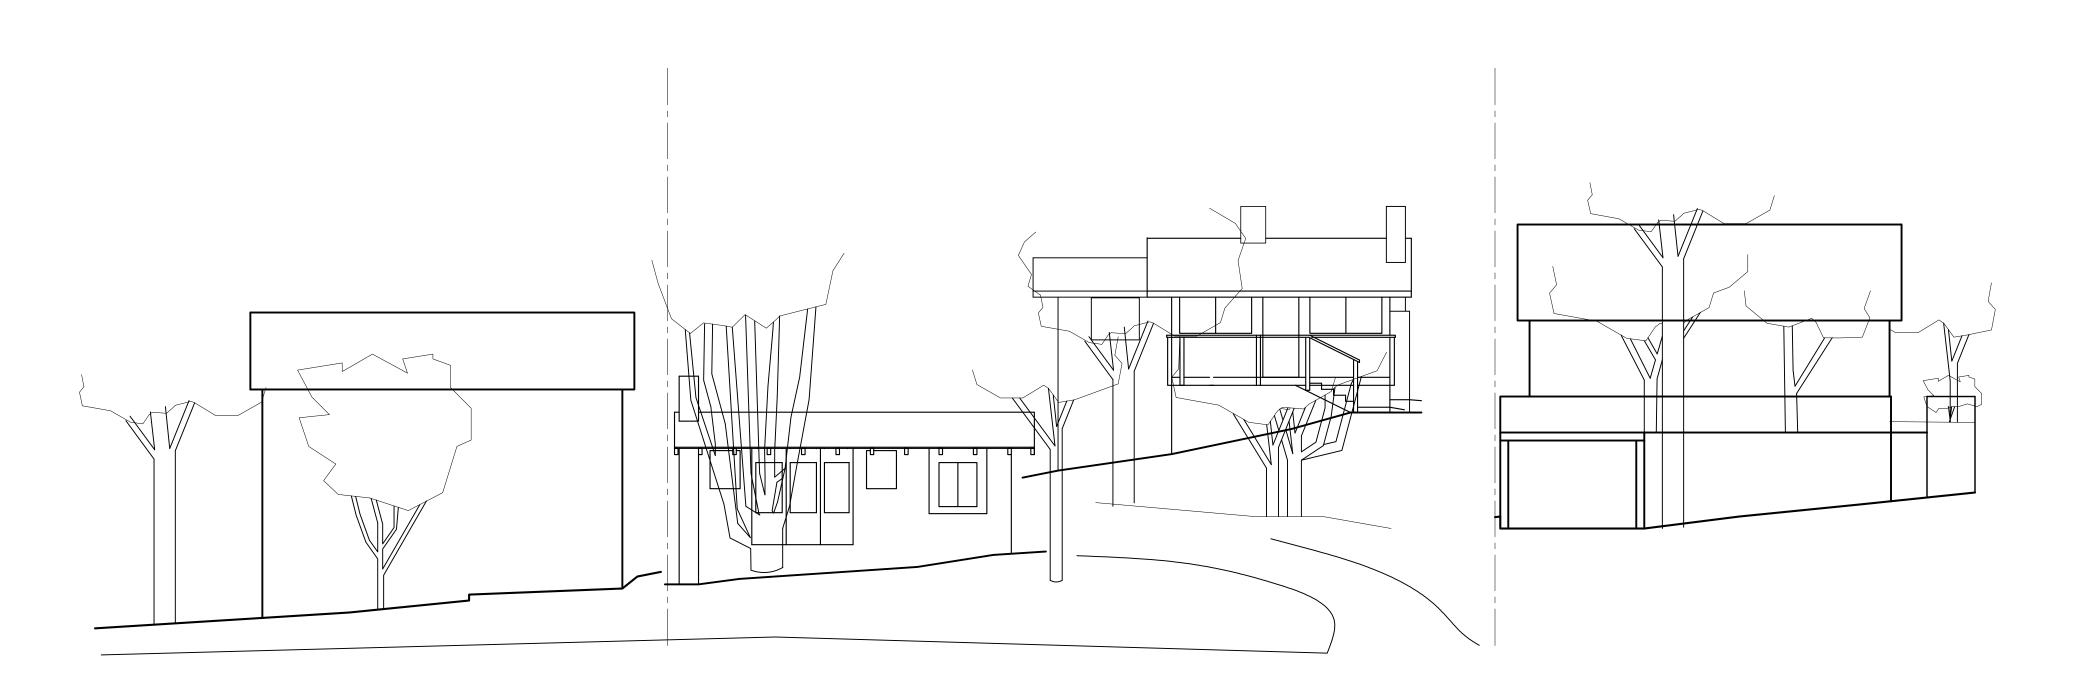



ARCHITECTURE

225 CANNERY ROW - SUITE A MONTEREY, CA 93940 Ph: 831.649.6001 Fax: 831.649.6003 www.hl-arc.com

01.17.2024 AS_NOTED SCALE: DRAWN: JOB NUMBER: REVISION

PLANNING COMMENT 04/10/24


EXISTING CARMELO STREET PROFILE - MEST ELEVATION

SCALE: 1/8"=1'-0"







PROPOSED CARMELO STREET PROFILE - WEST ELEVATION

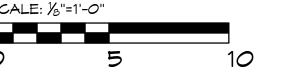

EXISTING AND PROPOSED STREET ELEY NEWMAN RESIDENCE
CARMELO, 3 SE OF 4TH
CARMEL, CA 93921
A.P.N. 010-252-020

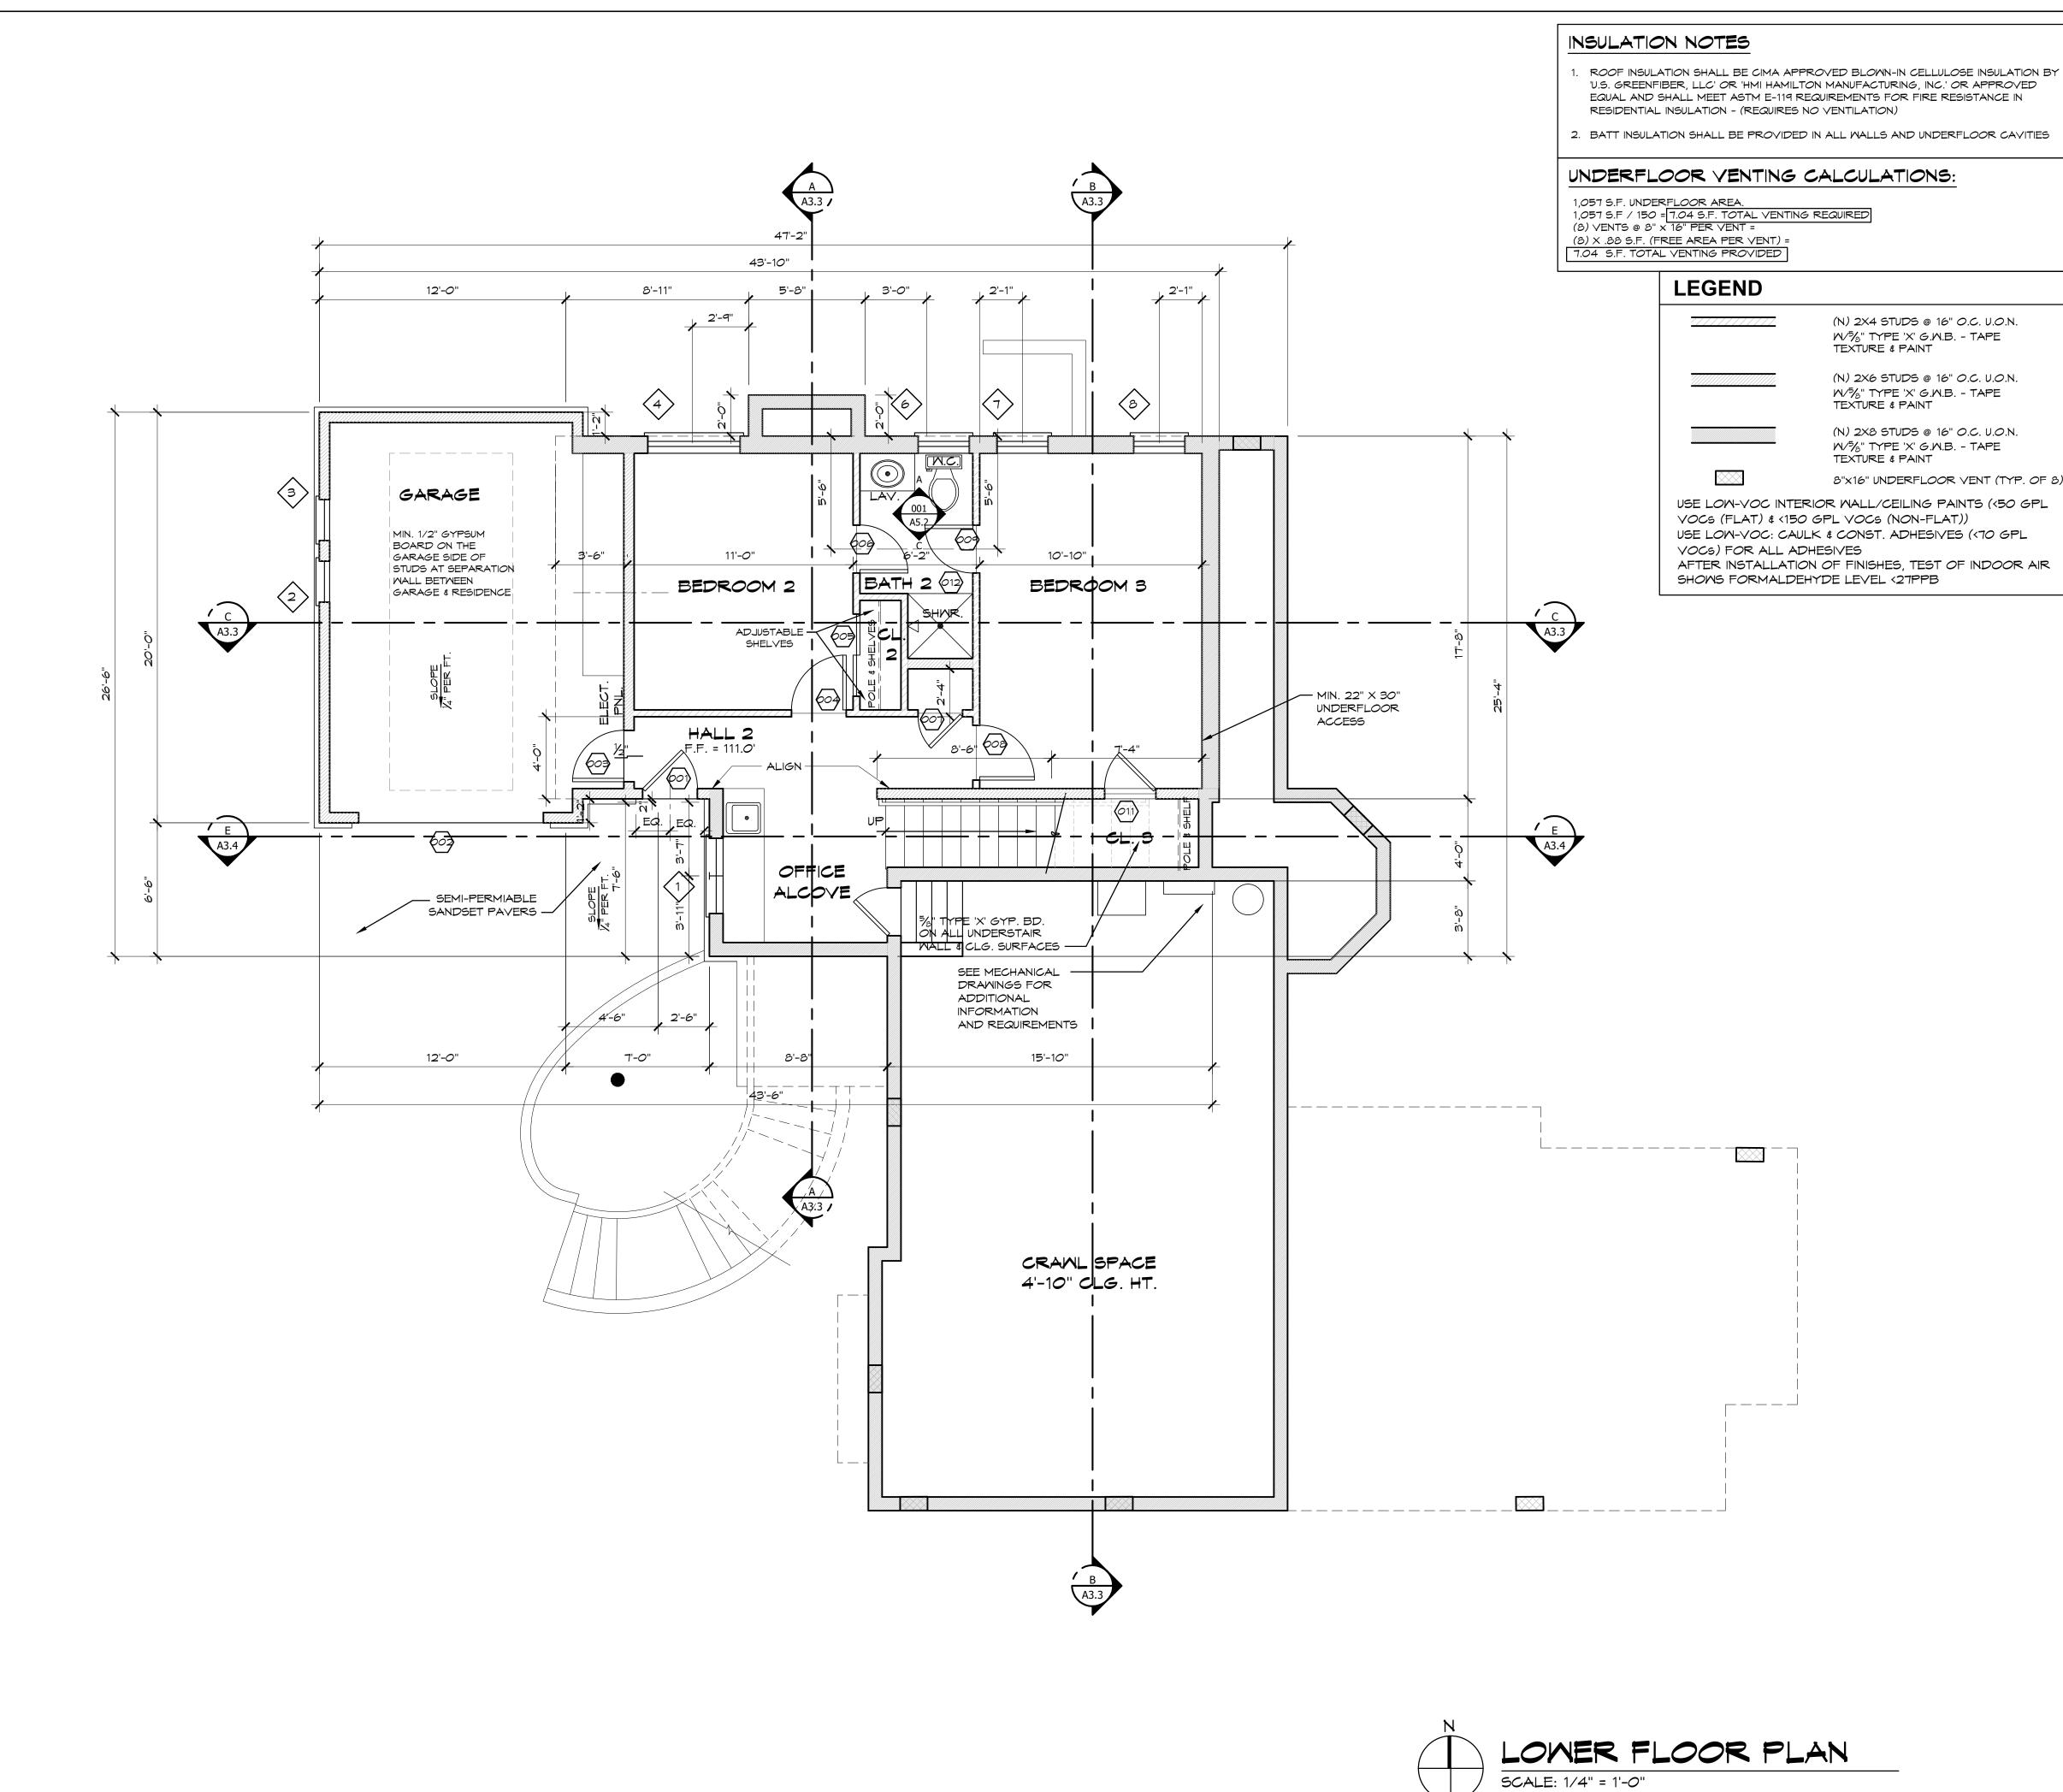

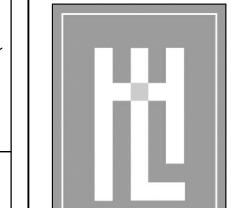

HOLDREN+LIETZKE ARCHITECTURE

225 CANNERY ROW - SUITE A MONTEREY, CA 93940

Ph: 831.649.6001
Fax: 831.649.6003

www.hl-arc.com

DATE: 01.17.2024

SCALE: 1/4"=1'-0"

DRAWN: LL

JOB NUMBER: 23.10

REVISION

J. CRAIG HOLDREN

C-12768

W. SEP 30 2025


Reflewal Date

OF CALLY

LOWER FLOOR PLAN


NEWMAN RESIDENCE
CARMELO, 3 SE OF 4TH
CARMEL, CA 93921
A.P.N. 010-252-020


A2.1

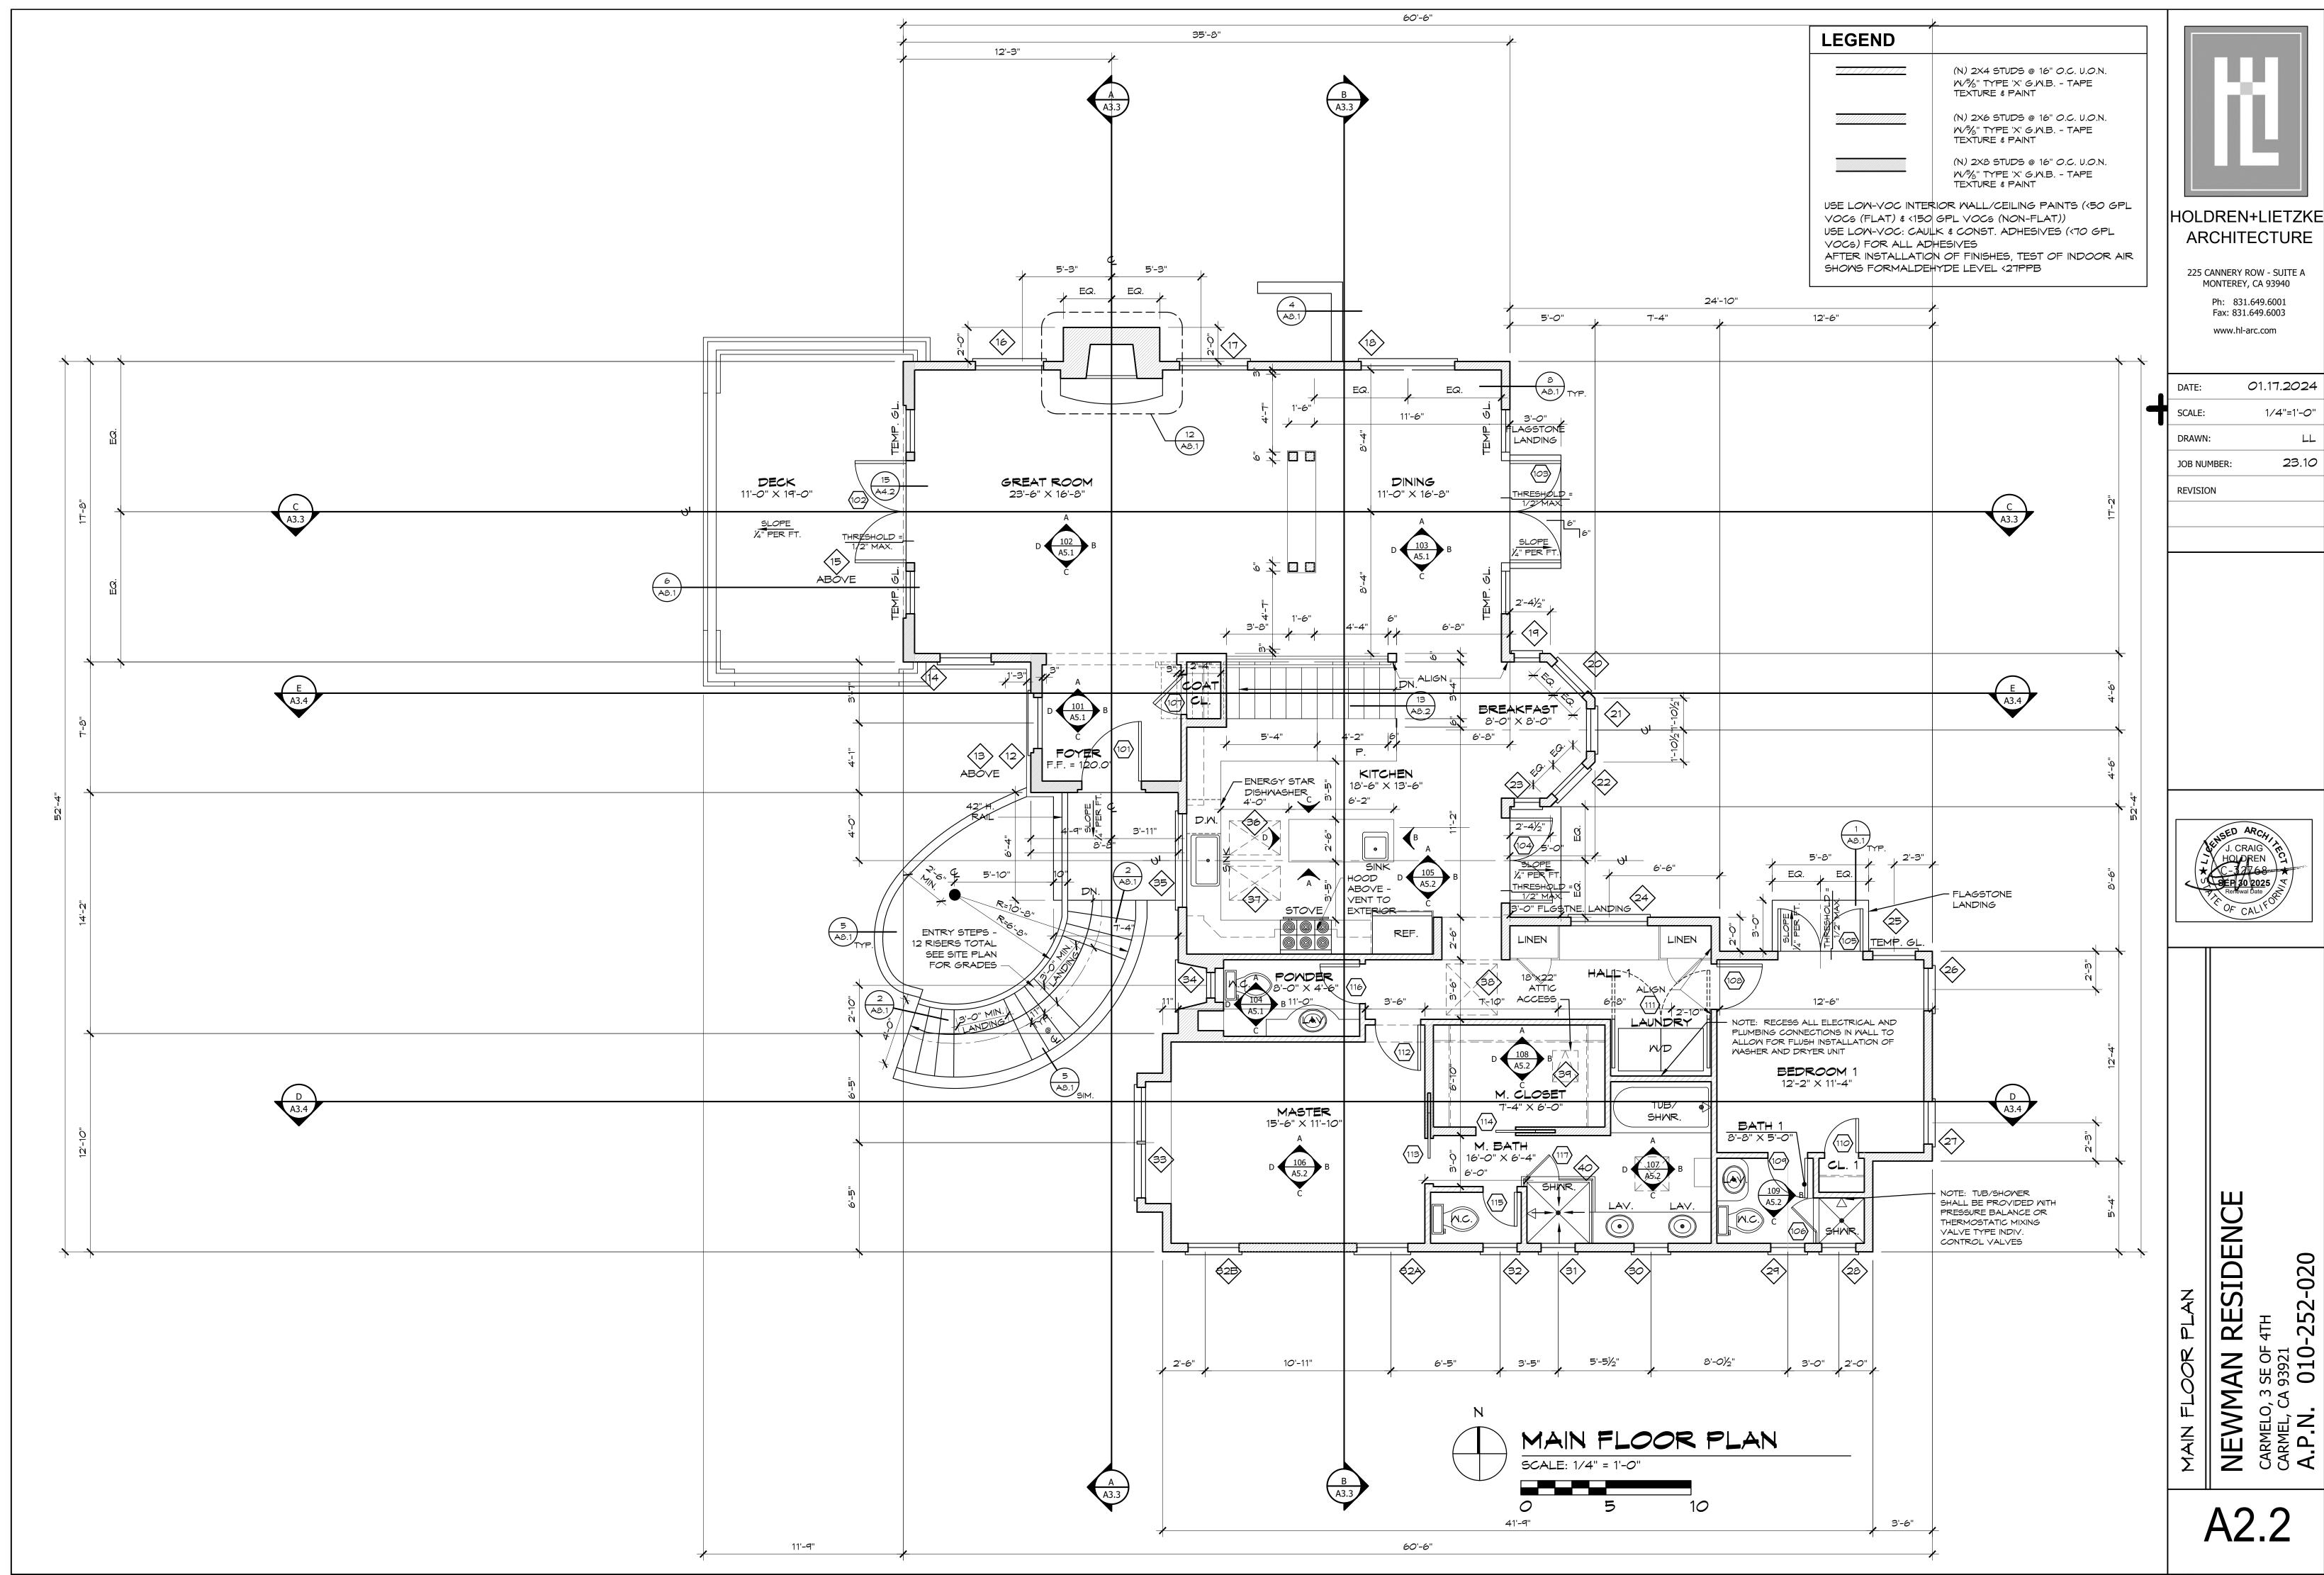

HOLDREN+LIETZKE

01.17.2024 1/4"=1'-0" 23.10

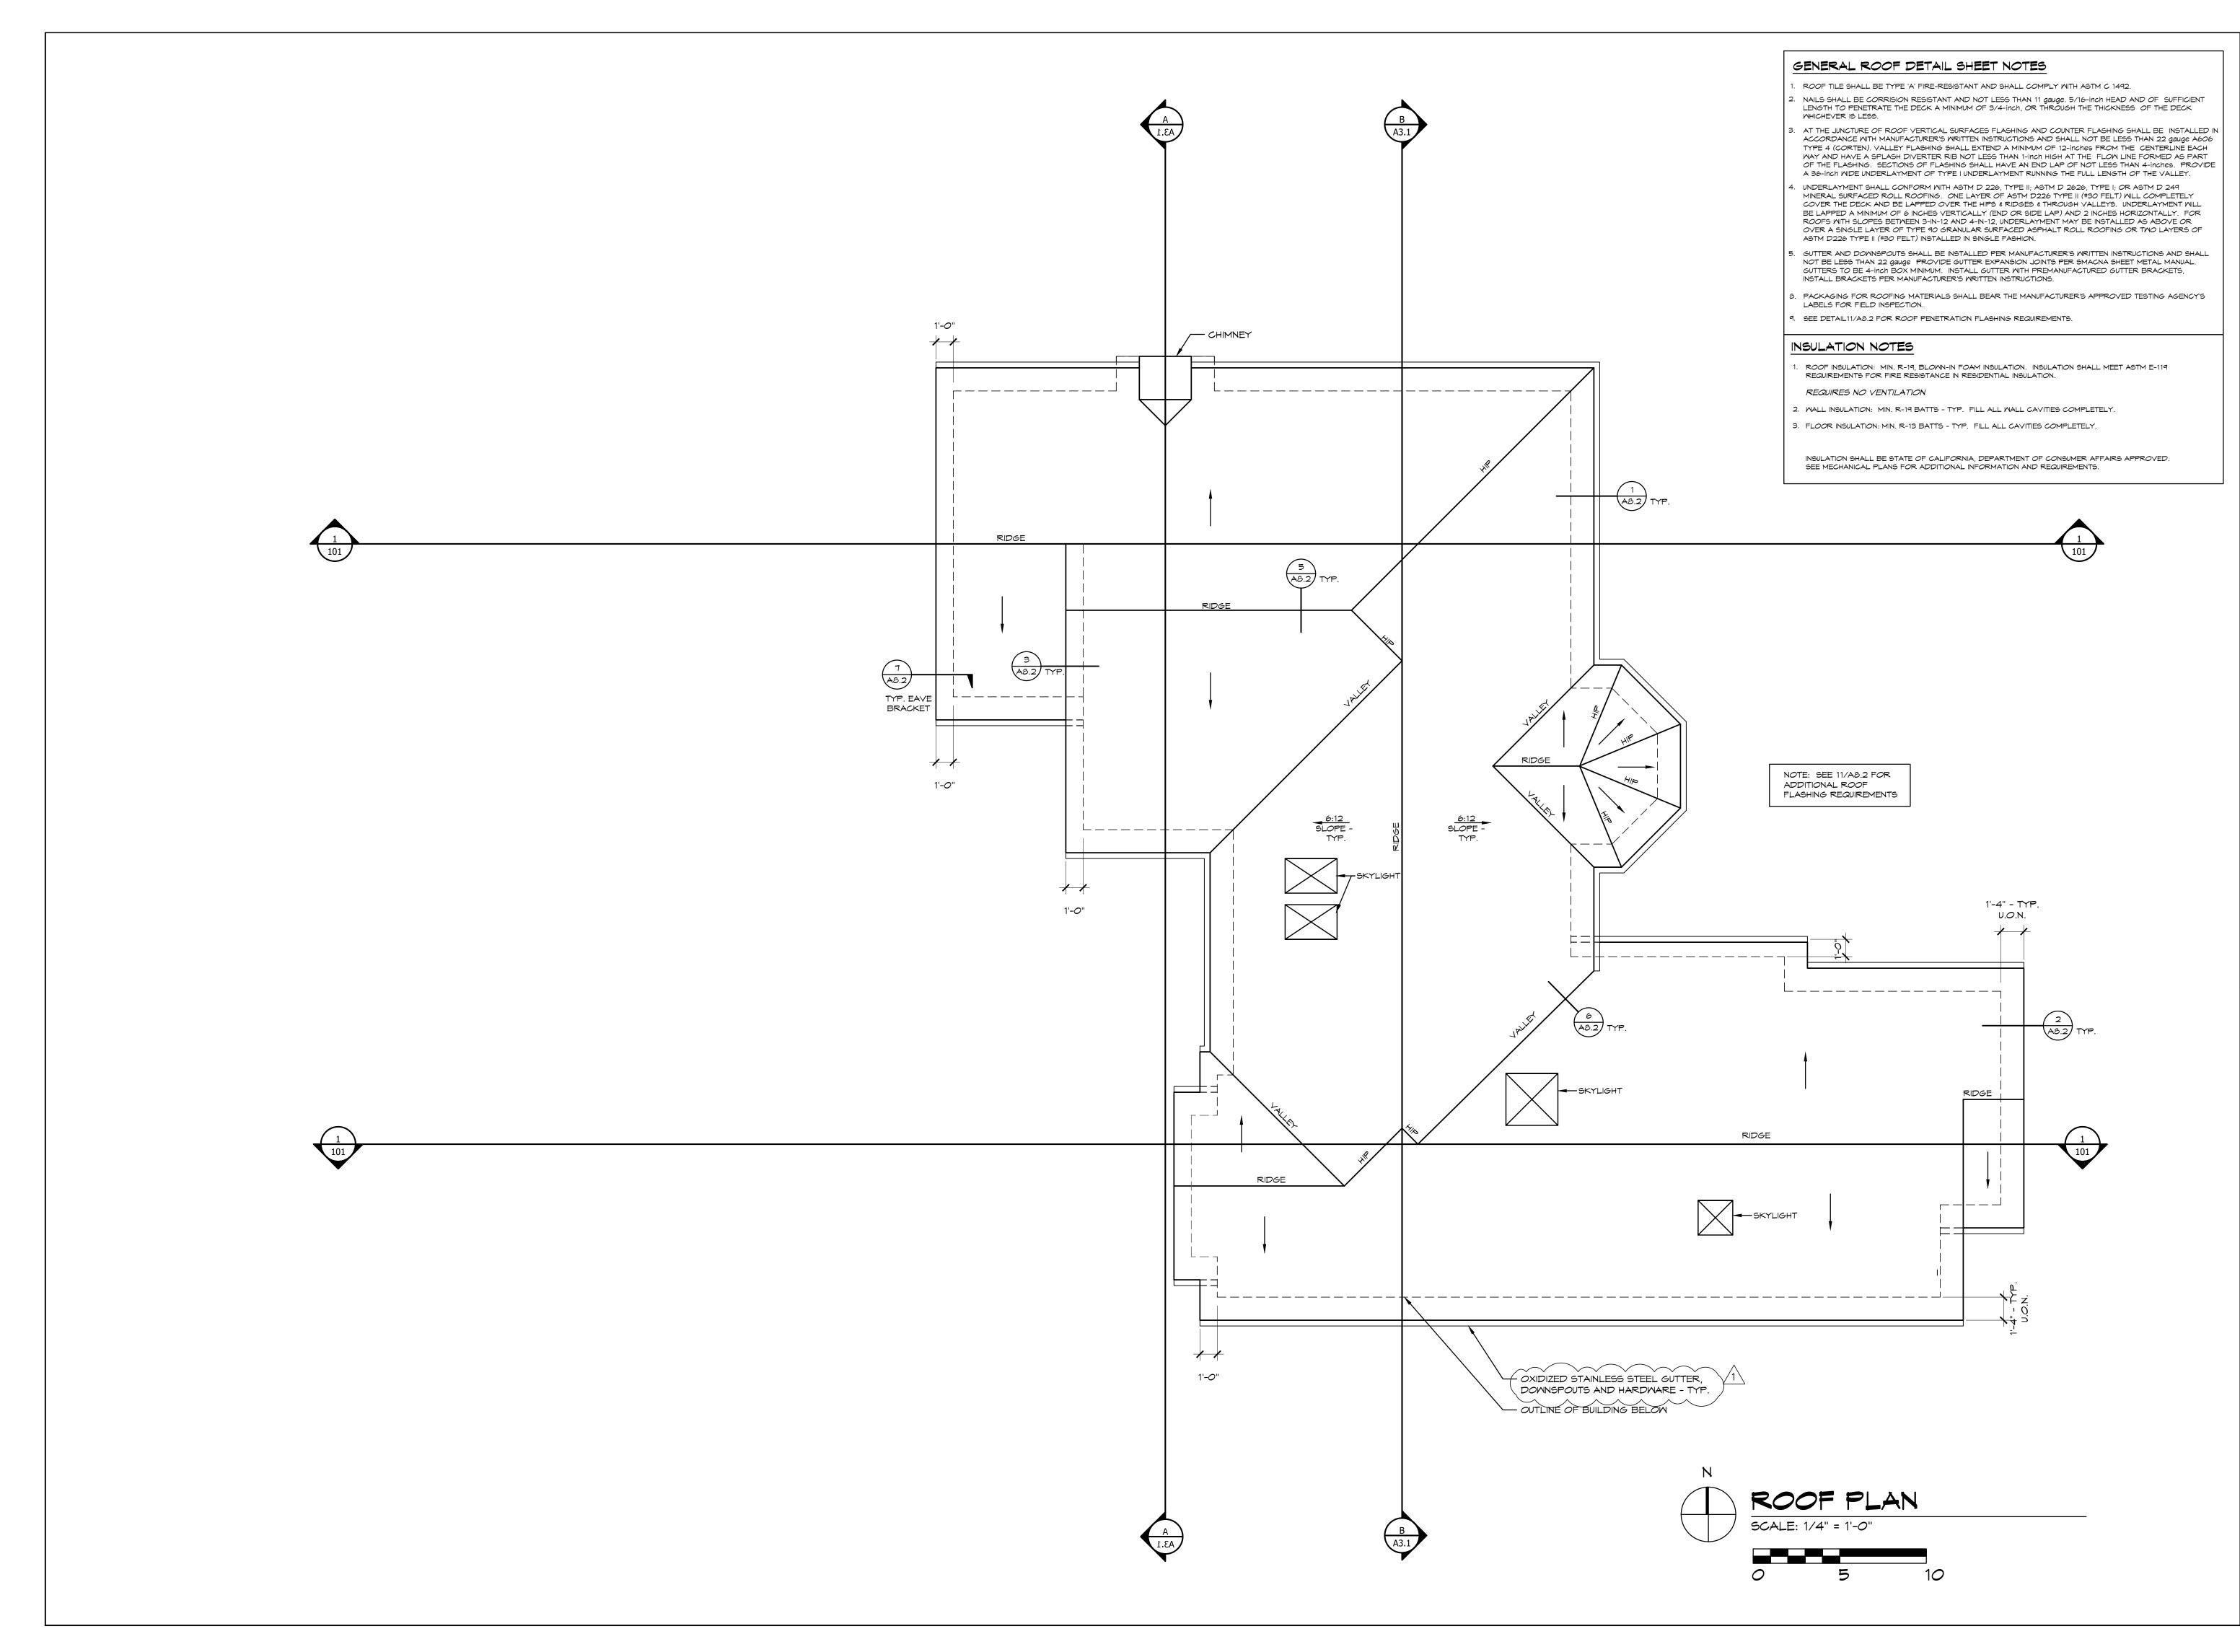

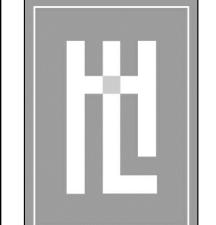

HOLDREN+LIETZKE ARCHITECTURE

225 CANNERY ROW - SUITE A MONTEREY, CA 93940

Ph: 831.649.6001
Fax: 831.649.6003

www.hl-arc.com

DATE: 01.17.2024

SCALE: 1/4"=1'-0"

DRAWN: LL

JOB NUMBER: 23.10


REVISION


↑ PLANNING COMMENT

04/10/24



NEWMAN RESIDENCE
CARMELO, 3 SE OF 4TH
CARMEL, CA 93921
A.P.N. 010-252-020

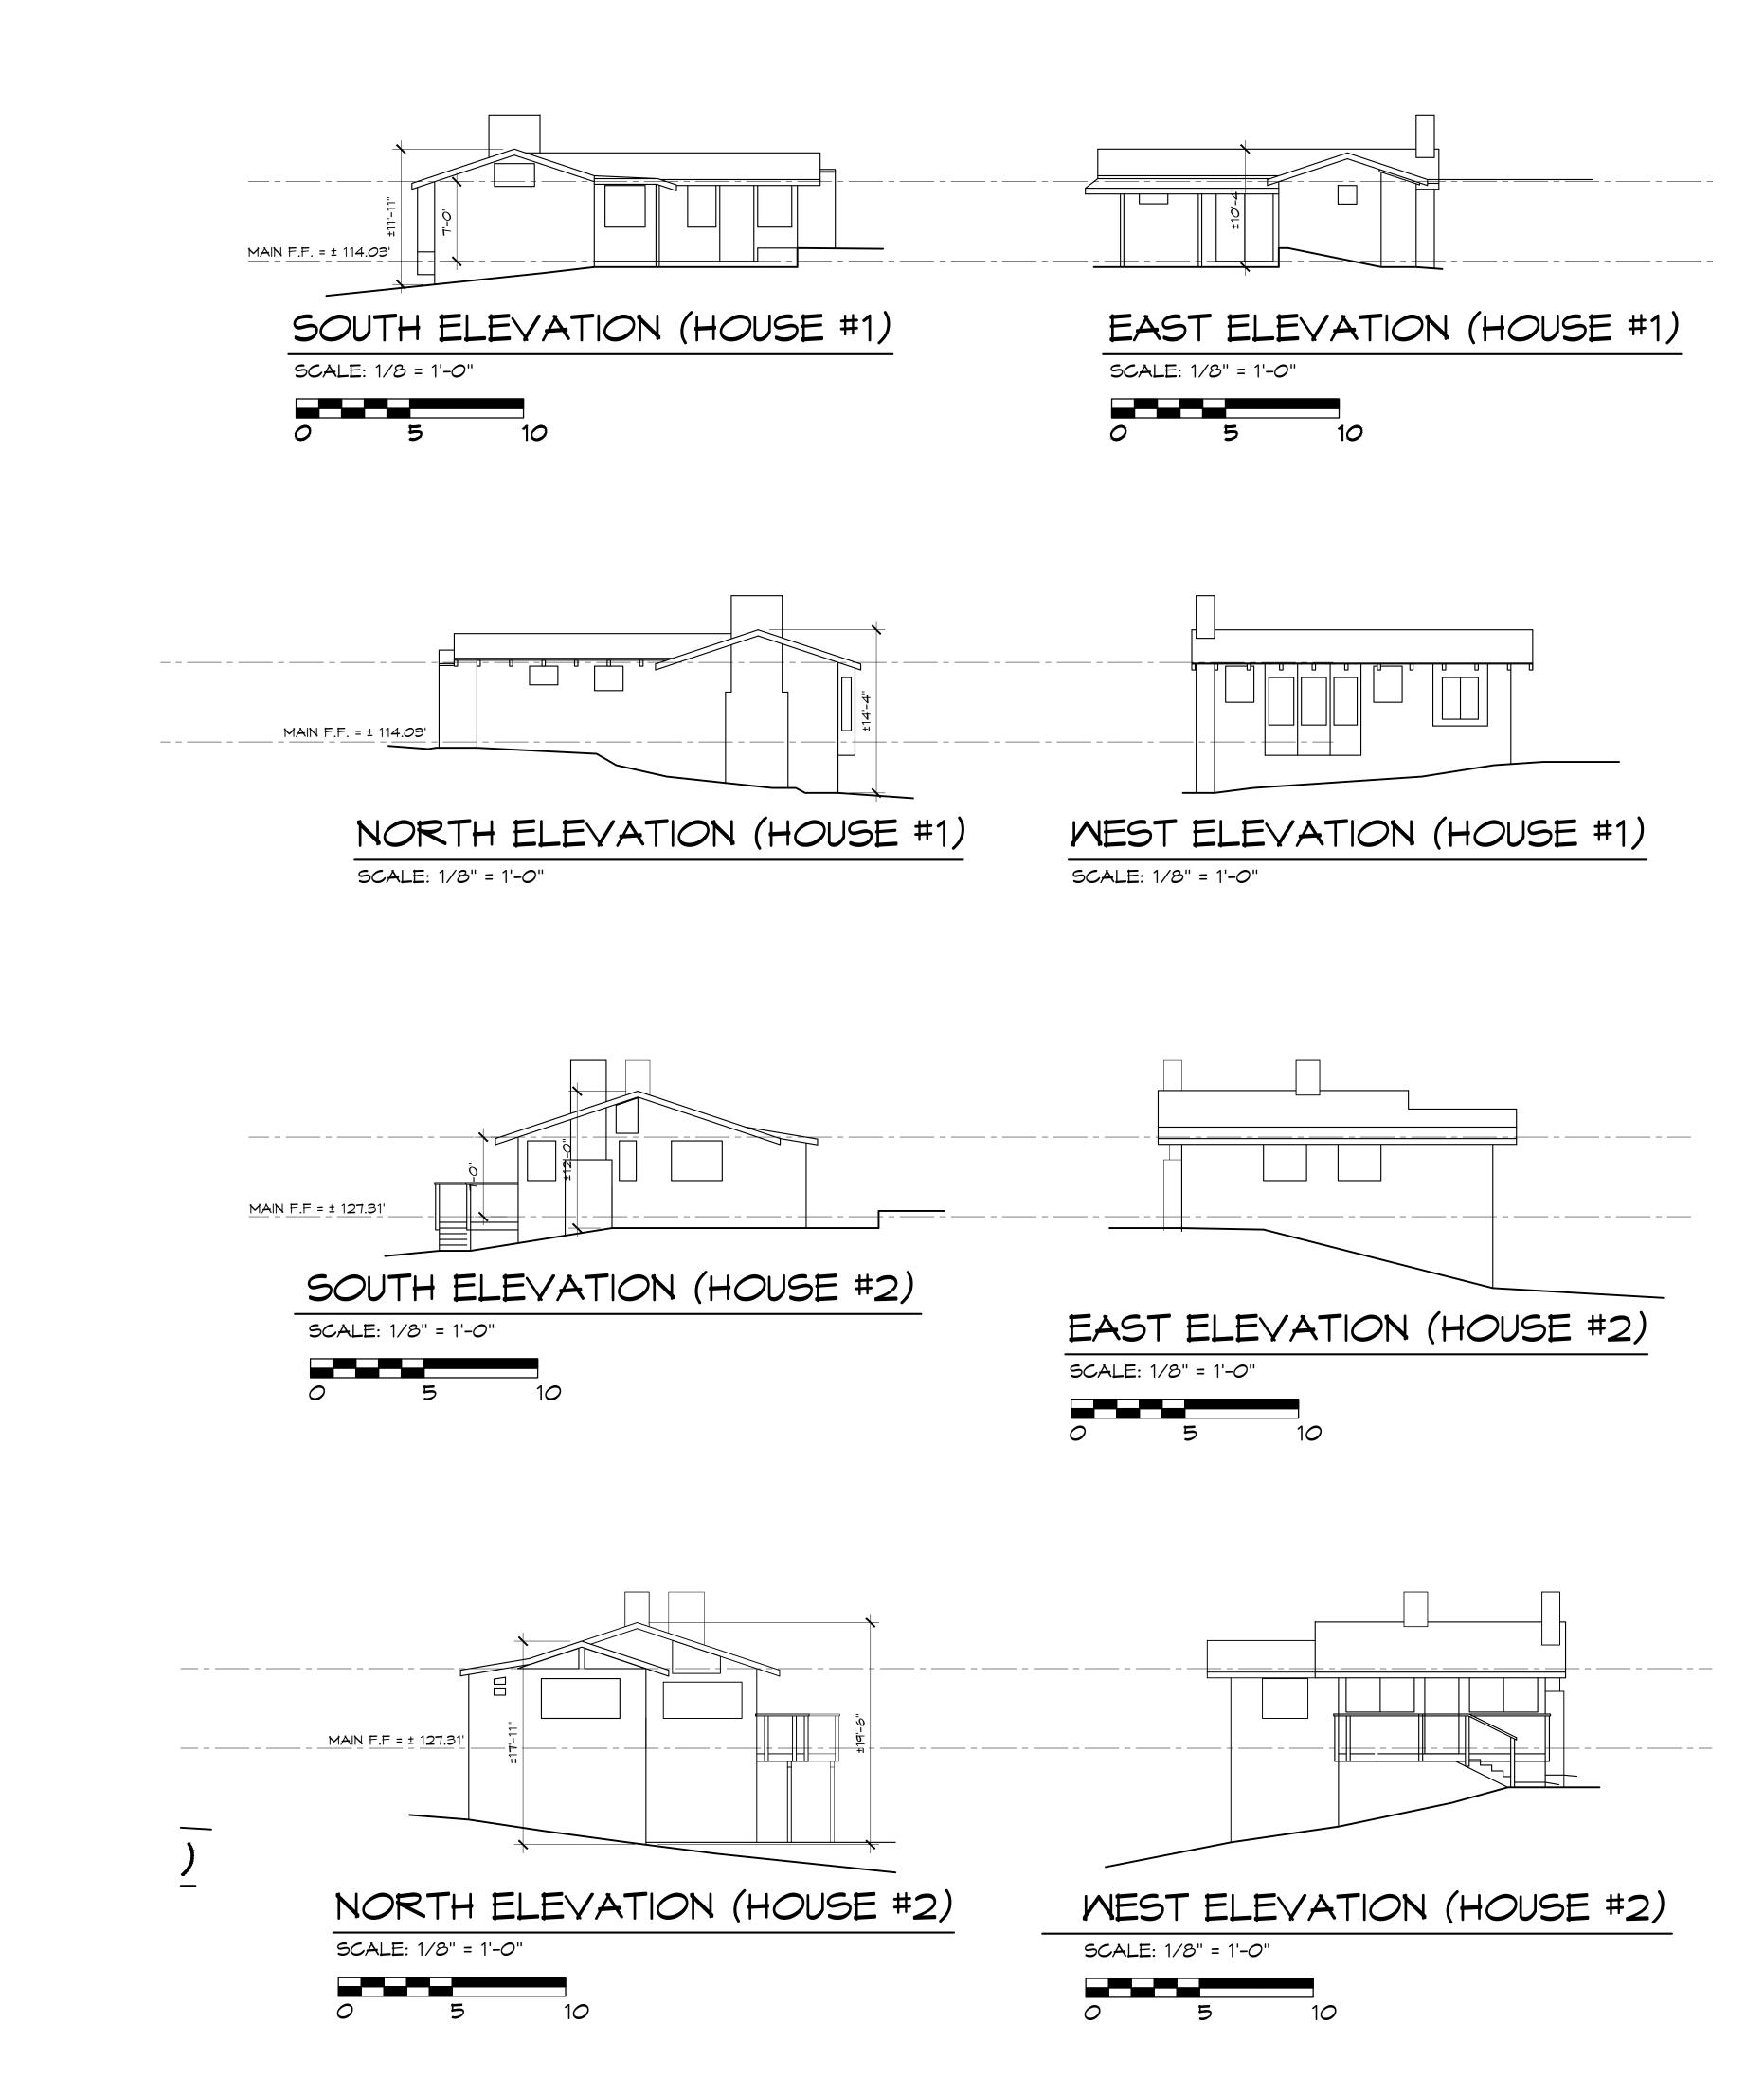

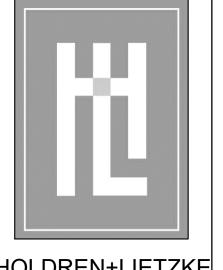

HOLDREN+LIETZKE ARCHITECTURE

225 CANNERY ROW - SUITE A MONTEREY, CA 93940

Ph: 831.649.6001
 Fax: 831.649.6003
 www.hl-arc.com

DATE: 01.17.2024


SCALE: 1/8"=1'-0"

DRAWN: 5GC

JOB NUMBER: 23.10

REVISION


PLANNING COMMENT 04/10/24

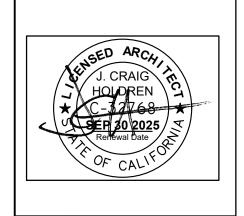



KTERIOR ELEVATIONS


NEWMAN RESIDENC
CARMELO, 3 SE OF 4TH
CARMEL, CA 93921
A.P.N. 010-252-020

A3.0

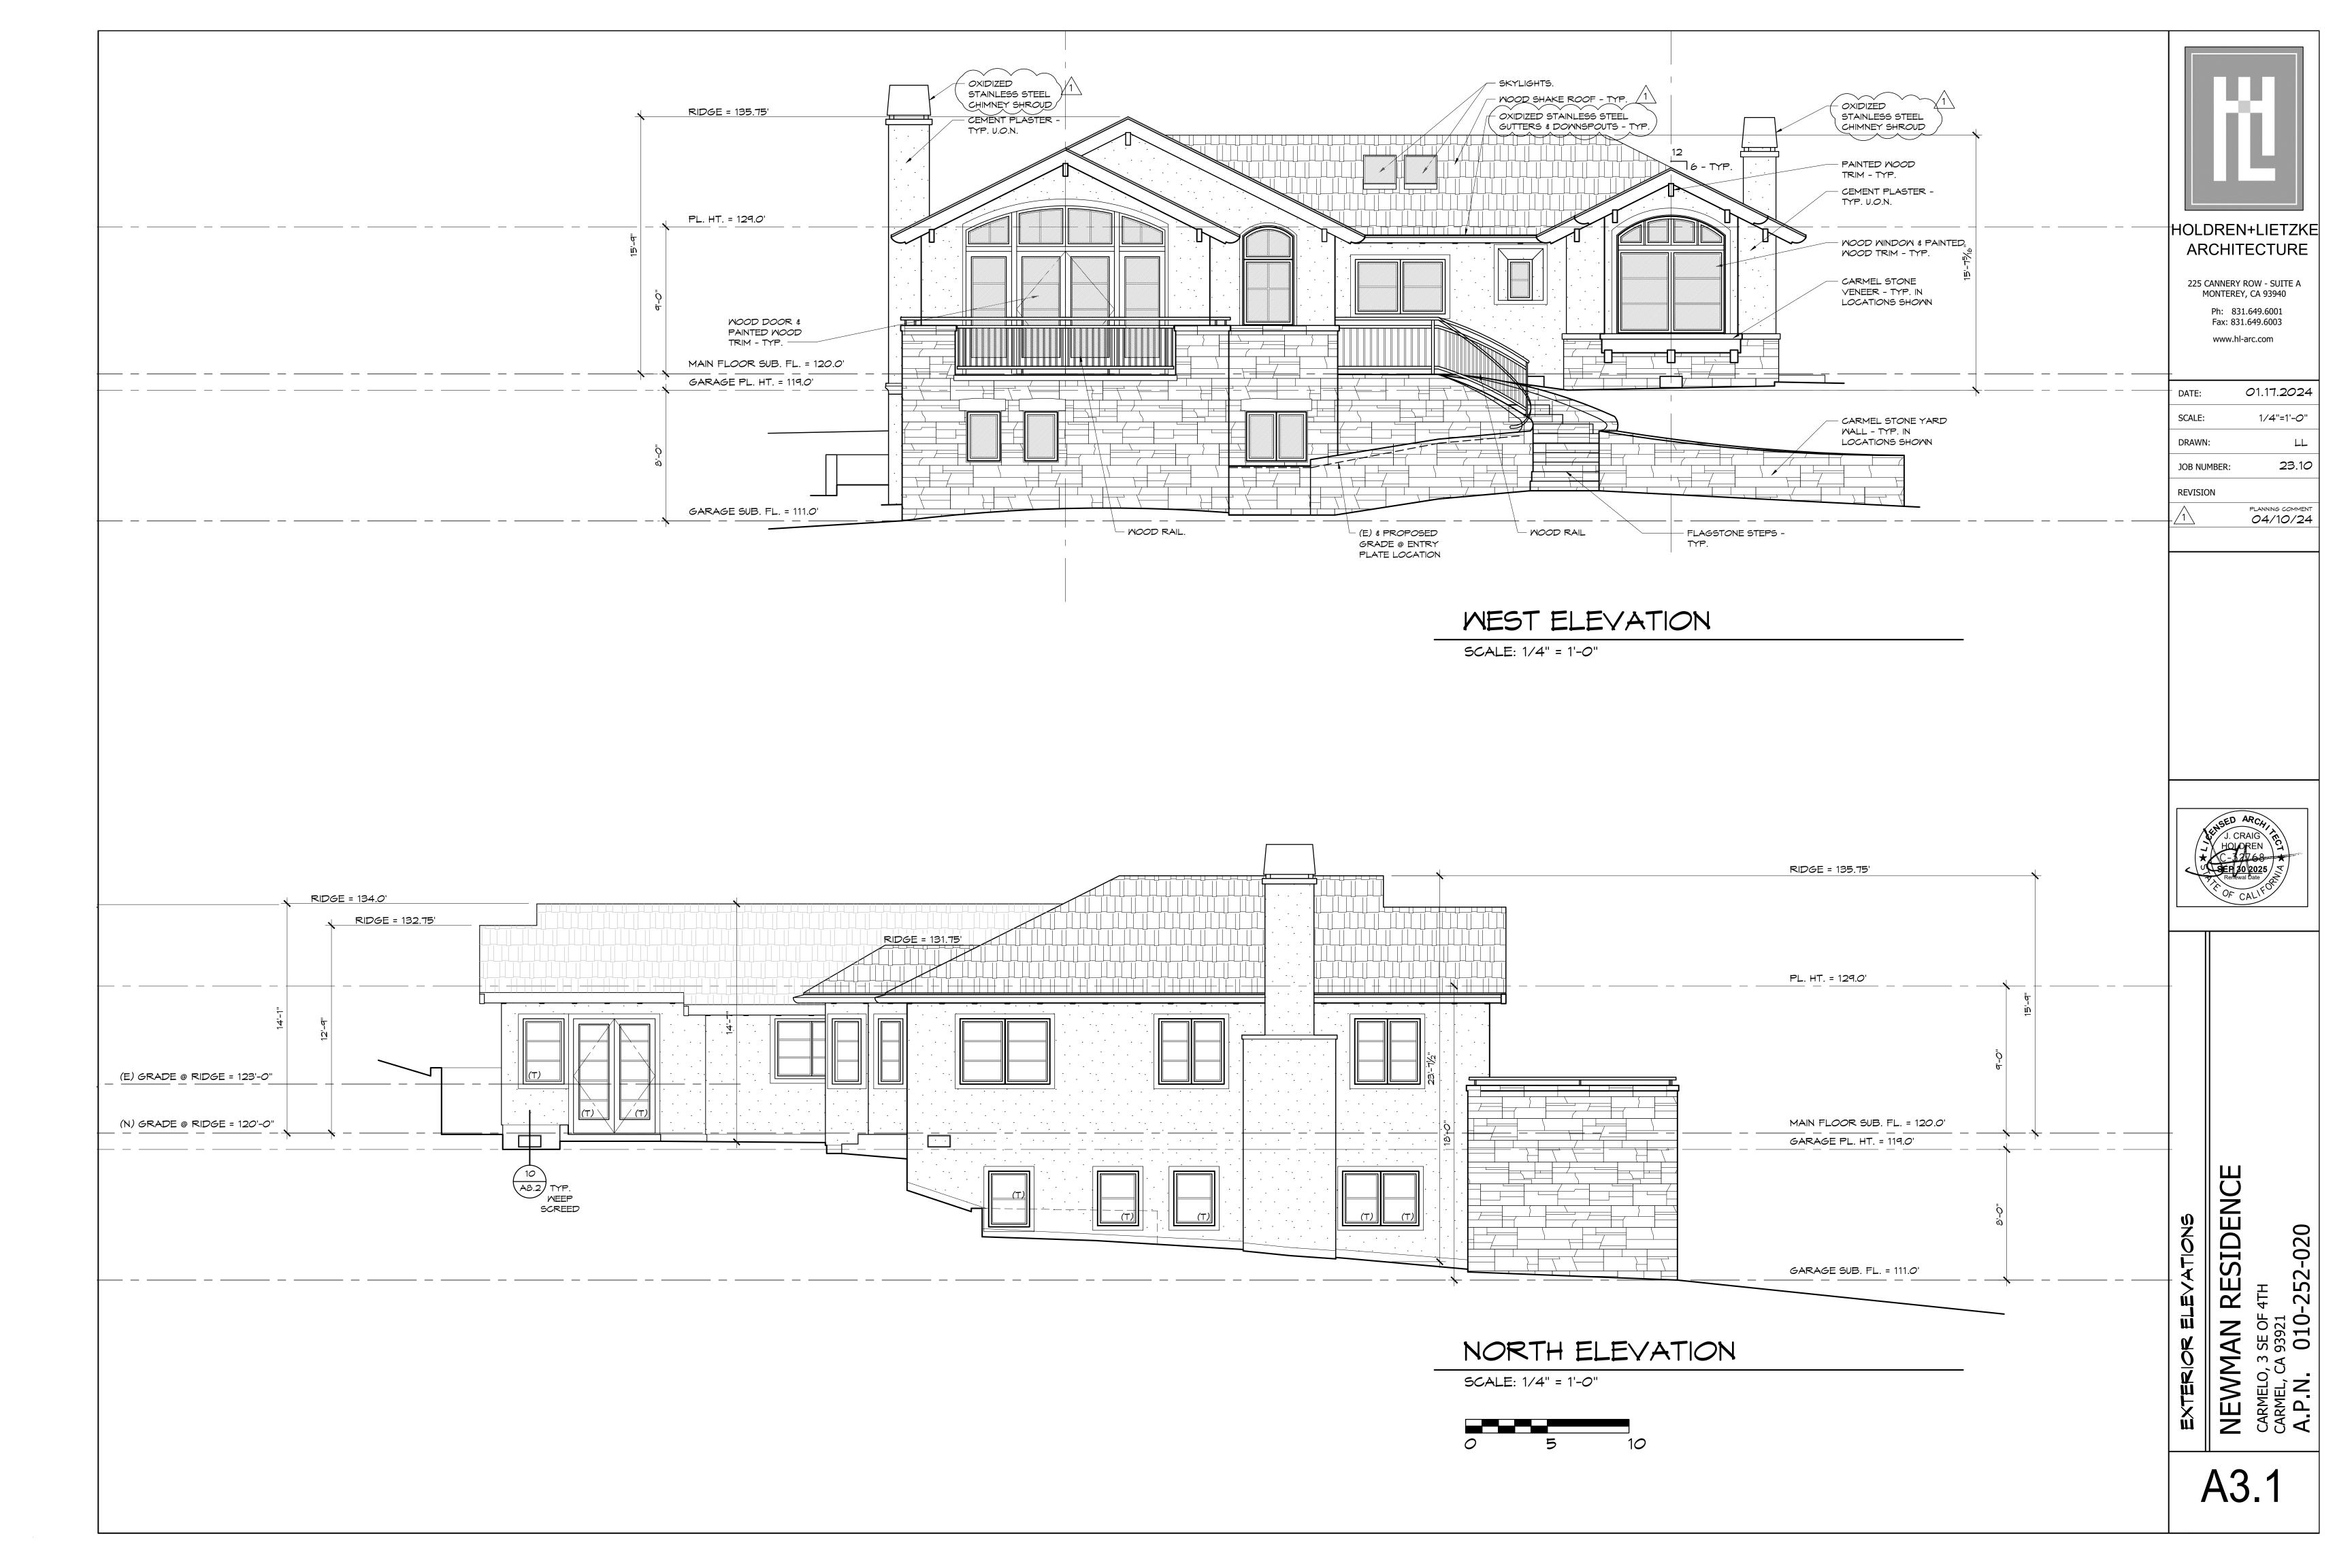

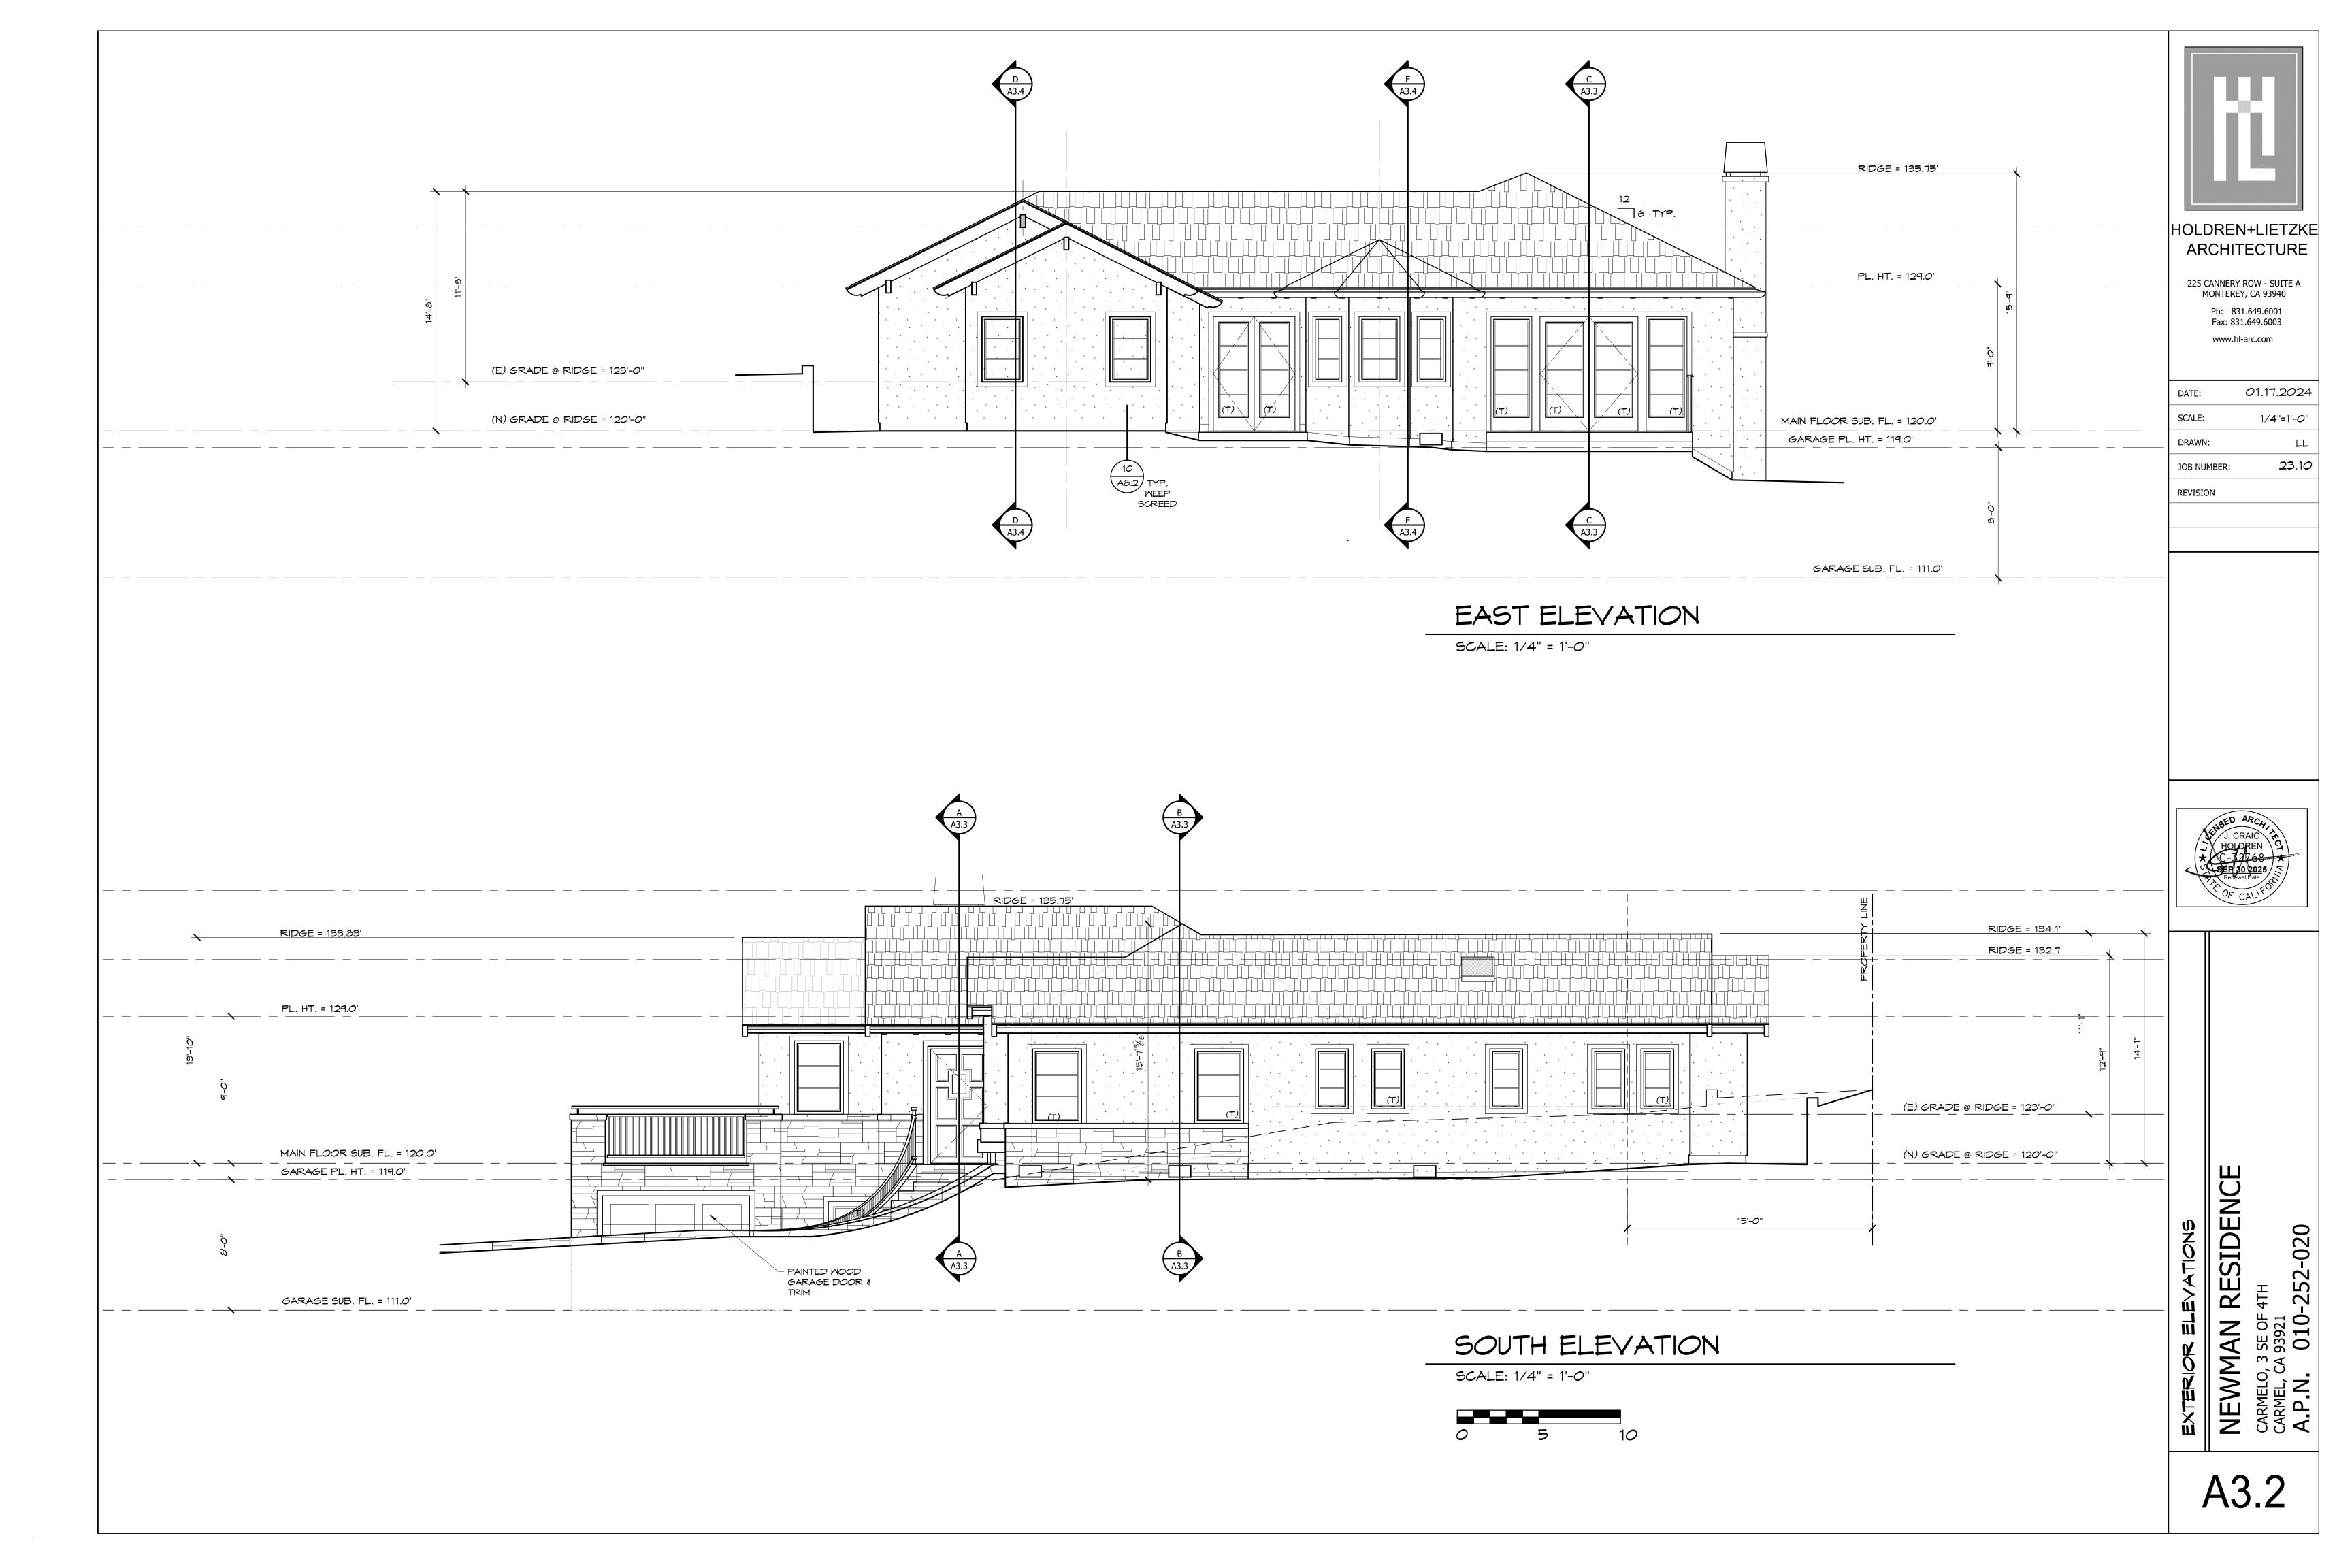

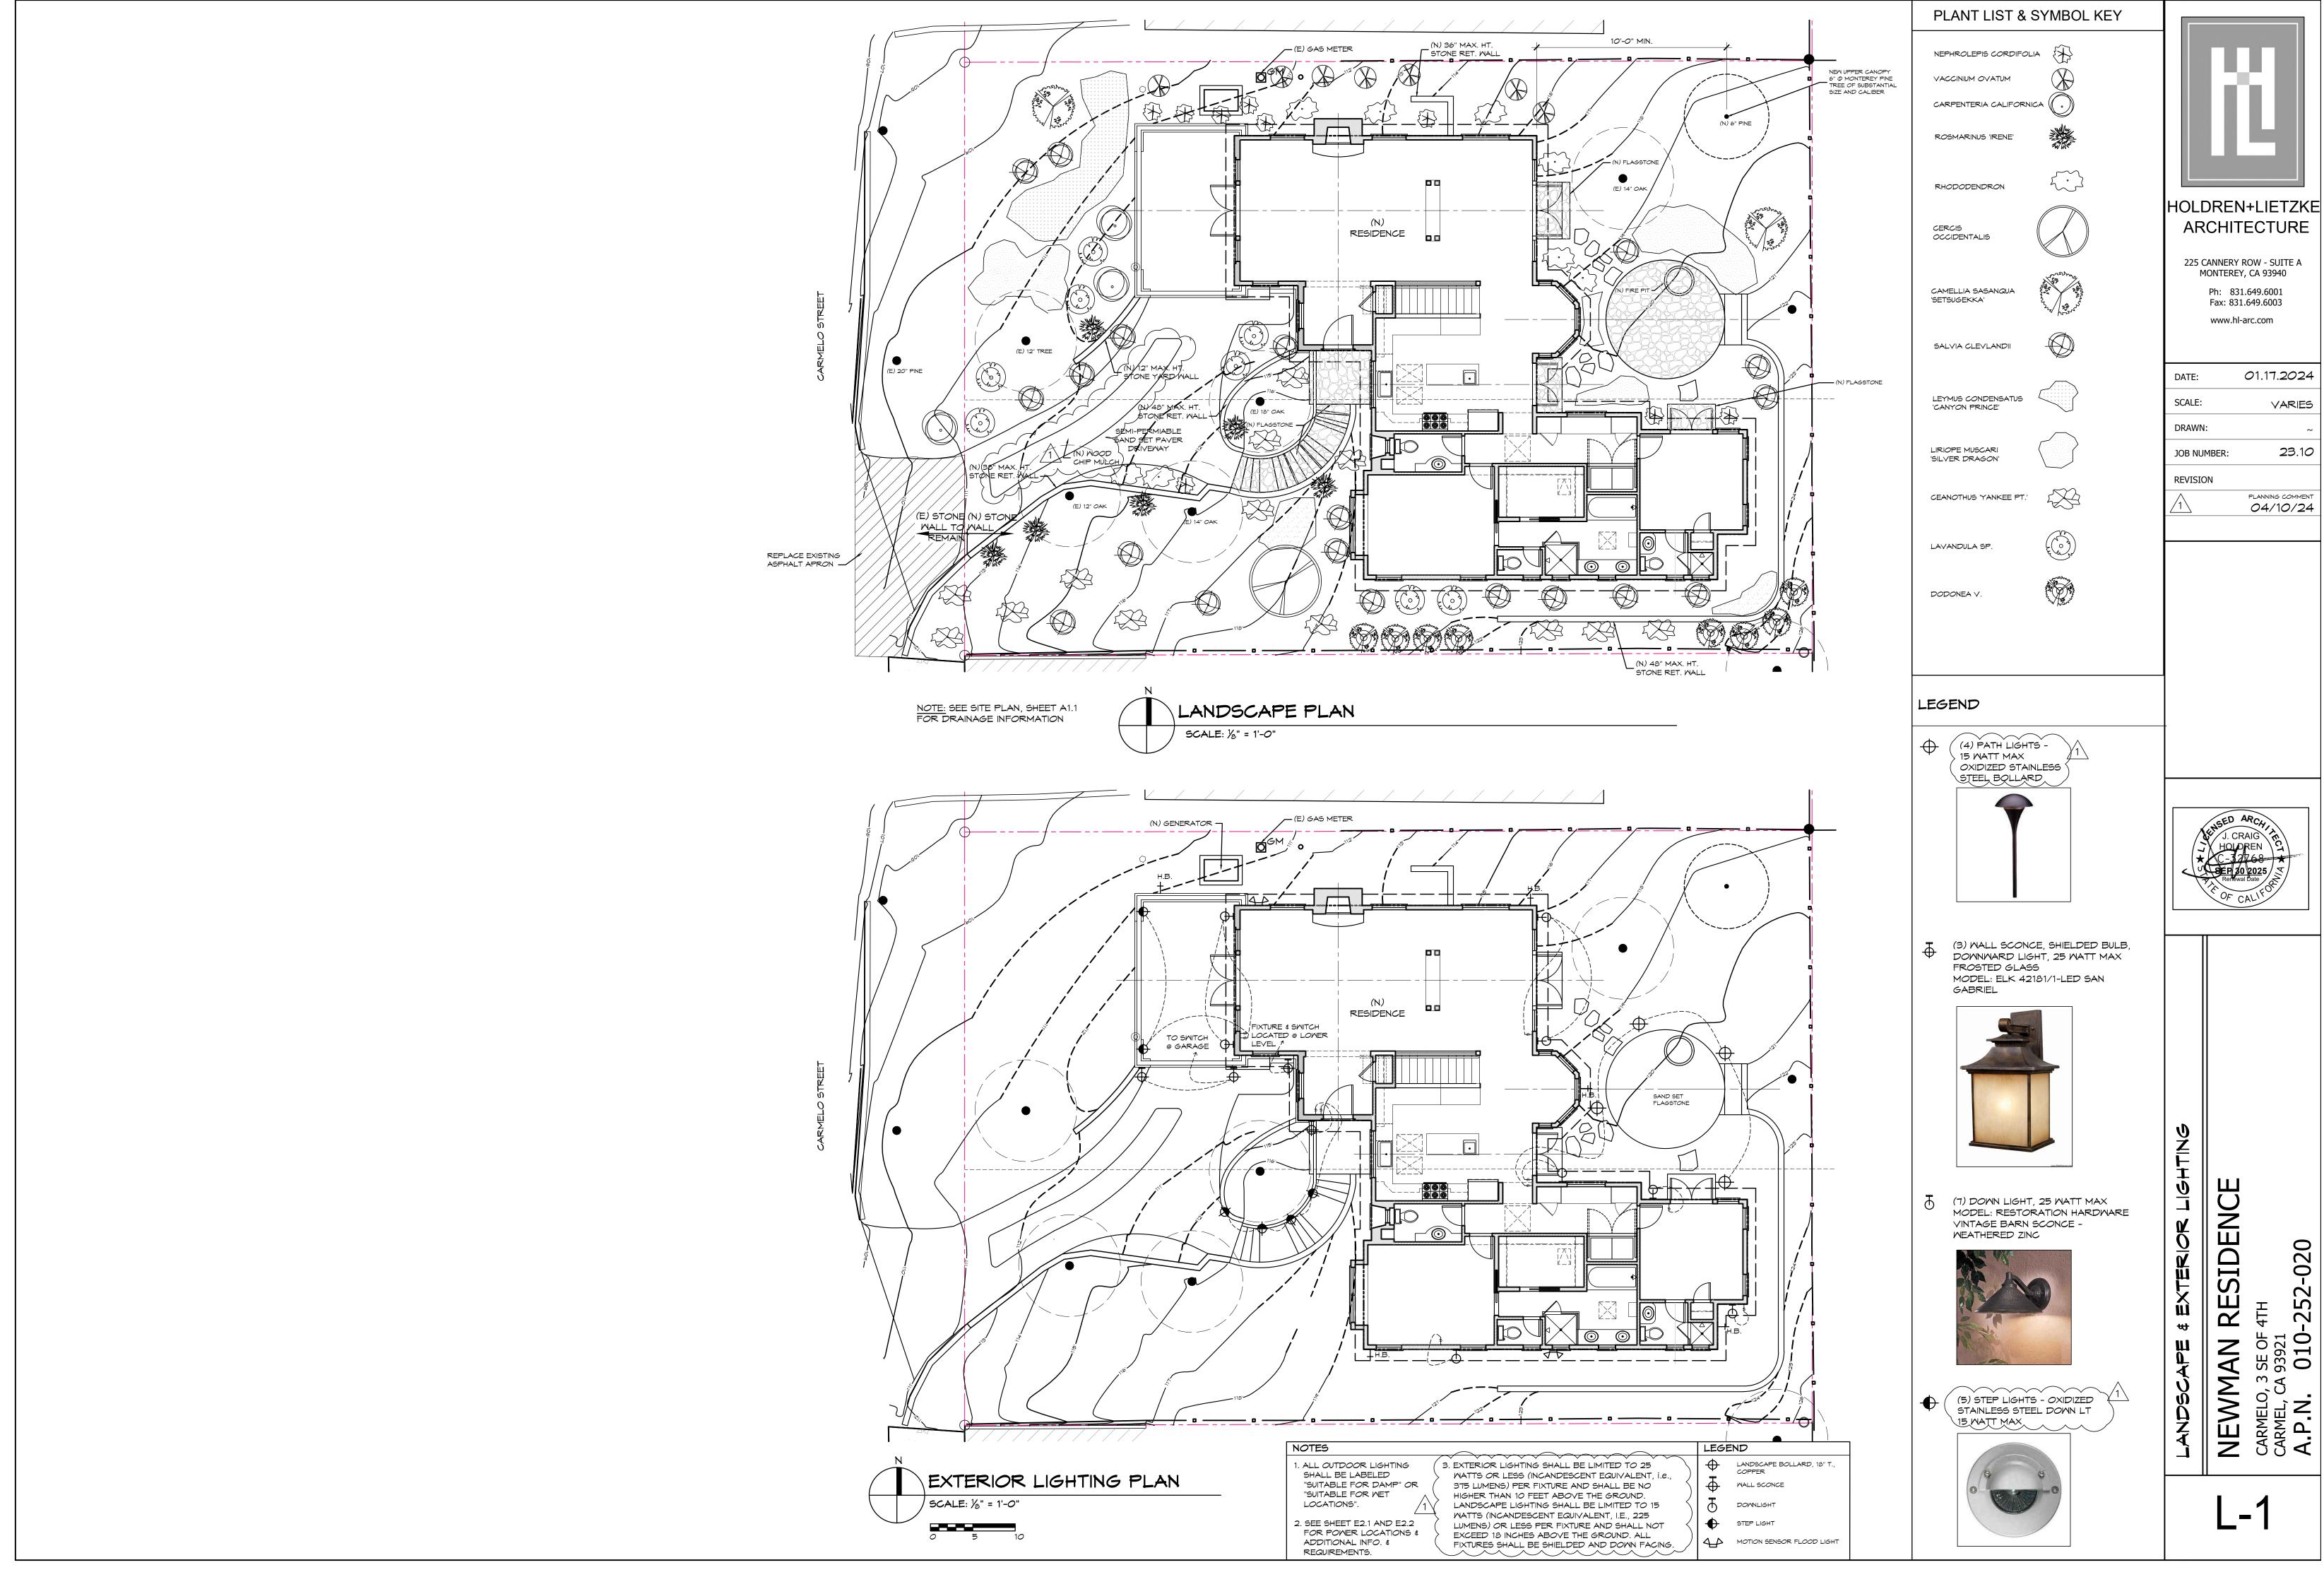

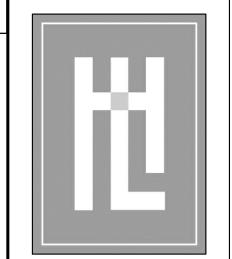

01.17.2024 VARIES 23.10