

The Department of Community Planning & Building of the City of Carmel-by-the-Sea has approved a Project pursuant to the City's Municipal Code. Persons interested in the project may review additional materials available at the Department of Community Planning & Building located at City Hall on Monte Verde Street between Ocean and 7th Avenues, phone number 831-620-2010.

The decision to approve this project may be appealed within 10 days from the date of this by filing a written appeal with the Department of Community Planning & Building.

Planning Case #: Design Study 23382

Owner Name: WILKS DIANA J TR

Case Planner: Marnie R. Waffle, AICP, Principal Planner

Date Posted:

Date Approved: 03/25/2024

Project Location: SW Corner of Monte Verde & 9th

APN #: 010186016000 **BLOCK/LOT:** D/1

Applicant: Alex Sandoval, Contractor

Project Description: This approval of Design Study application DS 23-382 (Wilks) authorizes the removal of two pairs of French doors and a pair of fixed full-height windows with a single door and four-panel folding door at an existing single-family residence located at the southwest corner of Monte Verde Street and Ninth Avenue in the Single-Family Residential (R-1) District as depicted in the plans prepared by AGS Construction Inc. consisting of 12 sheets including door specifications by AG Millworks stamped approved and on file in the Community Planning & Building Department unless modified by the conditions of approval.

Can this project be appealed to the Coastal Commission? Yes \Box No 🗹

Upon completion of the 10 calendar-day appeal period, please return this form, along with the *Affidavit of Posting, to the case planner noted above.*

	CONDITIONS OF APPROVAL		
No.	Standard Conditions		
1.	Authorization. This approval of Design Study application DS 23-382 (Wilks) authorizes the removal of two pairs of French doors and a pair of fixed full-height windows with a single door and four-panel folding door at an existing single-family residence located at the southwest corner of Monte Verde Street and Ninth Avenue in the Single-Family Residential (R-1) District as depicted in the plans prepared by AGS Construction Inc. consisting of 12 sheets including door specifications by AG Millworks stamped approved and on file in the Community Planning & Building Department unless modified by the conditions of approval contained herein.		
2.	Codes and Ordinances. The project shall be constructed in conformance with all requirements of the R-1 zoning district. All adopted building and fire codes shall be adhered to in preparing the working drawings. If any codes or ordinances require design elements to be changed, or if any other changes are requested when such plans are submitted, such changes may require additional environmental review and subsequent approval by the Director.		
3.	Permit Validity. In accordance with CMC Section 17.52.170 (Time Limits on Approvals and Denials), a residential design study approval remains valid for a period of 12 months from the date of action. During this time, the project must be implemented, or the approval becomes void. Implementation is effected by erecting, installing, or beginning the installation of the improvement authorized by the permit, as determined by the Director. Extensions to this approval may be granted consistent with CMC 17.52.170.C.		
4.	Modifications. The Applicant shall submit in writing, with revised plans, to the Community Planning and Building staff any proposed changes to the approved project plans prior to incorporating those changes. If the Applicant changes the project without first obtaining City approval, the Applicant will be required to submit the change in writing, with revised plans, within two weeks of the City being notified. A cease work order may be issued at any time at the discretion of the Director of Community Planning and Building until a) either the Planning Commission or Staff has approved the change, or b) the property owner has eliminated the change and submitted the proposed change in writing, with revised plans, for review. The project will be reviewed for its compliance with the approved plans prior to the final inspection.		
5.	Conflicts Between Planning Approvals and Construction Plans. It shall be the responsibility of the Owner, Applicant, and Contractor(s) to ensure consistency between the project plans approved by the Planning Staff, the Planning Commission, or the City Council on appeal and the construction plans submitted to the Building Division as part of the Building Permit review. Where inconsistencies between the Planning approval and the construction plans exist, the Planning approval shall govern unless otherwise approved in writing by the Community Planning & Building Director or their designee.		

	When changes or modifications to the project are proposed, the Applicant shall clearly list
	and highlight each proposed change and bring each change to the City's attention.
	Changes to the project incorporated into the construction drawings that were not clearly
	listed or identified as a proposed change shall not be considered an approved change.
	Should conflicts exist between the originally approved project plans and the issued
	construction drawings that were not explicitly identified as a proposed change, the plans
	approved as part of the Planning Department Review, including any Conditions of
	Approval, shall prevail.
6.	Aluminum-Clad Wood Frame Doors. Prior to the issuance of a building permit, the
0.	Autimuti-Ciau wood Frame Doors. Phot to the issuance of a building permit, the
0.	Applicant shall include the manufacturer's specifications for the approved aluminum-clad
0.	
0.	Applicant shall include the manufacturer's specifications for the approved aluminum-clad
7.	Applicant shall include the manufacturer's specifications for the approved aluminum-clad wood frame doors. Any window pane dividers, which are snap-in or otherwise superficially
	Applicant shall include the manufacturer's specifications for the approved aluminum-clad wood frame doors. Any window pane dividers, which are snap-in or otherwise superficially applied, are not permitted. The painted finish shall be matte or low gloss.
	Applicant shall include the manufacturer's specifications for the approved aluminum-clad wood frame doors. Any window pane dividers, which are snap-in or otherwise superficially applied, are not permitted. The painted finish shall be matte or low gloss. Indemnification. The Applicant agrees, at his or her sole expense, to defend, indemnify,
	Applicant shall include the manufacturer's specifications for the approved aluminum-clad wood frame doors. Any window pane dividers, which are snap-in or otherwise superficially applied, are not permitted. The painted finish shall be matte or low gloss. Indemnification. The Applicant agrees, at his or her sole expense, to defend, indemnify, and hold harmless the City, its public officials, officers, employees, and assigns from any

proceedings to attack, set aside, void, or annul any project approval. The City shall promptly notify the Applicant of any legal proceeding and cooperate fully in the defense. The City may, at its sole discretion, participate in any such legal action, but participation shall not relieve the Applicant of any obligation under this condition. Should any party bring any legal action in connection with this project, the Superior Court of the County of Monterey, California, shall be the situs and have jurisdiction for resolving all such actions by the parties hereto.

8. **Conditions of Approval.** Prior to the issuance of a building permit, the Applicant shall print a copy of the Resolution adopted by the Planning Commission and signed by the property owner(s) on a full-size sheet within the construction plan set submitted to the Building Safety Division.

Acknowledgment and acceptance of conditions of approval:

Property Owner Signature

Printed Name

Date

Applicant Signature

Printed Name

Date

	SHEET INDEX	
	ARCHITECTURAL	
A-000	TITLE SHEET	•
A-001	EXISTING FLOOR PLAN	•
A-002	EXISTING EXTERIOR DOOR	•
A-003	PROPOSED NEW EXTERIOR DOOR	•
A-004	PROPOSED REMODEL BATHROOM 2	•
A-005	PROPOSED REMODEL BATHROOM 2 - SHOWER DETAIL	•
A-006	EXISTING FIRST FLOOR PLAN	•
	ELECTRICAL	
E-001	PROPOSED REMODEL BATHROOM 2 - POWER & LIGHTING	•
	STRUCTURAL	
S-001	PROPOSED NEW EXTERIOR DOOR - FRAMING DETAILS	•



Permit #: DS 23-382 (Wilks)	
Date Approved: 3/25/2024	
Planner: M. Waffle	
*Approval for door only.	

PROJECT TEAM	_

OWNER: WILKS DIANA J. TR 1(926) 995-1855 Carmel, California

DESIGN: AGS CONSTRUCTION INC. ALEX SANDOVAL LICENSE # 1054767 (831) 402-6419

LUIS ALFONSO OSORIO (831) 915-8657 STRUCTURAL ENGINEER RC Consulting Engineers, Inc. 7007 Realm Drive, # B-3 San Jose, CA 95119 408-229-8155

GENERAL CONTRACTOR AGS CONSTRUCTION INC. ALEX SANDOVAL LICENSE # 1054767 (831) 402-6419


PROJECT DATA		
PROJECT LOCATION:	9 th Ave. & Monteverde St., Camel, CA 92923	
Assesor Parcel ID:	010-186-016	
BLOCK:	D	
TRACT:		
LOT SIZE:	S.F	
Type of project:	RESIDENCE REMODEL	

Scope of Work: Replace existing 16'0" door to fix the water leak in the basement with a new louvered pan and a new door. Maintain the same opening size and height. Hallway bathroom (Bathroom 2) remodeling to include the same layout with new toilet, vanity, and tiled floor and walls.

NOTE:


Plans to comply with 2022 CA building code, electrical code, and the carmel municipal code

CARMEL REMODEL 9 th Ave. & Monteverde St., Camel, CA 92923	Owner: WILKS DIANA J. TR	General Contractor:	Acad File: Job Number: 202403 RR
Drawing Title:	Applicant:		
	ALEX SANDOVAL	ALS SCONSTRUCTIONING Alex Sandoval License # 1054767	
TITLE SHEET	162.OHstage Rd Salinas, CA 93906 E-mail: alexg9501@yahoo.com.com T: (831).402-6419	G	Scale: 1/4° = 1'0° Date: SHEE ^T

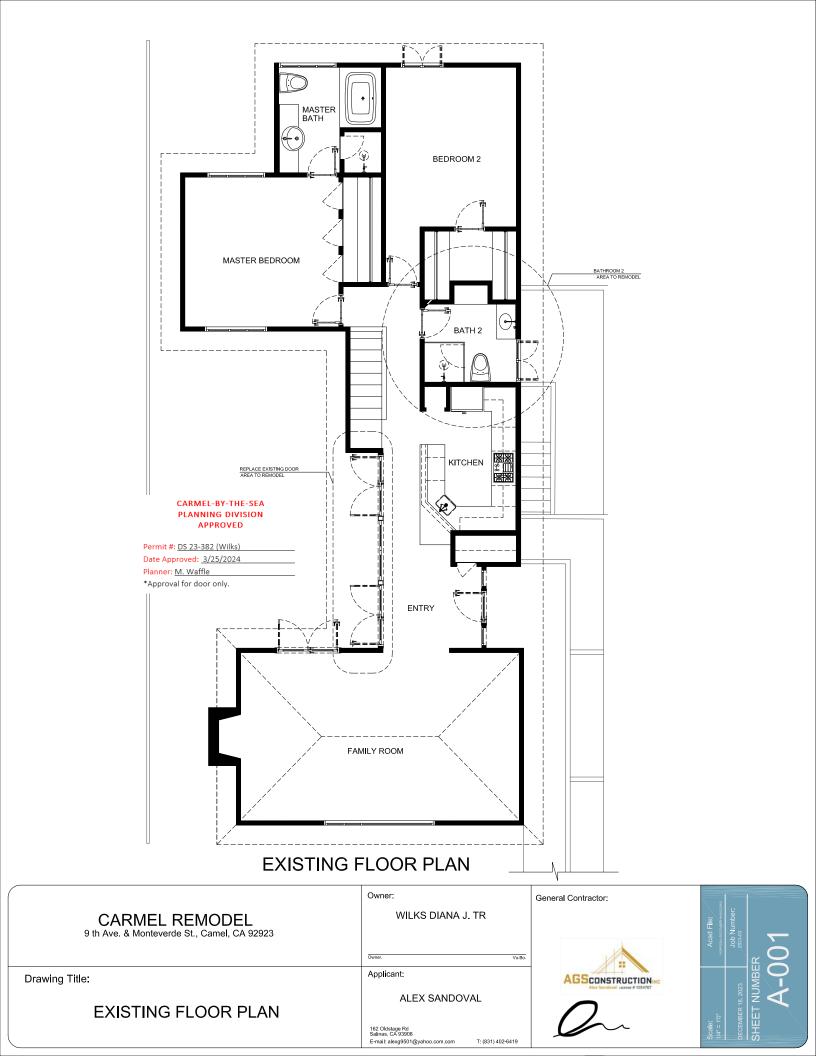




EXISTING

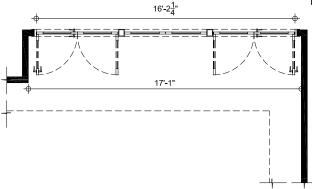


EXISTING FLOOR PLAN

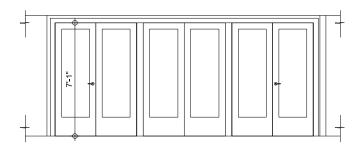


EXISTING ELEVATION

	Owner:	General Contractor:	
CARMEL REMODEL 9 th Ave. & Monteverde St., Camel, CA 92923	WILKS DIANA J. TR		Load File: Job Number: RR
Drawing Title:	Applicant:		
EXISTING EXTERIOR DOOR	ALEX SANDOVAL		л ВЕR 18, 2023 ЕТ NUN
	162 Oldstage Rd Salinas, CA 93908 E-mail: alexg9501@yahoo.com.com T: (831) 402-6419		Scale: 1/4" = 1'C Date: SHEF



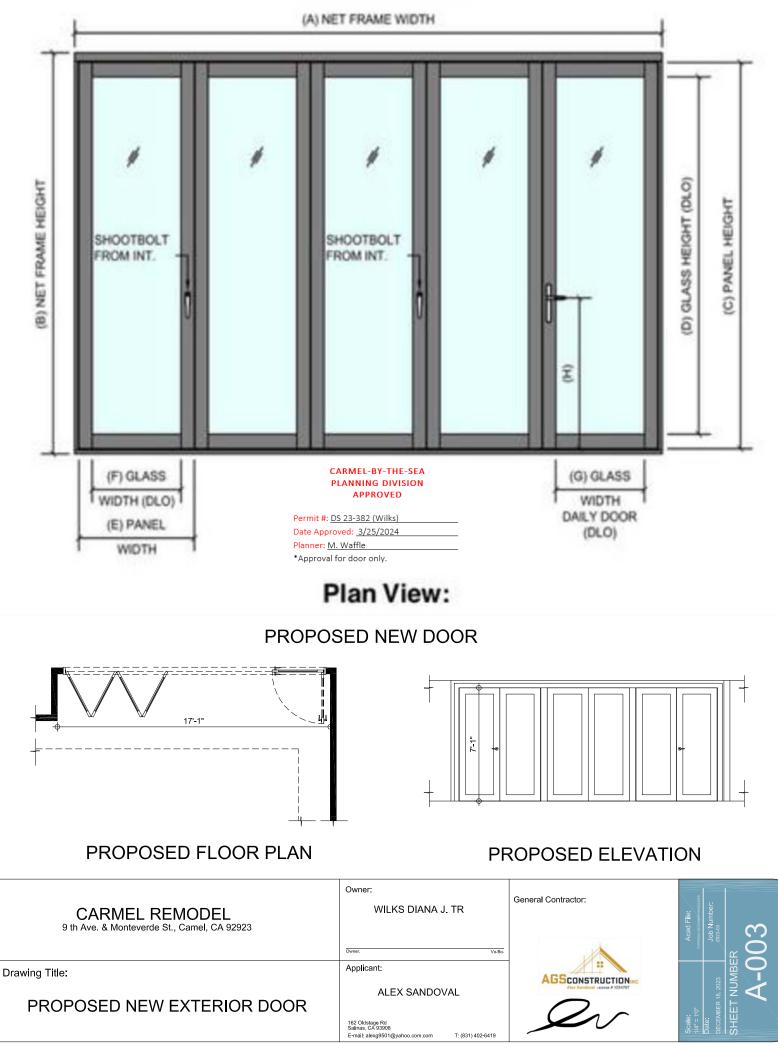




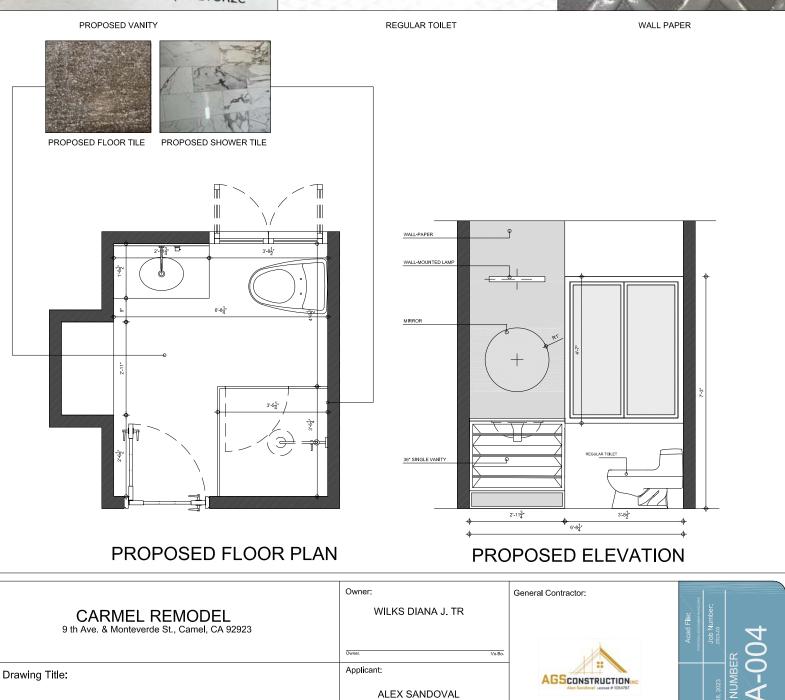

PROPOSED REMODEL BATHROOM 2


162 Oldstage Rd Salinas, CA 93908 E-mail: alexg9501@yahoo.com.com T: (831) 402-6419

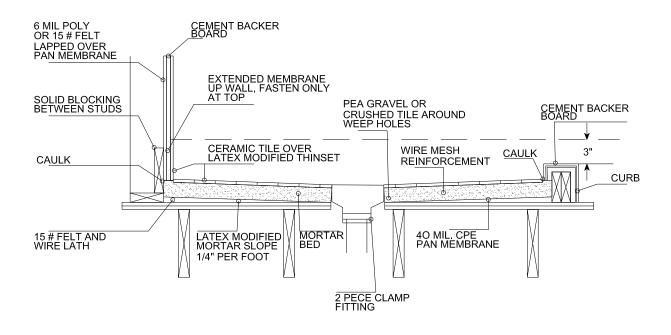

SHOWER DETAIL




PROPOSED FLOOR TILE

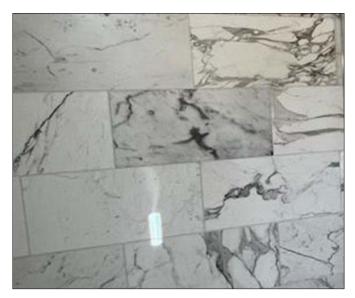


PROPOSED SHOWER TILE

CARMEL REMODEL 9 th Ave. & Monteverde St., Camel, CA 92923	Owner: WILKS DIANA J. TR	General Contractor:	Acad File: Job Number: RR
Drawing Title:	Applicant:		
POROSED REMODEL BATHROOM 2 SHOWER DETAIL	ALEX SANDOVAL		r= 10° tte: CEMBER 18, 200 HEET NU
	Salinas, CA 93908 E-mail: alexg9501@yahoo.com.com T: (831) 402-6419		S ⊒ ⊒ S

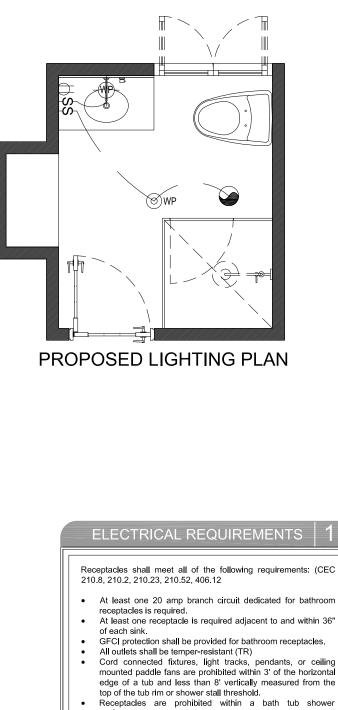

- enclosure. Light fixtures in tub or shower enclosures shall be labeled for
- damp locations (wet locations when subject to shower spray). All permanently installed luminaries shall be high efficacy. Recessed ceiling fixtures shall be IC (Insulation Contract) and AT (Air Tight)

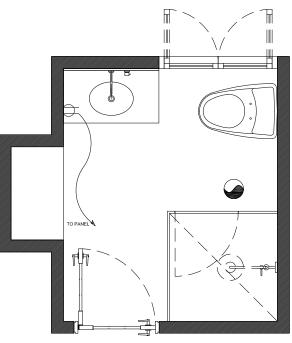


PROPOSED POWER PLAN

SYMBOLS LEGEND 2		
	LIGHT WALL Mounted / Weather proof	
() () () () () () () () () () () () () (Recessed light - LED/Insulation Contact (IC)/ Air tight (AT) rated/waterproof (WP)	
	50 CFM exhaust fan - Energy Star rated, backdraft protected, humidity controlled, exhausts to outdoors.	
\$	SINGLE POLE 20 AMP. SWITCH	
\$ 2	DOUBLE POLE 20 amp SWITCH	
\$ 3	TRIPLE WAY 20 amp. SWITCH	
	20 Amp Circuit	
	15 Amp Circuit	
110 VOLT W/BATTERY BACK-UP SMOKE DETECTOR		

	Owner:	General Contractor:	8
CARMEL REMODEL 9 th Ave. & Monteverde St., Camel, CA 92923	WILKS DIANA J. TR		Acad File: Job Number: RRR
Drawing Title:	Applicant:	AGSCONSTRUCTIONING	
POROSED REMODEL BATHROOM 2 POWER & LIGHTING	ALEX SANDOVAL 162 Oldstage Rd Salinas, CA 93008 E-mail: alexg9501@yahoo.com.com T: (831) 402-6419		Scale: 1/4" = 10° Date: Date: SHEET NUU

1

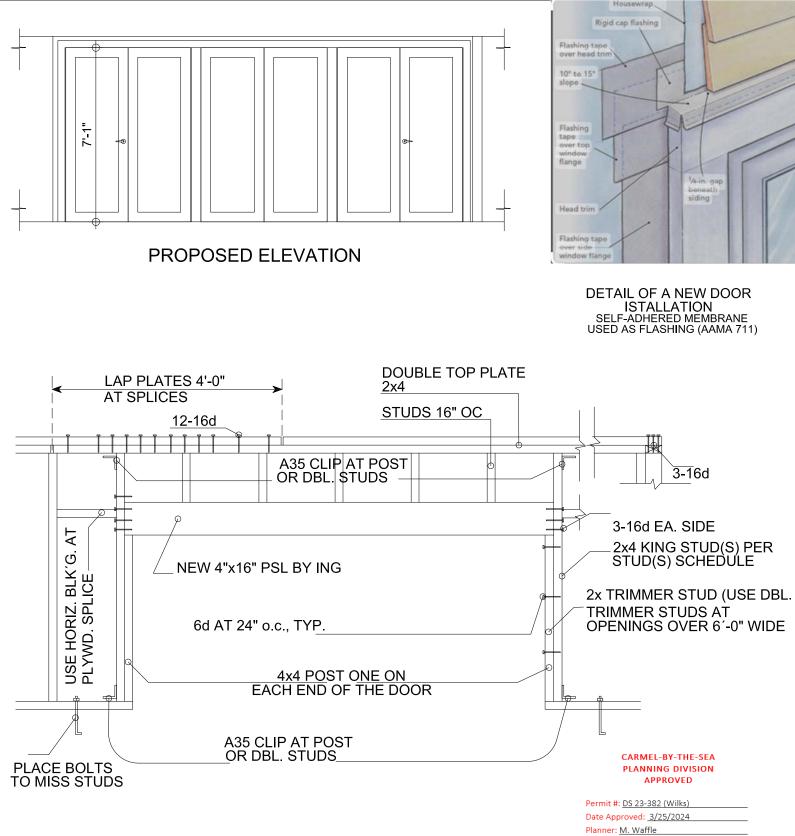

*Approval for door only.

Owner: General Contractor: WILKS DIANA J. TR CARMEL REMODEL 9 th Ave. & Monteverde St., Camel, CA 92923 Own -Applicant: Drawing Title: AGSCONSTRUCTION ALEX SANDOVAL PROPOSED NEW EXTERIOR DOOR FRAMING DETAILS 162 Oldstage Rd Salinas, CA 93908 E-mail: alexg9501@yahoo.com.com T: (831) 402-6419



Construction Projects Are Required to Implement the Stormwater Best Management Practices (BMP)

on this Page, as they Apply to Your Project, All Year Long.



material with tarps when rain is forecast or if not actively being used within 14 days. sand, dirt or other construction Berm and cover stockpiles of Non-Hazardous Materials

containers securely with tarps at the end of every work day

Cover waste disposal

Waste Management

and during wet weather.

Check waste disposal

Use (but don't overuse) reclaimed water for dust control.

containers frequently for leaks and to make sure they are not overfilled. Never hose down a

dumpster on the construction

site.

Hazardous Materials

and hazardous wastes (such as pesticides, paints, thinners, solvents, fucl, oil, and antifreeze) in accordance with Label all hazardous materials city, county, state and federal regulations.

toilets, and inspect them frequently for leaks and spills.

Clean or replace portable

Dispose of all wastes and

debris properly. Recycle

containers, store in appropriate secondary containment, and Store hazardous materials and wastes in water tight cover them at the end of

wet weather or when rain is every work day or during Follow manufacturer's forecast.

chemicals outdoors when rain careful not to use more than application instructions for hazardous materials and be is forecast within 24 hours. necessary. Do not apply □ Arrange for appropriate disposal of all hazardous

prevent further tracking. Never sediment discharges from site Sweep or vacuum any street secure sediment source to tracking immediately and and tracking off site.

hose down streets to clean up

tracking.

sufficiently control erosion and

entrances and exits to

and stabilize all construction

effective perimeter controls

Establish and maintain

EQUIPMENT MANAGEMENT & SPILL CONTROL

☐ Keep spill cleanup materials (rags, absorbents, etc.) available at the construction Spill Prevention and Control site at all times.

appropriate BMPs, for vehicle

and equipment parking and

storage.

 Perform major maintenance, repair jobs, and vehicle and equipment washing off site.

Designate an area, fitted with

Maintenance and Parking

- Inspect vehicles and equipment frequently for and repair leaks promptly. Use drip pans to catch leaks until repairs are made.
 - immediately and dispose of cleanup materials properly. Clean up spills or leaks

onsite, work in a bermed area

maintenance must be done

If refueling or vehicle

Seed or plant vegetation for erosion control on slopes or

where construction is not

immediately planned.

bonded fiber matrix) until

erosion control fabric or vegetation is established.

erosion controls (such as

- (absorbent materials, cat litter □ Do not hose down surfaces where fluids have spilled. Use dry cleanup methods
- Sweep up spilled dry materials immediately. Do not try to and/or rags).
- wash them away with water, or Clean up spills on dirt areas bury them.

streets, storm drains, or surface

waters

from paints, thinners, solvents, glues, and cleaning fluids as

hazardous waste.

Dispose of liquid residues

equipment onsite using soaps.

Do not clean vehicle or

solvents, degreasers, steam cleaning equipment, etc.

Construction Entrances and

Perimeter

rinse water to run into gutters

bermed area that will not allow

clean with water only in a

☐ If vehicle or equipment cleaning must be done onsite,

materials and wastes that can be recycled (such as asphalt, concrete, aggregate base

materials, wood, gyp board,

pipe, etc.)

dispose of fluids as hazardous over a drip pan big enough to collect fluids. Recycle or away from storm drains and

waste.

- by digging up and properly disposing of contaminated soil. releases of hazardous materials Report significant spills immediately. You are required by law to report all significant
- Transfer excavated materials to Keep excavated soil on the site dump trucks on the site, not in where it will not collect into Contaminated Soils the street. the street. emergency response number, 2) spill: 1) Dial 911 or your local Call the Governor's Office of Emergency Services Warning Center, (800) 852-7550 (24 including oil. To report a
 - conditions are observed, test for contamination and contact the If any of the following Board:
 - Regional Water Quality Control Unusual soil conditions,
 - discoloration, or odor.
- Abandoned underground tanks Abandoned wells

Buried barrels, debris, or trash

- N. N. N. EARTHWORK & CONTAMINATED SOILS
- in wet weather, or when rain is Avoid paving and seal coating forecast before fresh pavement WORK
- Cover storm drain inlets and manholes when applying seal coat, tack coat, slurry seal, fog will have time to cure.

Stabilize all denuded areas install and maintain tempor

weather only.

Schedule grading and excavation work for dry

Erosion Control

- appropriately dispose of excess abrasive gravel or sand. Do NOT sweep or wash it into seal, etc.
 - down fresh asphalt concrete pavement. gutters.

gutters, ditches, and drainage

Protect storm drain inlets,

Sediment Control

courses with appropriate BMPs, such as gravel bags.

storm drain inlets when saw cutting. Use filter fabric, catch basin inlet filters, or gravel bags to keep slurry out of the Shovel, abosorb, or vacuum storm drain system.

If sawcut slurry enters a catch all waste as soon as you are at the end of each work day finished in one location or (whichever is sooner!).

basin, clean it up immediately

applied.

□ Discontinue application of any erodible landscape material within 2 days before a forecast rain event or during wet

PAINTING & PAINT REMOVAL

DEWATERING

 Effectively manage all run-on, all runoff within the site, and all runoff that discharges from the offisite away from all disturbed areas or otherwise ensure site. Divert run-on water from

gutter, storm drain, or surface

vaters.

Never clean brushes or rinse paint containers into a street,

Painting cleanup

compliance.

□ For water-based paints, paint out brushes to the extent

trucks offsite or in a contained

area, so there is no discharge

possible. Rinse to the sanitary

sewer once you have gained

obtain approval from the local municipality before discharging water to a street gutter or storm through a basin, tank, or sediment trap may be required When dewatering, notify and drain. Filtration or diversion

> wastewater treatment authority. Never pour paint down a drain

concrete harden and dispose of

as garbage.

onto surrounding areas. Let

into the underlying soil or

Collect the wash water from

washing exposed aggregate concrete and remove it for appropriate disposal offsite

permission from the local

 For oil-based paints, paint out brushes to the extent possible

groundwater must be treated or hauled off-site for proper disposal. Consult with the Engineer to determine whether testing is required and how to interpredischarge of groundwater. contamination, testing is required prior to reuse or results. Contaminated In areas of known

solvents. Dispose of residue and

hazardous waste.

Paint Removal

solvent in a proper container. Filter and reuse thinners and unusable thinner/solvents as

and clean with thinner or





Wash out concrete equipment materials must never reach a from drainage areas. These storm drain.

Collect and recycle or

Do not use water to wash

Sawcutting & Asphalt/Concrete Removal Completely cover or barricade

controls, such as fiber rolls, silt

fences, or sediment basins.

migrating offsite by installing and maintaining sediment

Prevent sediment from

fiber rolls, berms, etc.

saw-cut slurry and dispose of

materials by storing them under tarps when they are not actively Contain stockpiled landscaping Stack erodible landscape being used.

and sand blasting may be swept up or collected in plastic drop cloths and disposed of as trash.

non-hazardous dry stripping

Department Paint chips and dust from

containing lead or tributyltin

must be disposed of as

hazardous waste.

LANDSCAPE MATERIALS

from marine paints or paints Chemical paint stripping residue and chips and dust

> store these materials when they are not actively being used or material on pallets. Cover or

STORM DRAIN POLLUTERS MAY BE LIABLE FOR FINES OF UP TO \$10,000 PER DAY!



? Millworks

3111 Golf Course Dr Ventura, CA 93003

Time/Date: 8/24/2023 11:54:20 AM

Page 1 of 5

T: 1 (800) 559-9995 F: (805) 644-4493



CUSTOMER QUOTE

Quote #: PC-7498 Dealer: Out of the Woods Dealer Sales Rep: Taylor Young

CARMEL-BY-THE-SEA

Job Details

Project Name:	Monte Verde
PO Number:	TBD
Lead Time:	Last Week of September 2023 Truck

Dealer Information

Dealer:	Out of the Woods	PLANNING DIVISION APPROVED
Name:	Taylor Young	Permit #: DS 23-382 (Wilks)
Email:	taylor.otw@gmail.com	Date Approved: <u>3/25/2024</u>
Phone:	(831) 717-4259	Planner: M. Waffle *Approval for door only.

Customer Information

Name:	TBD		
Email:	None		
Phone:	None		

Shipping Information

Ship to:DealerAddress:801 California Ave. Sand City, CA 93955



3111 Golf Course Dr Ventura, CA 93003

T: 1 (800) 559-9995 F: (805) 644-4493

Time/Date: 8/24/2023 11:54:20 AM

Quote #: PC-7498 Dealer: Out of the Woods

Dealer Sales Rep: Taylor Young

0.30

0.19

Yes

Project Name: Unit Location: Unit #:

Page 2 of 5

Monte Verde None

Α



U-Factor:

Daily Door:

SHGC:



Folds Open: Bi-fold 3 Left 1 Right (Primary Door: Right)

As Viewed From Exterior

Net Frame Width:	192 "
Net Frame Height:	86 "
Rec'd RO Width:	193"
Rec'd RO Height:	86 1/2"
Panel Width:	47 5/16"
Panel Height:	82 7/16"
Panel Thickness:	2 1/4"
Frame Weight:	144lbs
Per Panel Weight:	169lbs
Dead Load Weight:	743lbs

Product: Material: **Clad Color:** Wood Species: Wood Finish: Quantity: **Configuration:**

Stiles and Rails: Swing Direction:

Sill Type:

CARMEL-BY-THE-SEA PLANNING DIVISION APPROVED

Permit #: DS 23-382 (Wilks)	
Date Approved: <u>3/25/2024</u>	
Planner: M. Waffle	
*Approval for door only.	

Folding Door System
Clad Exterior/Wood Interior
Linen White
Paint-Grade Pine
Yes
1
3L1R (as viewed from exterior)
Euro
Outswing
Raised Sill (Rounded)

Flashing Fin: 1 1/2" Flashing Fin Setback: 1"

Measurements D - 11

Top Rail:	3-7/16"
Bottom Rail:	3-7/16"
Stiles:	3-7/16"
Lock Stile:	3-7/16"
Handle Height:	36"
Jamb Width:	5-5/8" Overall
Glass Width(DLO):	40 7/16"
Glass Height(DLO):	75 9/16"

Options

Lites:

Notes:

Handle Key:	Yes
Handle Style:	Verona
Handle Set Finish:	Satin Nickel(Resista Finish)
Shoot-bolt Finish:	Brushed Chrome
Head Track Finish:	Bronze Anodized
Sill Finish:	Bronze Anodized
Hinge Finish:	Stainless Steel
Weather Strip Color:	Bronze
Interior Stops:	Bevel
Glass Type:	LoE 366
Glass Gas:	Argon
Glass Spacer:	Mill
Primer:	Yes

Sill Dam: Unfinished 1

AG Millworks


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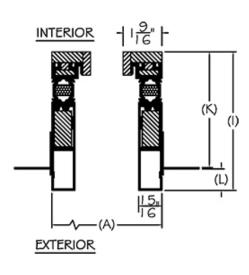
3111 Golf Course Dr Ventura, CA 93003

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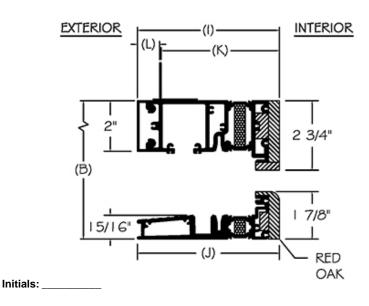
Time/Date: 8/24/2023 11:54:20 AM



Jamb Leg Section View:

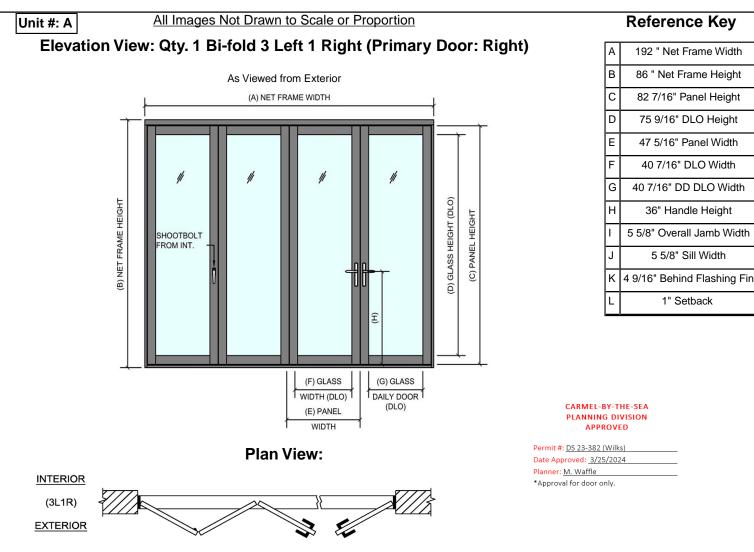

Head/Sill Section View:



CUSTOMER DRAWINGS

Quote #: PC-7498 Dealer: Out of the Woods

Dealer Sales Rep: Taylor Young