GENERAL NOTES

GOVERNING CODES ASSOCIATED WITH THIS PROJECT:

CARMEL-BY-THE-SEA MUNICIPAL CODE, 2022 CALIFORNIA RESIDENTIAL CODE (CRC), CALIFORNIA BUILDING CODE (CBC), CALIFORNIA MECHANICAL CODE (CMC), CALIFORNIA PLUMBING CODE (CPC), CALIFORNIA ELECTRICAL CODE (CEC), CALIFORNIA FIRE CODE (CFC), CALIFORNIA ENERGY CODE (CENC) CALIFORNIA GREEN BUILDING CODE (CALGREEN), AND ALL OTHER APPLICABLE LOCAL AND STATE LAWS AND REGULATIONS.

THESE DRAWINGS ARE PREPARED FOR USE BY A PROPERLY LICENSED, BONDED \$ CERTIFIED CONTRACTOR.

ALL WORK SHALL BE DONE IN ACCORDANCE WITH APPLICABLE CODE AND ORDINANCE REQUIREMENTS SET FORTH BY THE PREVAILING GOVERNING BODY.

ALL WRITTEN DIMENSIONS SHALL SUPERCEDE SCALED DIMENSIONS.

CONTRACTOR SHALL VERIFY ALL DIMENSIONS, ELEVATIONS, MATERIALS, AND CONDITIONS PRIOR TO STARTING CONSTRUCTION AND REPORT ANY DISCREPANCIES TO THE OWNER PRIOR TO ORDERING

CONTRACTOR IS RESPONSIBLE FOR COMPLETE FINAL DISPOSAL OF ALL CONSTRUCTION DEBRIS IN A MANNER CONSISTENT WITH ALL APPLICABLE FEDERAL, STATE AND LOCAL LAWS.

VERIFY LOCATION OF UTILITIES AND EXISTING CONDITIONS AT THE SITE PRIOR TO CONSTRUCTION.

CONTRACTOR TO OBTAIN 811 TICKET PRIOR TO PERMIT ISSUANCE AND SHALL MAINTAIN THE TICKET IN ACTIVE STATUS THROUGH OUT THE PROJECT. TICKET SHALL BE AVAILABLE FOR INSPECTOR ON SITE.

SETBACK \$ HEIGHT CERTIFICATIONS


A STATE LICENSED SURVEYOR SHALL SURVEY AND CERTIFY THE FOLLOWING IN WRITING:

- THE FOOTING LOCATIONS FOR CONFORMANCE WITH THE APPROVED PLANS PRIOR TO FOOTING/FOUNDATION INSPECTION
- THE ROOF HEIGHT FOR CONFORMANCE WITH THE APPROVED PLANS PRIOR TO ROOF SHEATHING INSPECTION
- WRITTEN CERTIFICATIONS PREPARED, SEALED \$ SIGNED BY THE SURVEYOR SHALL BE PROVIDED TO THE BUILDING INSPECTIONS AT THE TIME OF SPECIFIED INSPECTIONS

PHASE I ARCHAEOLOGICAL INVESTIGATION TOOK PLACE JULY 13, 2022. AN ARCHAEOLOGICAL RECONNAISSANCE SURVEY WAS UNDERTAKEN AT THE PROPERTY AND THERE WAS NO EVIDENCE OF ANY PREHISTORIC OR HISTORIC ARCHAEOLOGICAL RESOURCES PRESENT. THERE WERE NO CONSTRAINTS WHEN CONDUCTING THIS INVESTIGATION.

- THE FOLLOWING RECOMMENDATIONS SHALL BE OBSERVED DURING CONSTRUCTION: - CONDUCTING ARCHAEOLOGICAL AND CULTURAL SENSITIVITY TRAINING
- PROVIDING NATIVE AMERICAN AND ARCHAEOLOGIST MONITORS DURING GROUND DISTURBING
- TEMPORARILY HALT OR DIVERT EXCAVATIONS SHOULD ARCHAEOLOGICAL RESOURCES BE FOUND DURING GROUND DISTURBING ACTIVITIES; AND CONTACTING THE MONTEREY COUNTY CORONER SHOULD HUMAN REMAINS BE ACCIDENTALLY DISCOVERED.

SYMBOL KEY

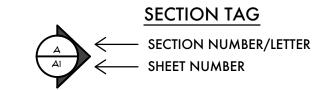





ABBREVIATIONS

A.B.	ANCHOR BOLT	F.O.C.	FACE OF CONCRETE	O.F.S.	OUTSIDE FACE OF STUD		
A.C.	ASPHALTIC CONCRETE	F.O.S.	FACE OF STUD	OPP.	OPPOSITE	U.N.O.	UNLESS NOTED OTHERWISE
A/C	AIR CONDITIONING	FR. DR.	FRENCH DOOR	O.A.	OUTSIDE DIAMETER		
ALUM.ALU	MINUM	FT.	FOOT OR FEET			VERT.	VERTICAL
APPROX.	APPROXIMATE	FTG.	FOOTING	የ	PLATE		
	HITECTURAL			P/L	PROPERTY	W/	WITH
ANOD.	ANODIZED	GA	GAUGE	PLAS.	PLASTER	WAINS	WAINSCOT
ASPH.	ASPHALT	GALV.	GALVANIZED	PLY.	PLYWOOD	WC	WATER CLOSET
A0111.	AUTIALI	G.I.	GALVANIZED IRON	PNL.	PANEL	WD	WOOD
BD.	BOARD	GFI	GROUND FAULT INTERRUPTER	P & S	POLE & SHELF	WDW	WINDOW
BLDG.	BUILDING	GL	GLASS	PT.	POINT	W/O	WITH OUT
BLKG.	BLOCKING	GND.	GROUND			•	
				PR.	PAIR	WP	WATERPROOF
BM.	BEAM	GYP. BD.	GYPSUM BOARD			WWP	WELDED WIRE FABRIC
BOTT.	BOTTOM			R.A.	RETURN AIR		
		H.C.	HOLLOW CORE	RAD.	RADIUS		
CAB.	CABINET	H.D.	HOLD DOWN	RD.	ROUND		
CEM.	CEMENT	HDR.	HEADER	REC.	RECESSED		
C.T.	CERAMIC TILE	HDWD.	HARDWOOD	REF.	REFRIGERATOR		
C.I.	CAST IRON	HORIZ.	HORIZONTAL	RENF.	REINFORCED/ING		
CLR.	CLEAR	HR.	HOUR	RES.	RESILIENT		
CLST.	CLOSET	H.B.	HOSE BIBB	RM.	ROOM		
COMP.	COMPOSITION	HT.	HEIGHT	R.O.	ROUGH OPENING		
CONC.	CONCRETE	HC.	HANDICAP	REQ.	REQUIRED		
CLG.	CEILING	HVAC	HEATING VENTILATION &	R/W	RIGHT OF WAY		
C.M.U.	CONCRETE MASONRY UNIT		AIR CONDITIONING	RWD.	REDWOOD		
C.O.	CLEAN OUT	HW	HOT WATER	R.W.L.	RAINWATER LEADER		
COL.	COLUMN	11111	HOT WATER	K. W.L.	KAII1WAIEK LEADEK		
CONN.	CONNECTION	I.D.	INSIDE DIAMETER	SCHED.	SCHEDULE		
		INS.	INSULATION				
CONST.	CONSTRUCTION			S.C.	SOLID CORE		
CSMT.	CASEMENT	INT.	INTERIOR	SECT.	SECTION		
C.W.	COLD WATER			S.F.	SQUARE FOOT/FEET		
		J.B.	JUNCTION BOX	SH	SINGLE HUNG		
DBL.	DOUBLE	JST.	JOIST	SHT.	SHEET		
DET.	DETAIL			SHWR.	SHOWER		
DF.	DOUGLAS FIR	KIT.	KITCHEN	SIM.	SIMILAR		
DIA. OR Ø	DIAMETER	KP	KICKER POST	SLD	SLIDER		
DIM.	DIMENSION	KS	KING STUD	SLD. GL. DR.	. SLIDING GLASS DOOR		
D.S.	DOWNSPOUT			SPECS.	SPECIFICATIONS		
DRY	DRYER	LAV	LAVATORIES	SQ.	SQUARE		
DW	DISHWASHER	LIN.	LINEN	SQ.FT.	SQUARE FEET		
DWG	DRAWING	LT.	LIGHT	STD.	STANDARD		
				STL.	STEEL		
EA.	EACH	MAT.	MATERIAL	STOR.	STORAGE		
ELEC.	ELECTRICAL	MAX.	MAXIMUM	STRUCT.	STRUCTURAL		
ELEV.	ELEVATION	M.B.	MACHINE BOLT	SS STRUCT.	STAINLESS STEEL		
		MECH.	MECHANICAL				
ENCL.	ENCLOSURE			SYM.	SYMMETRICAL		
EQ	EQUAL	M.A.	MEDICINE CABINET	TD	TOWEL DAD		
EXH.	EXHAUST	MFR.	MANUFACTURER	TB	TOWEL BAR		
EXP.	EXPANSION	MIN.	MINIMUM	TEL.	TELEPHONE		
EXIST. OR (I		MISC.	MISCELLANEOUS	TEMP.	TEMPERED		
EXT.	EXTERIOR	MTD.	MOUNTED	THRSH.	THRESHOLD		
				T&G	TONGUE & GROOVE		
FBRGL.	FIBERGLASS	(N)	NEW	T.O.F.	TOP OF FOOTING		
FD	FLOOR DRAIN	N.I.C.	NOT N CONTRACT	T.O.	TOP OF		
FND.	FOUNDATION	NO. OR #	NUMBER	T.O.P.	TOP OF PLATE		
F.F.	FINISH FLOOR	N.T.S.	NOT TO SCALE	T.O.S.	TOP OF SLAB		
F.G.	FINISH GRADE			T.O.W.	TOP OF WALL		
FLR.	FLOOR	0/	OVER	TP	TOILET PAPER		
FL.	FLUORESCENT	O.C.	ON CENTER	TYP.	TYPICAL		

VICINITY MAP

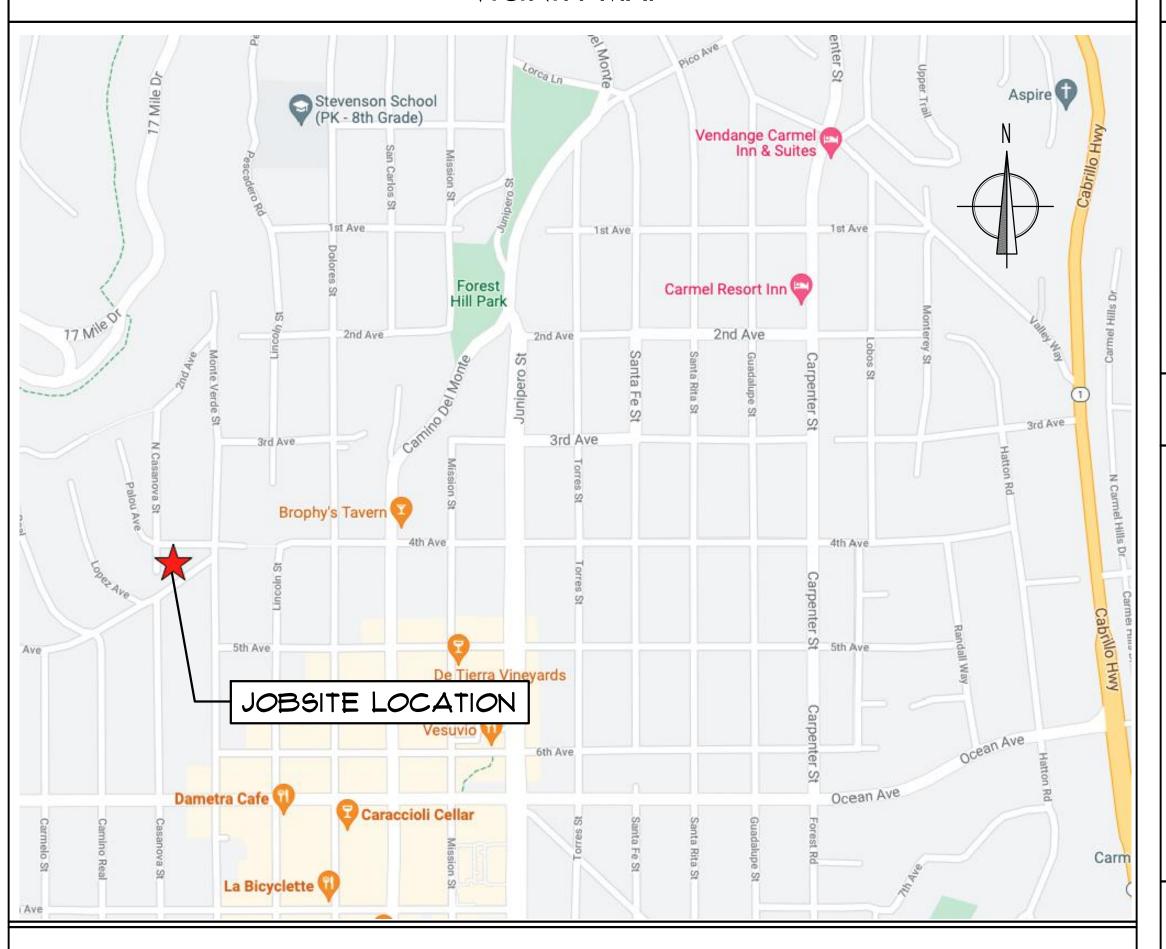

APN MAP

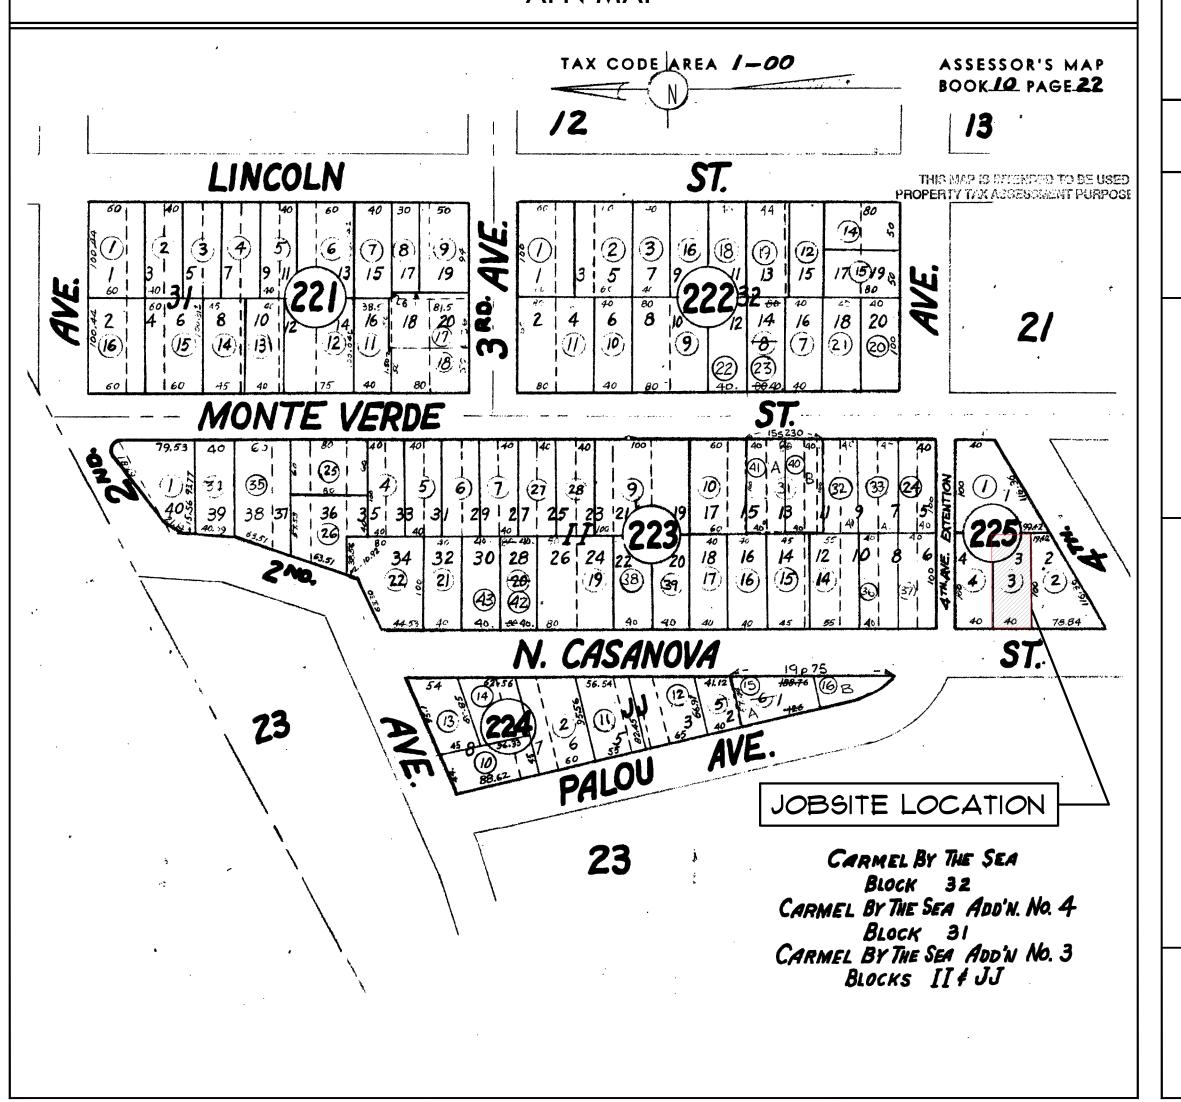

PROJECT CONTACTS

OWNER:

SURVEYOR: **Christopher Stout** L &S Engineering and Surveying, Inc.

Ms. Li Lim N. Casanova 2 SE of Palou

Carnel-by-the-Sea, CA 93923 408-390-0445

Monterey, CA 93940 831-655-2723

2460 Garden Road, Suite G

ARCHAEOLOGIST

Kaitlin Ruppert, RPA

liyoongl@sbcglobal.net chris@landsengineers.com

RESIDENTIAL DESIGNER: Angie Phares Hastings Construction, Inc.

EMC Planning Group 11 Thomas Owens Way, Ste. 201 601 Abrego Street Monterey, CA 93940 Monterey, CA 93940 831-620-0920 x706 831-649-1799 x214 design@hastingsconstruction.com ruppert@emcplanning.com

DRAWING INDEX

Title Sheet

Topographic Survey

Tree Assessment Survey

Tree Site Plan

ARCHITECTURAL

Proposed Roof & Site Plans

Existing Floor Plan

Proposed Entry Level Floor Plan

Proposed Upper Level Floor Plan

Existing Exterior Elevations

Proposed Exterior Elevations Exterior Finishes & Light Specifications

Architectural Details

Skylight Details & Specifications

A10 Door & Window Schedules

3D Rendering A11

A12 Streetscape Elevations

SCOPE OF WORK

Demolition of an existing single story family residence and detached garage. Construction of a new two story, single family residence with attached garage and new paver driveway, removal of 1 tree. Landscaping to be natural. Fencing along perimeters to remain.

PROJECT DATA TABLE

LOT DATA: Project Address: N. Casanova 2 SE Palou, Carmel-By-The-Sea, CA 010-225-003-000 Zoning:

Construction Type: VB

Fire Sprinklers: Yes (Deferred Submittal)

<u>AREAS</u>

0.08004 ACRES (4,000 sq. ft.) Existing Floor Area (Demo): Living Floor Area 848 SF

205 SF 1,053 SF

1,079 SF **Building Footprint:**

<u>Proposed Floor Area:</u> Entry Level Floor Area: Upper Level Floor Area: Garage & Mech Area:

Building Footprint:

Allowed:

1,793 SF Base Floor Area: (Allowed: 1,800 SF) 1,319 SF

474 SF

288 SF

SITE COVERAGES Existing Site Coverage Totals (Demo).

Permeable Coverage: Impervious Coverage:

Proposed Site Coverage 🛕 Impervious:
Concrete:

Garage Area:

Base Floor Area:

Total Impervious:

<u>Permeable:</u> 63 SF Driveway:

Total Permeable:

393 SF (Allowed: 396 SF) Total Site Coverage:

TREE REMOVAL

One (1) Tree to be Removed: • Tree #14 on the Tree Survey Report; species "Unknown" **SETBACKS**

Sides: 10' Composite Front: 15' (25% lot width, min. 3') Rear: 15'

North Sides: 13', 2'-9", 4'-4" Front: 18'-2" Rear: 7'-8" South Sides: 17'-2", 15'-4", 6'-11"

Proposed: 4 North Sides (varies): 5'-7", 4'-10" Front: 31'-3" South Sides (varies): 4-6", 10'-2"

1 Story Plate: 12'

2 Story Plate: 18'


<u>HEIGHT</u>

Allowed: 1 Story Ridge: 18' 2 Story Ridge: 24'

1 Story Plate: 6'-6" +/-, 6'-9" +/-2 Story Plate: N/A 2 Story Ridge: N/A

Proposed:
1 Story Ridge: 12'-4" +/- 1 Story Plate: 8'-1", 9'-1" 2 Story Ridge: 20'-7" +/- 2 Story Plate: 7'-4"

/\ PSA 22-058 (LIM) DS 22-051 (LIM)
COMMENTS D9 22-051 (LIM) HEARING DS 22-057 (LIM) HEARING 8/14/24

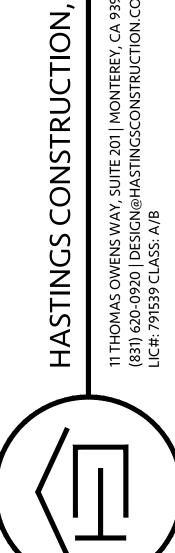

3923 CARMEL-BY-THE-SEA, AVE., SE O 7 ک ST.

TITLE SHEET Project: HC21007 Date: 9/17/2024 Drawn By: AAP Scale:



CASANOVA N: 010-225-00

TREE ASSESSMENT SURVEY

Significant Tree Evaluation Worksheet APN: 010-225-003-000 Street Location: Casanova 2 SE of Palou Planner: Evan Kort

City Forester: Sara Davis Property Owner: Lim Recommended Tree Density: 3 upper and 1 lower

Part One: Initial Screening:

Complete Part One to determine if further assessment is warranted. Trees must pass all criteria in Part One to be considered significant or moderately significant. A. Does the tree pose an above-normal potential risk to life and property?

711 <u>DOCS</u>	tile ti	cc po	JC GII	GDOVC	1101111	ai pote	inciai i	1510 00	inc an	a prop	city.				
Tree #	1	2	3	4	5	6	7	8	9	10	11	12	13	14	15
YES															
NO	Χ	Χ	Χ	Χ	Χ	Χ	Χ	Χ	Χ	Χ	Χ	Χ	Χ	Χ	

Any tree with structural impairment likely to cause failure should be marked as unsafe and removed. Use page five of this worksheet to document the safety risk. Trees that have limited and specific defects that can be remedied with selective pruning or other mitigation should be marked as safe and specific recommendations should be given to the owner for tree care. Such trees may still be assessed for significance.

Tree # 1 2 3 4 5 6 7 8 9 10 11 12 13 14 15

CI -- Catalina ironwood CS -- California sycamore BL -- big leaf maple OT -- other (Note: Other species on the recommended tree list may be determined to be Significant Trees only if they are exceptional examples of the species. Such trees also must exhibit excellent health, form, vigor, and substantial size to rate an overall score of at least 7 points in Part Two of the

C. <u>Does the tree meet the minimum size criteria for significance?</u> Tree # 1 2 3 4 5 6 7 8 9 10 11 12 13 14 15 YES 40 8 8 8 8 8 8 8 8 36 18 6 20

Monterey pine, Monterey cypress, Bishop pine, Coast redwood: 6" DBH

Coast live oak – single trunk tree: 6" DBH Coast live oak – multi-trunk tree measured per industry standard: 6" DBH

California sycamore, Big leaf maple, Catalina ironwood, other: 10" DBH dbh = diameter at breast height or 4.5 feet above the adjacent ground surface Part Two: Assessment For Tree Significance

For each of the criteria below assign points as shown to assess the tree. If any criteria score is zero the assessment may stop as the tree cannot qualify as significant or moderately significant.

D. What is the health and condition of the tree? Tree # 1 2 3 4 5 6 7 8 9 10 11 12 13 14 15 score 2 2 2 2 2 2 2 2 2 2 1

10 points: The tree is heavily infested with pests or has advanced signs of disease that indicates the tree is declining and has very limited life expectancy.

The tree shows some pests or disease that impair its condition, but which does not immediately threaten the health of the tree. The 1 point: The tree shows some pests or disease that impair its condition, but tree may recover on its own, or with appropriate intervention.

2 points: The tree appears healthy and in good condition. 3 points: The tree shows excellent health, is free of pests and disease and is in very strong condition.

Tree # 1 2 3 4 5 6 7 8 9 10 11 12 13 14 15

Prior pruning, disease or growth habit have left the tree deformed or unsound to an extent that it cannot 0 points: recover or will never be a visual asset to the neighborhood or will likely deteriorate into a structural hazard. The tree has poor form or structure but (a) can recover with proper maintenance or (b) it provides visual

2 points:

form and structure.

The tree exhibits excellent form and structure. For all species there will be a good distribution of foliage on the tree exhibits excellent form and structure. For all species there will have a single straight leader with balanced

1 point: interest in its current form, and does not have structural defects that are likely to develop into a safety

branching and with good taper. Oaks will exhibit a well-developed canopy with no suppressed branches. Oaks may be single-trunked or multi-trunked and will have a balanced distribution of foliage on each

F. Wh	at is tl	ne age	e and	vigor	of the	tree	-								
Tree #	1	2	3	4	5	6	7	8	9	10	11	12	13	14	15
score	1		2	2	2	2	2	2	2	2	1	2	2	2	

The tree is over-mature or shows signs of poor or declining vigor such as die-back of major limbs or of the points: crown, small leaves/needles and/or minimal new growth.

The tree is mature but retains normal vigor and is likely to continue as a forest asset for a substantial period 1 points: The tree is mature out retains normal vigor.

2 points: The tree is young to middle age and shows normal vigor.

3 points: The tree is young to middle age and shows exceptional vigor.

G. Are environmental conditions favorable to the tree? Tree # | 1 | 2 | 3 | 4 | 5 | 6 | 7 | 8 | 9 | 10 | 11 | 12 | 13 | 14 | 15

The tree is crowded or has no room for growth to maturity. The tree has poor access to light, air

or has poor soil for the species.

The tree has average environmental conditions including room for growth to maturity, access to The tree has average environmental light, air and soils suitable for the species.

The tree has room for growth to maturity with no crowding from other significant trees or

Part Three: Final Assessment

Tree #	1	2	3	4	5	6	7	8	9	10	11	12	13	14	15
Total Score	6		7	7	7	7	7	7	7	7	6	7	7	6	
Jeore															
A. <u>Did</u>	all ass	sessm	ent c	ategor	ies in	Part ⁻	Two a	chieve	e a mi	nimur	n scoi	e of 1	poin	<u>t</u> ?	

root development.

NO X B. Are there any other factors that would disqualify a tree from a determination of significance?

YES X X X X X X X X X X X X X X

(Explain any 'yes' answer)

Conclusion: Does The Tree Qualify As Significant Or Moderately Significant? If the tree meets the species, size and safety criteria identified in Part One and scores at least one point under each of the criteria in Part Two, it shall be classified as Significant if it achieves a score of 6 or more points or shall be classified as Moderately Significant if it achieves a score of 4 or 5 points. Tree species not listed in Part One-B that meet other screening criteria in Part One may be classified by the City Forester as Significant if they score at least 7 points, or as Moderately Significant if they score at least 4 points. All other trees are classified as non-significant.

other tre	cs are	CIGOSIII			,cai										
Tree #	1	2	3	4	5	6	7	8	9	10	11	12	13	14	15
SIGNIF	Χ		Χ	Χ	Х	Χ	Х	Х	Х	Х	Х	Χ	Х	Х	
MOD															
SIGNIF															
NOT		v													
SIGNIF		_ ^						l		l		l			

Items to note: The pruning of neighbors' trees is not permitted without the property owners permission. Eradicate all ivy. Stop pruning the trees into squares. Remove high stumps in the public right of way.

Tree # 1 2 3 4 5 6 7 8 9 10 11 12 13 14 15 Feet 20 0 6 6 6 6 6 6 6 6 18 9 3 10

Required Tree Protection Zone Tree # 1 2 3 4 5 6 7 8 9 10 11 12 13 14 15 **YES** 60 0 18 18 18 18 18 18 18 18 18 54 27 9 30

Requirements for tree preservation shall adhere to the following tree protection measures on construction

Prior to grading, excavation, or construction, the developer shall clearly tag or mark all trees to be

Excavation within 6 feet of a tree trunk is not permitted.

No attachments or wires of any kind, other than those of a protective nature shall be attached to any


• Per Municipal Code Chapter 17.48.110 no material may be stored within the dripline of a protected tree to include the drip lines of trees on neighboring parcels.

 Tree Protection Zone -- The Tree Protection Zone shall be equal to dripline or 18 inches radially from the tree for every one inch of trunk diameter at 4.5 feet above the soil line, whichever is greater. Minimum of 4 foot high transparent fencing is required unless otherwise approved by the City Forester. Tree protection shall not be resized, modified, removed, or altered in any manner without written approval. The fencing must be maintained upright and taught for the duration of the project. No more than 4 inches of wood mulch shall installed within the Tree Protection Zone. When the Tree Protection Zone is at or within the drip line, no less than 6 inches of wood mulch shall be installed 18 inches radially from the tree for every one inch of trunk diameter at 4.5 feet above the soil line outside of fencing.


• The Structural Root Zone -- Structural Root Zone shall by 6 feet from the trunk or 6 inches radially from the tree for every one inch of trunk diameter at 4.5' above the soil line, whichever is greater. Any excavation or changes to the grade shall be approved by the City Forester prior to work. Excavation within the Structural Root Zone shall be performed with pneumatic excavator, hydrovac at low pressure, or other method that does not sever roots.

• If roots greater than 2 inches in diameter or larger are encountered within the approved Structural Root Zone the City Forester shall be contacted for approval to make any root cuts or alterations to structures to prevent roots from being damaged.

• If roots larger than 2 inches in diameter are cut without prior City Forester approval or any significant tree is endangered as a result of construction activity, the building permit will be suspended and all work stopped until an investigation by the City Forester has been completed and mitigation measures have been

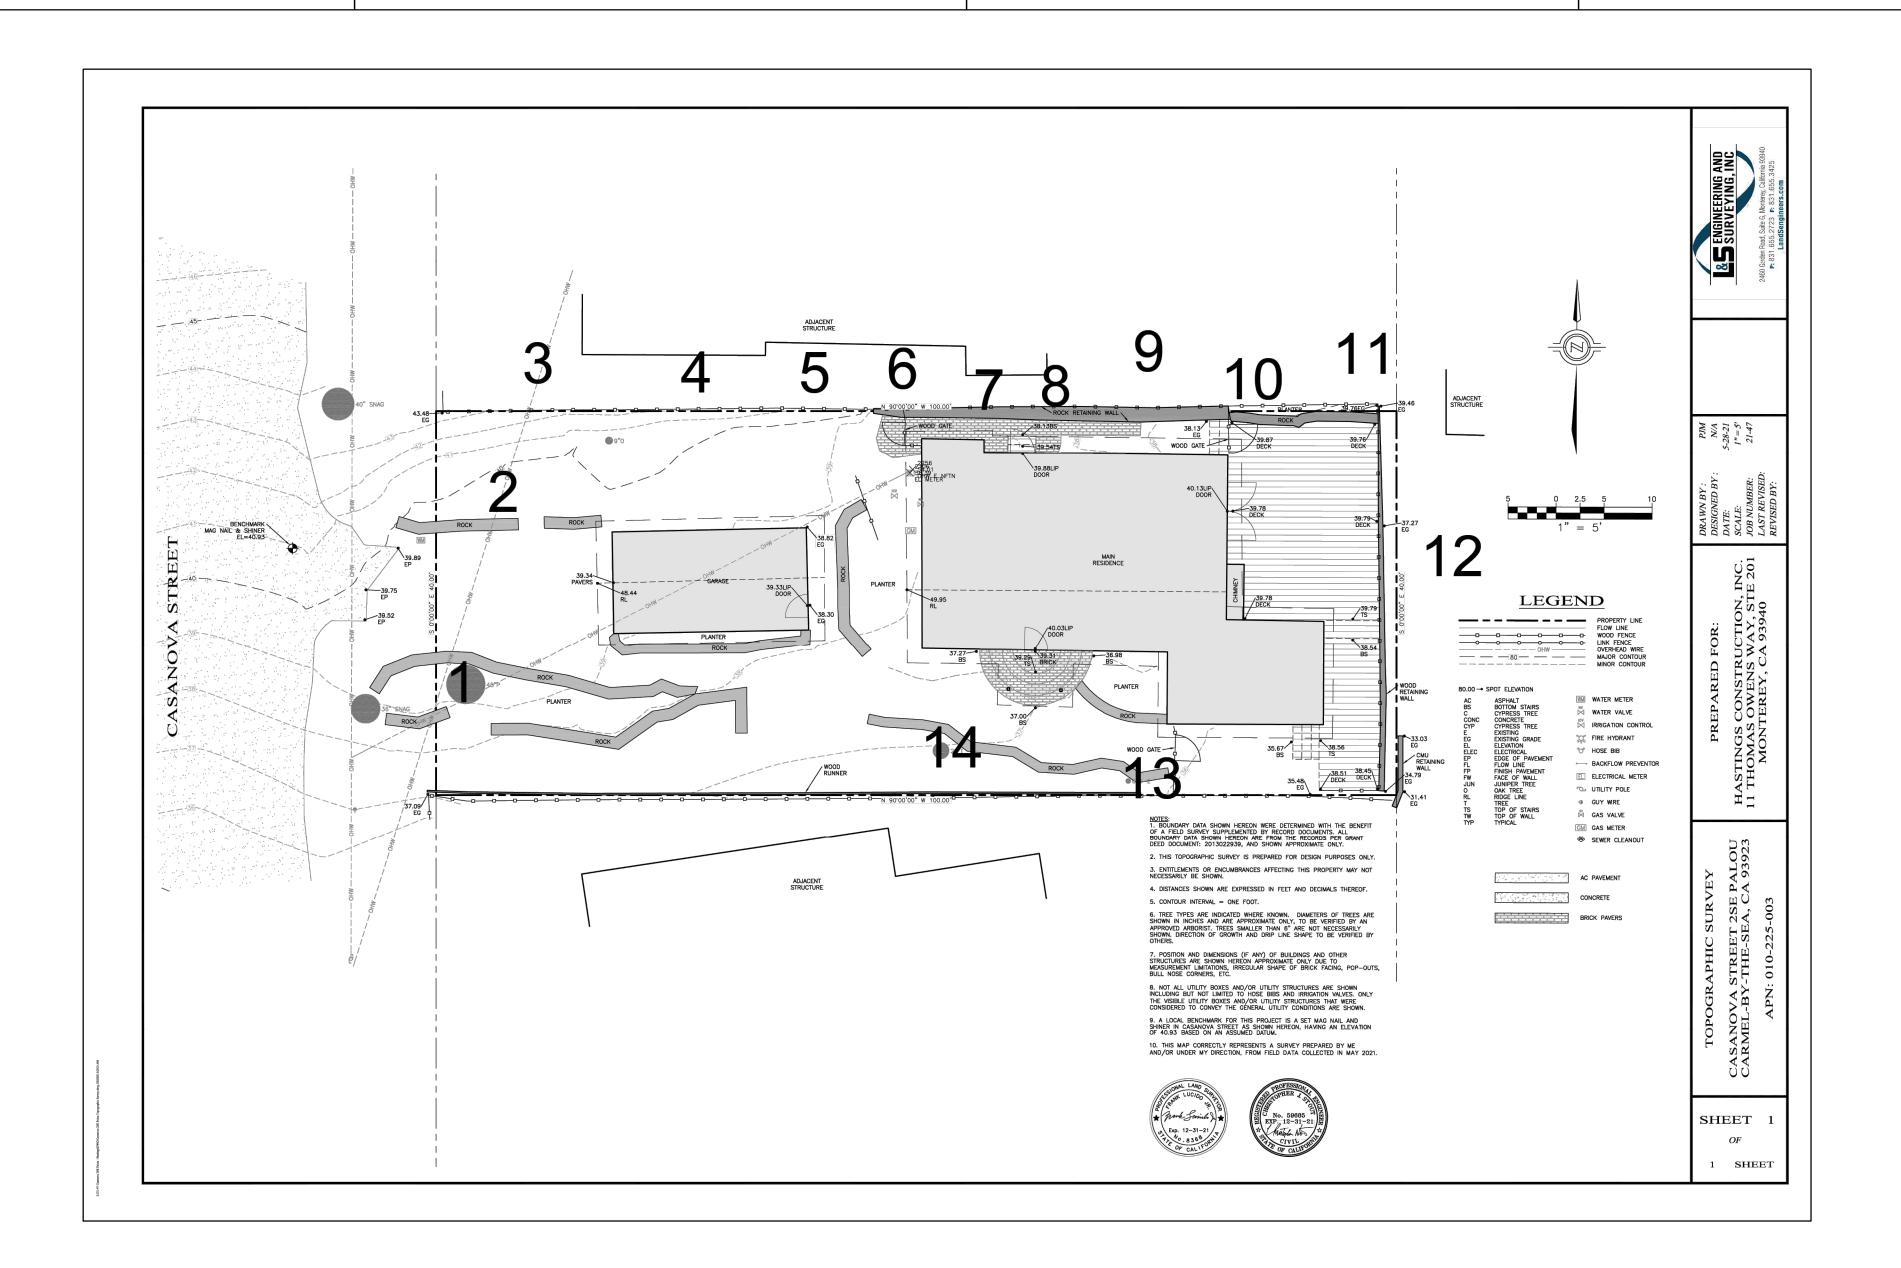

Revision/Issue

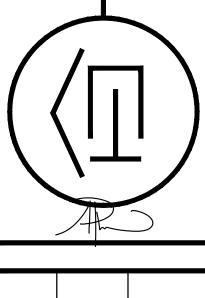



9392


HC21007 9/17/2024


Scale:



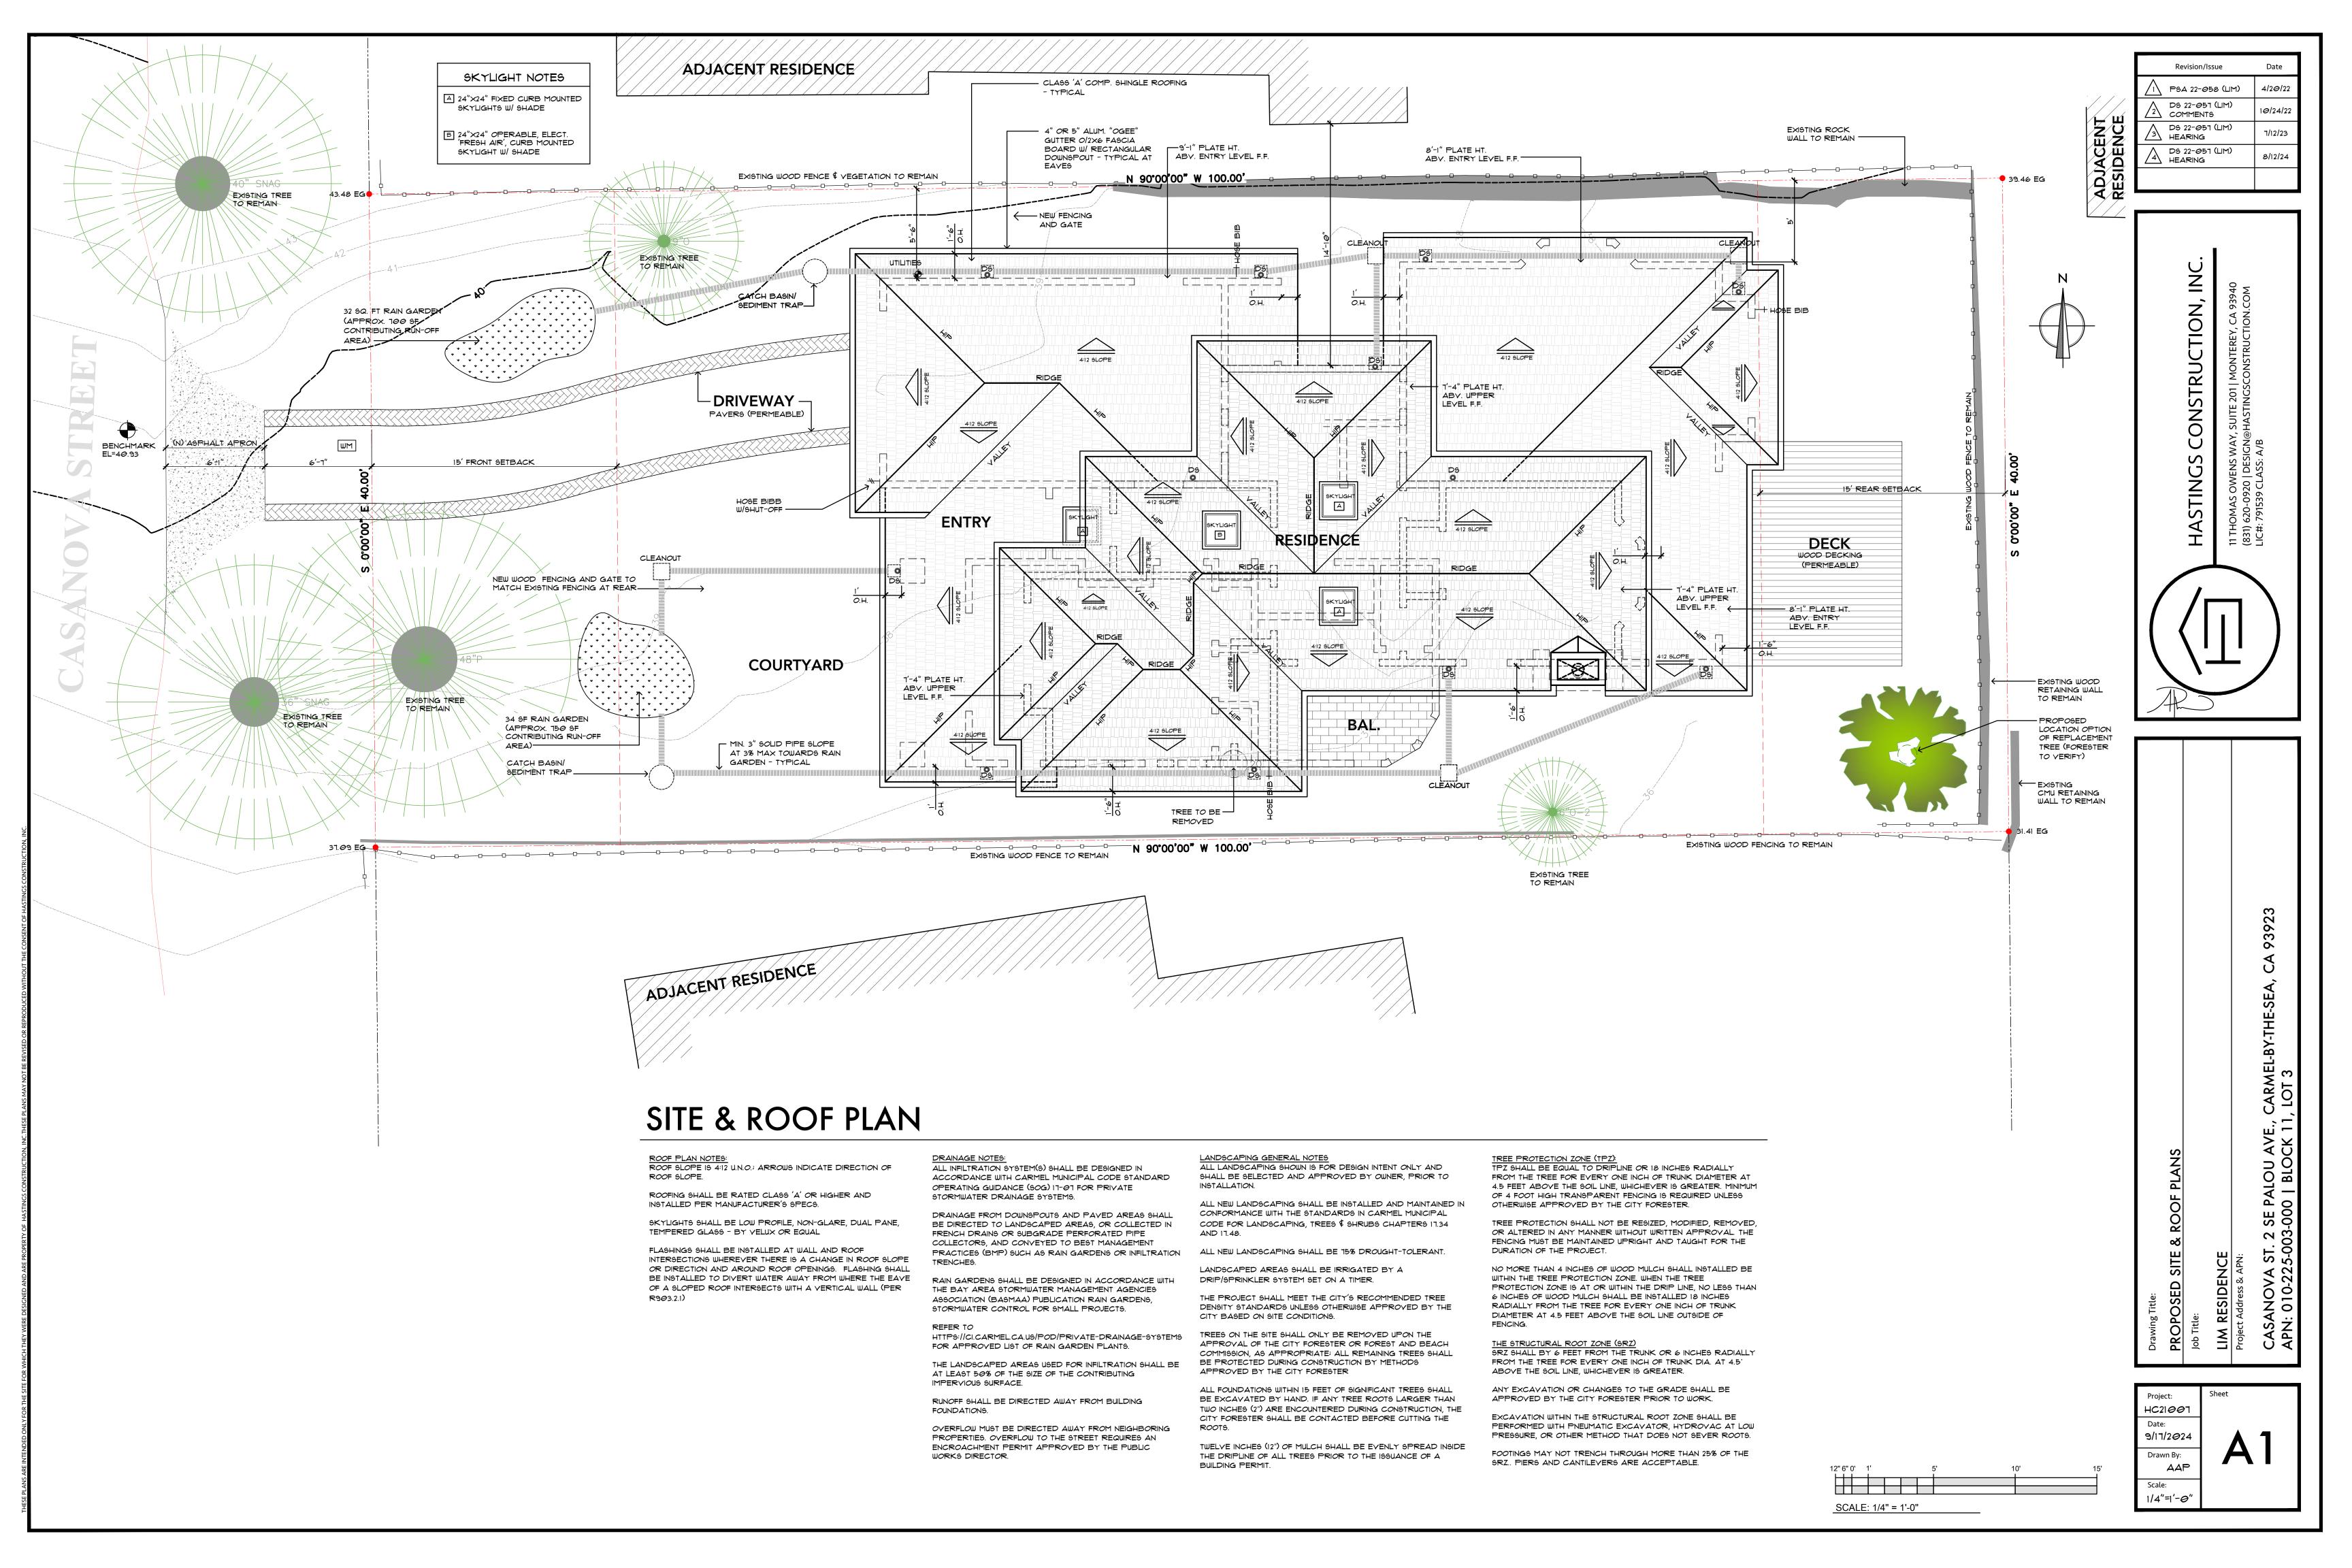

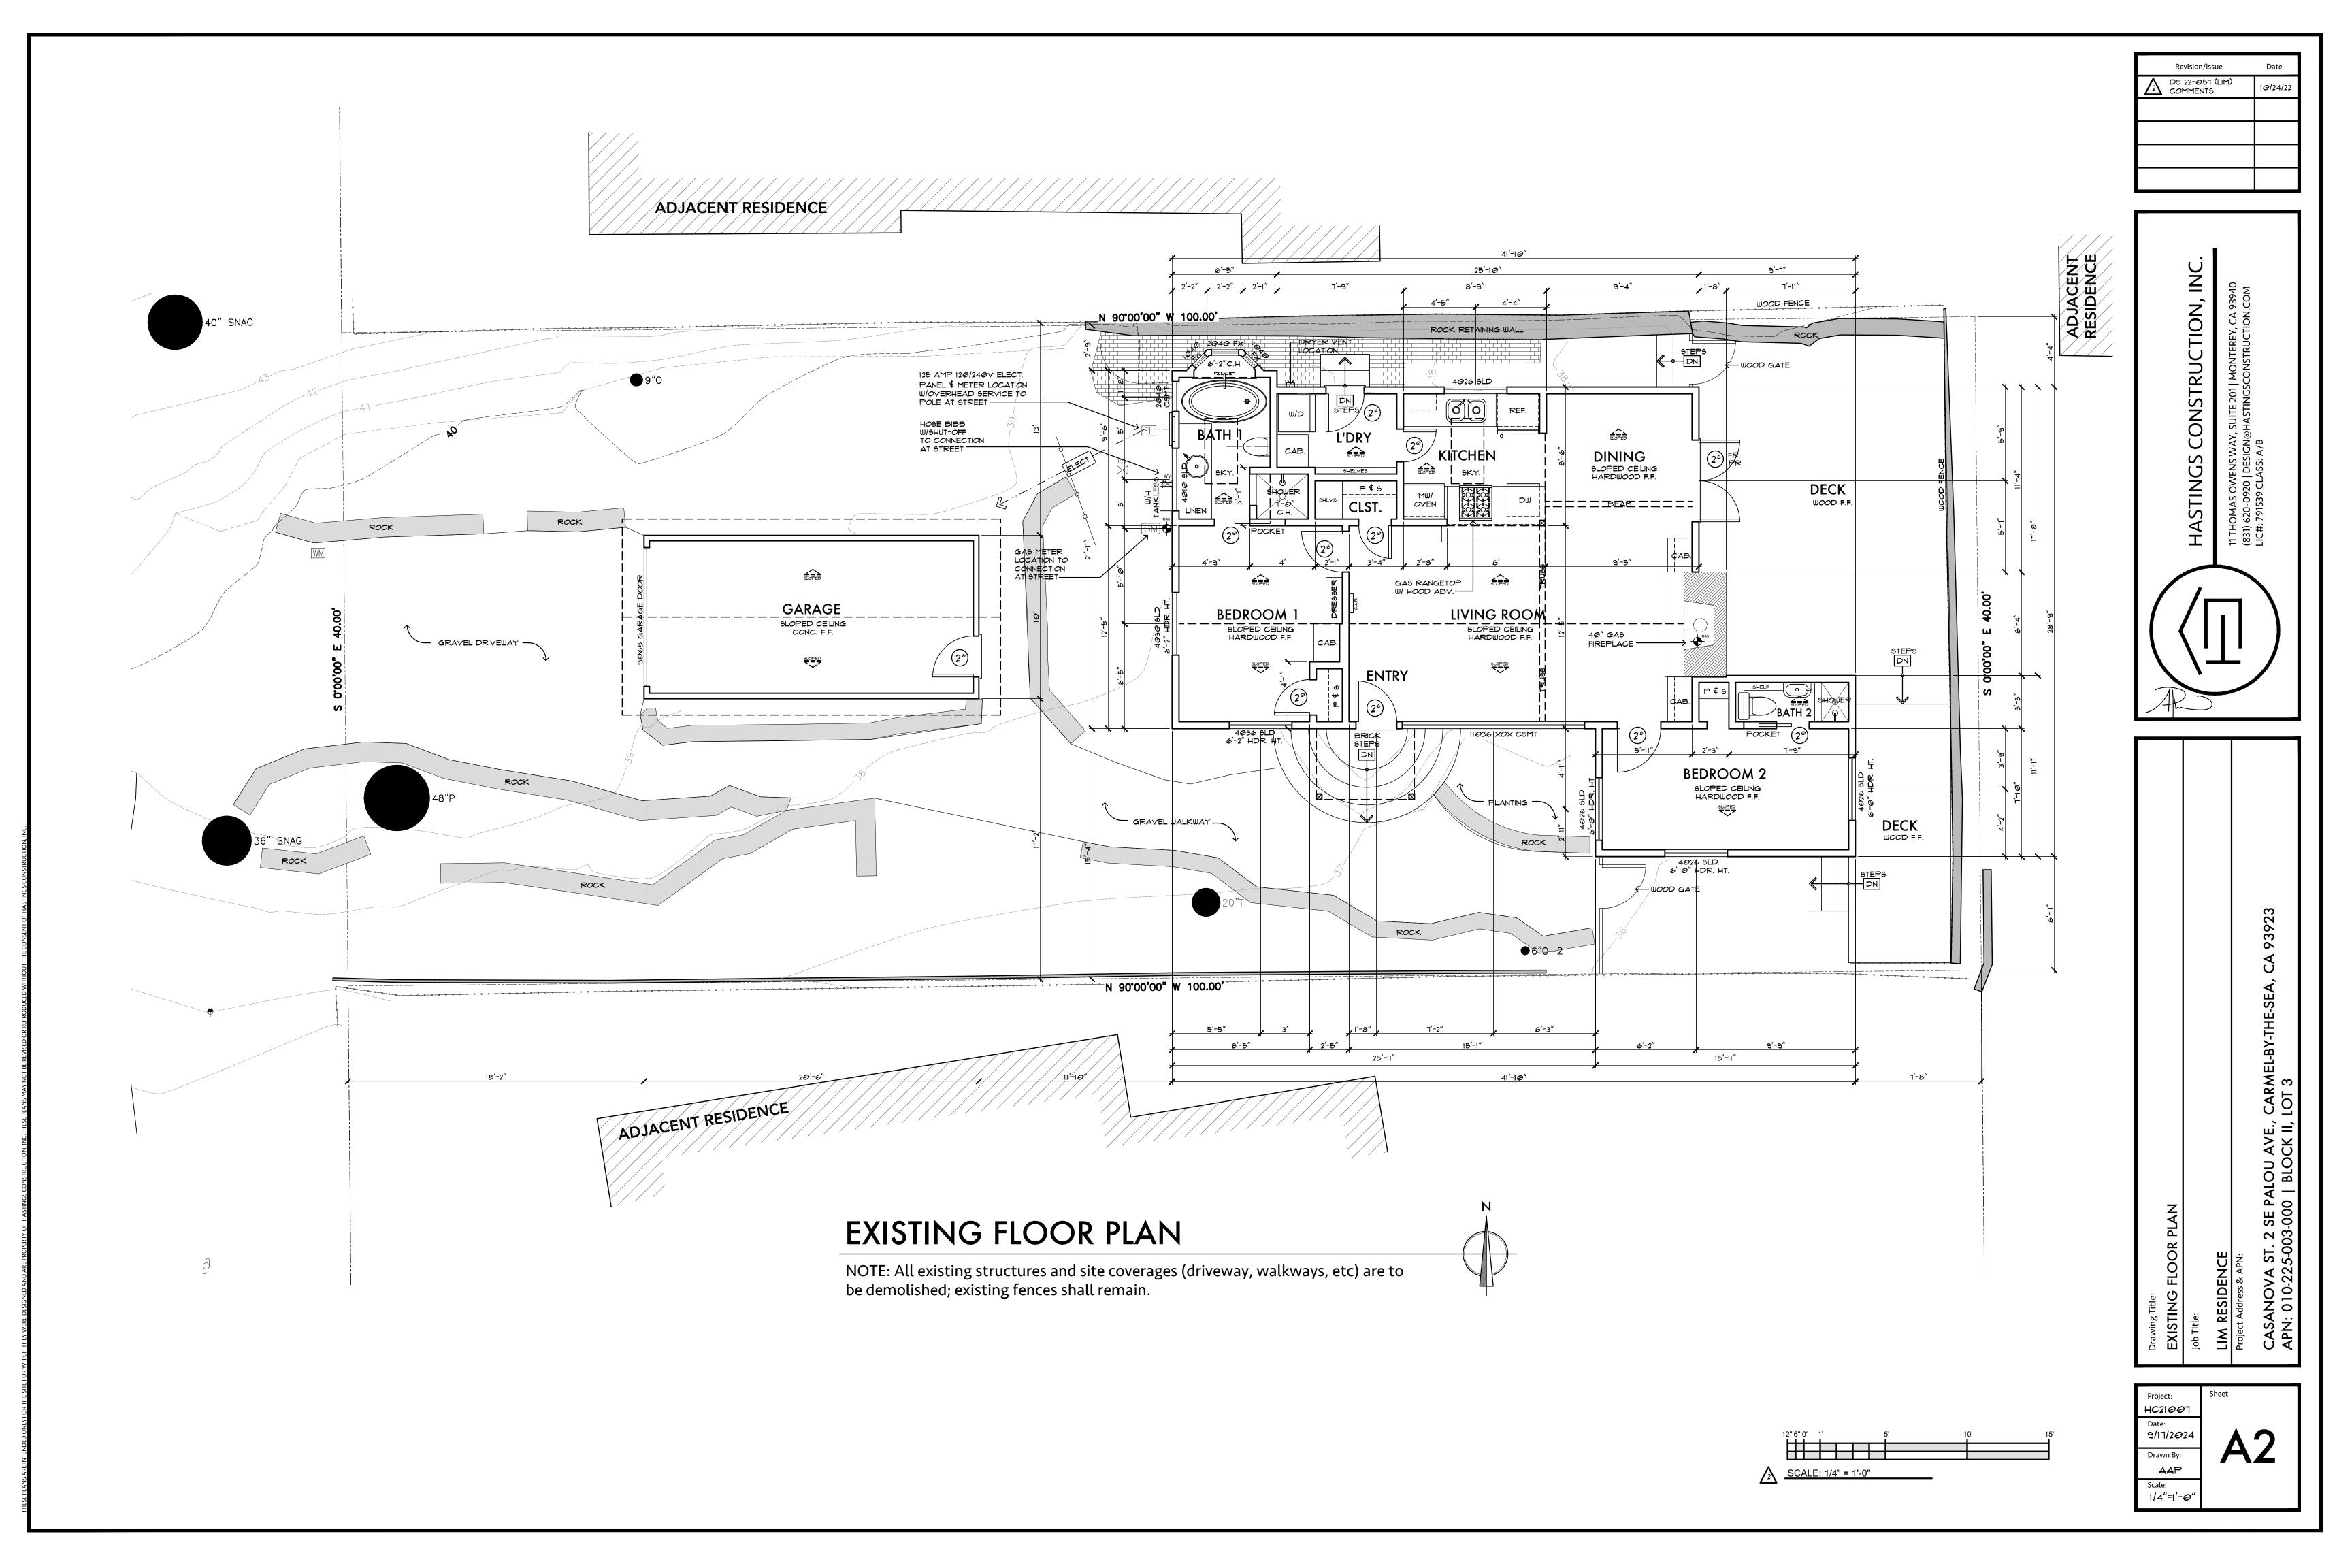

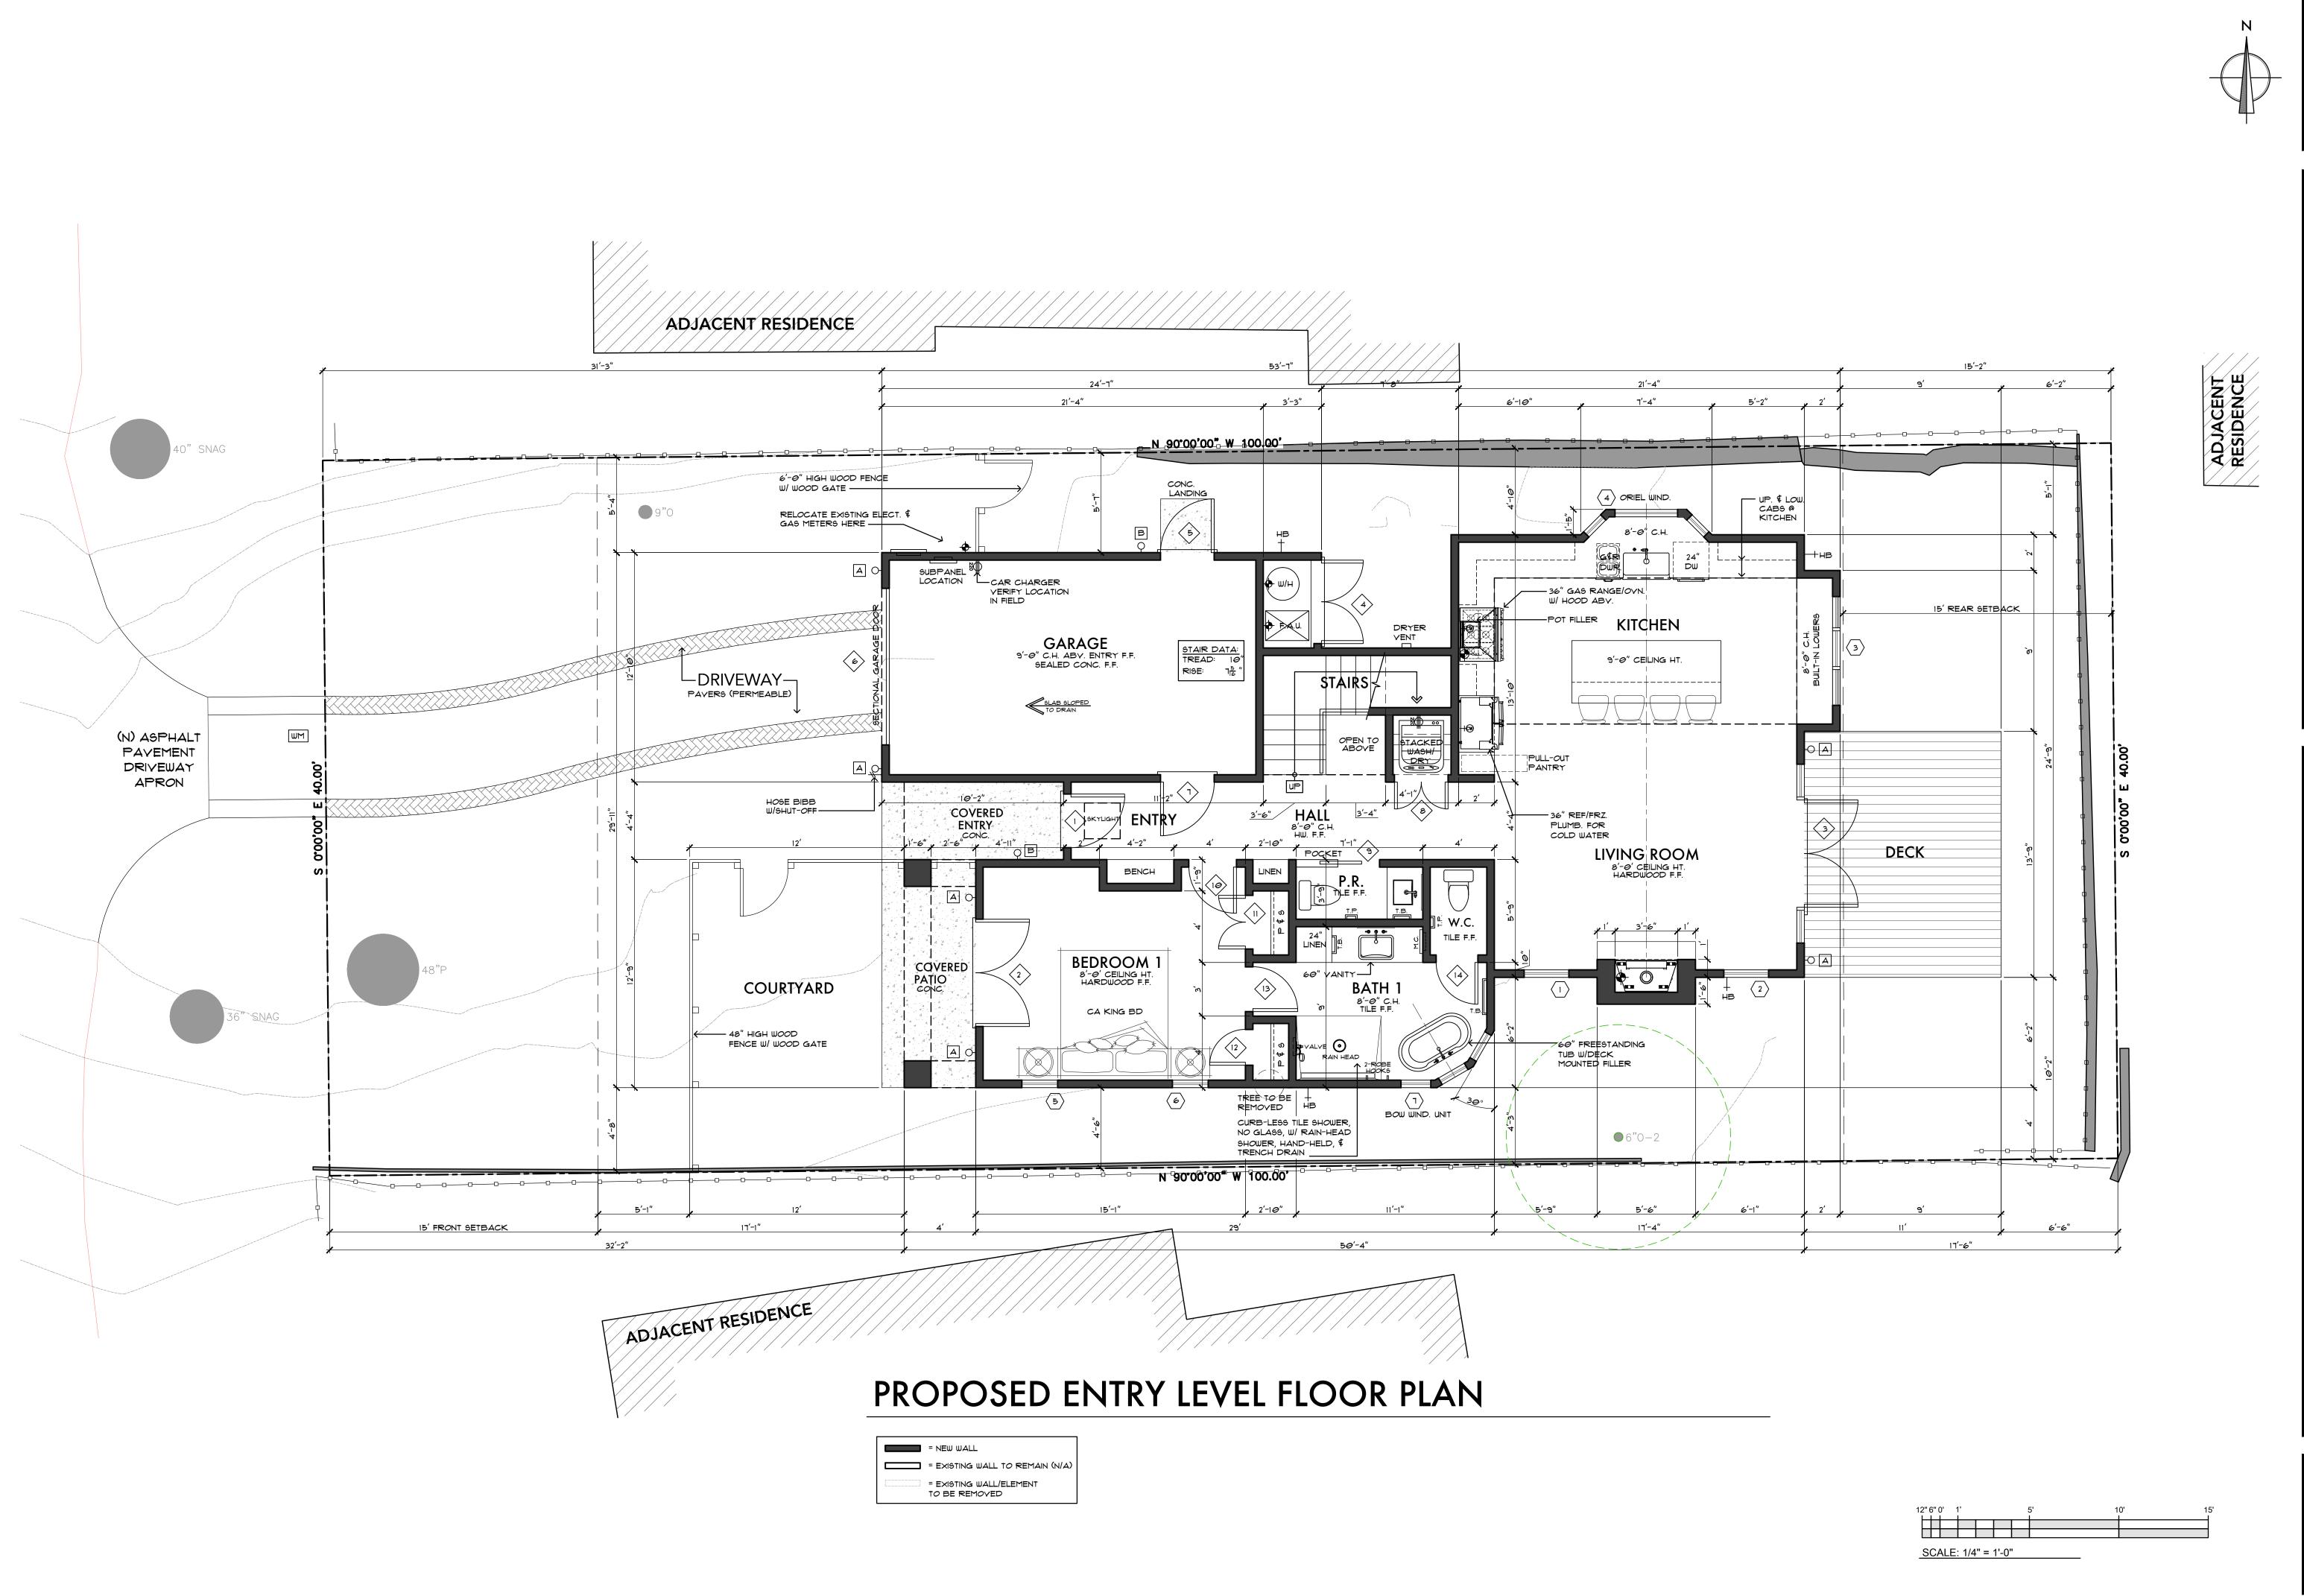

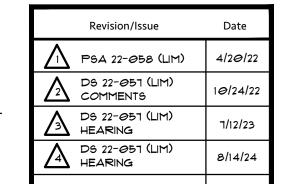

HASTINGS CONSTRUCTION, INC.

11 THOMAS OWENS WAY, SUITE 201 | MONTEREY, CA 93940
(831) 620-0920 | DESIGN@HASTINGSCONSTRUCTION.COM
LIC#: 791539 CLASS: A/B

PLAN
VE., CARMEL-BY-THE-SEA, CA 93923

RESIDENCE

ct Address & APN:


SANOVA ST. 2 SE PALOU AVI


Project:
HC21007

Date:
9/17/2024

Drawn By:
AAP

Scale:
1/4"=1'-0"

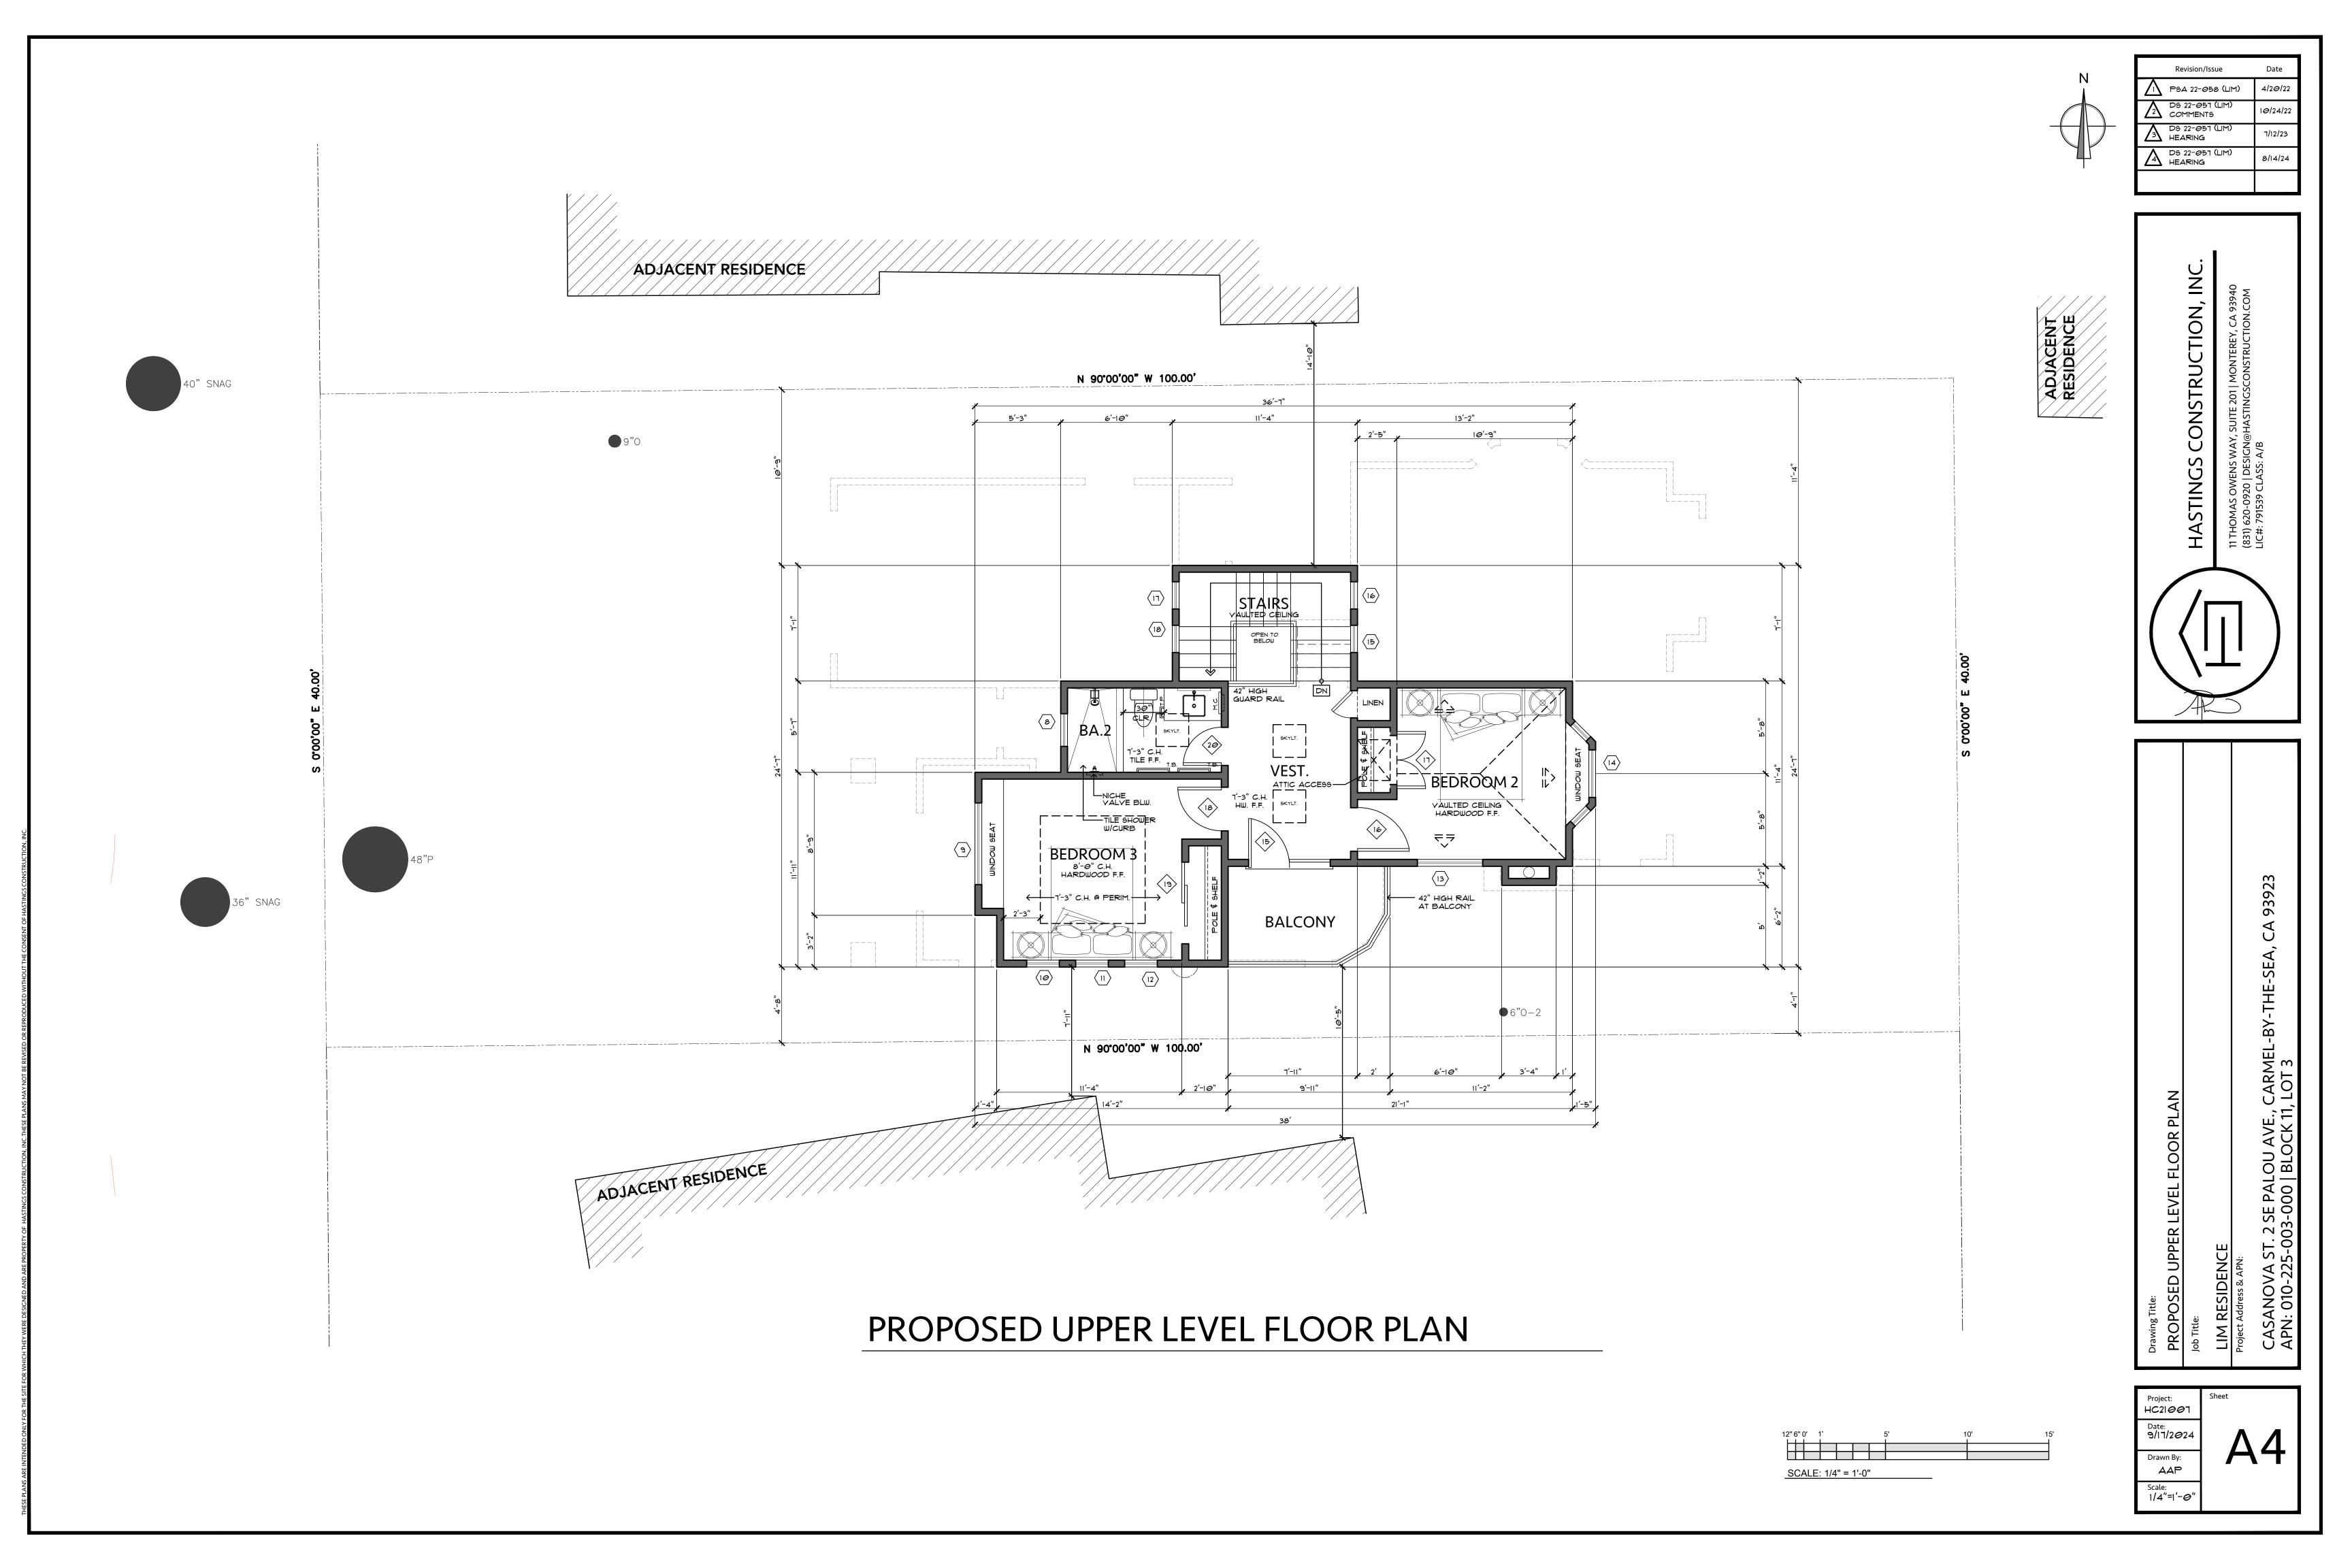

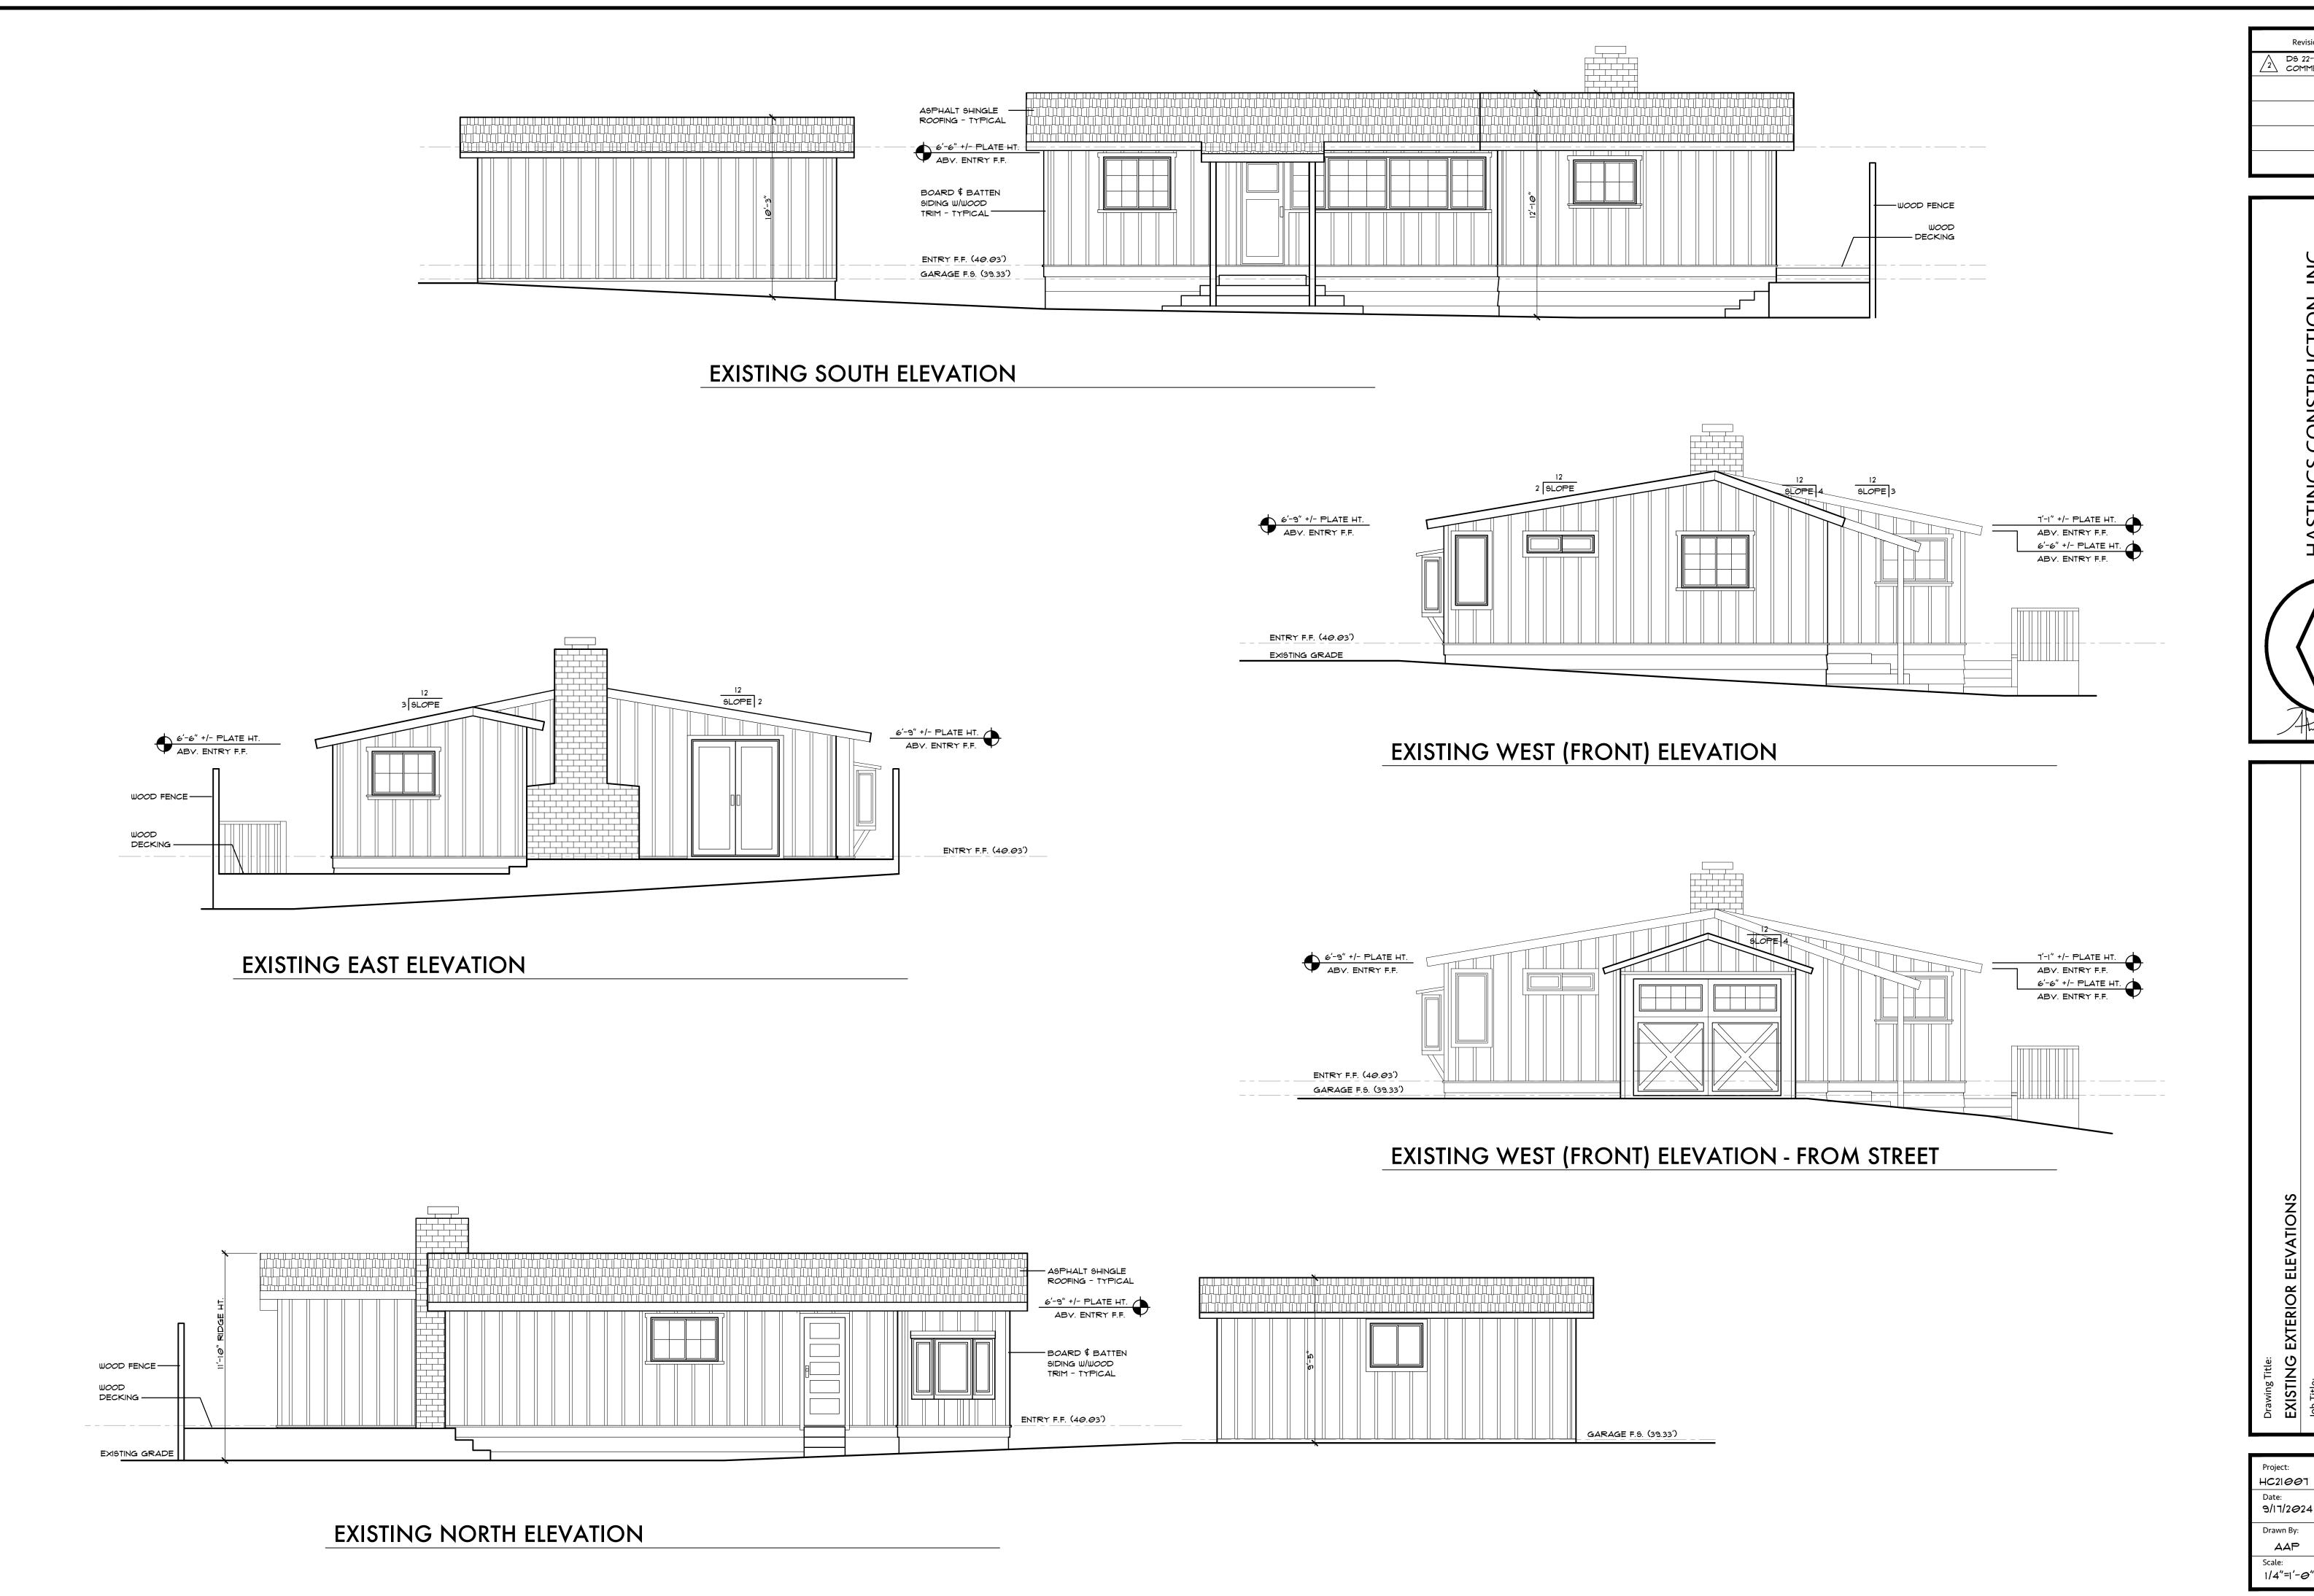

Revision/Issue Date

D9 22-057 (LIM)
COMMENTS

10/24/22

HASTINGS CONSTRUCTION, INC.

11 THOMAS OWENS WAY, SUITE 201 | MONTEREY, CA 93940
(831) 620-0920 | DESIGN@HASTINGSCONSTRUCTION.COM
LIC#: 791539 CLASS: A/B


ELEVATIONS
SE PALOU AVE., CARMEL-BY-THE-SEA, CA 93923

Project:
HC21007

Date:
9/17/2024

Drawn By:
AAP

Scale:

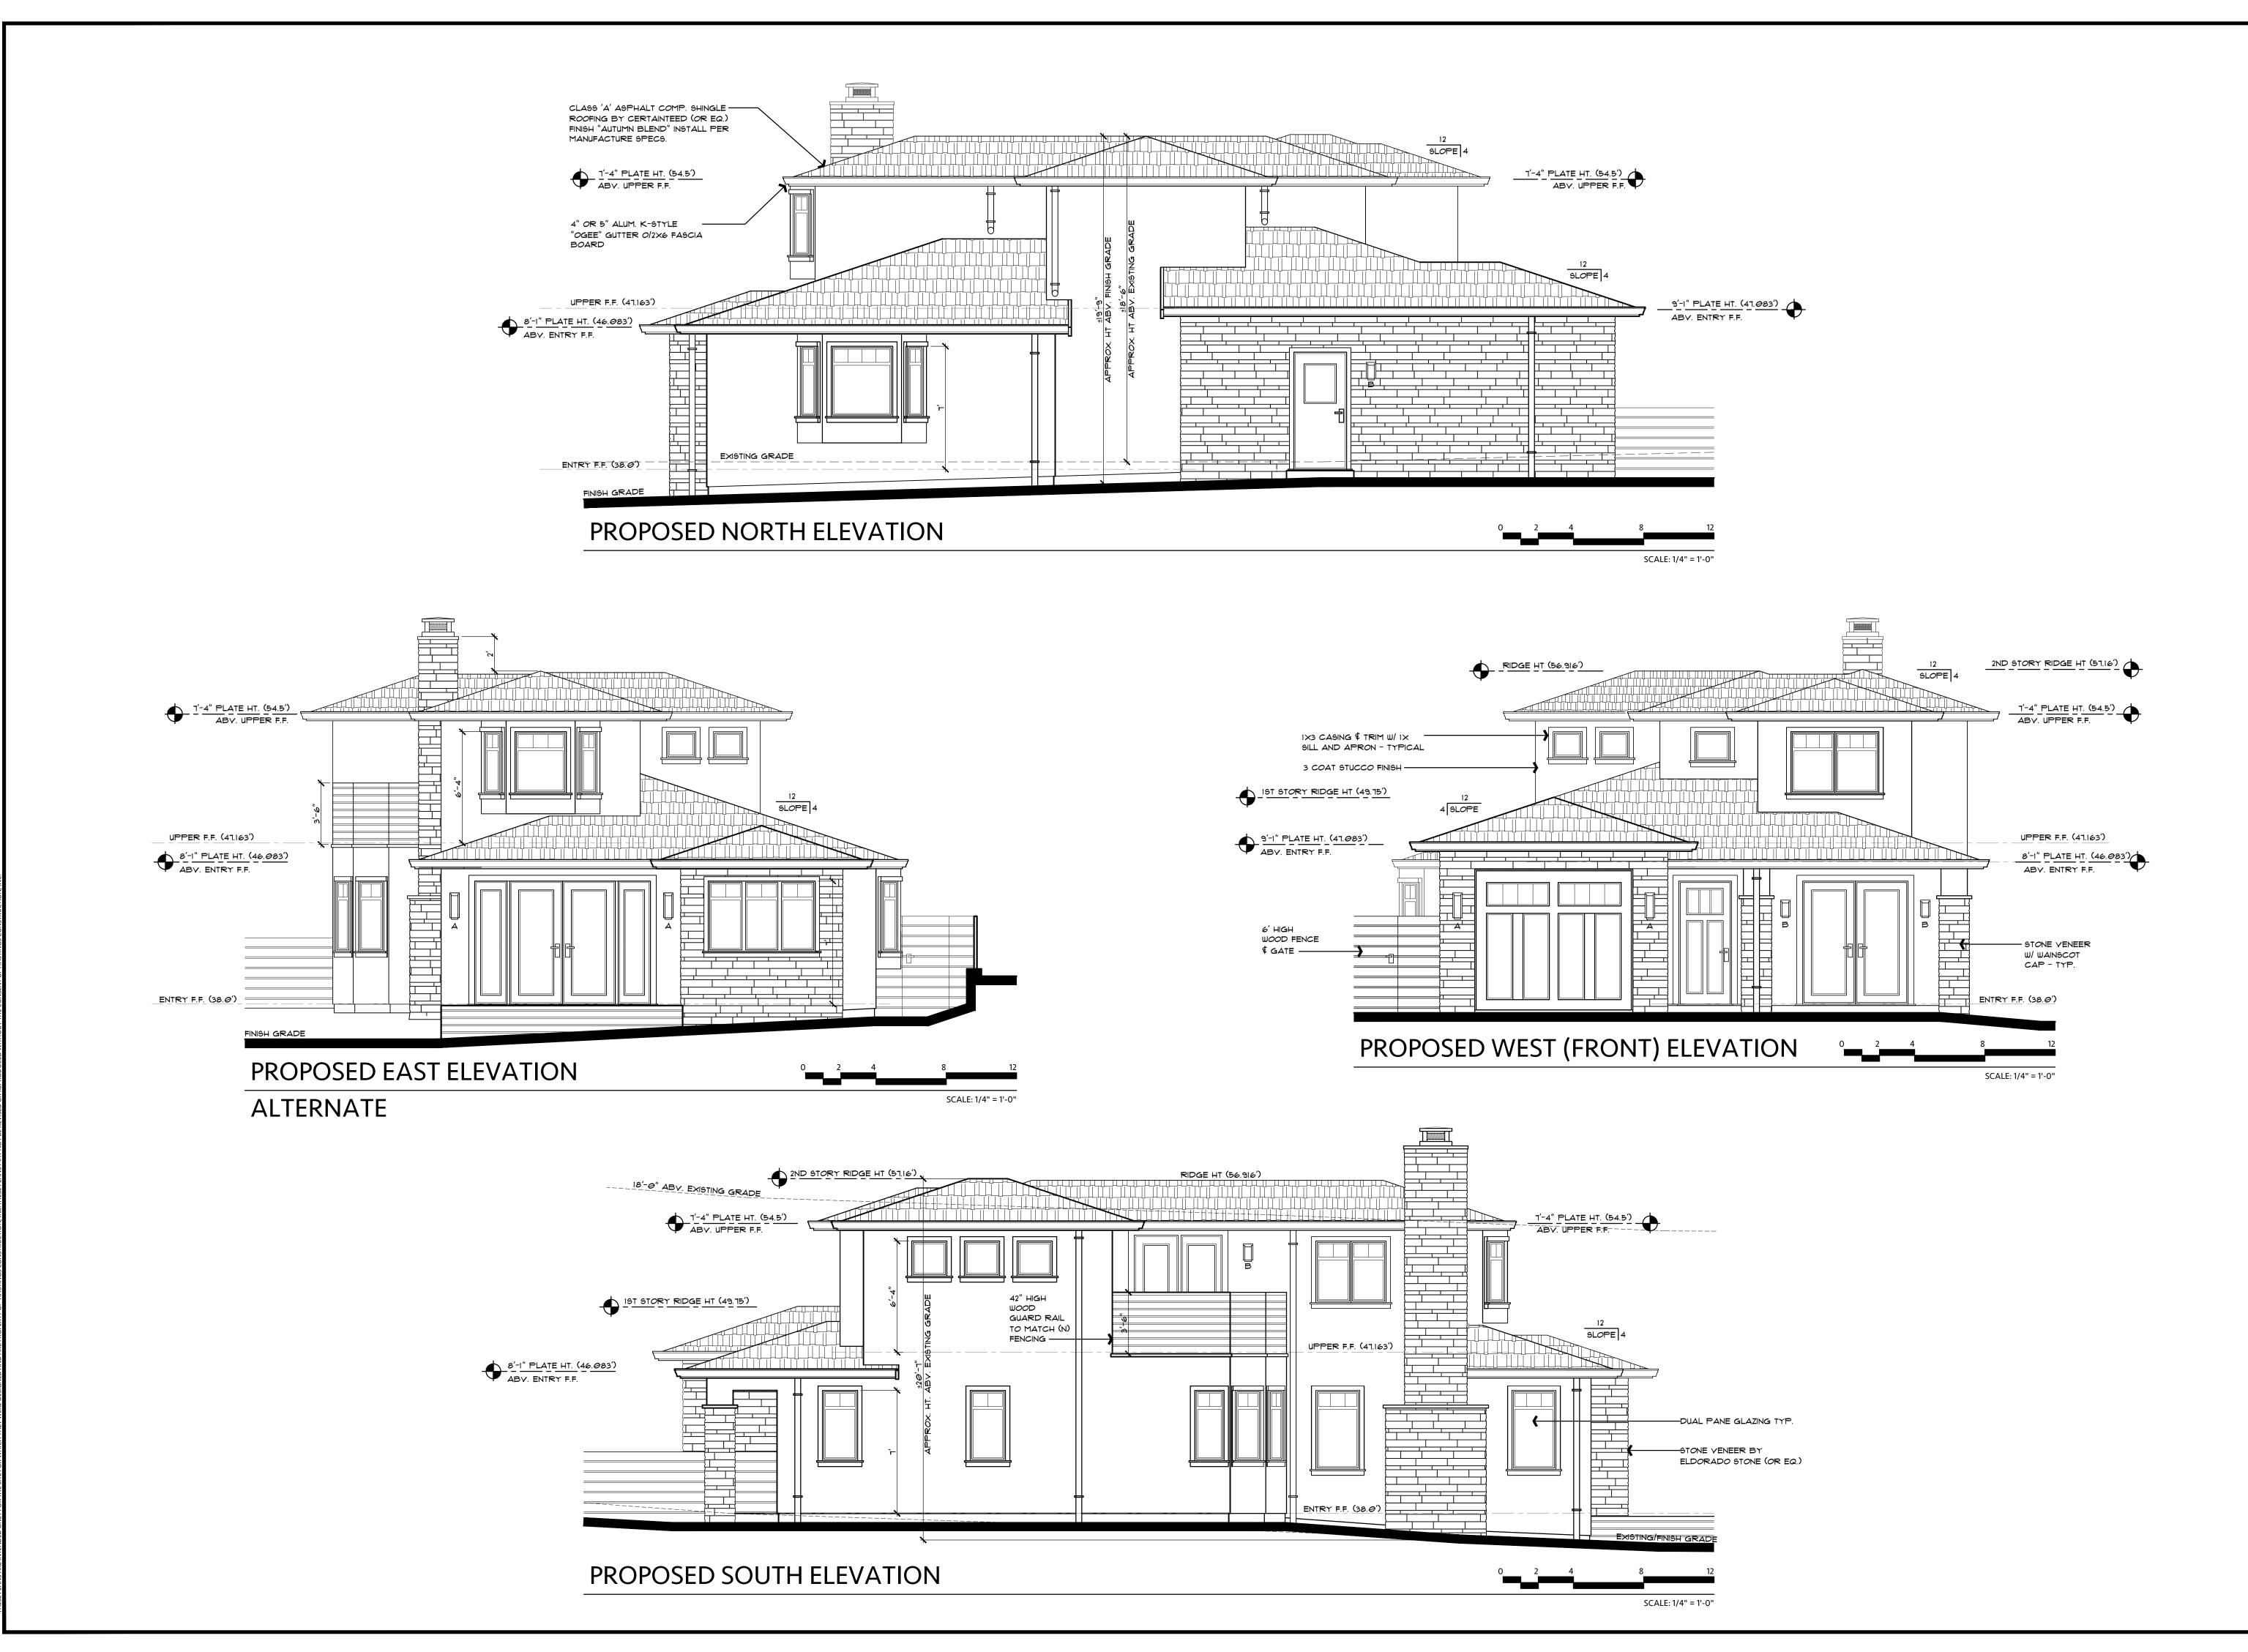

Revision/Issue Date

PSA 22-Ø58 (LIM) 4/2Ø/22

DS 22-Ø51 (LIM) 1Ø/24/22

DS 22-Ø51 (LIM) 1/12/23

DS 22-Ø51 (LIM) 4/12/23

DS 22-Ø51 (LIM) 8/14/24

HASTINGS CONSTRUCTION, INC.

11 THOMAS OWENS WAY, SUITE 201 | MONTEREY, CA 93940
(831) 620-0920 | DESIGN@HASTINGSCONSTRUCTION.COM
LIC#: 791539 CLASS: A/B

IATE PROPOSED EXTERIOR ELEVATIONS
SIDENCE

93923

SE PALOU AVE., CARMEL-BY-THE-SEA, -000 | BLOCK 11, LOT 3

Project:
HC21007

Date:
9/17/2024

Drawn By:
AAP

Scale:
1/4"=1'-0"

EXTERIOR FINISHES

Description: Door Pros "Reserve Wood" Limited Edition carriage style door with Design #2 paired with Reserve Limited Edition REC14 window design, finished in Natural

#078 or Teak #085, to match Entry door finish.



Light Fixture A Specifications

Modern Forms Vitrine 16" High Bronze LED Outdoor Wall Light

Product Details

This bronze outdoor wall light has a mouth-blown seeded glass shade that adds a beautiful rain-washed effect.

Additional Info:

Gorgeous glass and a rich oil-rubbed bronze finish make for a compelling combination in this outdoor LED wall light from Modern Forms. This light features absolutely beautiful seeded optic glass, mouth-blown for an incredible look flanking a front or back door. Perfect for indoor and outdoor settings in luxury homes and resorts. Supports smooth dimming with the addition of an electronic low voltage dimmer (not included).





Shop all Modern Forms

- 16" high x 6 1/2" wide. Extends 4 1/2"
- from the wall. • Backplate is 14 3/4" high x 6 1/2" wide

x 3/4" deep. Glass is 14" high x 5 1/4"

- Includes one dimmable 10.5 watt high-powered replaceable LED
- module: 365 lumen light output, comparable to a 35 watt incandescent. 3000K color temperature. 90 CRI.
- Energy-efficient LED outdoor wall light from the Vitrine collection by Modern Forms.
- Bronze finish over aluminum construction. Clear hammered seeded mouth-blown optic glass.
- Smooth and continuous dimming with an electronic low voltage (ELV)
- LED averages 80,000 hours at 3 hours per day.
- AC LED technology no driver or transformer required.
- Easily fits on a pancake junction box.
- 277V, 240V, or custom CCT options available by special order.
- Perfect for indoor and outdoor settings in luxury homes and resorts.



Light Fixture B Specifications
Modern Forms Vitrine 12" High Bron

Wall Light

- 12" high x 6 1/2" wide. Extends 4" from the wall. Backplate is 10 3/4" high x 6 1/2" wide x 3/4" deep.
- 5 watt high-powered replaceable LED module, comparable to a 25 watt incandescent. 205 lumens. 3000K. 90


/I\ PSA 22-058 (LIM) DS 22-057 (LIM) 2 COMMENTS D9 22-051 (LIM) HEARING 7/12/23





9392


HC21007 9/17/2024 Drawn By:


Scale: 1/4"=1'-0"

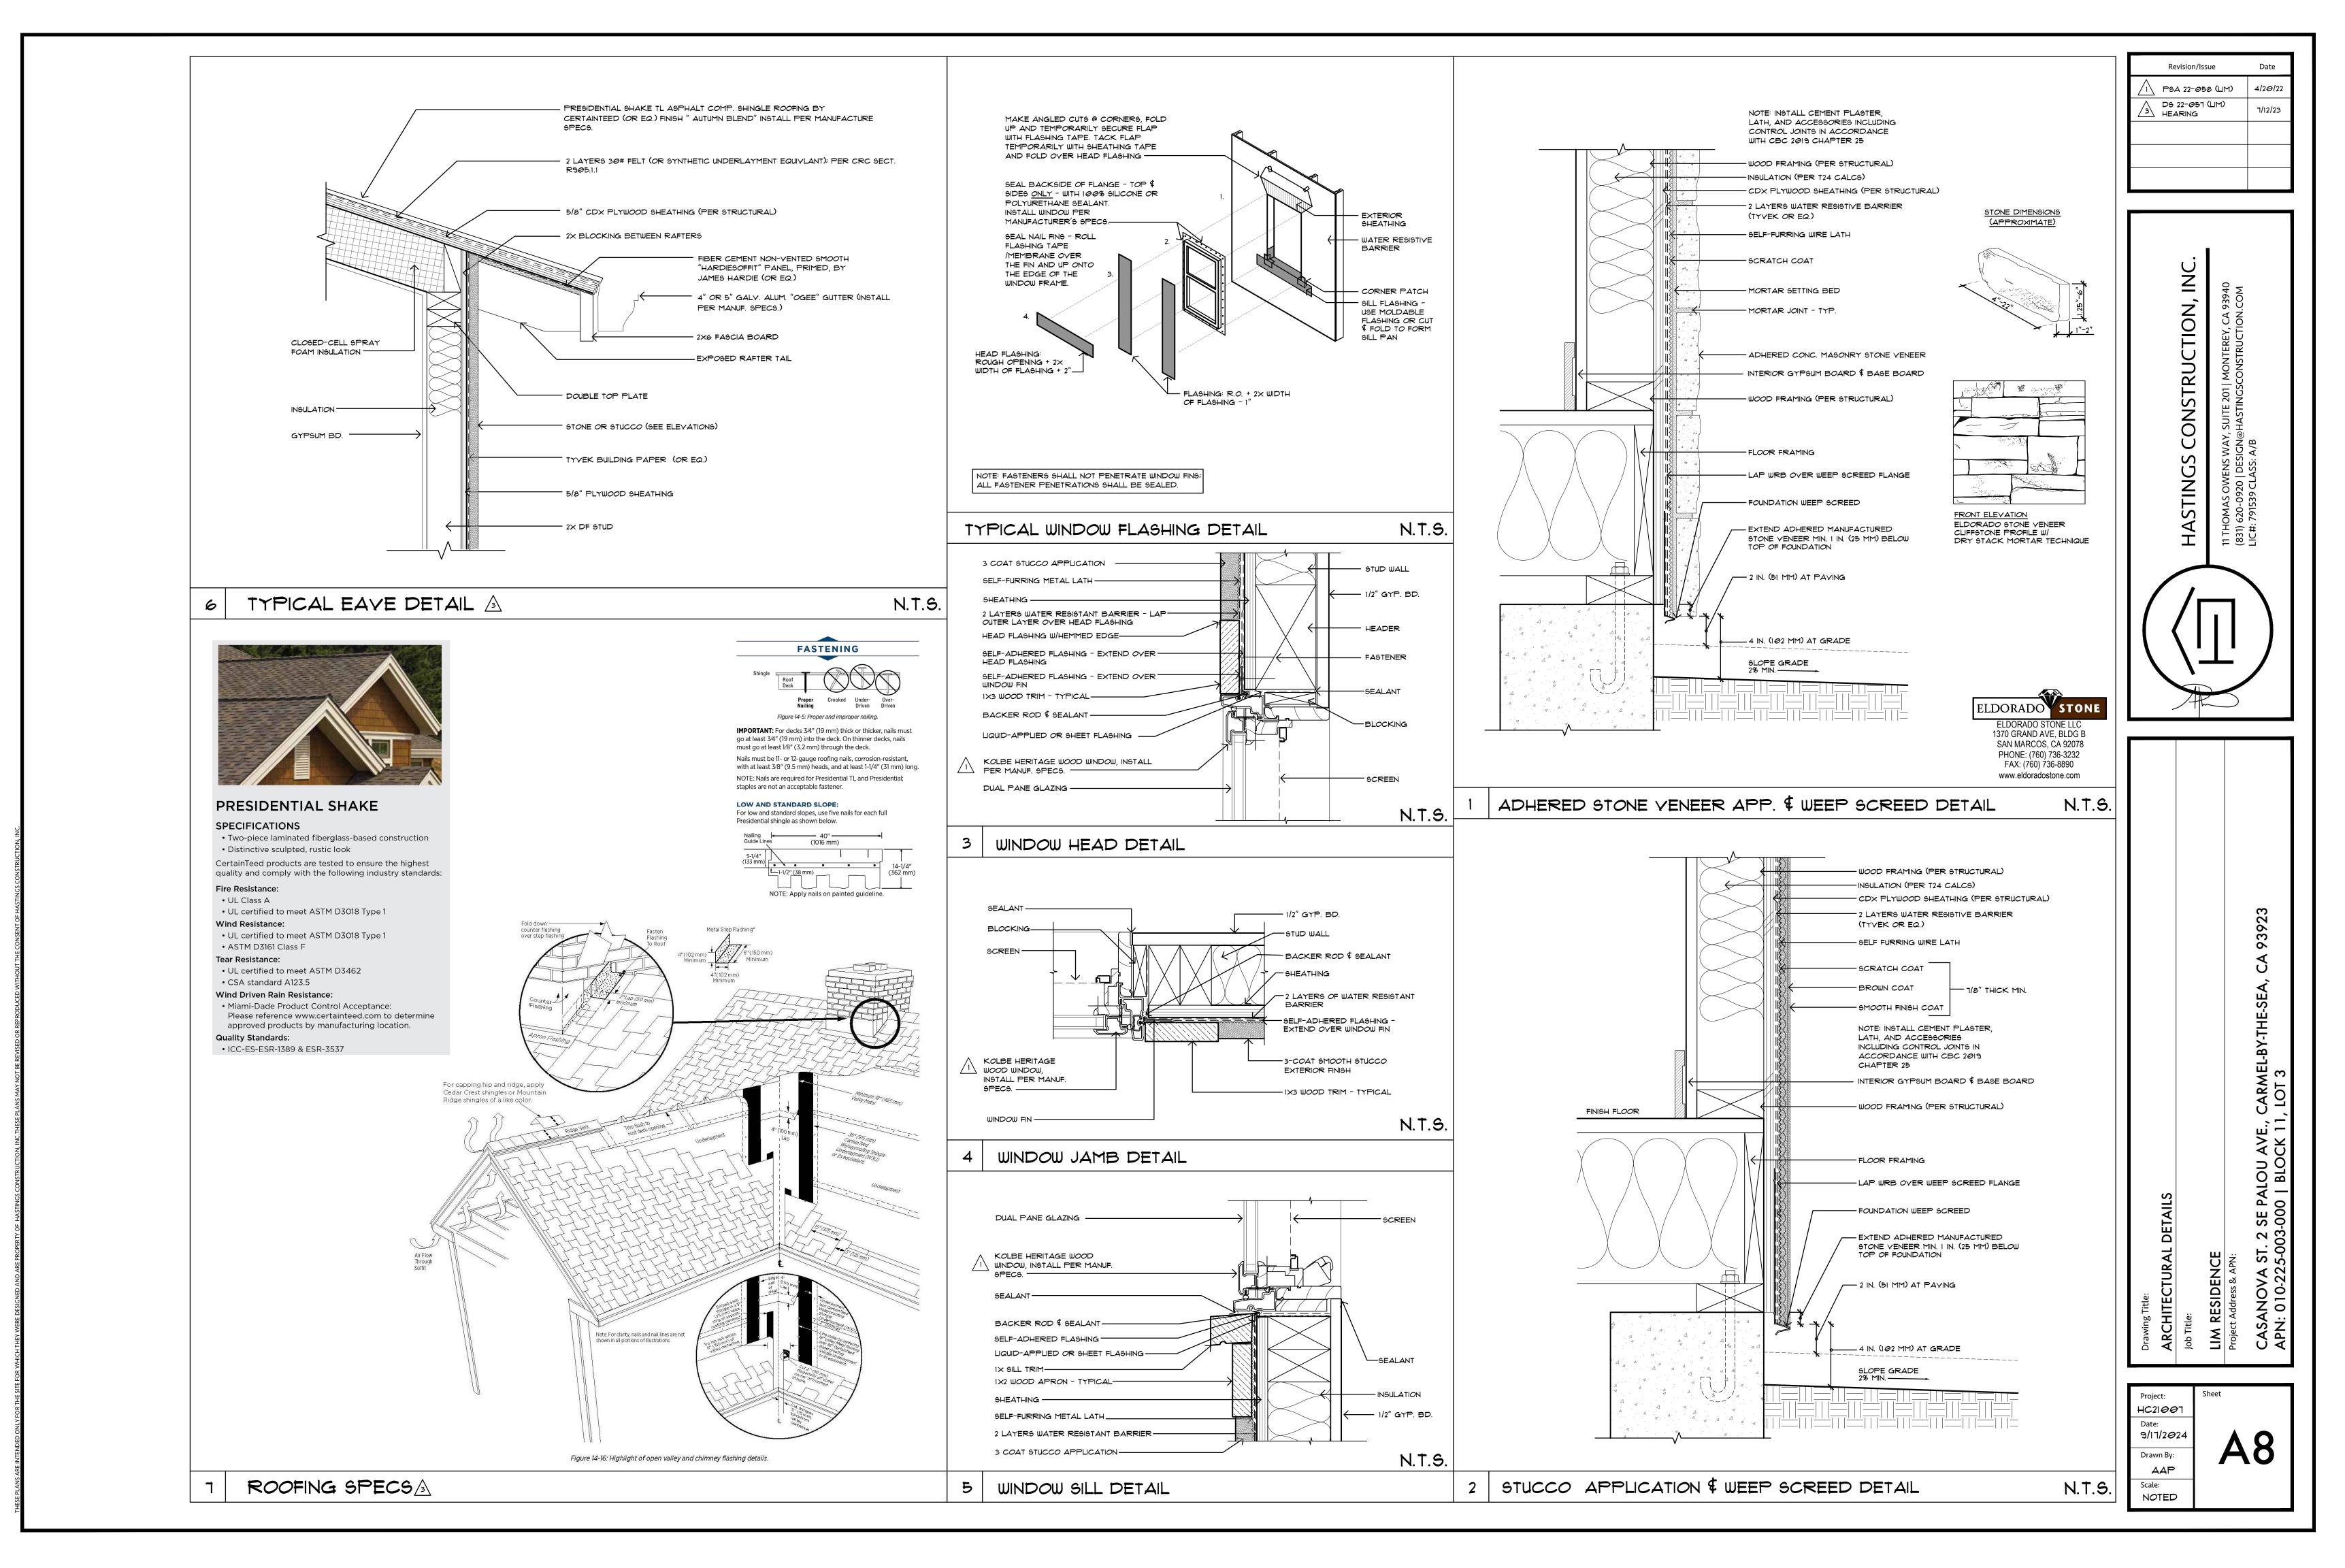


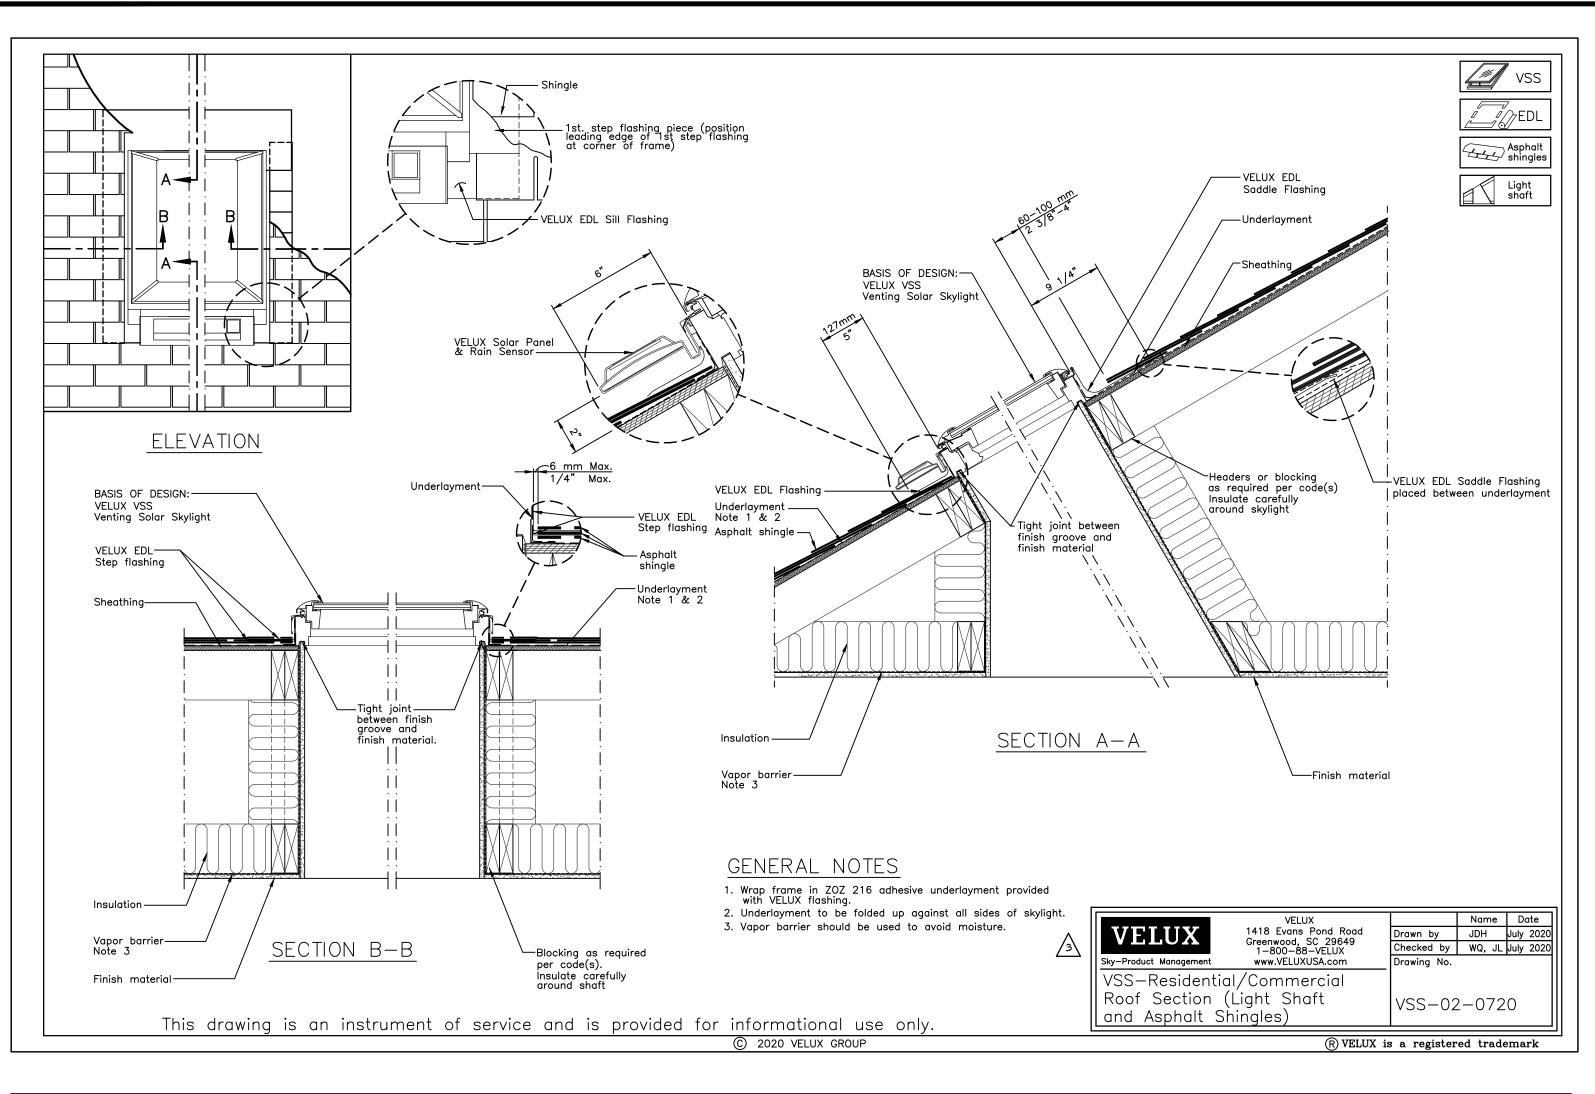

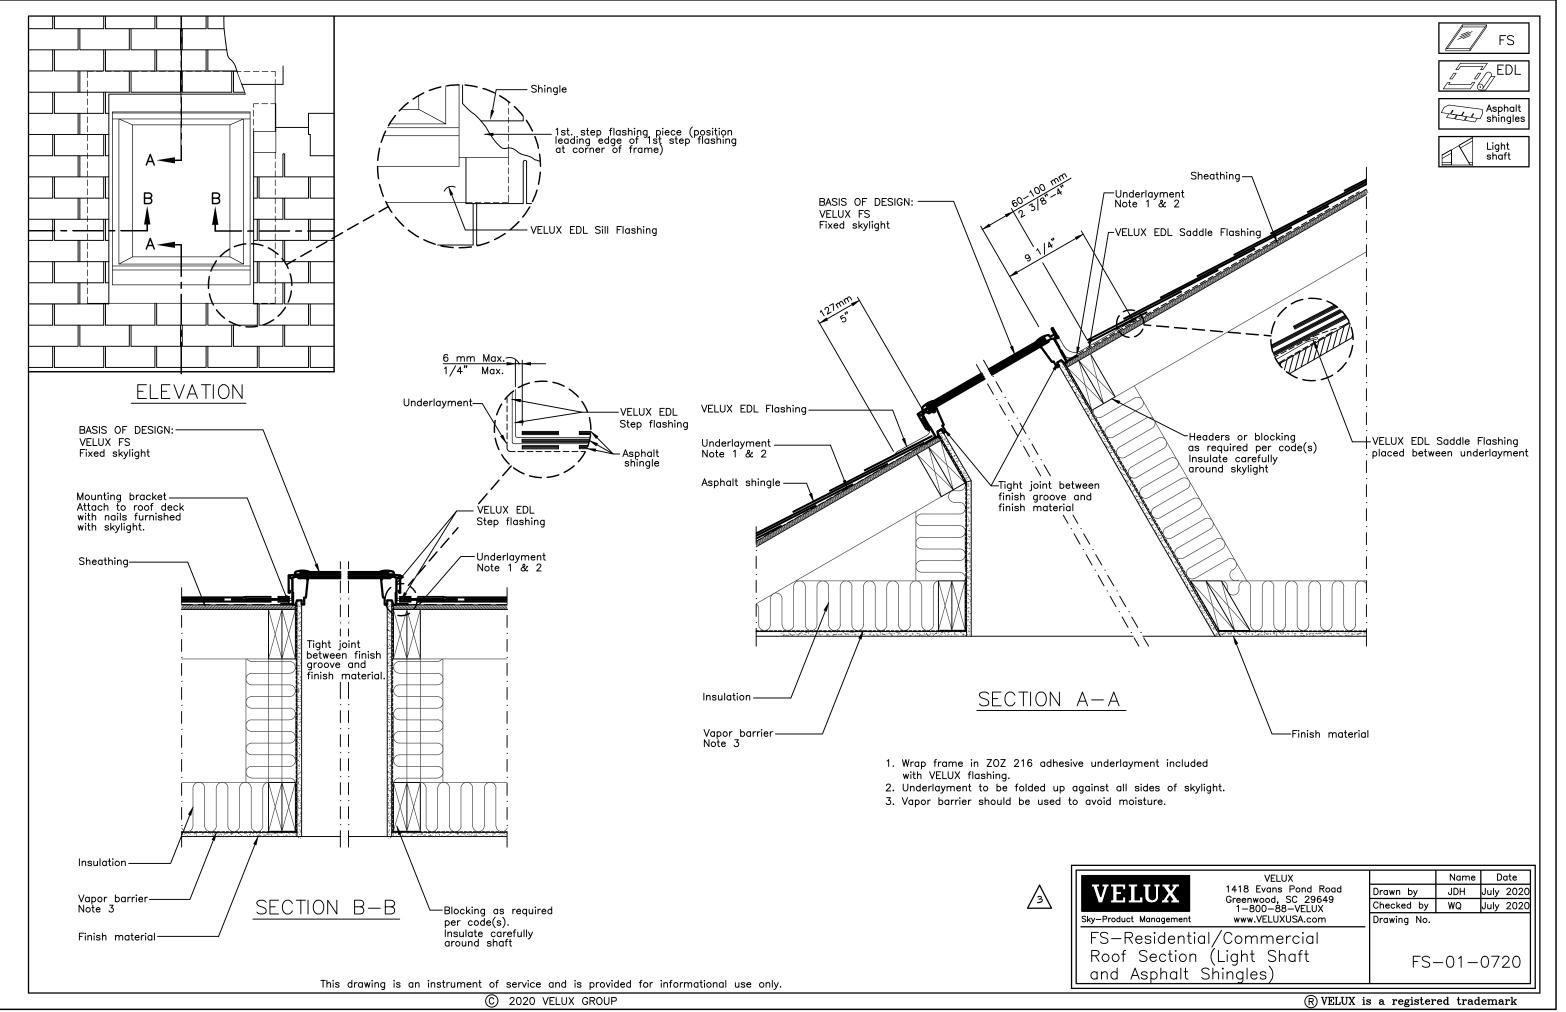

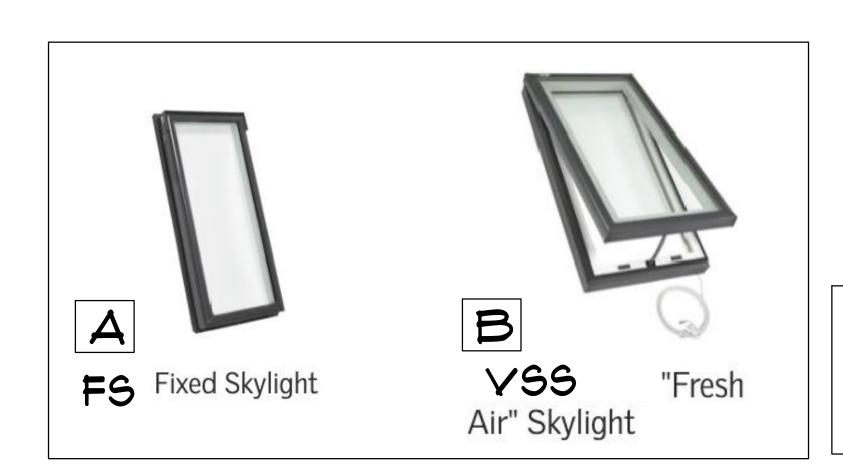

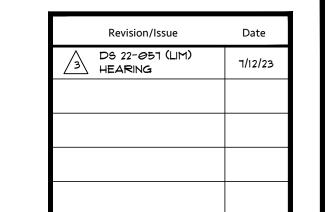

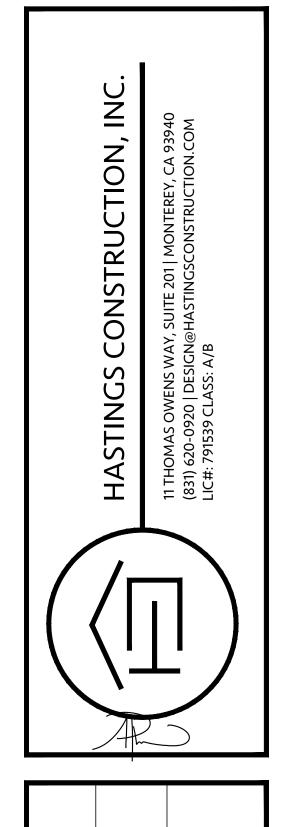

M RESIDENCE

ject Address & APN:

ASANOVA ST. 2 SE PALOU AVE., CARMEL-BY-THE-SEA, CA 9392;

PN: 010-225-003-000 | BLOCK 11, LOT 3

General Notes: (Cont.)

4. Exterior finish shall be non-reflective

Exterior infisit shall be non-reflective
 Provide required electrical per manufacturers specs for mechanical operation and power operated shades

6. Interior finish to be white7. Elec. Shade shall be installed

Project:

HC21007

Date:

9/17/2024

Drawn By:

AAP

Scale:


1/4"=1'-0"


SKYLIGHT DETAILS

			\	WIND	S WC	SCHEDULE
	WINDOU	J SIZES (Af	PPROX.)			
WINDOW NUMBER	WIDTH	HEIGHT	HDR. HEIGHT	TYPE	GLAZING NOTES	REMARK9
1	2'-6"	5'-6"	8'-0"	CASEMENT		
2	2'-6"	5'-6"	8'-0"	CASEMENT		
3	6'-0"	5'- <i>0</i> "	8'-6"	FRENCH CASEMENT	TEMPERED	
4	7'-4"	5'- <i>0</i> "	8'-6"	45 DEG. BAY WIND <i>o</i> w		(2) CASEMENT UNITS: 1450 (1) PICTURE UNIT: 3650 (SEE EXTERIOR ELEVATIONS)
(5)	2'-0"	4'-0"	1'− Ø"	CASEMENT		
6	2'-0"	4'-0"	ĭ'- <i>⊜</i> "	CASEMENT		
7	5'-10"	4'-0"	T'-Ø"	30 DEG. BAY WINDOW	TEMPERED	(3) CASEMENT UNITS: 1850
8	2'-0"	1'-8"	6'-4"	AWNING	TEMPERED OBSCURED	
(e)	5'- <i>0</i> "	3'-6"	6'-4"	FRENCH CASEMENT		EGRE99
(10)	2'-0"	2'-@"	6'-4"	AWNING		
	2'-0"	2'-@"	6'-4"	AWNING		
(12)	2'-@"	2'-@"	6'-4"	AWNING		
(13)	4'-0"	3'-6"	6'-4"	FRENCH CASEMENT	TEMPERED	EGRE99
(14)	1'-0"	3'-6"	6'-4"	45 DEG. BAY WIND <i>o</i> W	TEMPERED	(2) CASEMENT UNITS: 1436 (1) CASEMENT UNIT: 3036
(15)	1'-8"	1'-6"	6'-4"	FIXED	TEMPERED	
(16)	1'-8"	1'-6"	6'-4"	FIXED	TEMPERED	
(17)	1'-8"	1'-6"	6'-4"	FIXED	TEMPERED	
(18)	1'-8"	1'-6"	6'-4"	FIXED	TEMPERED	


						DOC	JR SC	CHEDULE
DOOR		SIZE		ŧ	FINISH			
NUMBER	WIDTH	HEIGHT	THICK	INTERIOR	EXTERIOR	HARDWARE	GLAZING	REMARKS
$\langle 1 \rangle$	3'-0"	1'-0"	1-3/4"	WOOD FIR FINISH	WOOD FIR FINISH	THRESHOLD LOCKSET W/ DEADBOLT	"SEEDY BAROQUE"	ENTRY DOOR BY T.M. COBB #4632, FLAT PANEL, W/FIR FINISH AND "SEEDY BAROQUE" GLAZING; HARDWARE BY KWIKISET "AVALON" IN OIL-RUBBED BRONZE FINISH W/SMARTK (OR EQUAL); LH SWING
2	3'-0" PR	ז'-@"	1-3/4"	WOOD PRIMED	PAINTED TO MATCH TRIM	*BUILT-IN	TEMPERED	KOLBE HERITAGE OUTSWING FRENCH DOOR PAIR W/OIL-RUBBED BRONZE HARDWARE (OR EQUAL)
3	3'-0" PR	ד'-@"	1-3/4"	WOOD PRIMED	PAINTED TO MATCH TRIM	*BUILT-IN	TEMPERED	KOLBE HERITAGE OUTSWING FRENCH DOOR PAIR W/24" SIDELIGHTS AND 12" TRANSOM ABOVE, W/OIL-RUBBED BRONZE HARDWARE (OR EQUAL)
4	3'-0" PR	6'-8"	1-3/4"	WOOD PRIMED	WOOD	THRESHOLD KEYED KNOB	N/A	WOOD OUTSWING W/ VENTING FOR HIGH AND LOW COMBUSTION MAKE UP AIR, W/OIL-RUB BRONZE HARDWARE (OR EQUAL)
(5)	3'-@"	6'-8"	1-3/4"	WOOD PRIMED	WOOD FIR FINISH	THRESHOLD LOCKSET W/ DEADBOLT	OBSCURED TEMPERED	GARAGE MAN-DOOR BY TYCO, FLAT PANEL, W/FIR FINISH AND OBSCURED GLAZING; HARDWARE BY KWIKISET "ALISO" KNOB IN OIL-RUBBED BRONZE FINISH (OR EQUAL - FII TO MATCH ENTRY DOOR); RH SWING
6	9'-0"	8'-0"	* PER MANUF.	W00D	WOOD	N/A	CLEAR D9B W/9IM. DIV LT.	SECTIONAL GARAGE DOOR BY CLOPLAY "RESERVE WOOD, LIMITED EDITION" COLLECTION DESIGN #2 WITH REC! 4 WINDOWS (OR EQUAL-FINISH TO MATCH ENTRY DOOR)
$\langle \overline{1} \rangle$	3'-@"	7'-0"	TBD	w <i>oo</i> 1	O PRIMED	THRESHOLD KEYED KNOB	N/A	INTERIOR GARAGE DOOR; RH SWING
8	1'-6" PR	ד'-@"	TBD	W <i>00</i> 1	O PRIMED	DUMMY W/LATCH	N/A	OUTSWING PAIR - LOUVERED
⟨e ⟩	2'-4"	ז'-⁄€"	TBD	W <i>00</i> 1	O PRIMED	PULL-PRIVACY	N/A	POCKET
10	2'-8"	ז'-⁄⁄9"	TBD	W <i>00</i> 1	O PRIMED	PRIVACY	N/A	LH SWING
	1'-6" PR	7'-0"	TBD	W <i>00</i> 1	D PRIMED	DUMMY W/LATCH	N/A	OUTSWING PAIR
(12)	2'-0"	7'-0"	TBD	W <i>00</i> 1	D PRIMED	DUMMY W/LATCH	N/A	RRH SWING
(13)	2'-6"	7'-0"	TBD	W <i>00</i> 1	O PRIMED	PRIVACY	N/A	RH SWING
14	2'-4"	7'-0"	TBD	W <i>00</i> 1	D PRIMED	PRIVACY	N/A	RRH SWING
(15)	2'-6"	6'-8"	* PER MANUF.	WOOD PRIMED	PAINTED TO MATCH TRIM	*BUILT-IN	TEMPERED	KOLBE HERITAGE INSWING FRENCH DOORS, W/OIL-RUBBED BRONZE HARDWARE (OR EQUAL); LH SWING
(16)	2'-8"	6'-8"	TBD	W001	D PRIMED	PRIVACY	N/A	RH SWING
(17)	1'-6" PR	6'-8"	TBD	W <i>00</i> 1	D PRIMED	DUMMY W/LATCH	N/A	OUTSWING PAIR
(18)	2'-8"	6'-8"	TBD	W001	D PRIMED	PRIVACY	N/A	RH SWING
⟨€1⟩	5'-0"	6'-8"	TBD	W <i>00</i> 1	D PRIMED	FLUSH PULL	N/A	(2) BYPASS DOORS
20	2'-4"	6'-8"	TBD	W00	D PRIMED	PRIVACY	N/A	LH SWING




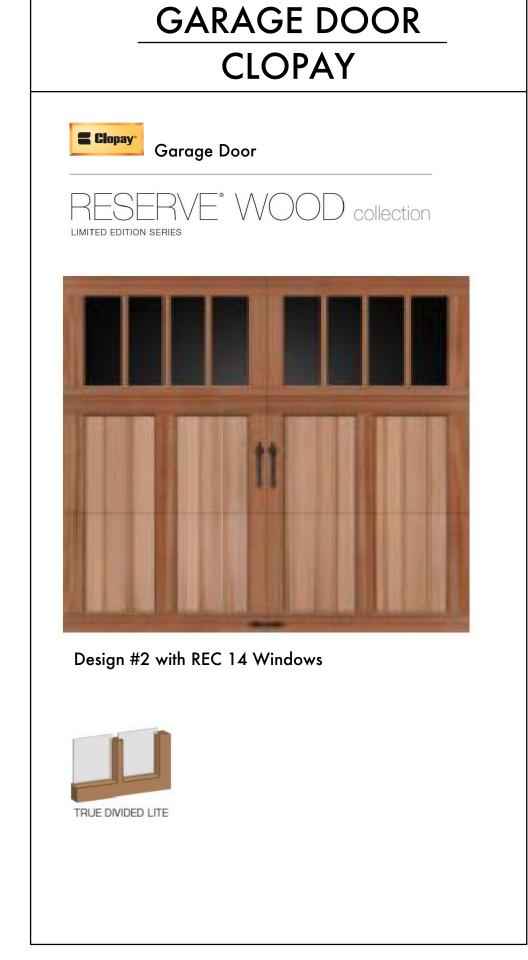


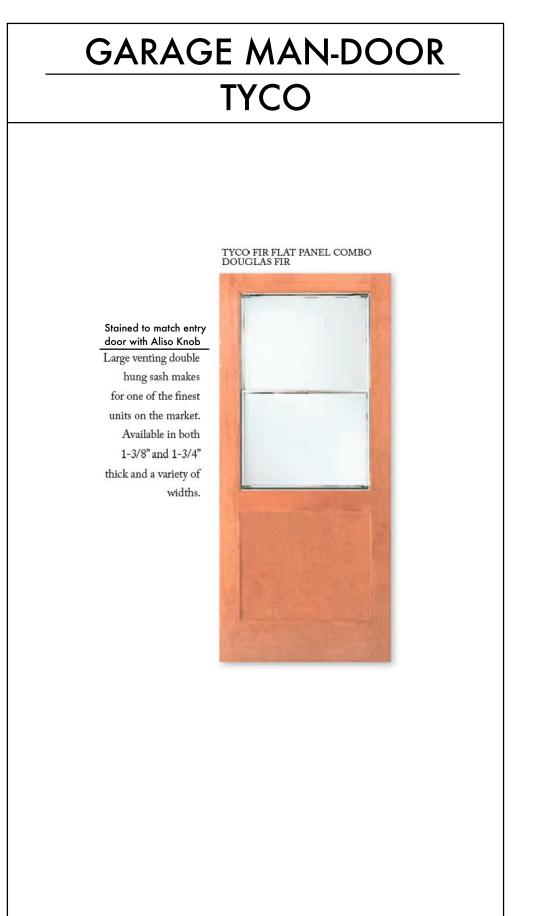



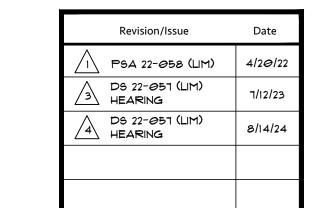

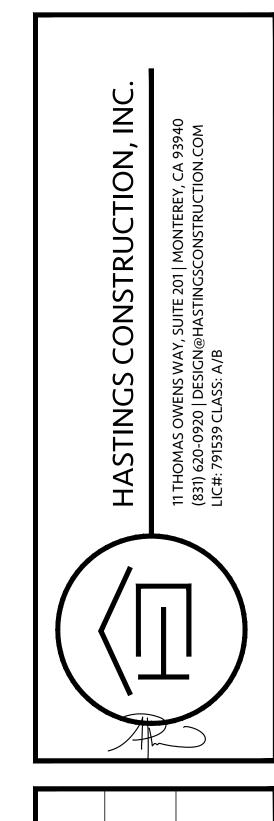

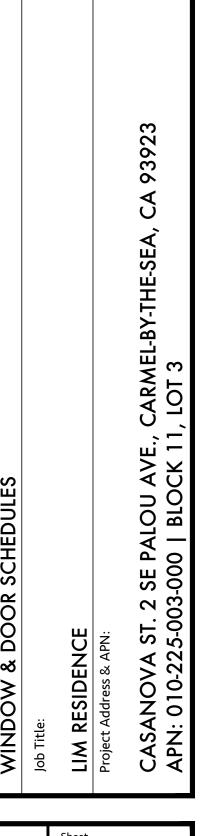

HC21007

9/17/2024

Scale: 1/4"=1'-0"



FRONT ELEVATION - VIEW FROM CASANOVA FACING EAST



A REAR ELEVATION - VIEW FACING WEST

Revision/Issue	Date
DS 22-051 (LIM) COMMENTS	10/24/22
DS 22-051 (LIM) HEARING	7/12/23
DS 22-051 (LIM) HEARING	8/14/24




ROPOSED FRONT ELEVATION - 3D RENDERING

bb Title:

IM RESIDENCE

oject Address & APN:

ASANOVA ST. 2 SE PALOU AVE., CARMEL-BY-THE-SEA, CA 93923

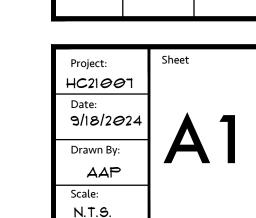




STREETSCAPE - PROPOSED



STREETSCAPE - EXISTING

Re	vision/Issue	Date
/I Ps	4 22- <i>0</i> 58 (LIM)	4/20/22
/2\	22- <i>0</i> 57 (LIM) MMENTS	10/24/22
/ 2\	22-057 (LIM) ARING	7/12/23
/ /\	22-057 (LIM) ARING	8/14/24

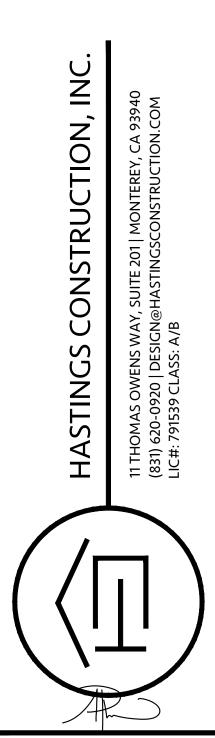

Diawilly litter.	
STREETSCAPE ELEVATIONS	
Job Title:	
LIM RESIDENCE	
Project Address & APN:	
CASANOVA ST. 2 SE PALOU AVE., CARMEL-BY-THE-SEA, CA 93923 APN: 010-225-003-000 BLOCK 11, LOT 3	