

## NOTICE OF APPLICATION SUBMITTAL


The Department of Community Planning & Building of the City of Carmel-by-the-Sea has received an application for a Design Study Track 1 Major staff-level project. As a courtesy, this Notice of Application Submittal is being distributed immediately adjacent property owners. Any persons interested in the project are encouraged to contact the Project Planner listed below at (831) 620-2027 or ctarone@ci.carmel.ca.us.

Planning Application: DS 20-346 (Howley) Location: 26185 Dolores Street
Date Mailed: 12/17/2020 Project Planner: Catherine Tarone, Assistant Planner
Block: 9 Mission Tract, Lot: 2; APN: 009-382-019 Applicant: Dyar Architecture

**Project Description** Consideration of a Track 1 Major Design Study application for: 1) Raise roof over Master Bedroom by 2'-11" and raise the roof of the entire residence by 1'. The area and height of all new additions will be staked and flagged in the coming weeks so that the proposed height is visible. 2) New windows and doors. 3) A new board-form concrete front deck. 4) A remodel of the façade of the residence using new horizontal wood siding and fascia, refinishing of existing stucco, reroof with light grey, TPO membrane roofing. 4) The addition of 96 square feet of floor area to be located under existing roof eaves and at the rear of the property and in the interior patio. Please refer to plans as the floor area to be added is distributed in several locations. The additions are shown on sheet 1 of the plans with diagonal hatching. 5) Site work, including a reduction in total site coverage, a new front wood deck and fire pit and courtyard patio integral-color concrete pavers. 6) The addition of 6 new skylights with interior shades. This application is currently under review by the Carmel Planning Department.

Plans are available on the City's website at <u>https://ci.carmel.ca.us/post/current-planning-applications.</u>

Is this project appealable to the Coastal Commission? No

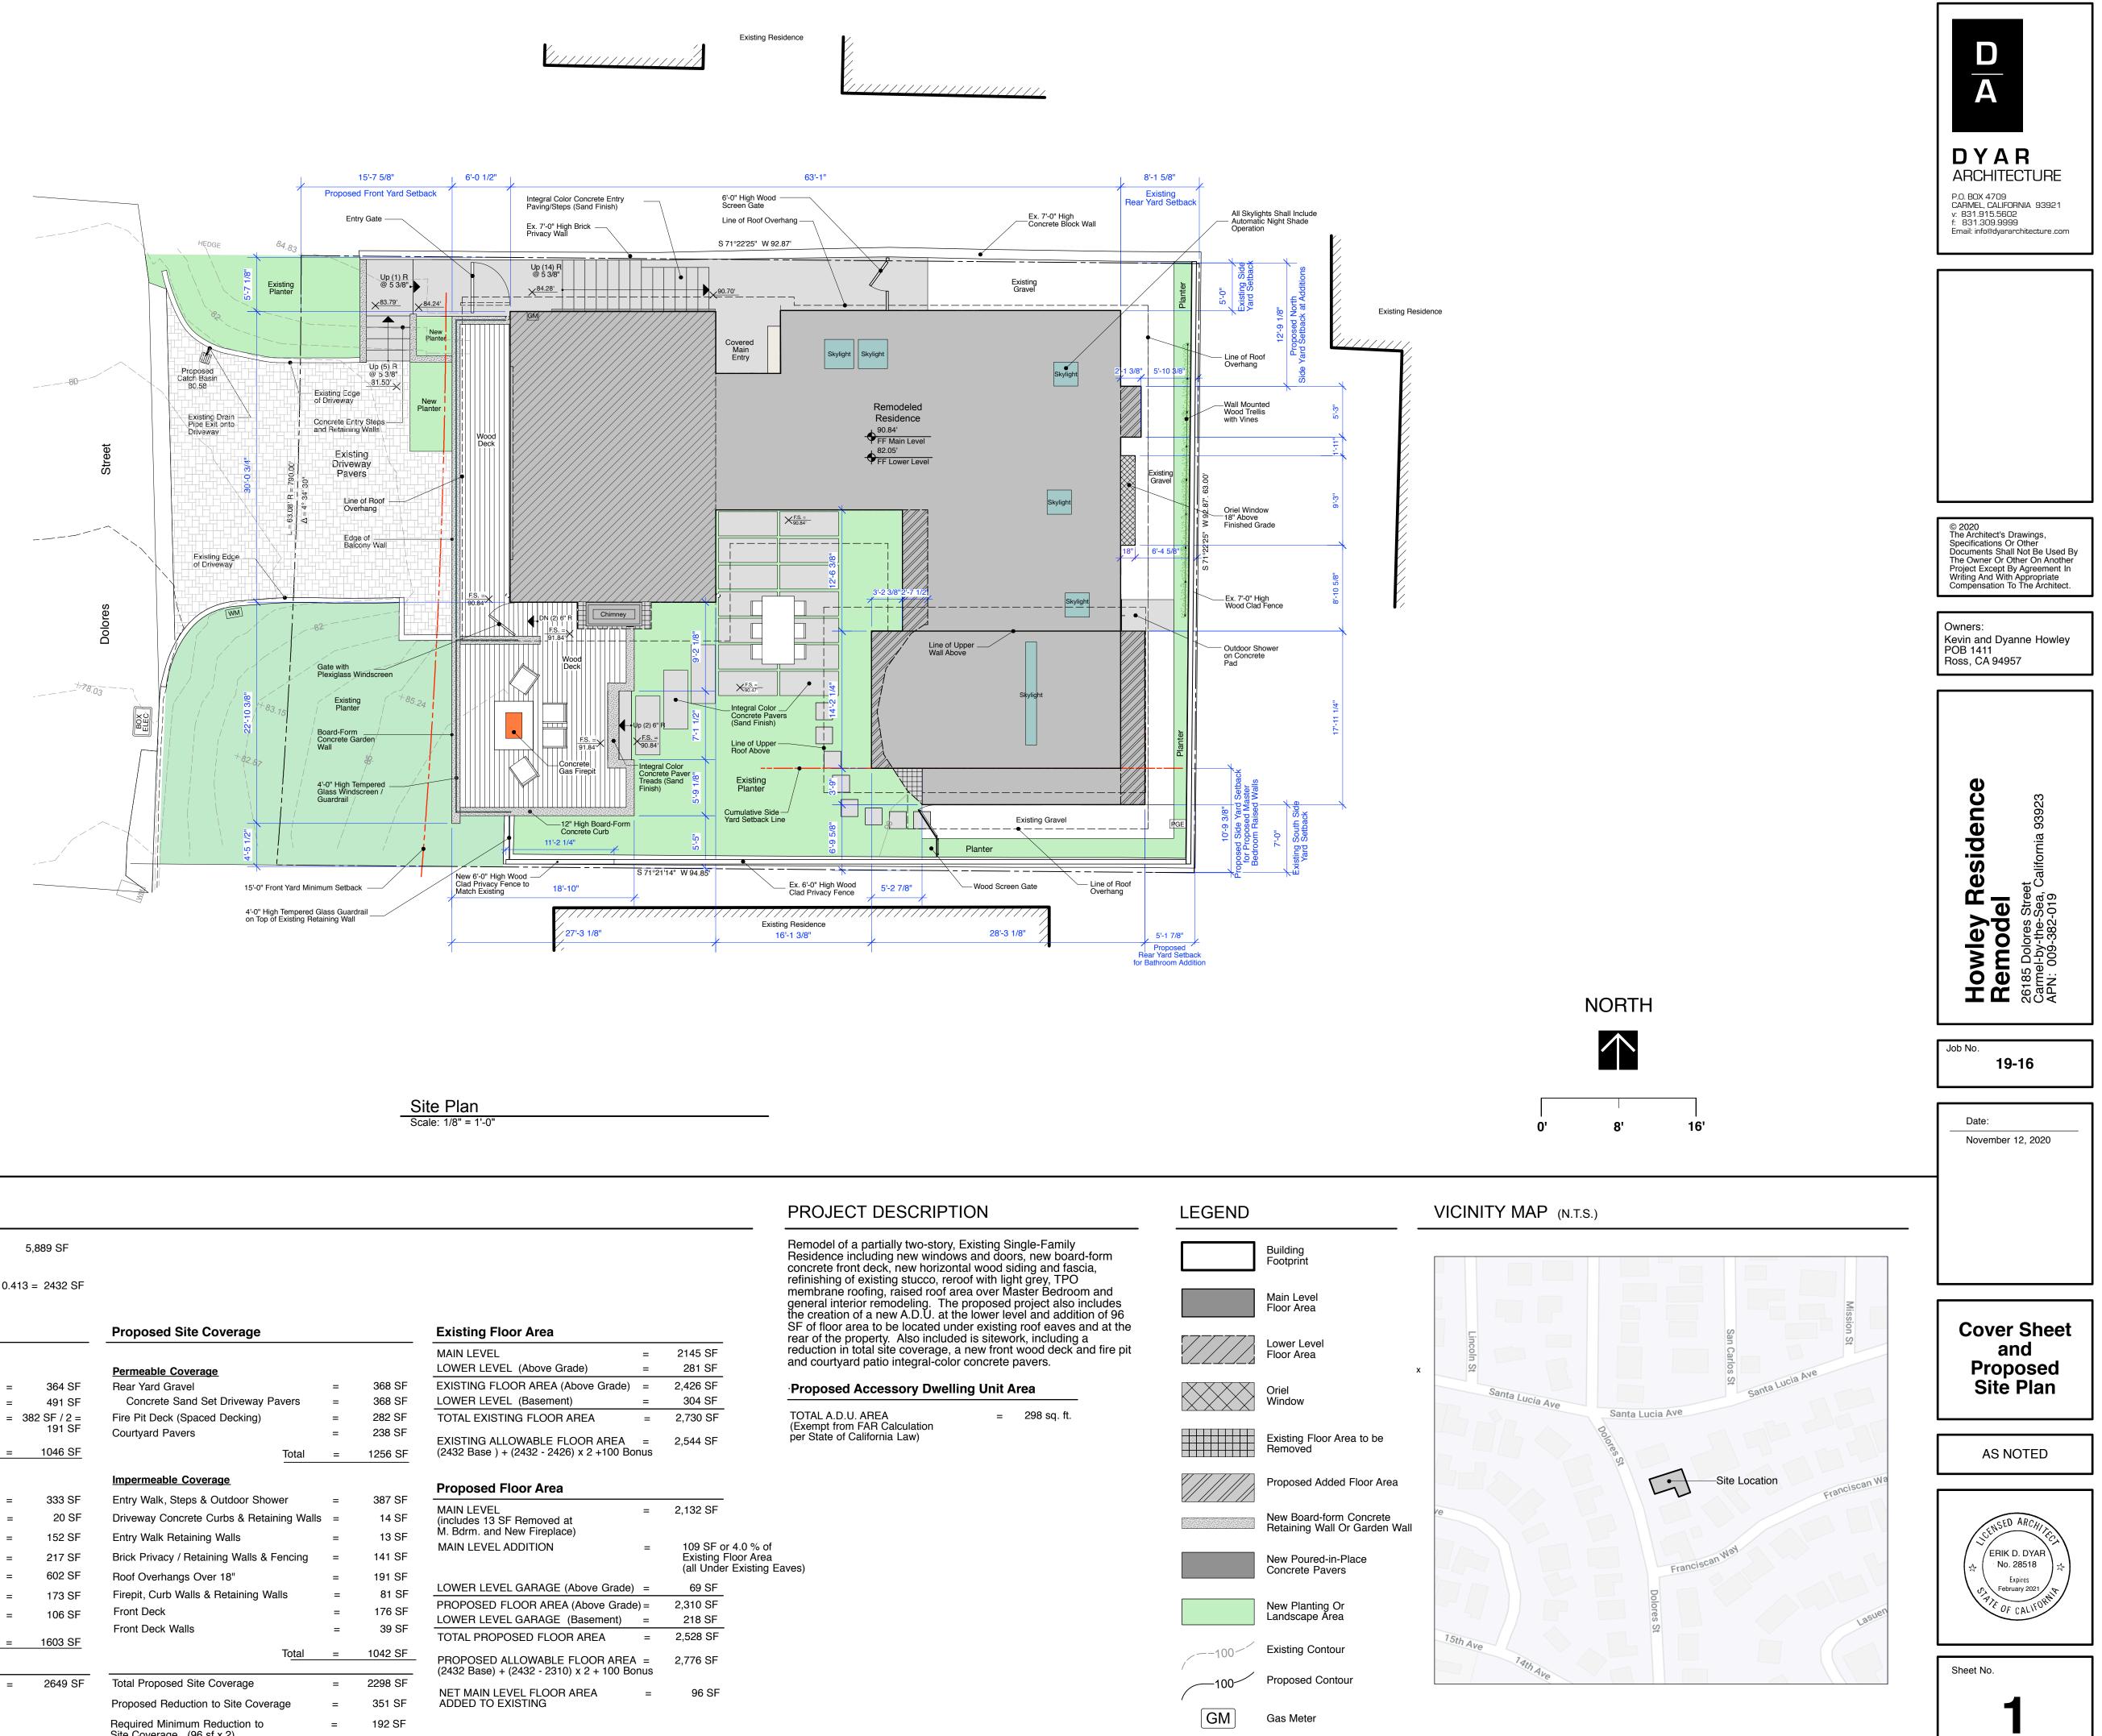

## PROJECT DATA


PROPERTY OWNER:	Kevin and Dyanne Howley POB 1411	EXISTING LOT AREA: =	=	5,889 SF	
	Ross, CA 94957	BASE FLOOR AREA:			
ARCHITECT/ APPLICANT:	Dyar Architecture P.o. Box 4709 Carmel, Ca. 93921 Contact: Erik Dyar	5889 x (0.45 - (1889 x 0.02 / 1000)) = 5889 x	(0.41	3 = 2432 SF	
	Ph: 831-915-5602	Existing Site Coverage			Proposed Site Coverage
PROJECT ADDRESS:	26185 Dolores Carmel-by-the-Sea , CA 93921	Permeable Coverage			Permeable Coverage
APN:	009-382-019	Rear Yard Gravel	=	364 SF	Rear Yard Gravel
ZONING:	R-1-BR	Concrete Sand Set Driveway Pavers	=	491 SF	Concrete Sand Set Driveway Pavers
PROJECT CODE COMPLIANCE:	2019 CBC, CRC, CPC, CEC, CMC, CFC,	50% Courtyard Gravel Planting Bed (50% Permeable Site Coverage)	= :	382 SF / 2 = 191 SF	Fire Pit Deck (Spaced Decking) Courtyard Pavers
	California Energy Code & California Green Building Code	Total	=	1046 SF	Total
OCCUPANCY GROUP:	R-3	Impermeable Coverage			Impermeable Coverage
CONSTRUCTION TYPE:	VB	Entry Walk And Steps	=	333 SF	Entry Walk, Steps & Outdoor Shower
TOPOGRAPHY:	Sloping To West	Driveway Concrete Curbs & Retaining Walls	=	20 SF	Driveway Concrete Curbs & Retaining Walls
		Brick Privacy / Retaining Walls & Fencing	=	152 SF	Entry Walk Retaining Walls
TREE REMOVAL:	None	Roof Overhangs Over 18"	=	217 SF	Brick Privacy / Retaining Walls & Fencing
GRADING:	Cut: 16 CY Fill: 16 CY	Concrete Courtyard Terrace	=	602 SF	Roof Overhangs Over 18"
		Rear and Side Yard Concrete Walk	=	173 SF	Firepit, Curb Walls & Retaining Walls
		Front Cantilevered Deck	=	106 SF	Front Deck
					Front Deck Walls
		Total	=	1603 SF	Total


Total Existing Site Coverage

Required Minimum Reduction to Site Coverage. (96 sf x 2)




	Existing Floor Area		
	MAIN LEVEL	=	2145 SF
	LOWER LEVEL (Above Grade)	=	281 SF
368 SF	EXISTING FLOOR AREA (Above Grade)	=	2,426 SF
368 SF	LOWER LEVEL (Basement)	=	304 SF
282 SF	TOTAL EXISTING FLOOR AREA	=	2,730 SF
238 SF 1256 SF	EXISTING ALLOWABLE FLOOR AREA (2432 Base ) + (2432 - 2426) x 2 +100 Bor	= nus	2,544 SF
007.05	Proposed Floor Area		
387 SF 14 SF	MAIN LEVEL (includes 13 SF Removed at	=	2,132 SF
13 SF 141 SF	M. Bdrm. and New Fireplace) MAIN LEVEL ADDITION	=	109 SF or 4. Existing Floc (all Under Ex
191 SF	LOWER LEVEL GARAGE (Above Grade)	=	69 SF
81 SF	PROPOSED FLOOR AREA (Above Grade	) =	2,310 SF
176 SF	LOWER LEVEL GARAGE (Basement)	, _	218 SF
39 SF	TOTAL PROPOSED FLOOR AREA	=	2,528 SF
1042 SF	PROPOSED ALLOWABLE FLOOR AREA (2432 Base) + (2432 - 2310) x 2 + 100 Boi		2,776 SF
2298 SF 351 SF	NET MAIN LEVEL FLOOR AREA ADDED TO EXISTING	=	96 SF
192 SF			

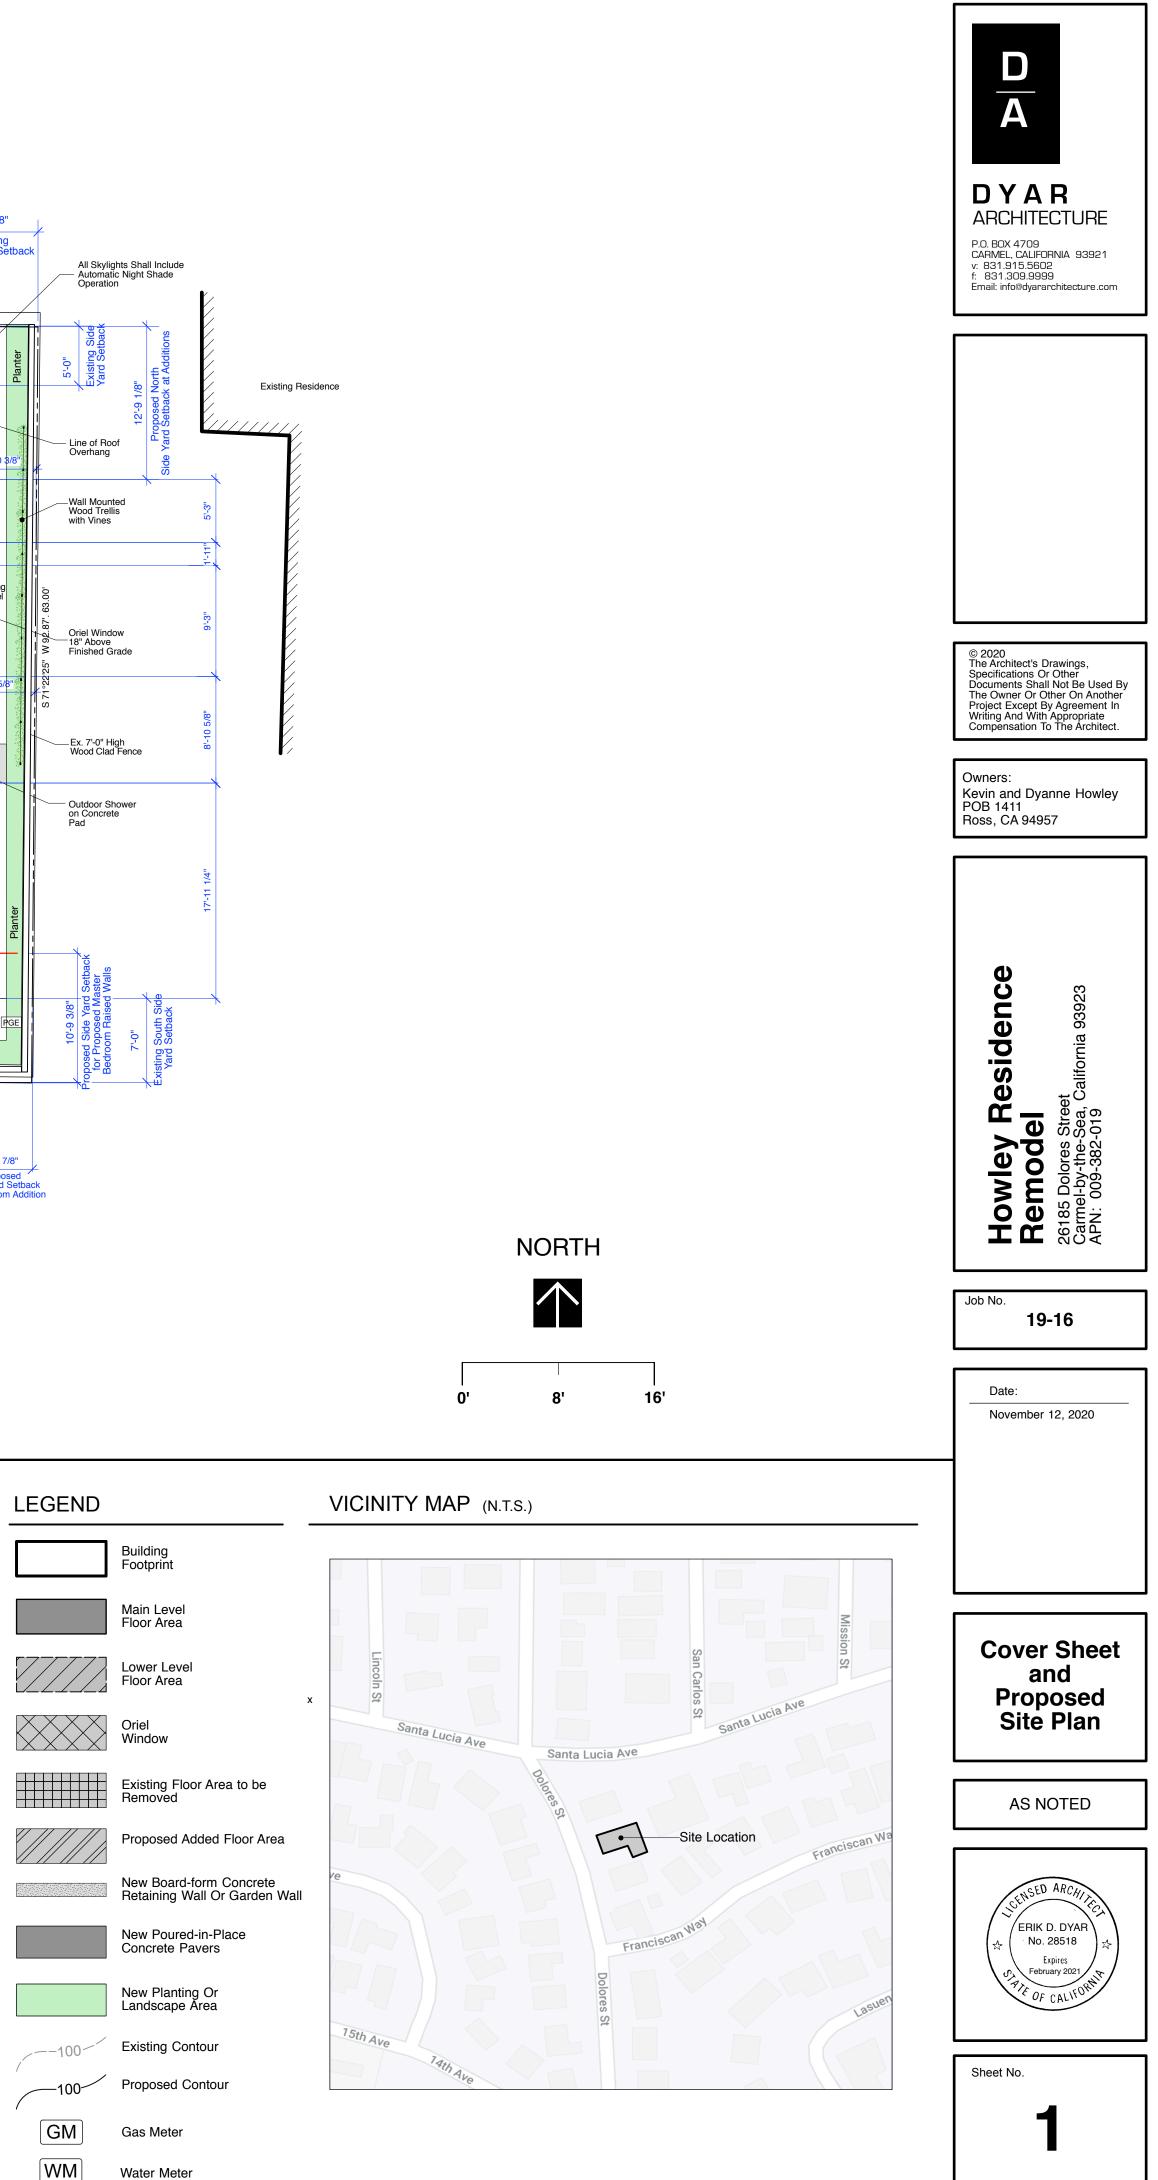

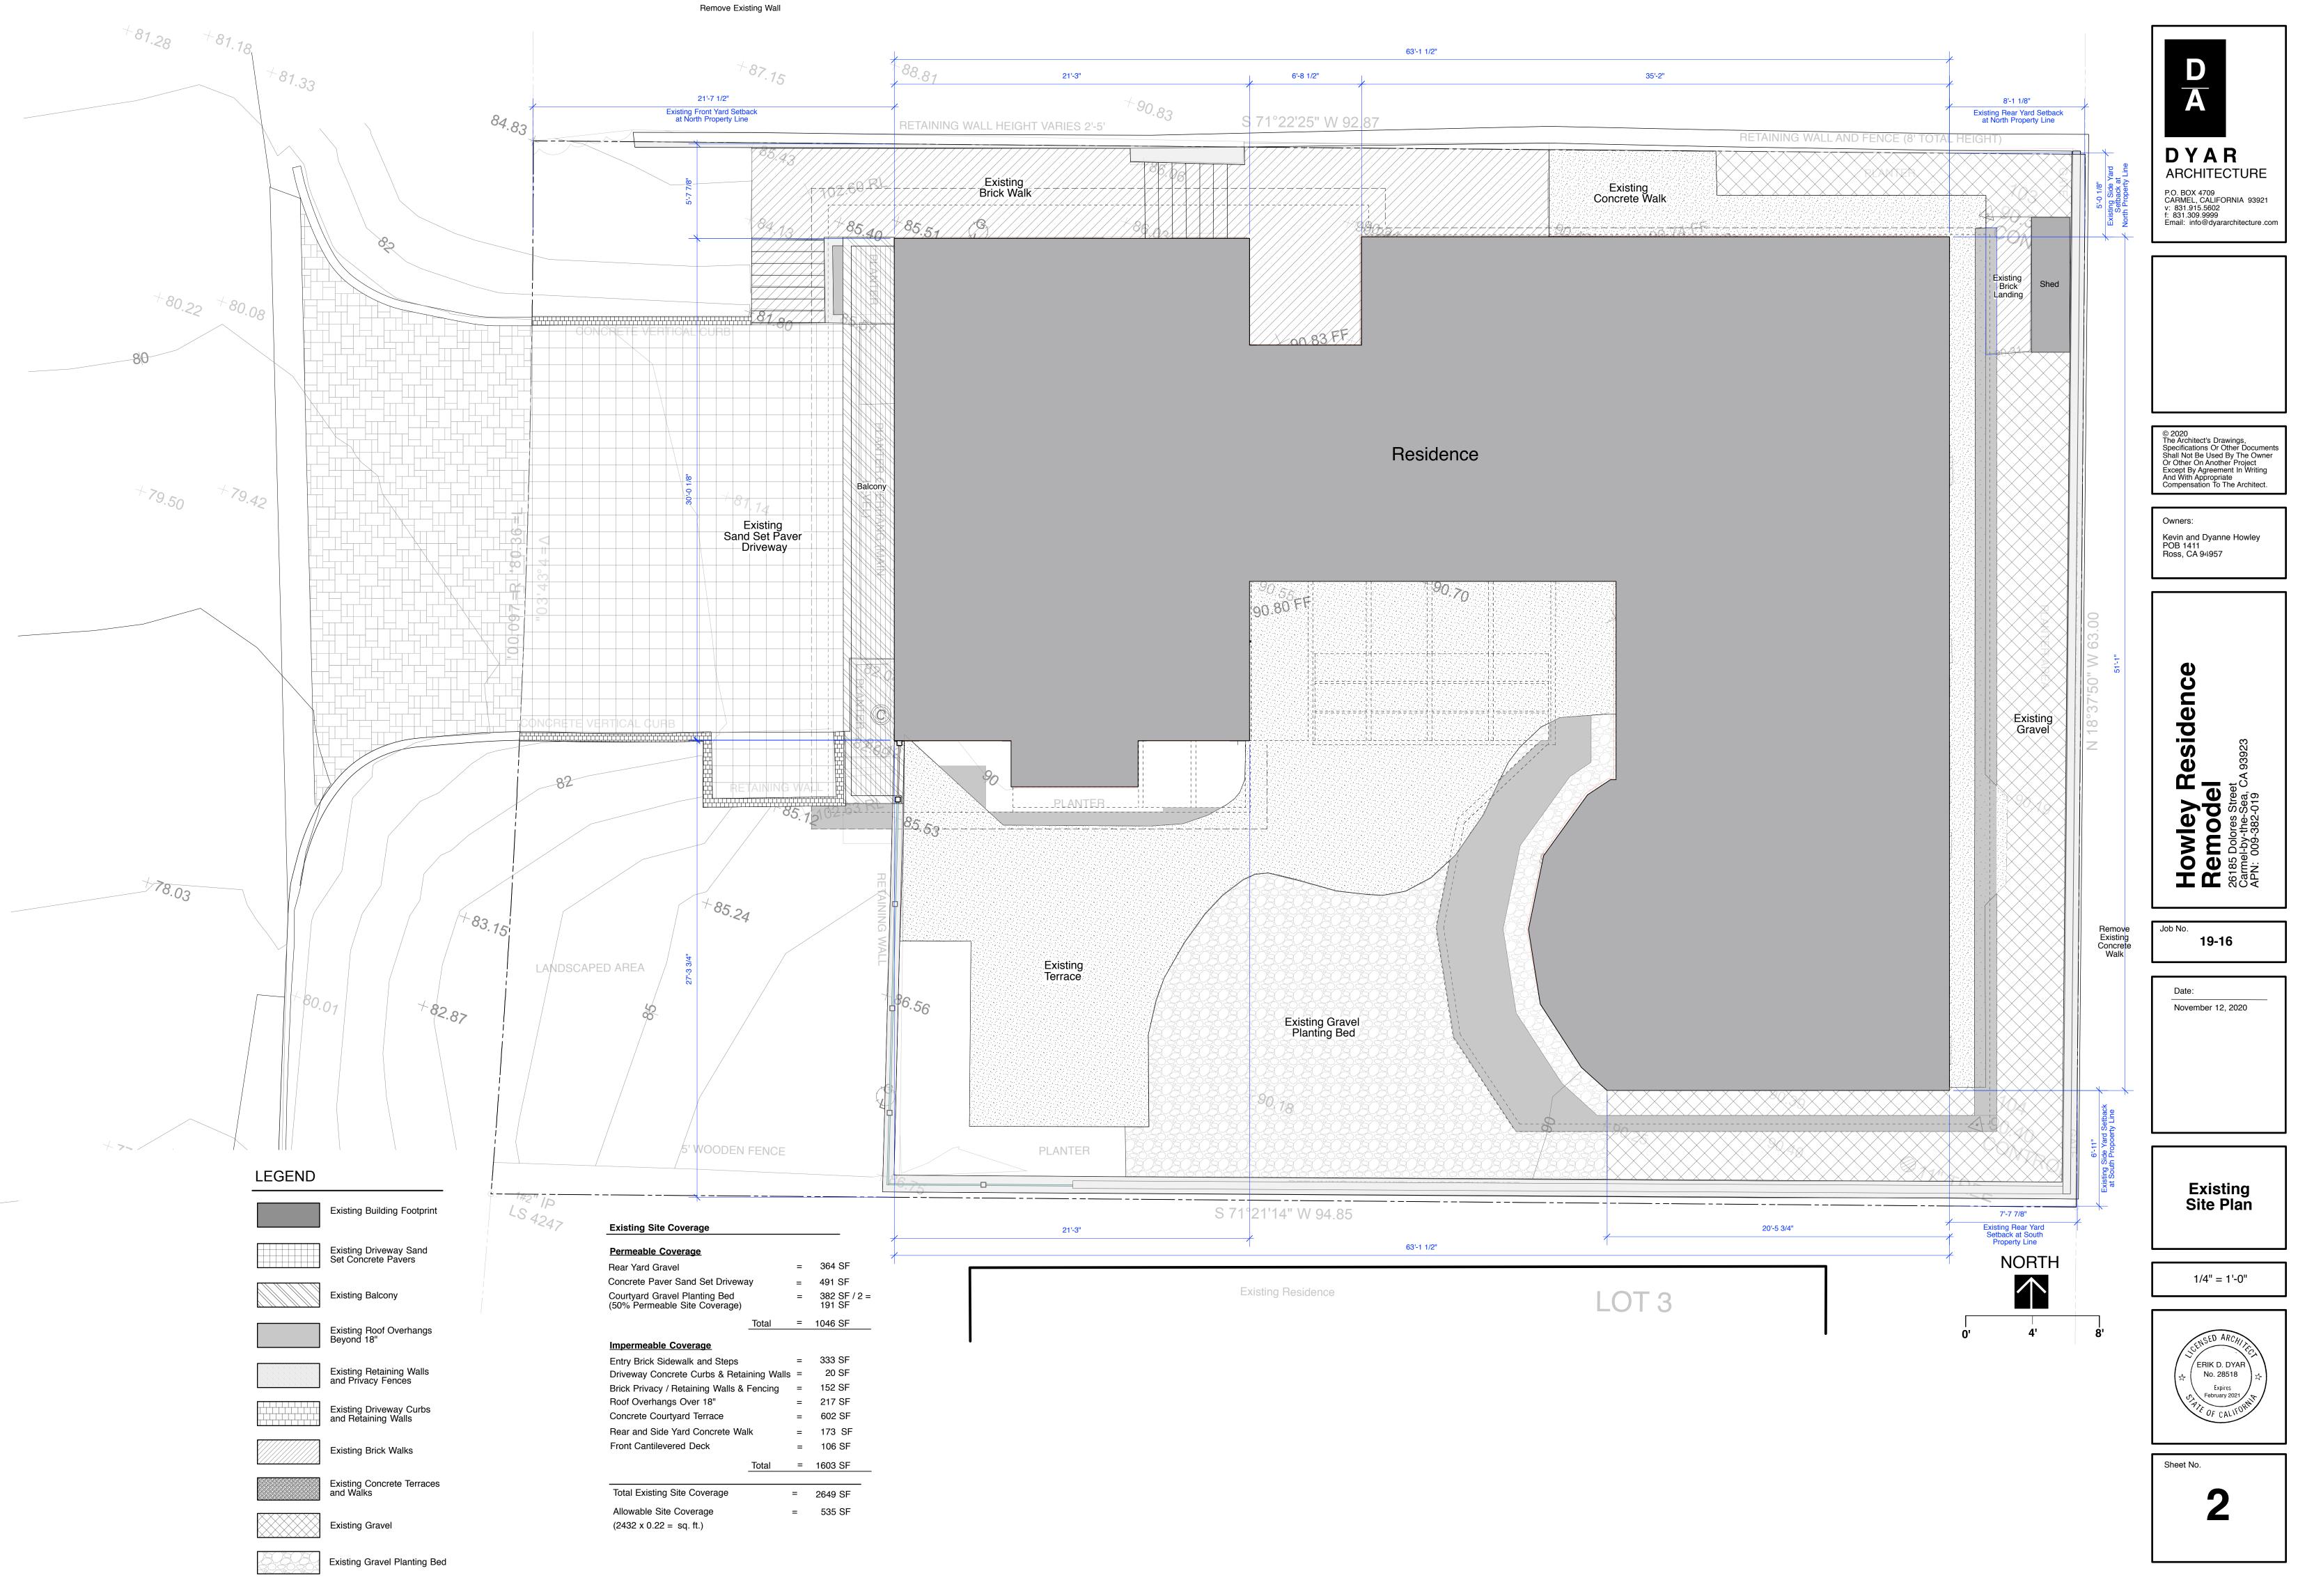



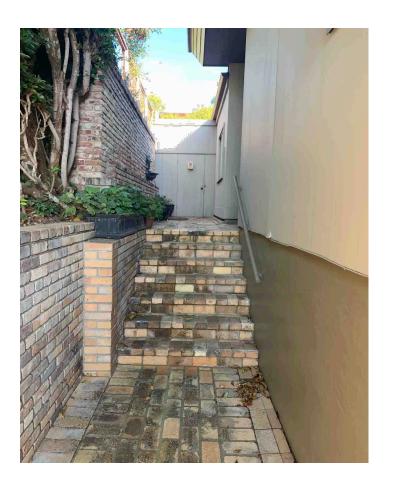

<u>Main Entry Steps</u>



North Side Yard



Courtyard From Gravel Planting Bed




<u>Courtyard</u>

Existing View From Dolores Street



East Rear Yard

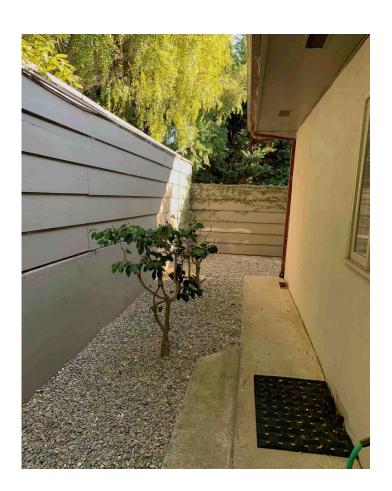







South Side Yard




Master Bedroom From Courtyard

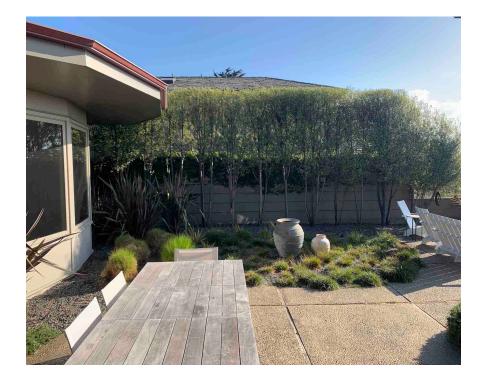

Planting Bed at South Property Line From Courtyard

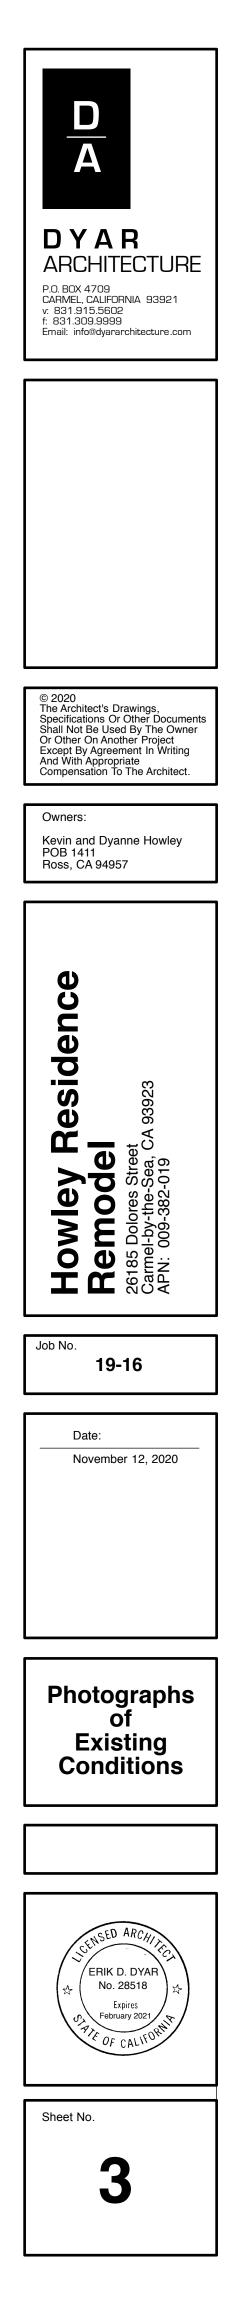




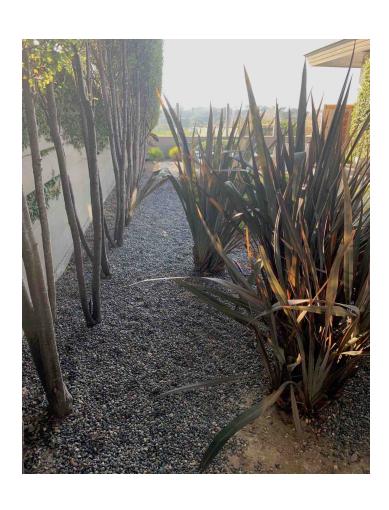


Courtyard Gravel Planting Bed




Viewing Terrace From Courtyard

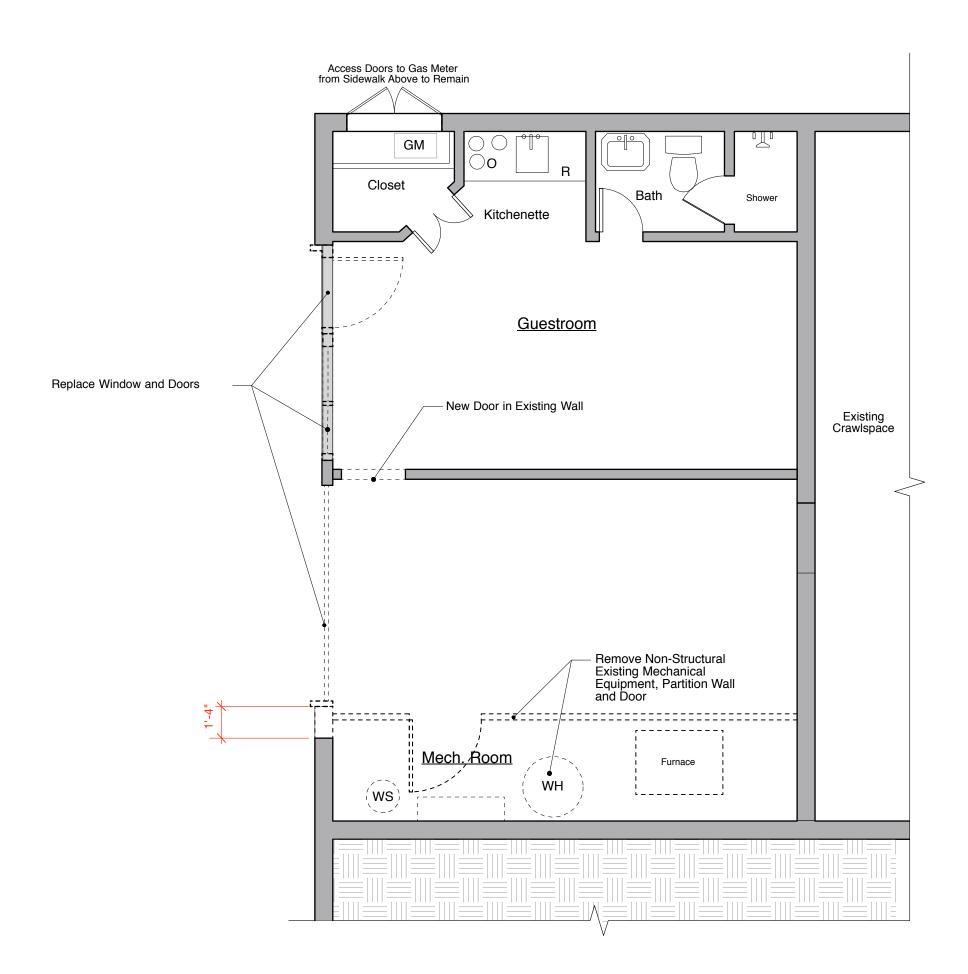

<u>Lower Level</u> <u>Take-Down Plan</u>

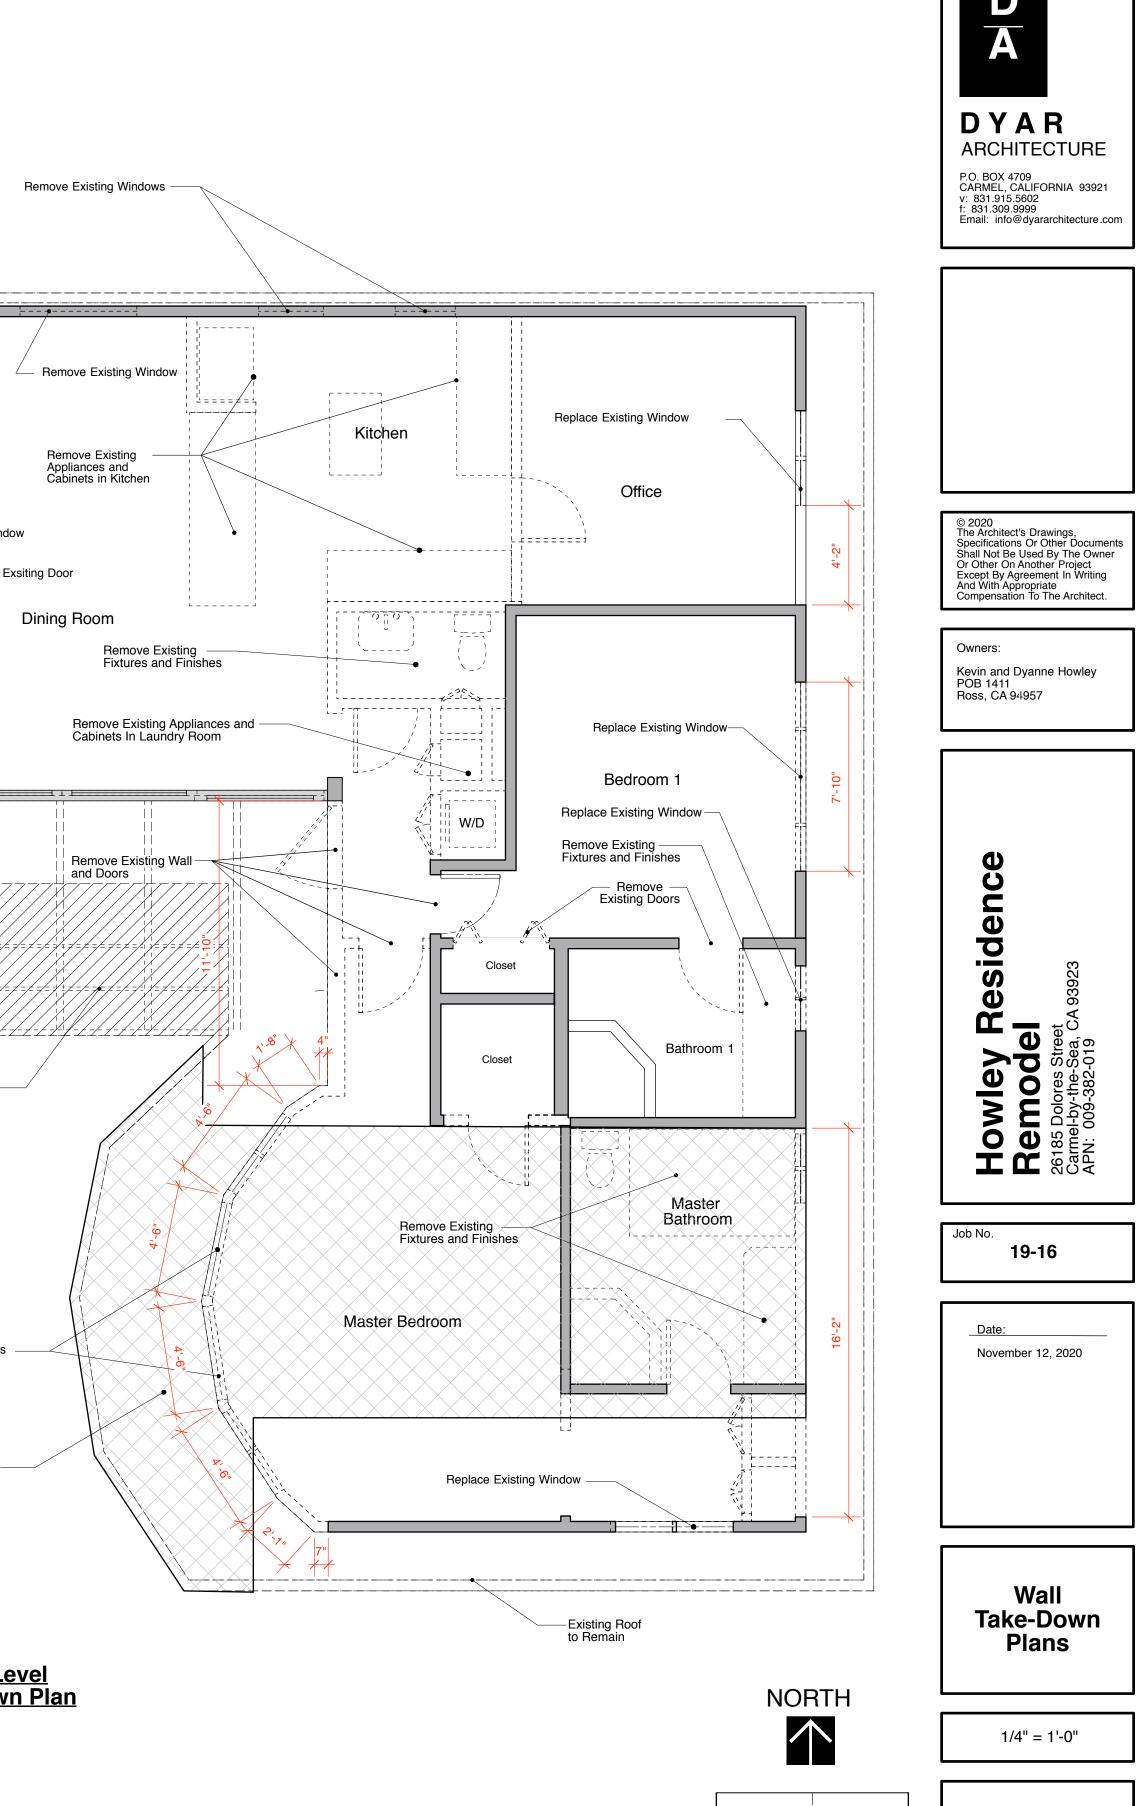

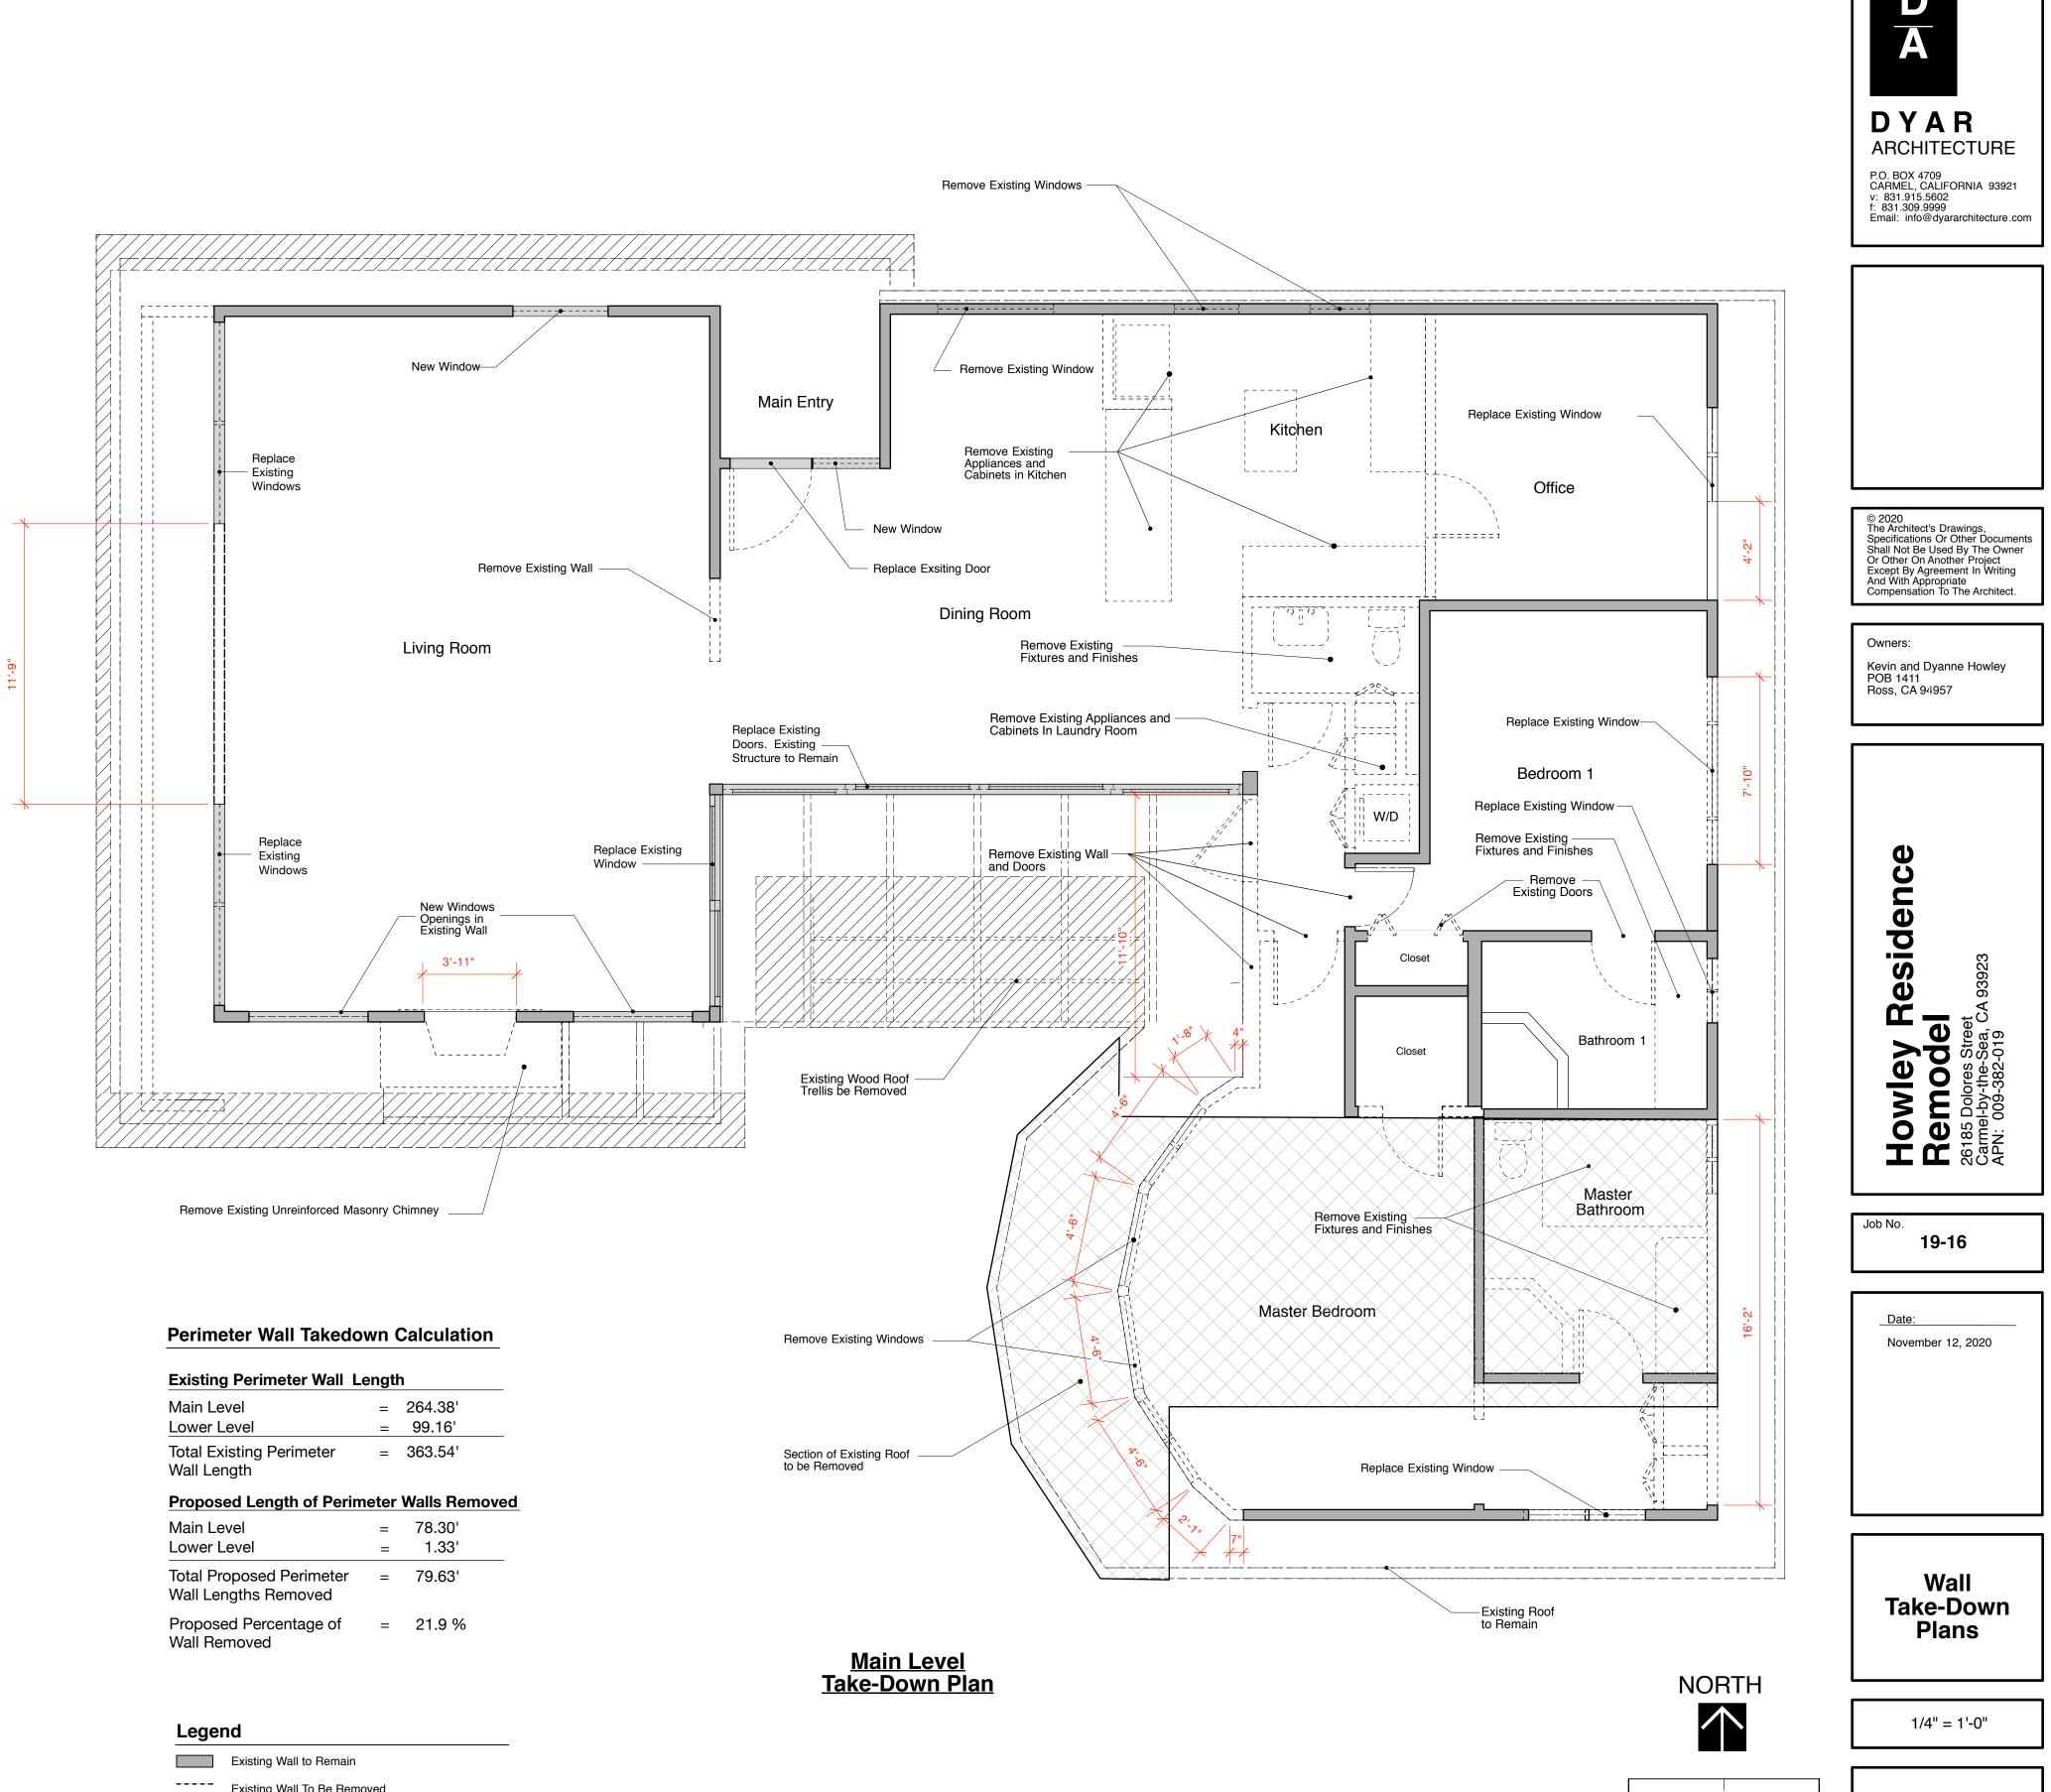


U	
	Existing Wall to Remain
	Existing Wall To Be Removed
	Line of Existing Element To Be Removed
	Section of Existing Roof to be Removed
[]]]	Section of Existing Roof Overhang to be Removed


ERIK D. DYAR No. 28518 Expires February 202 Sheet No. 4

4'

8'

0'

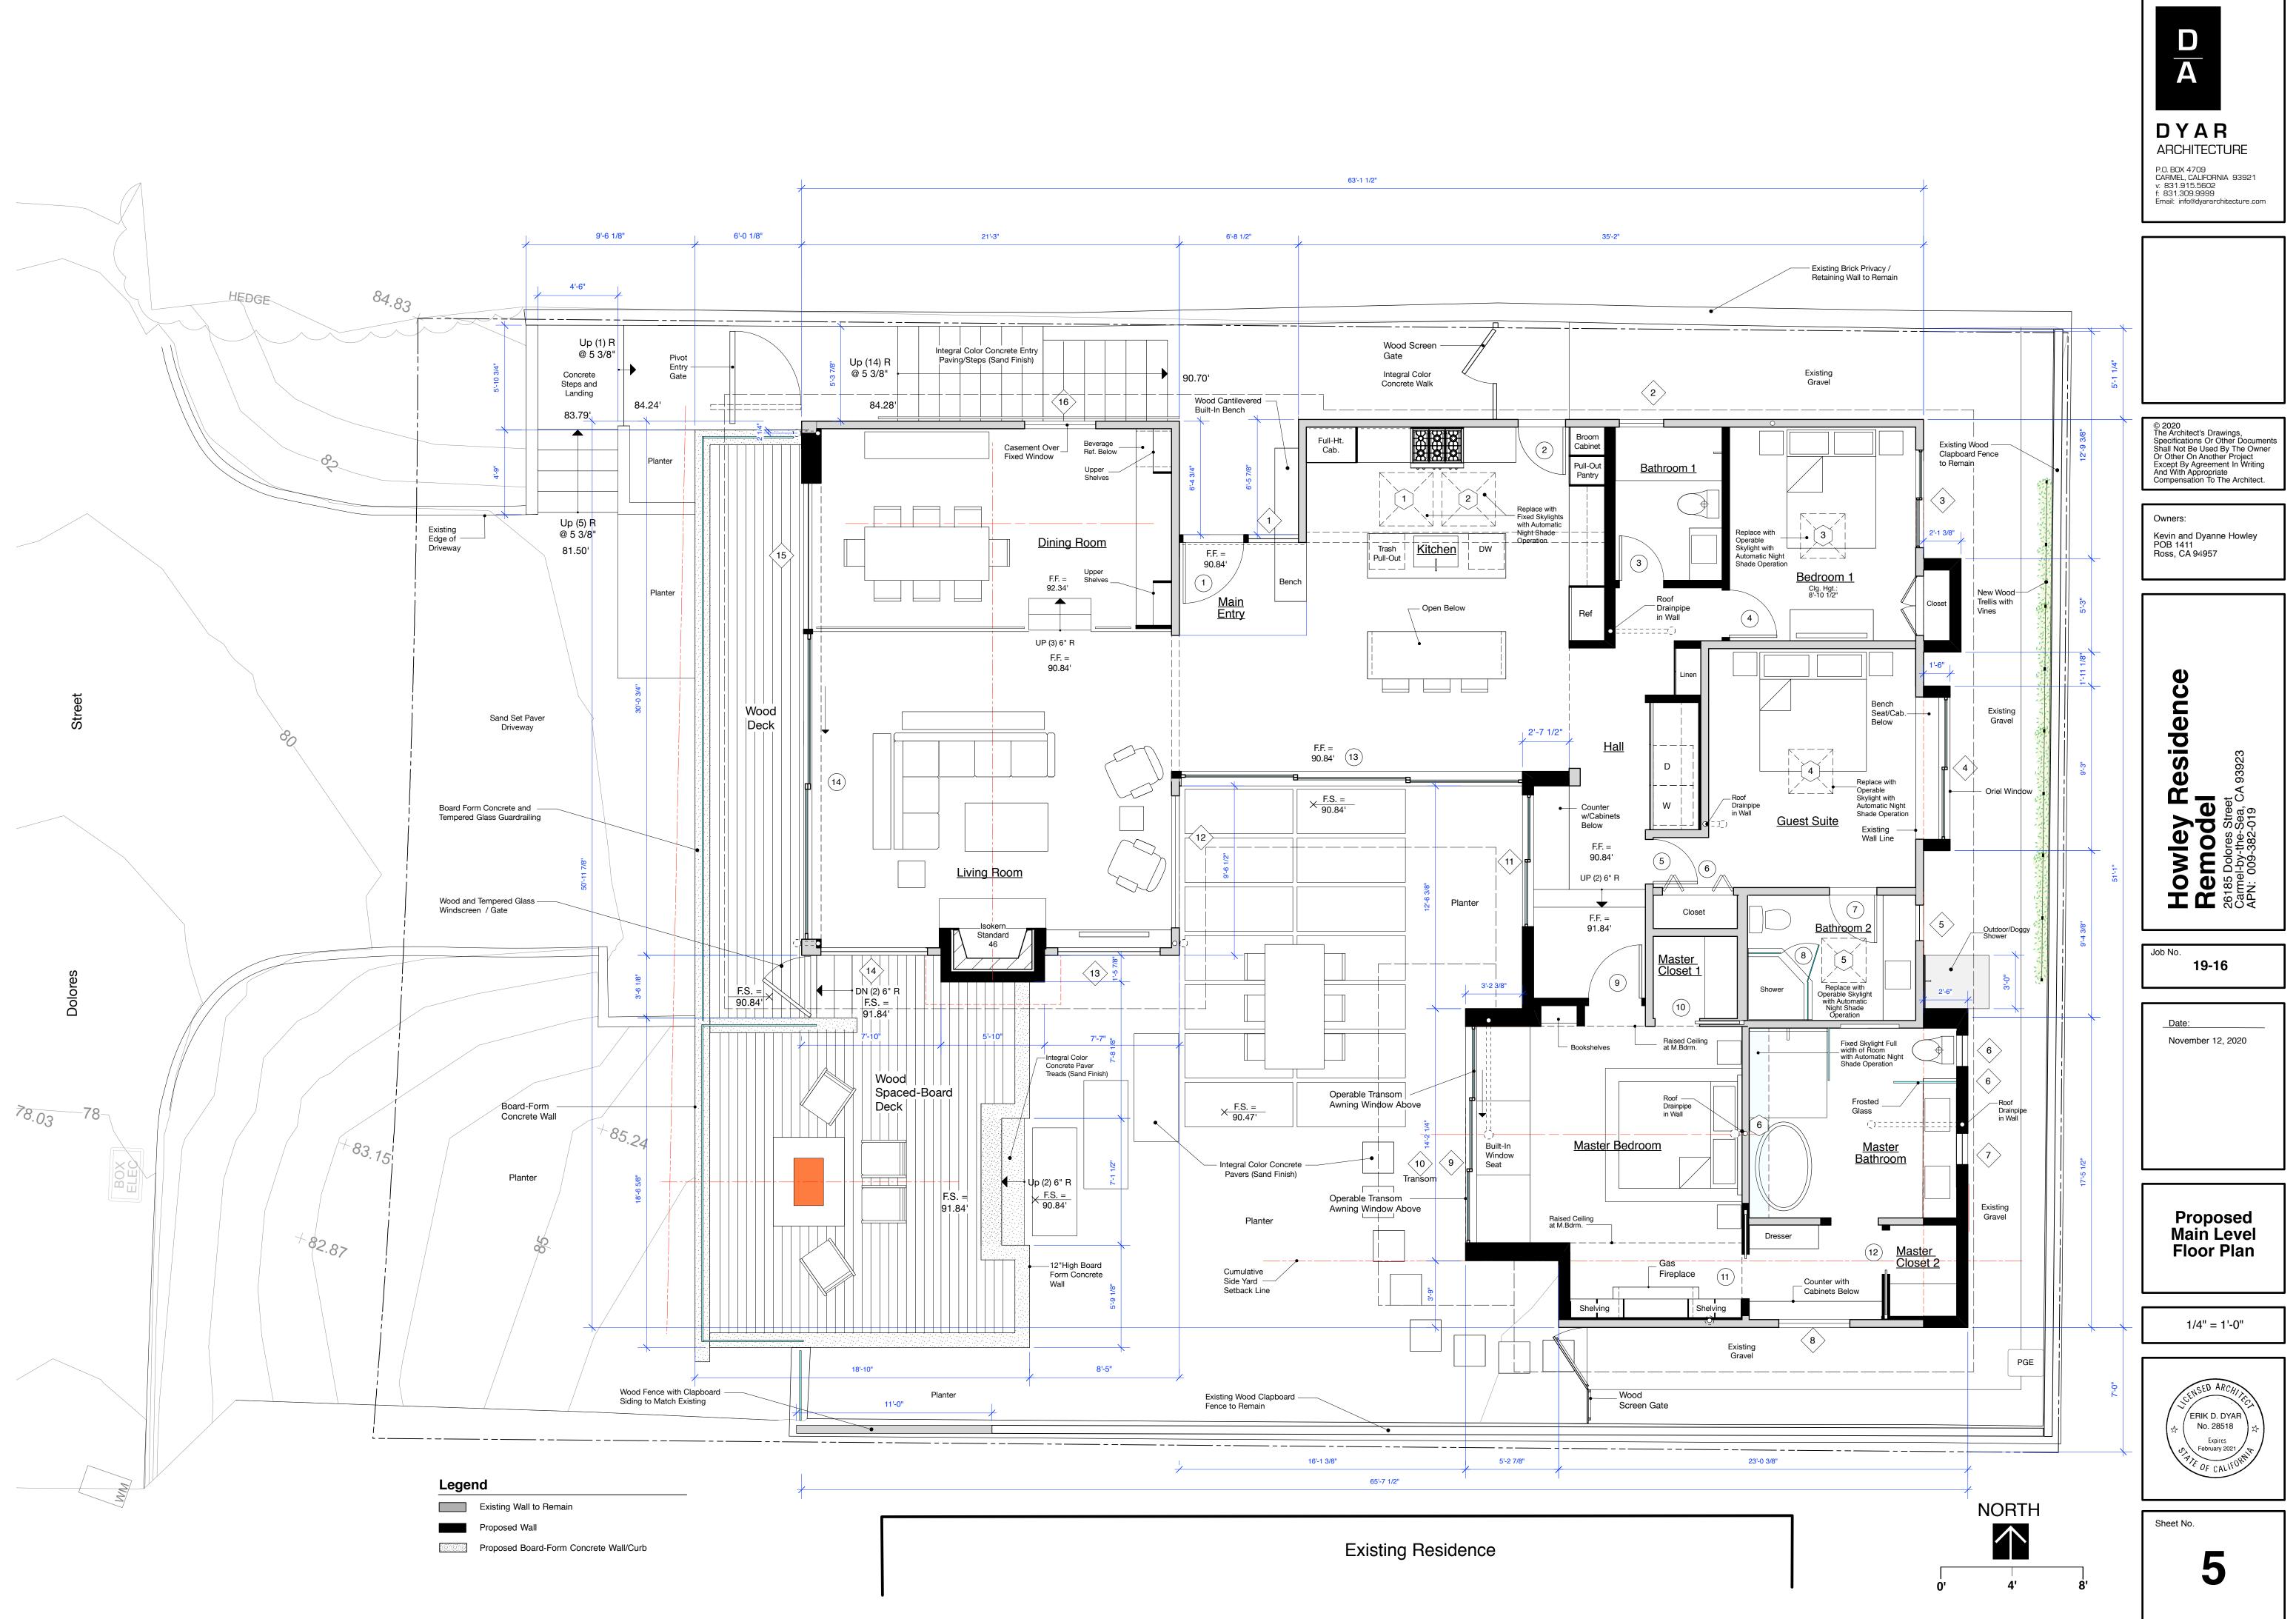

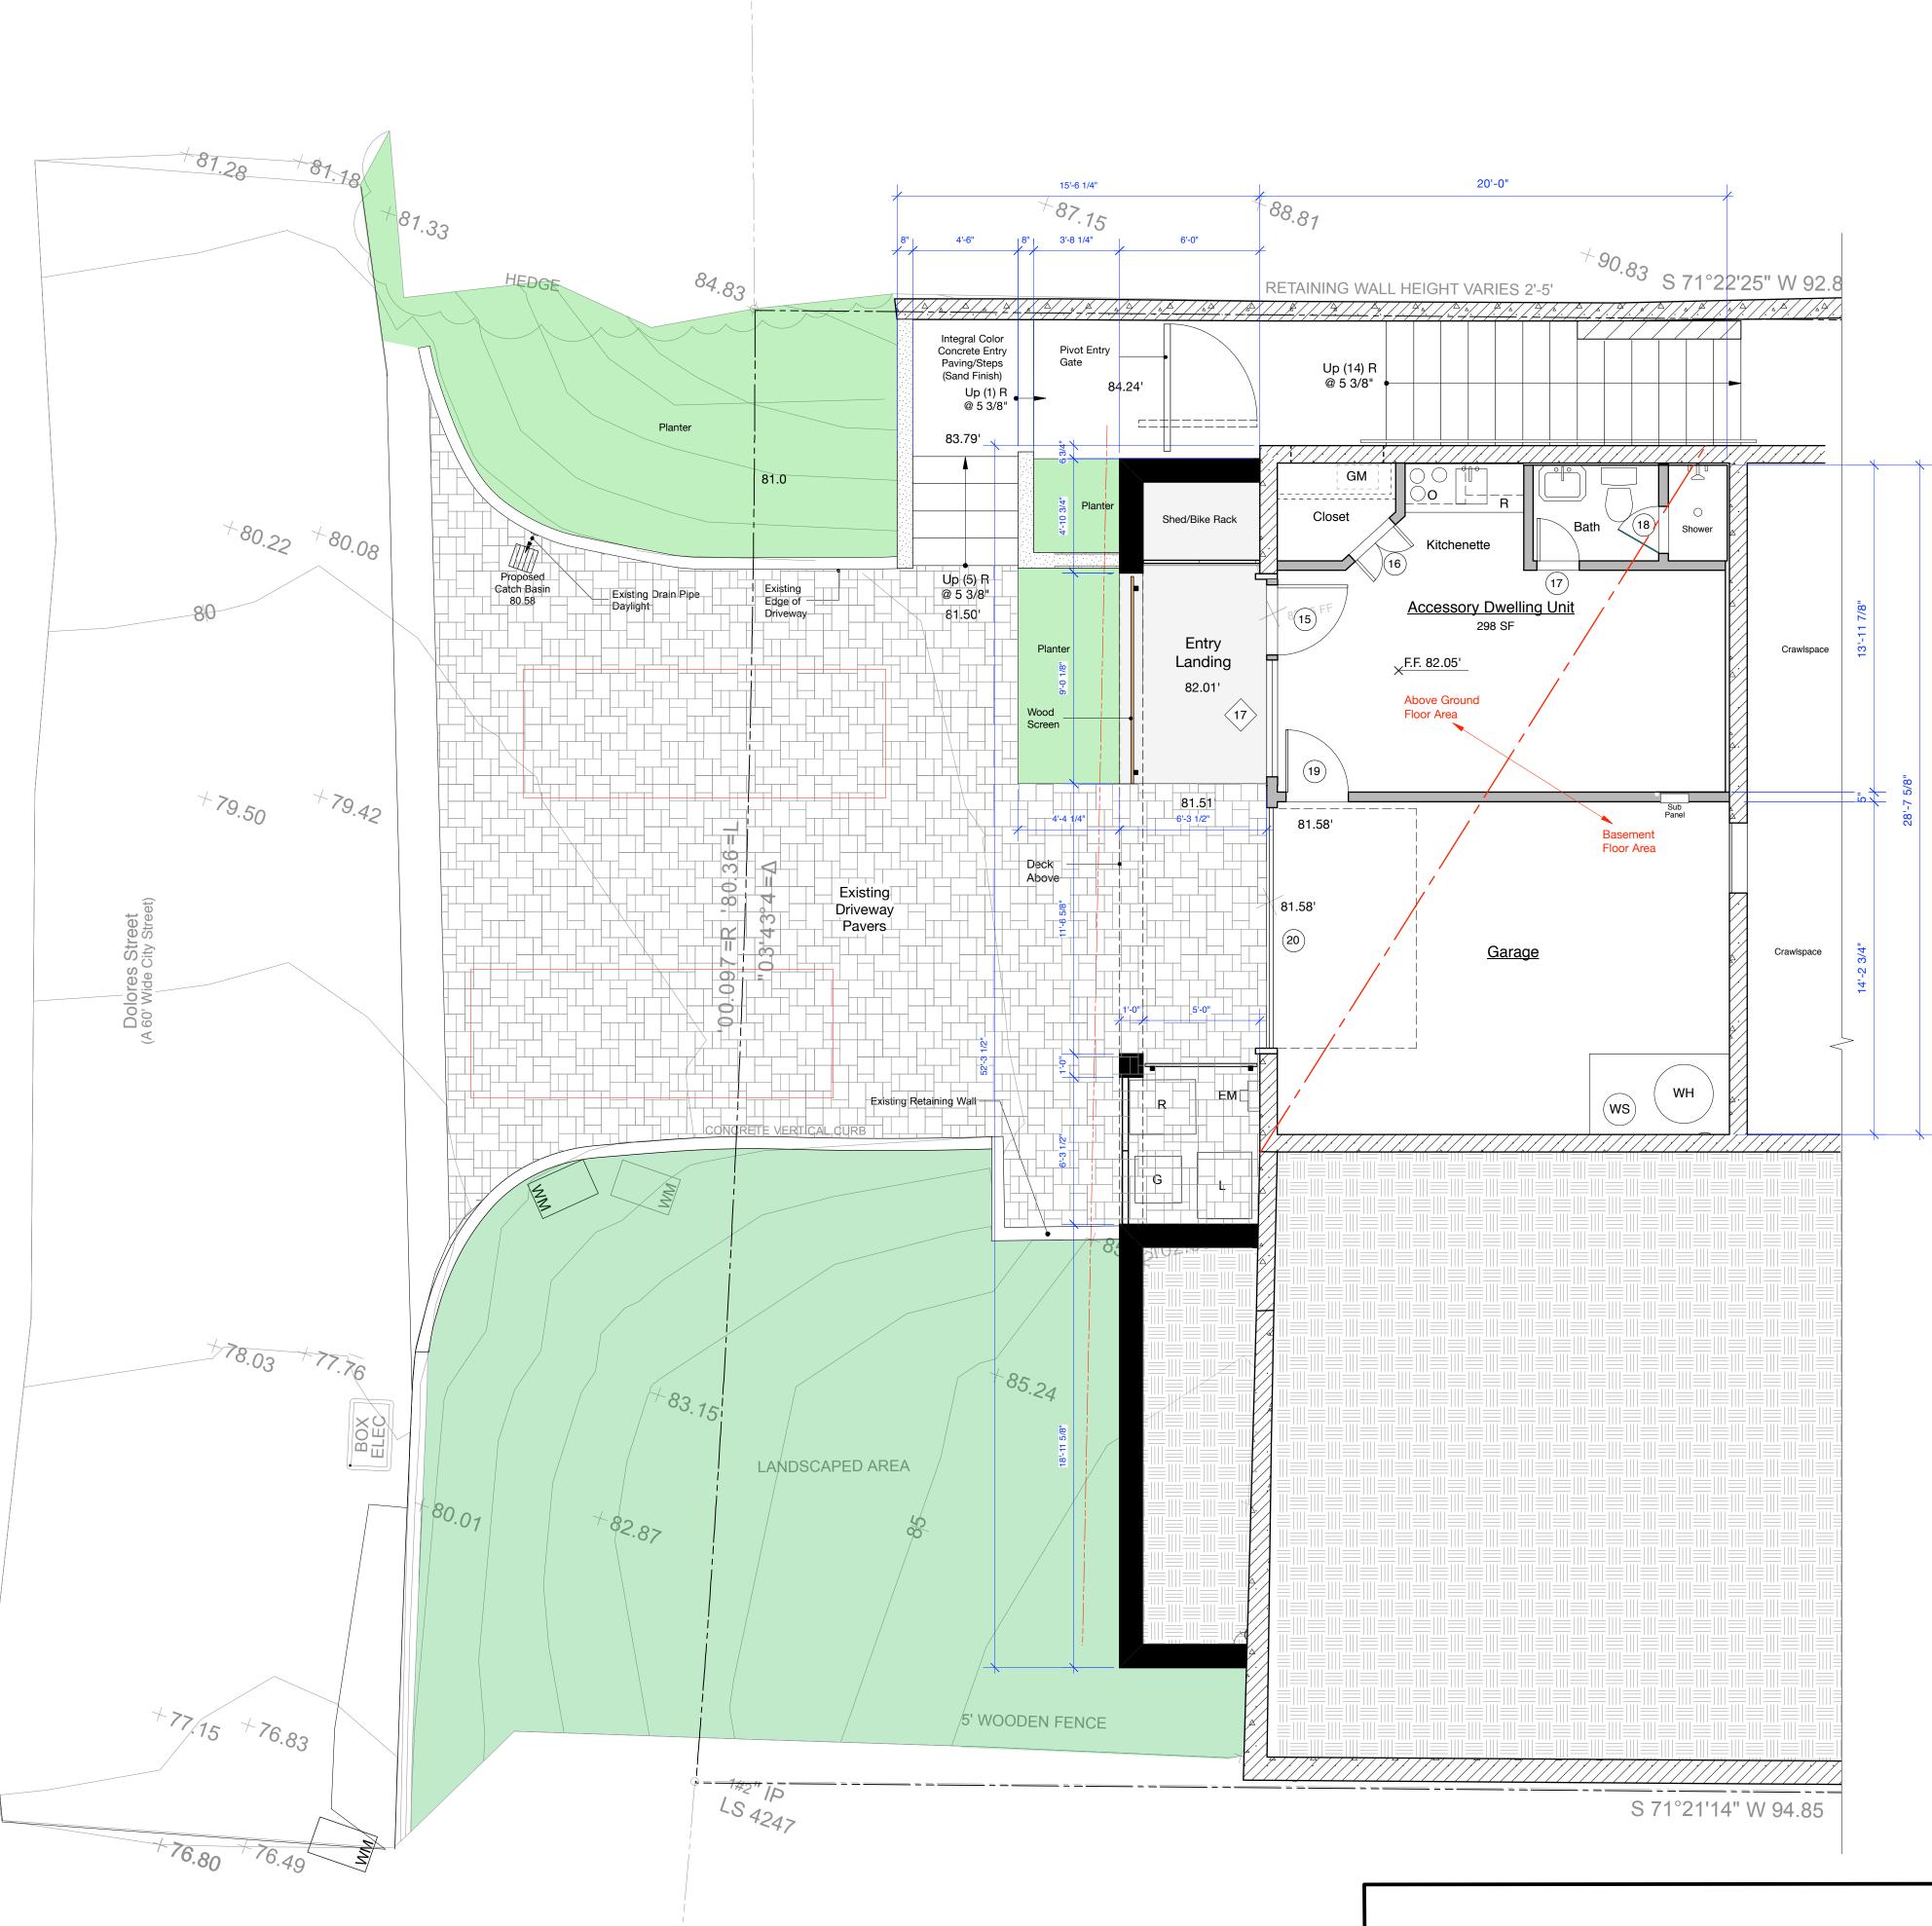


## Legend


Existing Wall to Remain
Existing Reinforced Concr
Proposed Deck/Garden W
Proposed Board Form Ga

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Howley Residence Remodel 26185 Dolores Street Carmel-by-the-Sea, CA 93923 APN: 009-382-019
Job No. <b>19-16</b> <u>Date:</u> November 12, 2020
Proposed Lower Floor Plan 1/4" = 1'-0"
ERIK D. DYAR No. 28518 Expires February 2021
6

forced Concrete Wall to Remain eck/Garden Wall oard Form Garden Wall

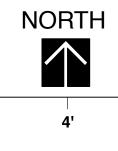

0'

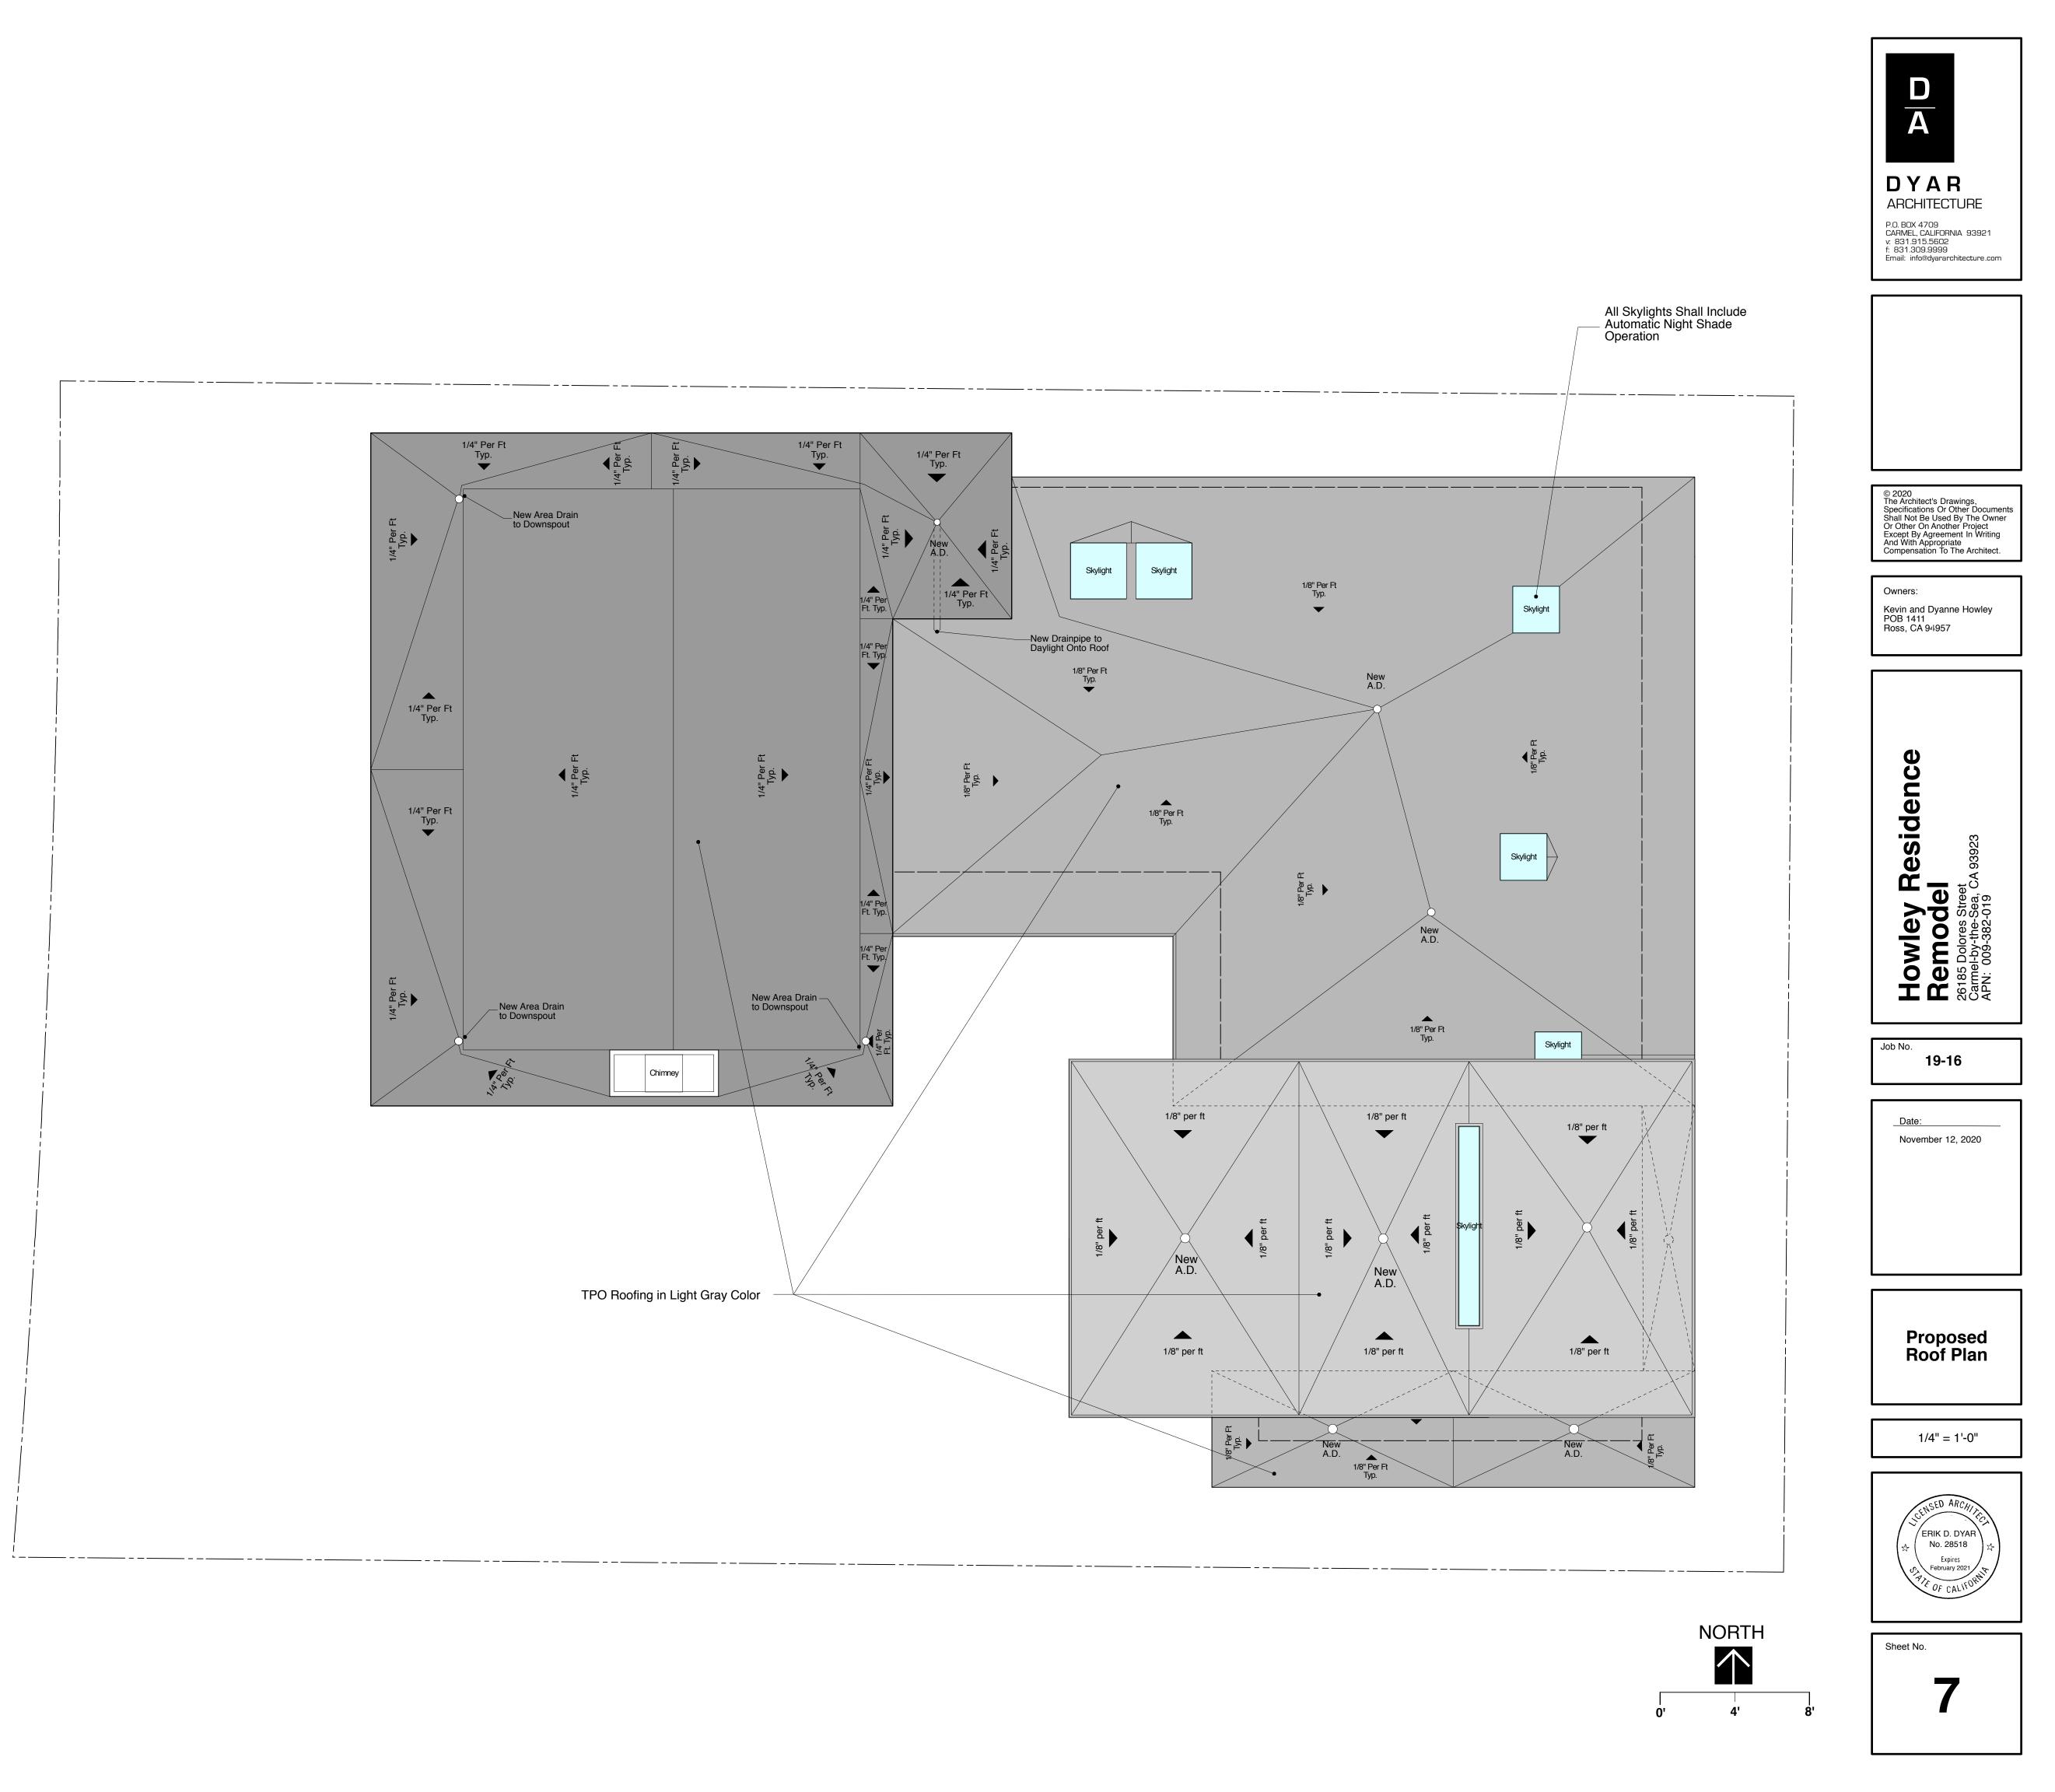












# 1 EXISTING DOLORES STREET ELEVATION

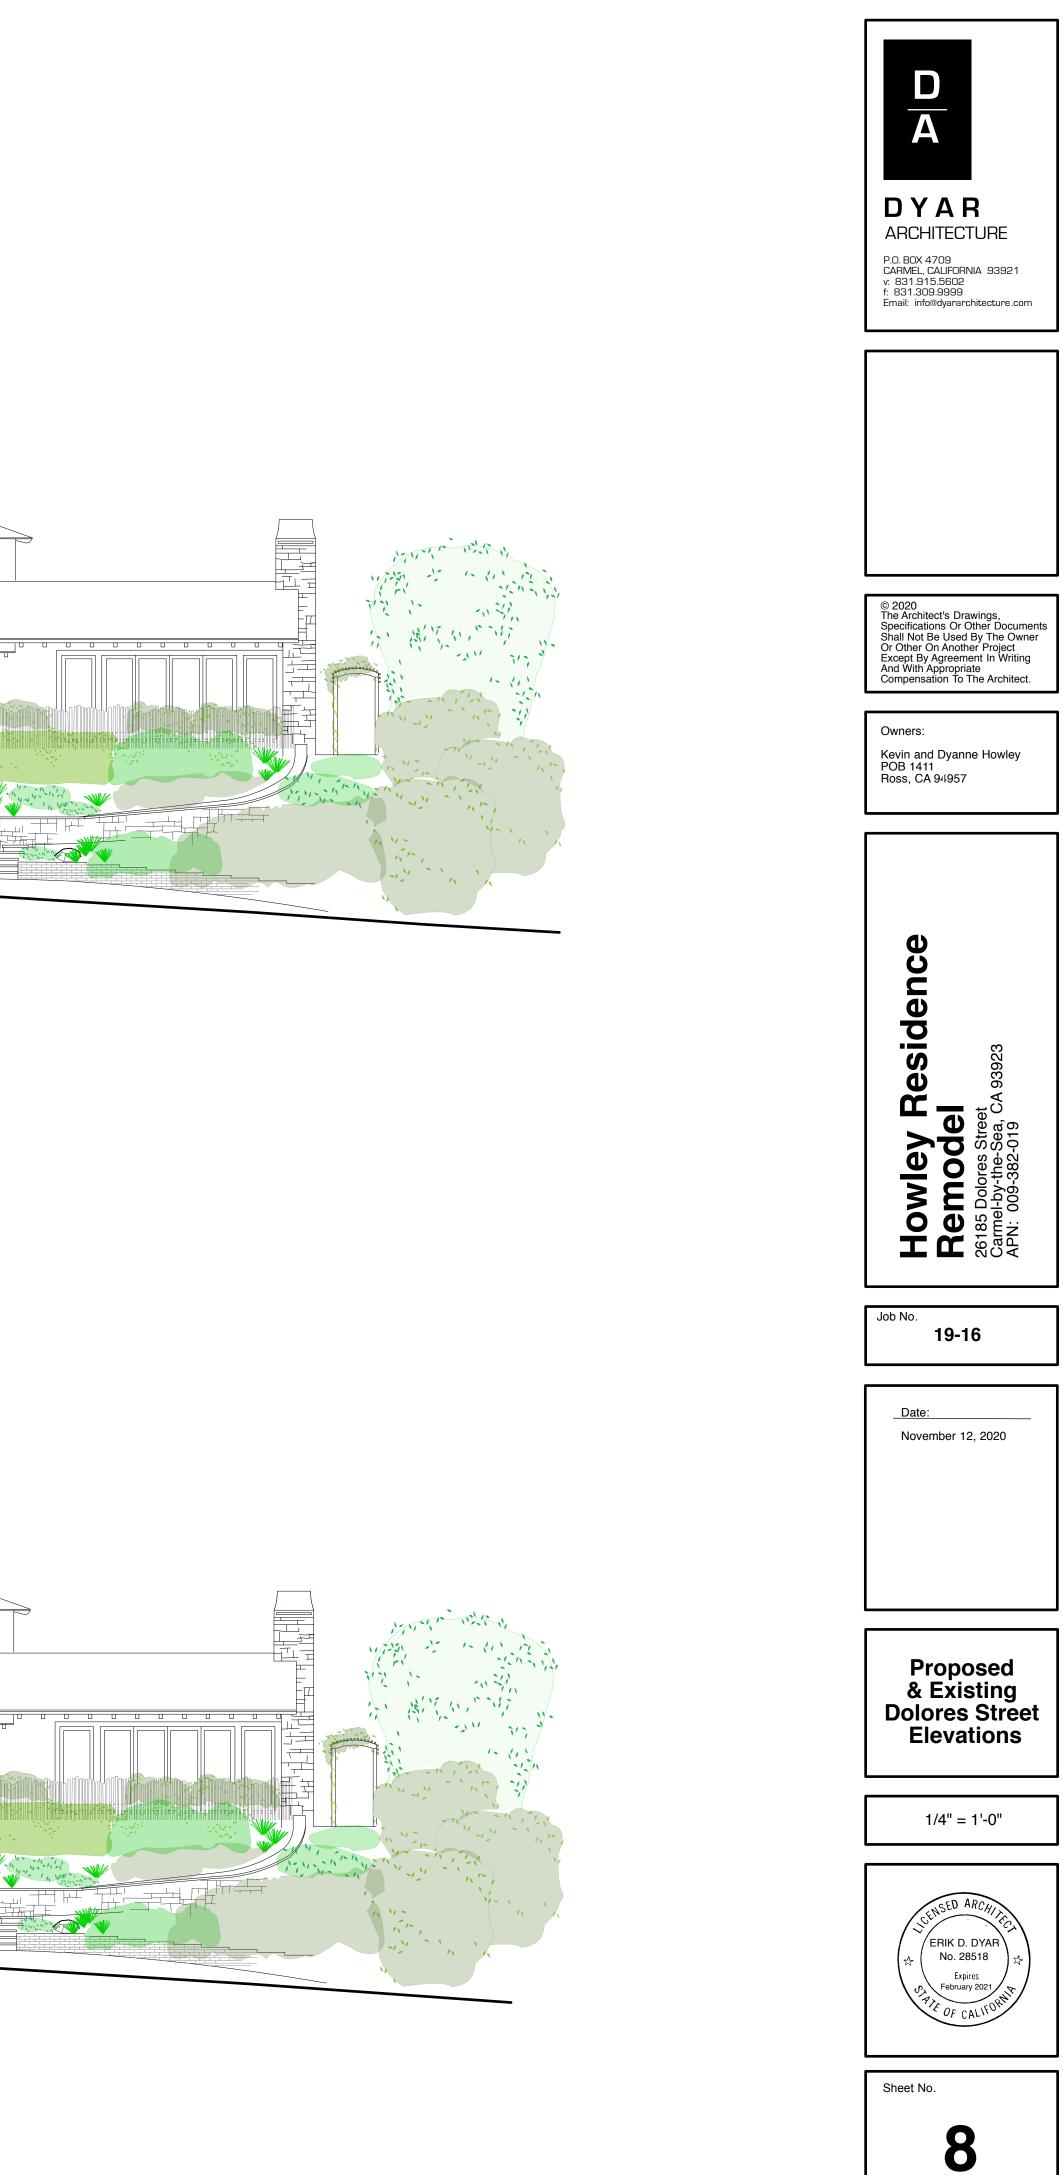

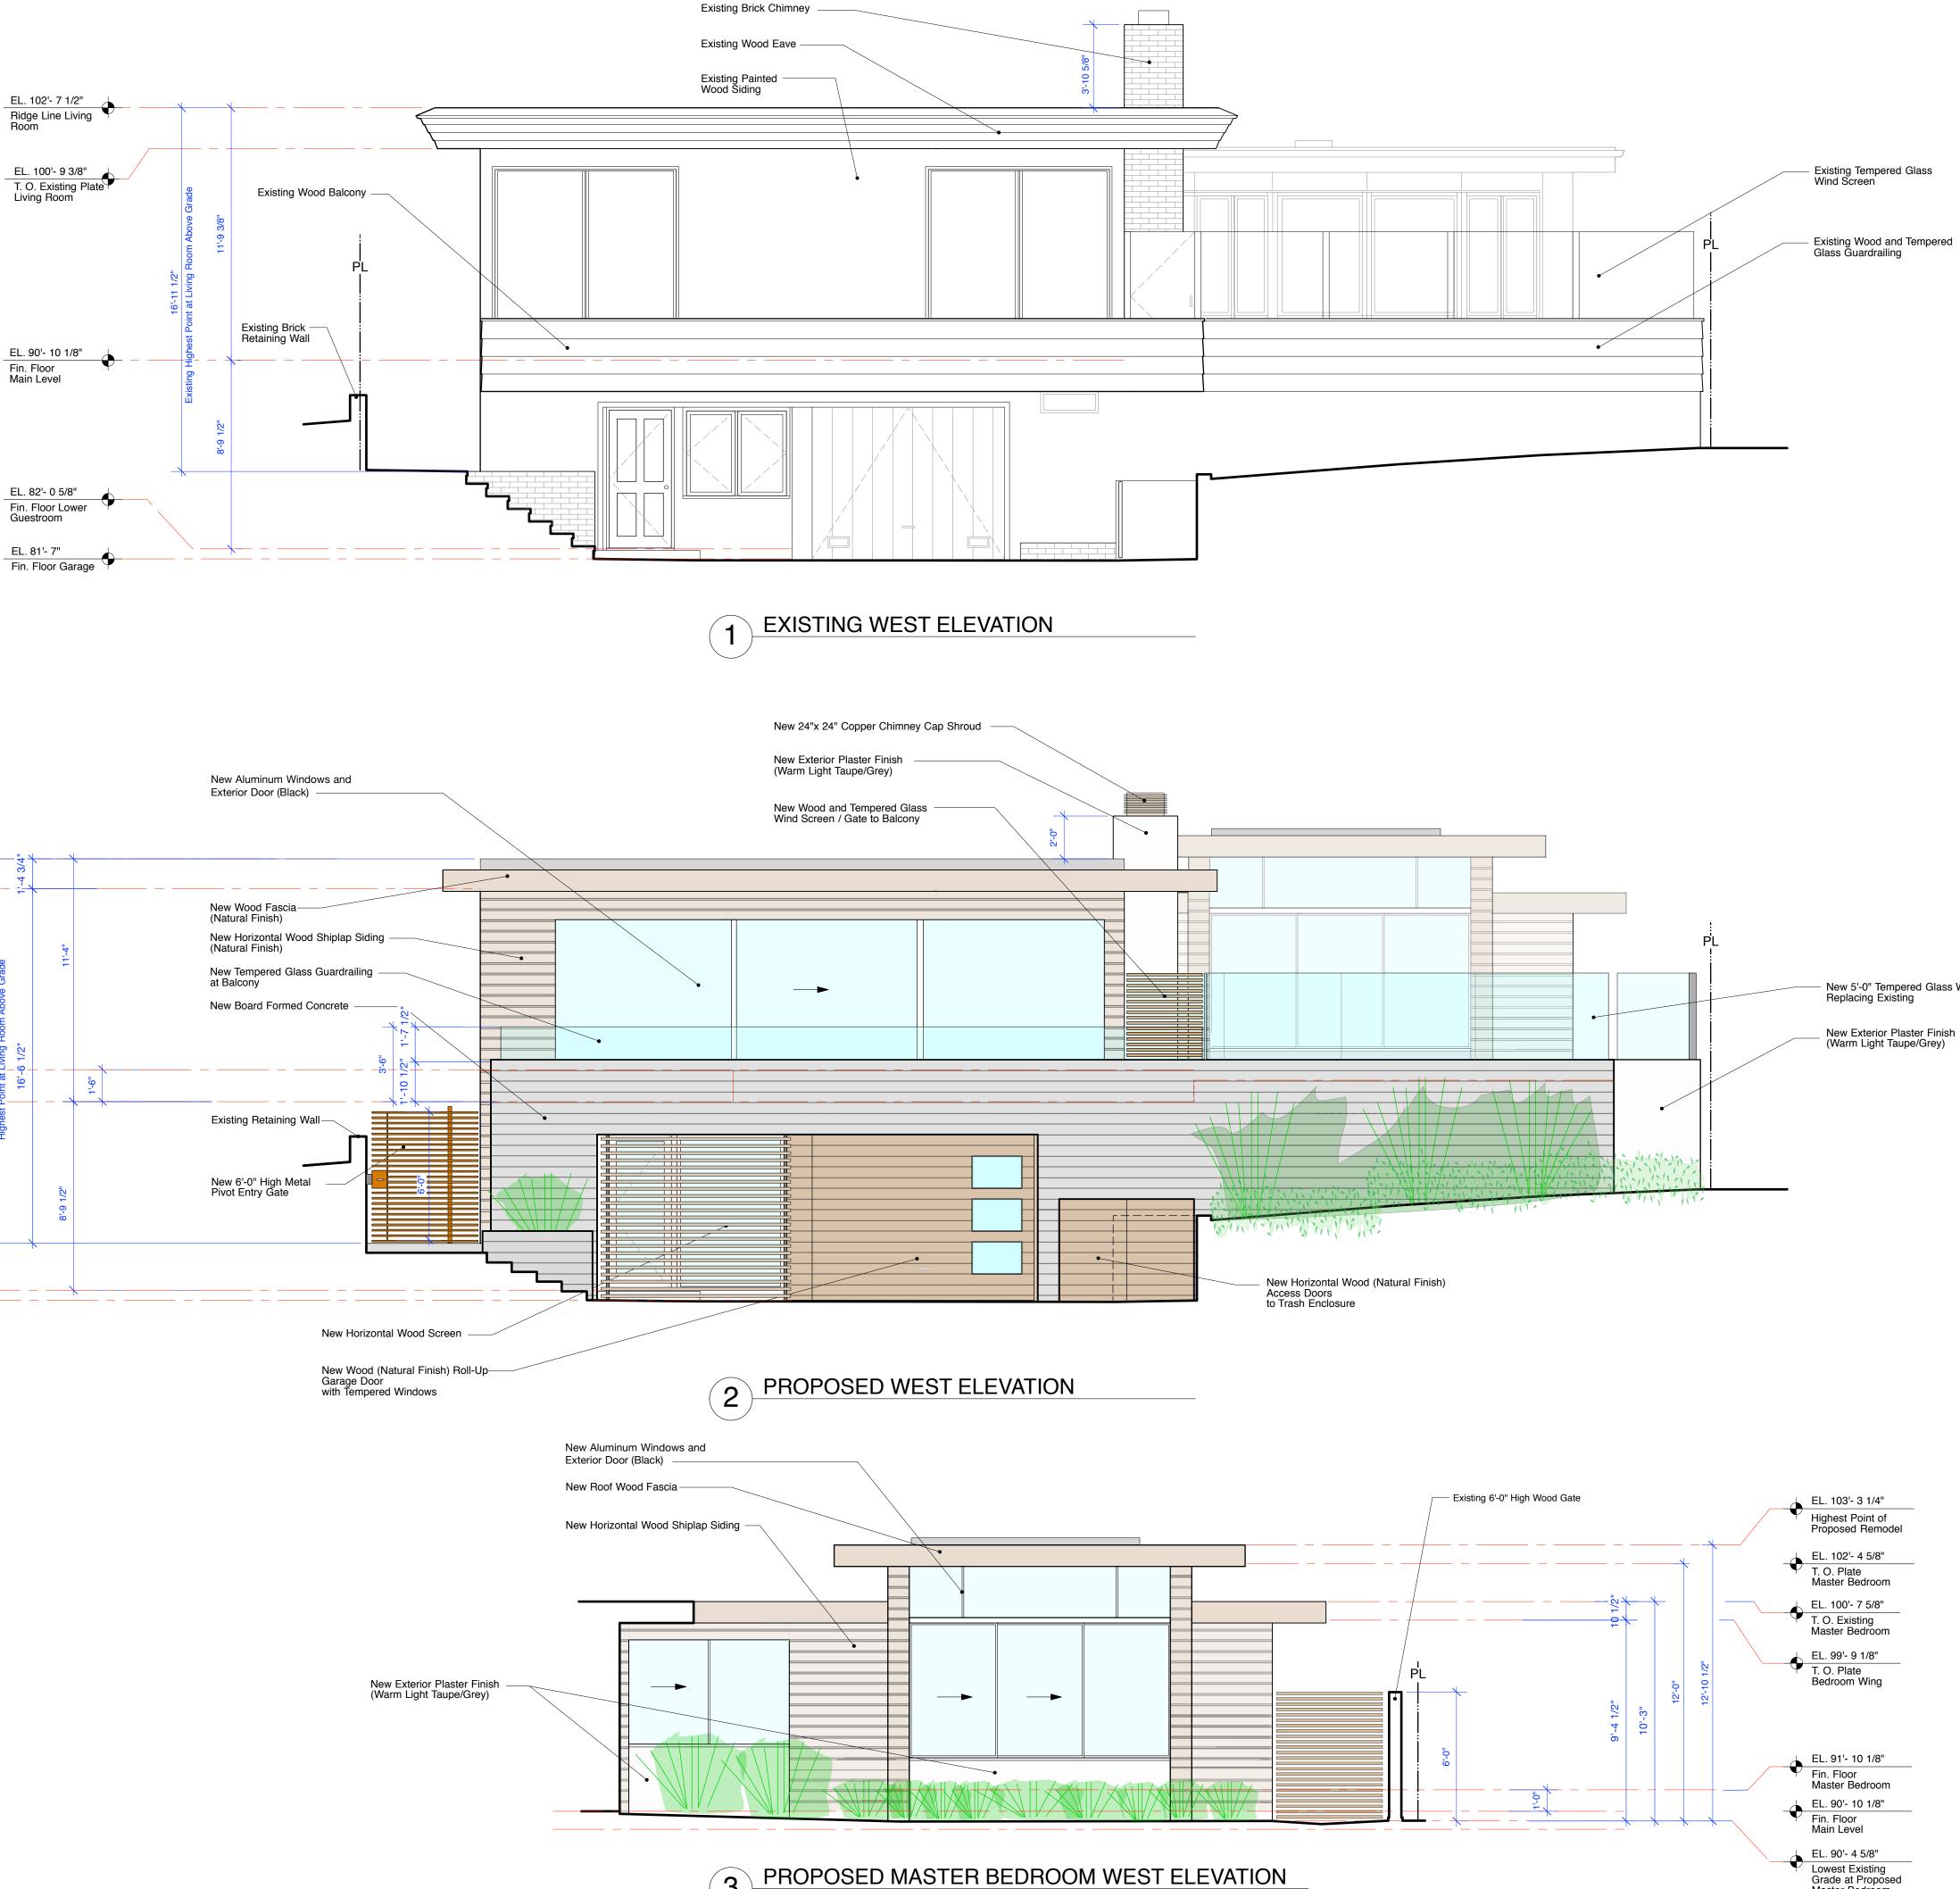

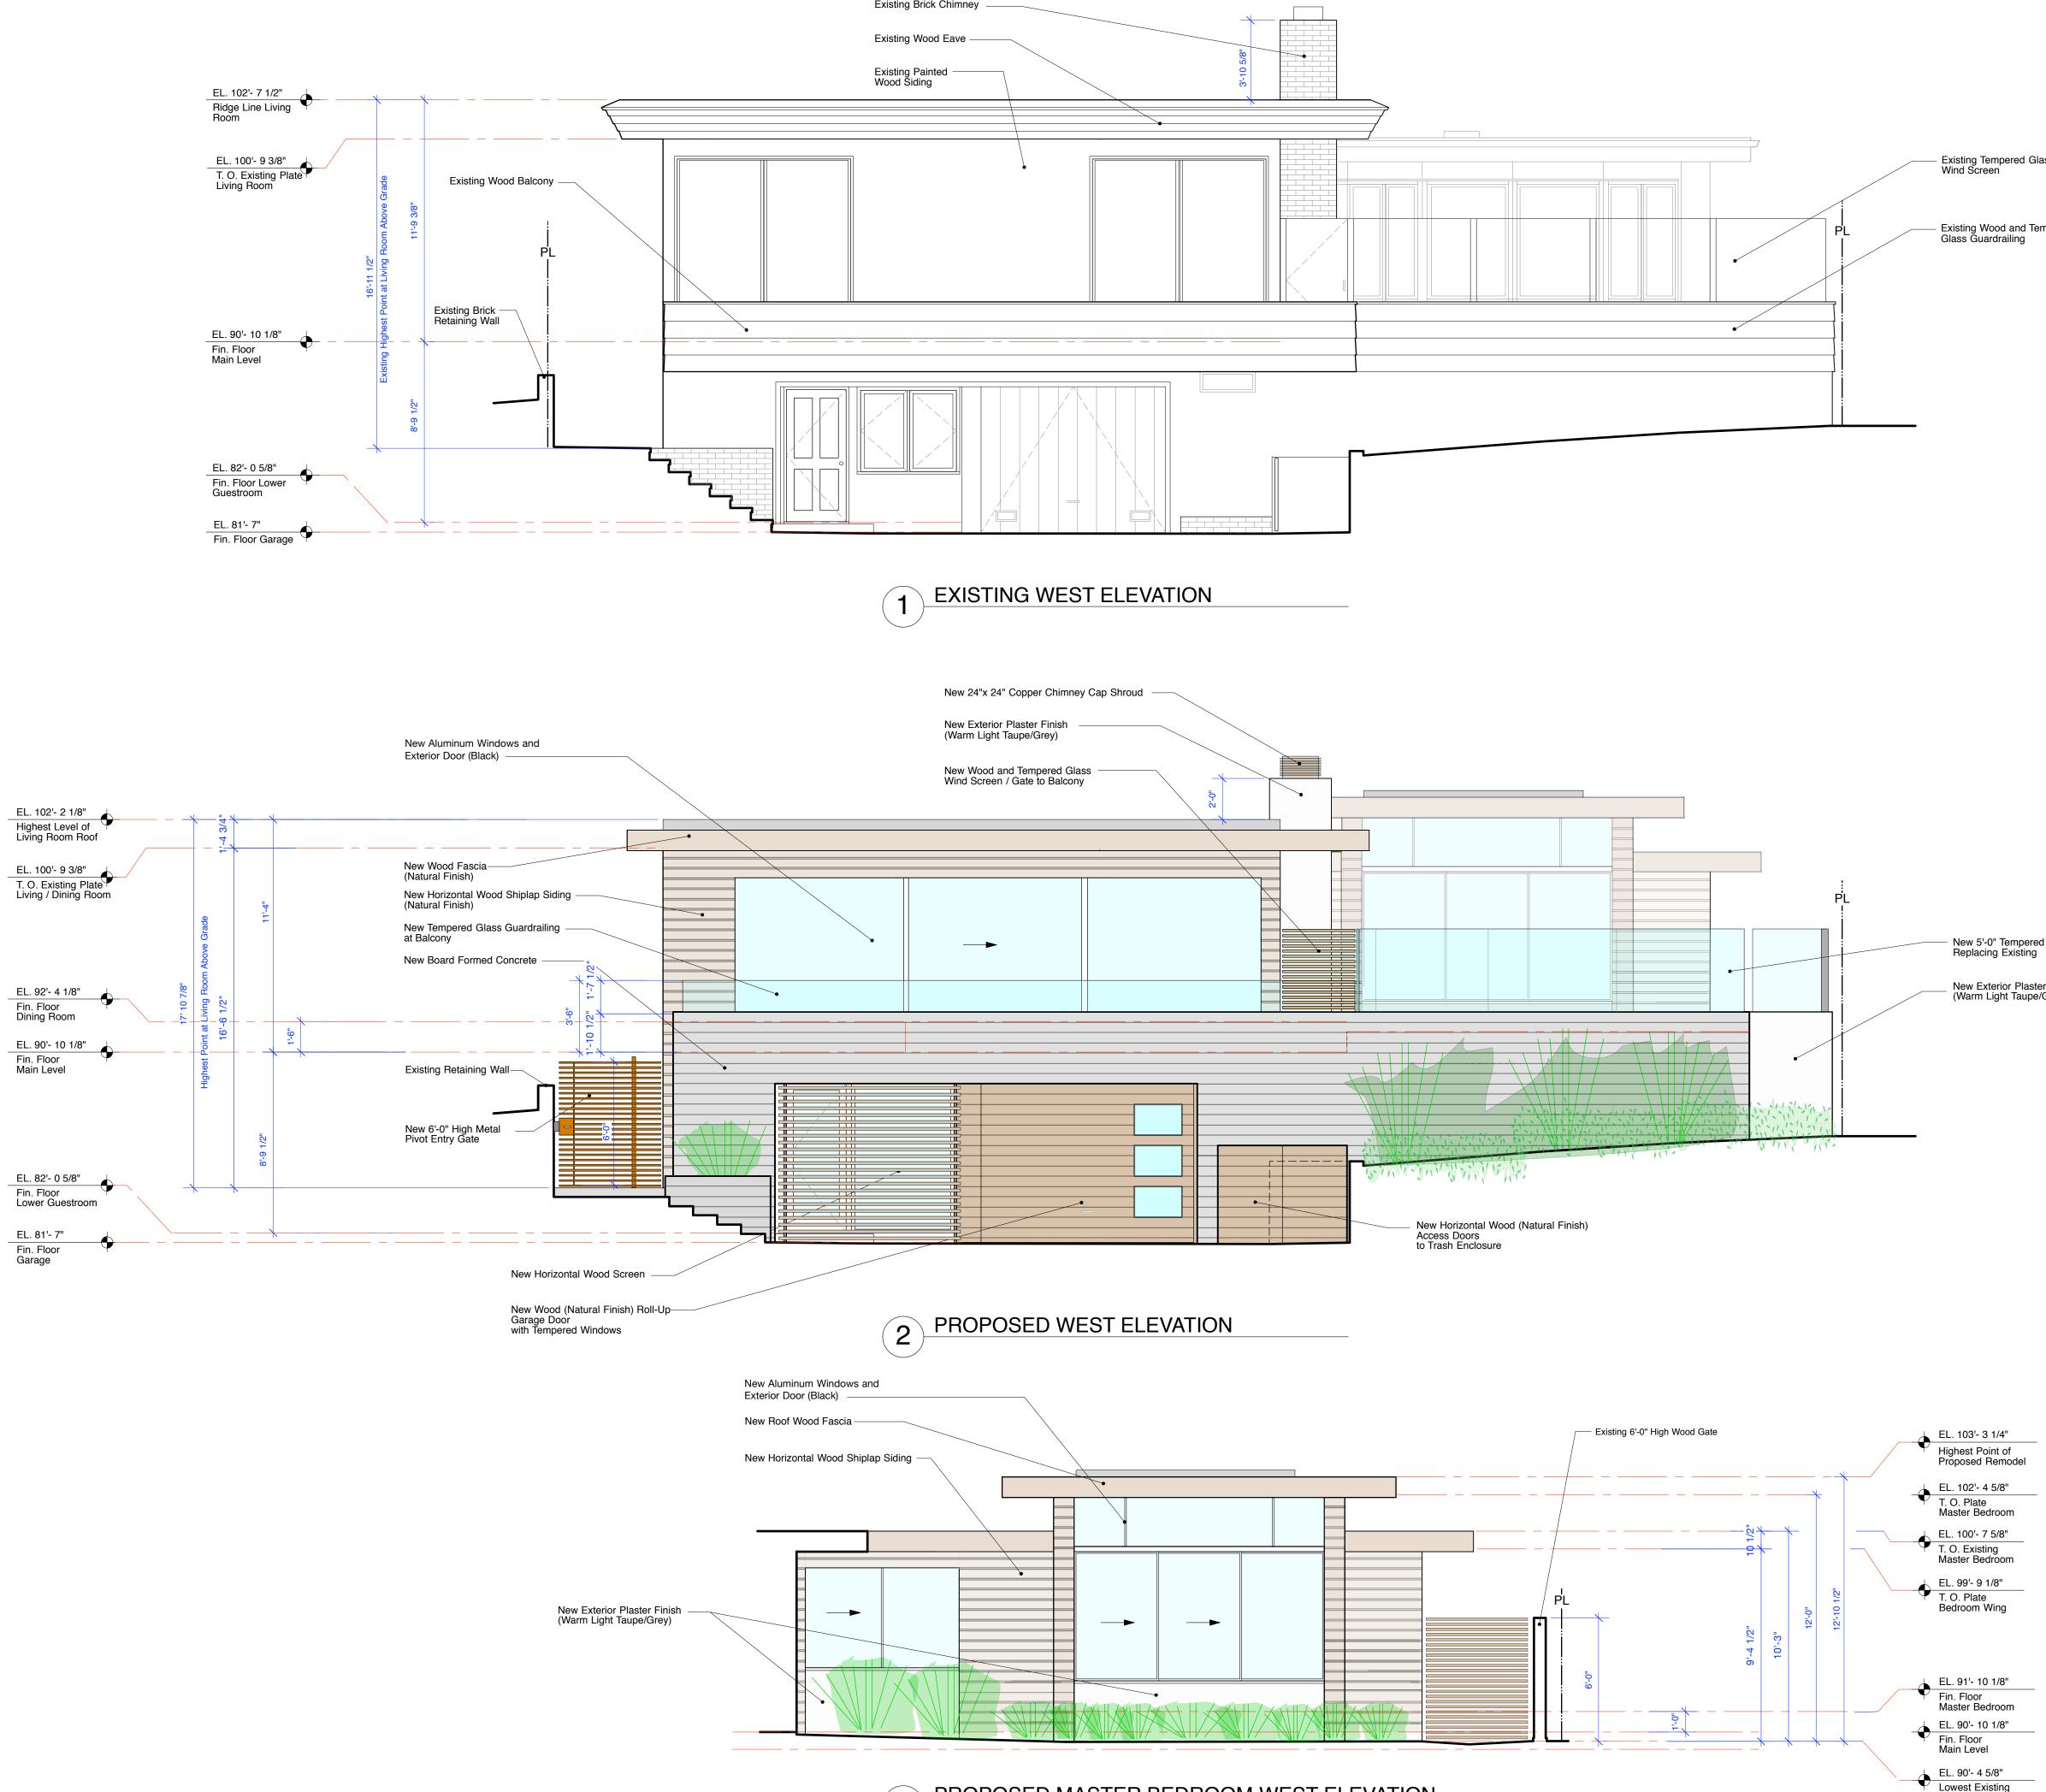

3 PROPOSED MASTER BEDROOM WEST ELEVATION



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Owners: Kevin and Dyanne Howley POB 1411 Ross, CA 94957

New 5'-0" Tempered Glass Wind Screen Replacing Existing

Master Bedroom




Residence


Job No. 19-16

> Date: November 12, 2020




Existing and Proposed West Elevations

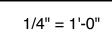

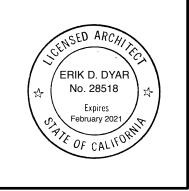


Sheet No.



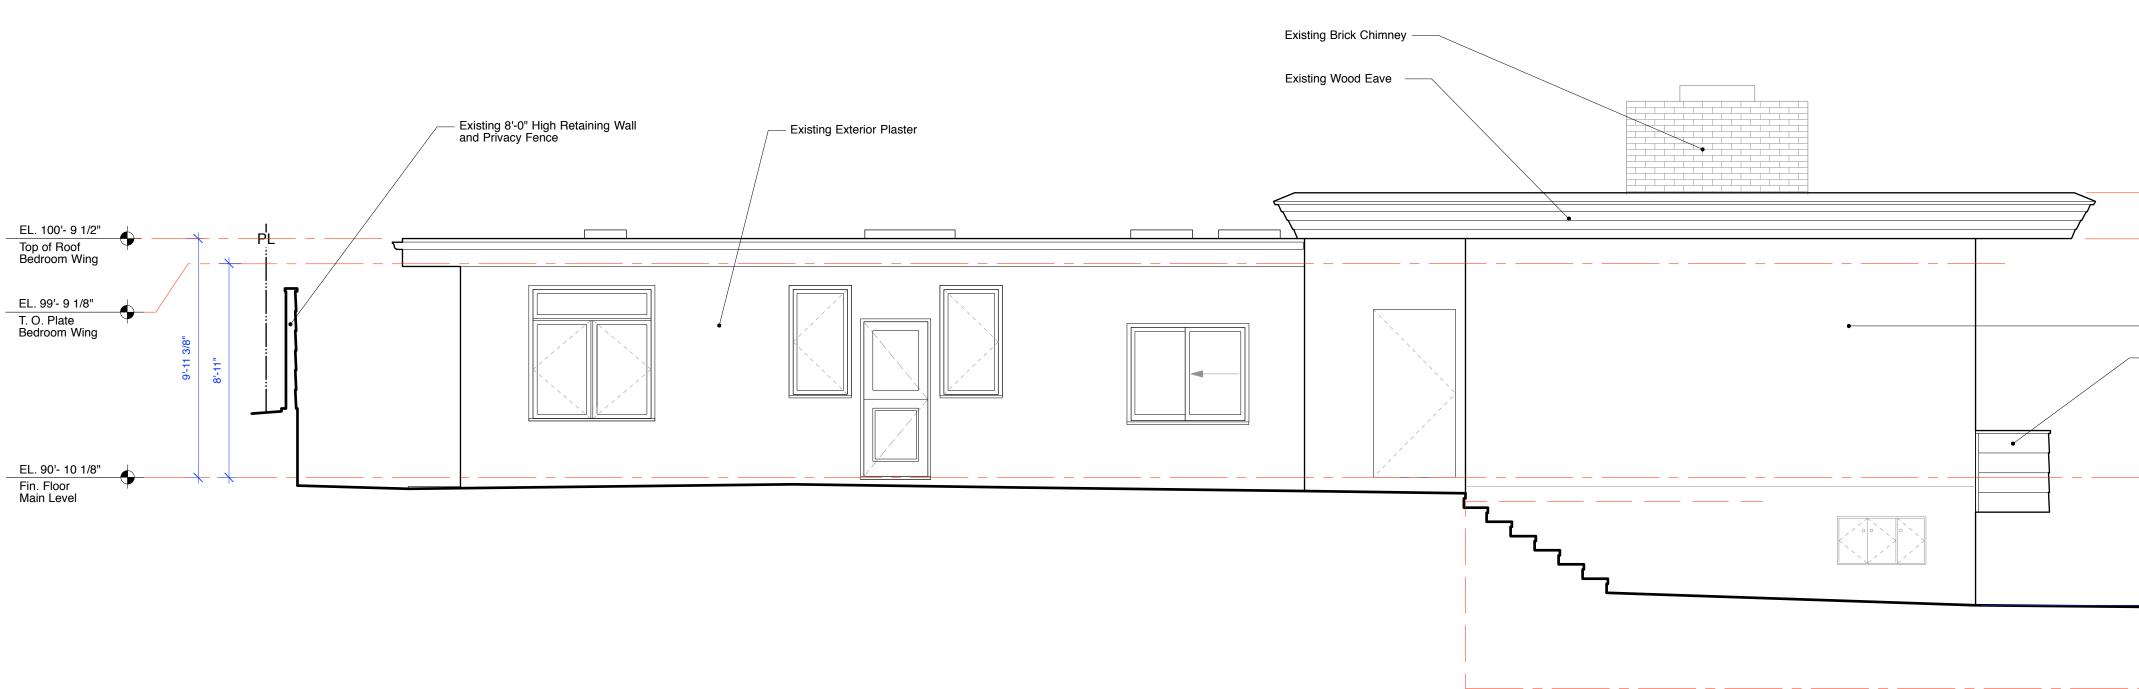


EXISTING NORTH ELEVATION 6

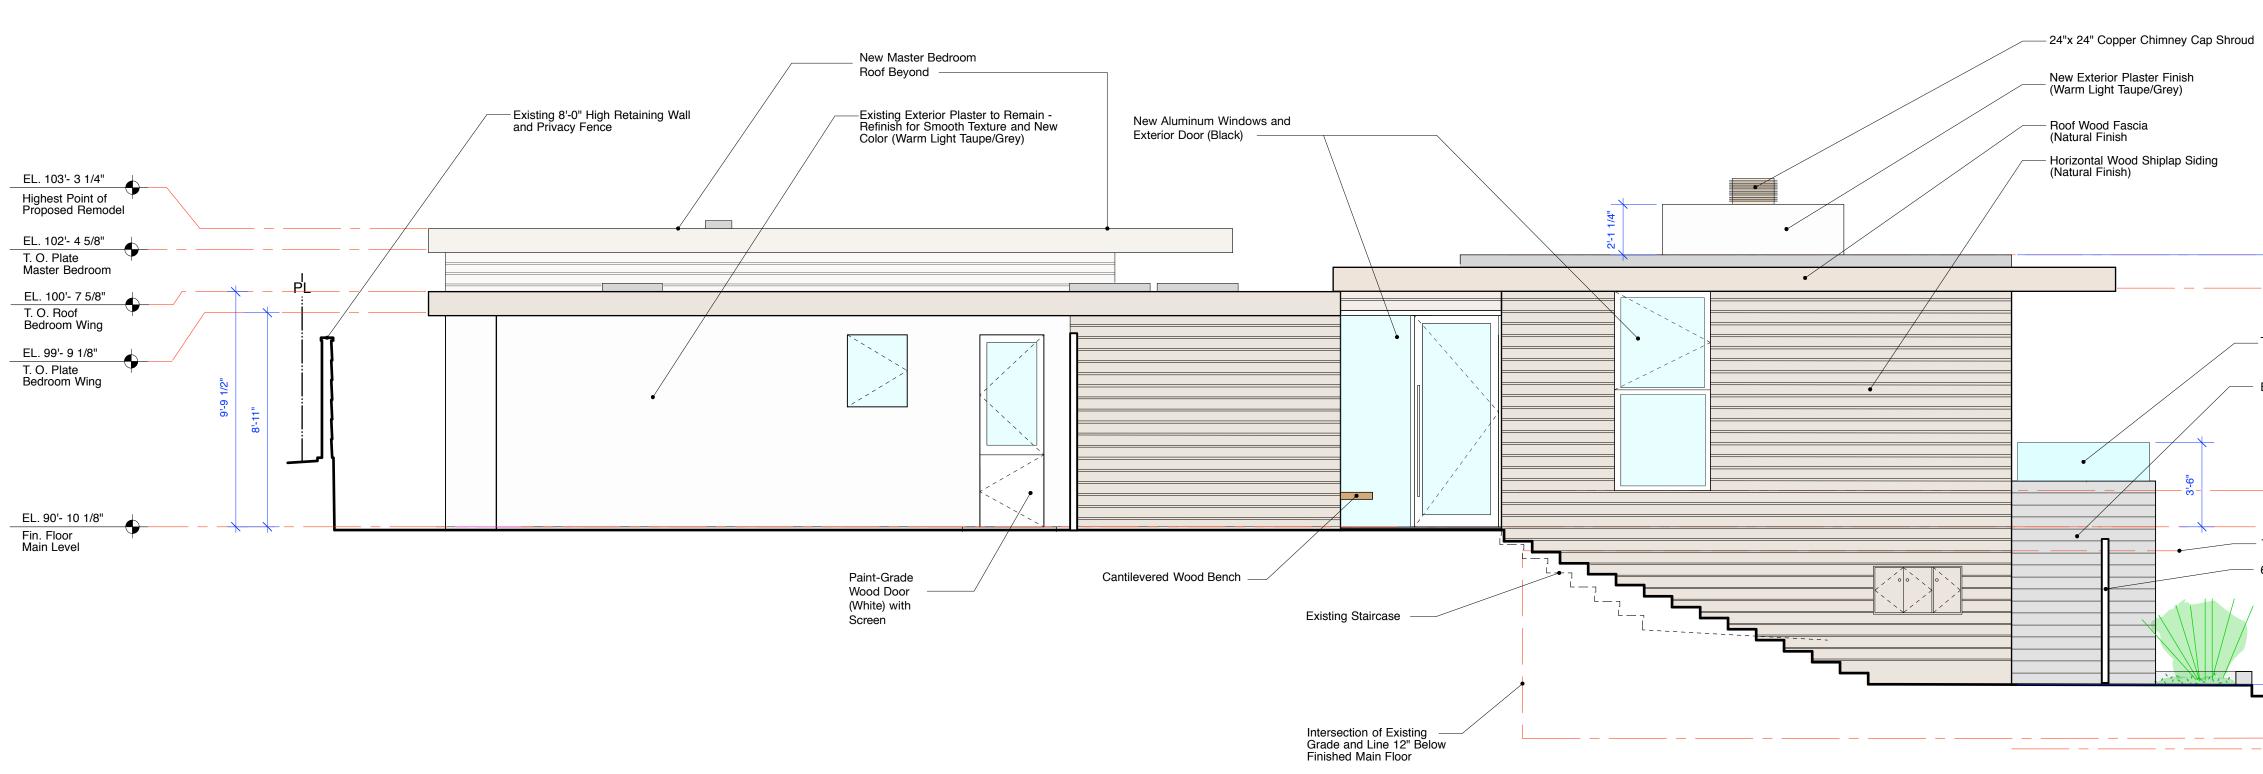




PROPOSED NORTH ELEVATION

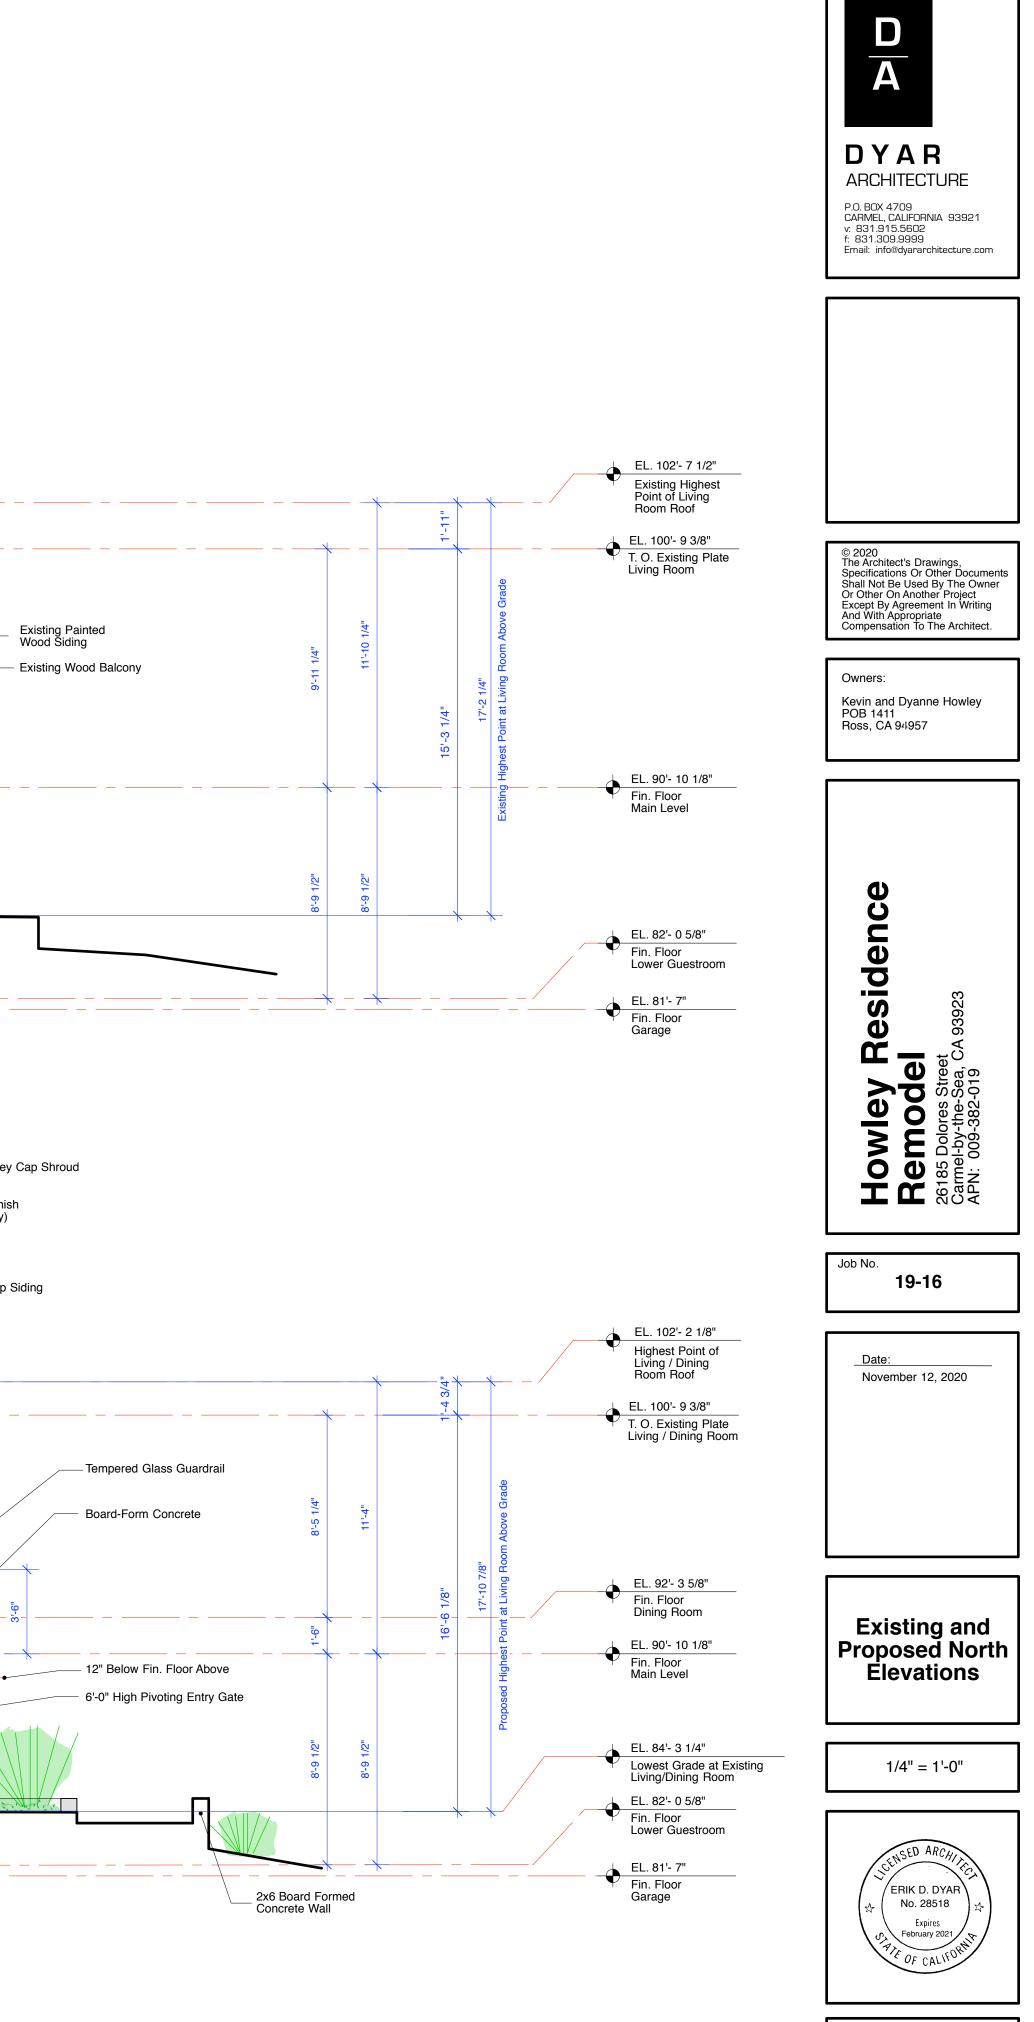

Sheet No.

10



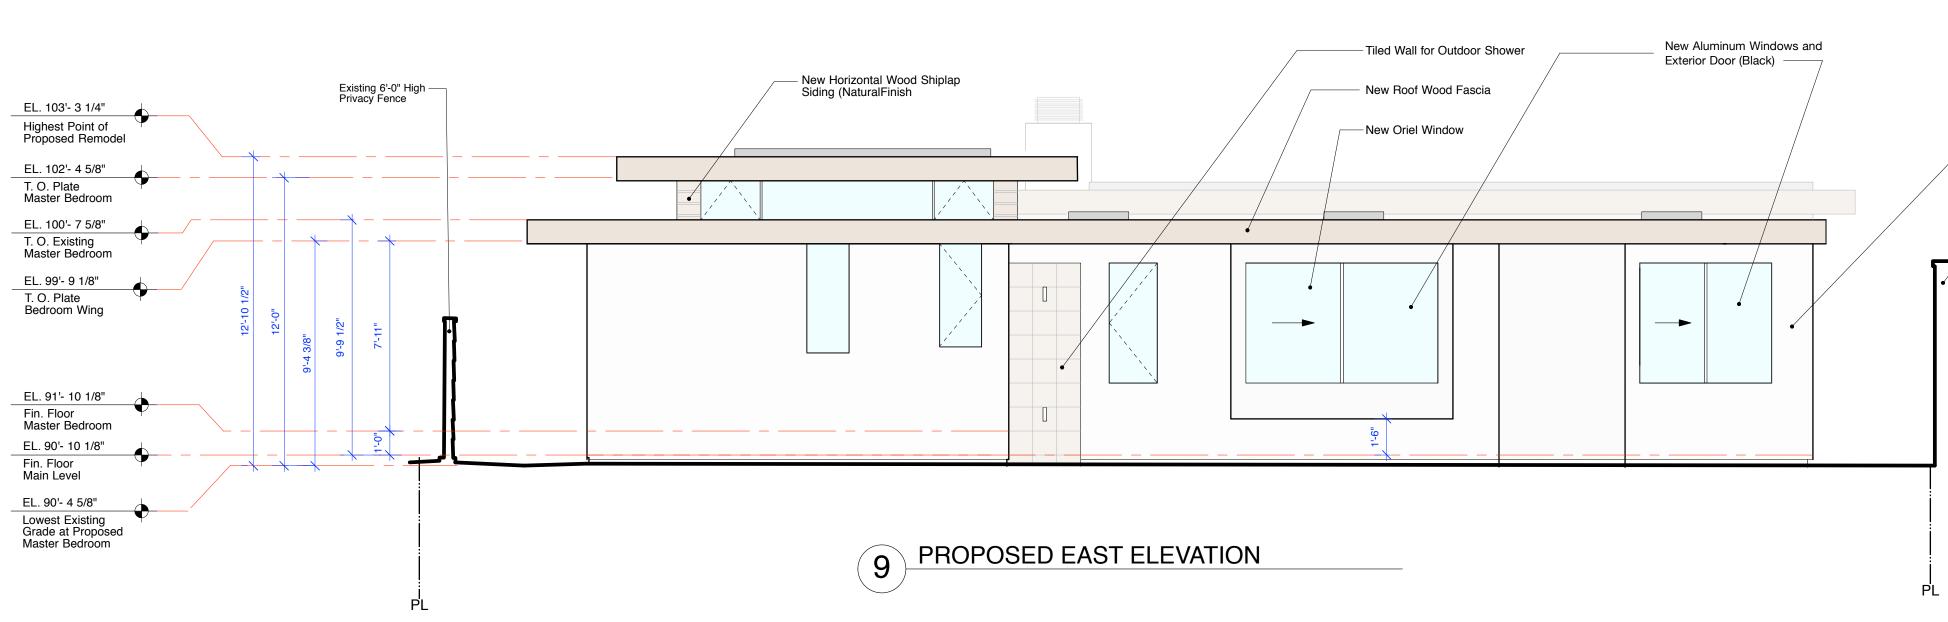







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Howley Residence Remodel 26185 Dolores Street Carmel-by-the-Sea, CA 93923 APN: 009-382-019
Job No. <b>19-16</b>
<u>Date:</u> November 12, 2020
Existing & Proposed East Elevations
1/4" = 1'-0"
ERIK D. DYAR No. 28518 February 2021
Sheet No.


Existing Exterior Plaster to Remain -— Refinish for Smooth Texture and New Color (Warm Light Taupe/Grey)

Existing 8'-0" High Retaining
Wall and Privacy Wall

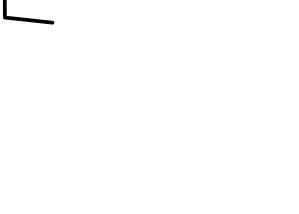

Existing 8'-0" High Retaining
Wall and Privacy Wall

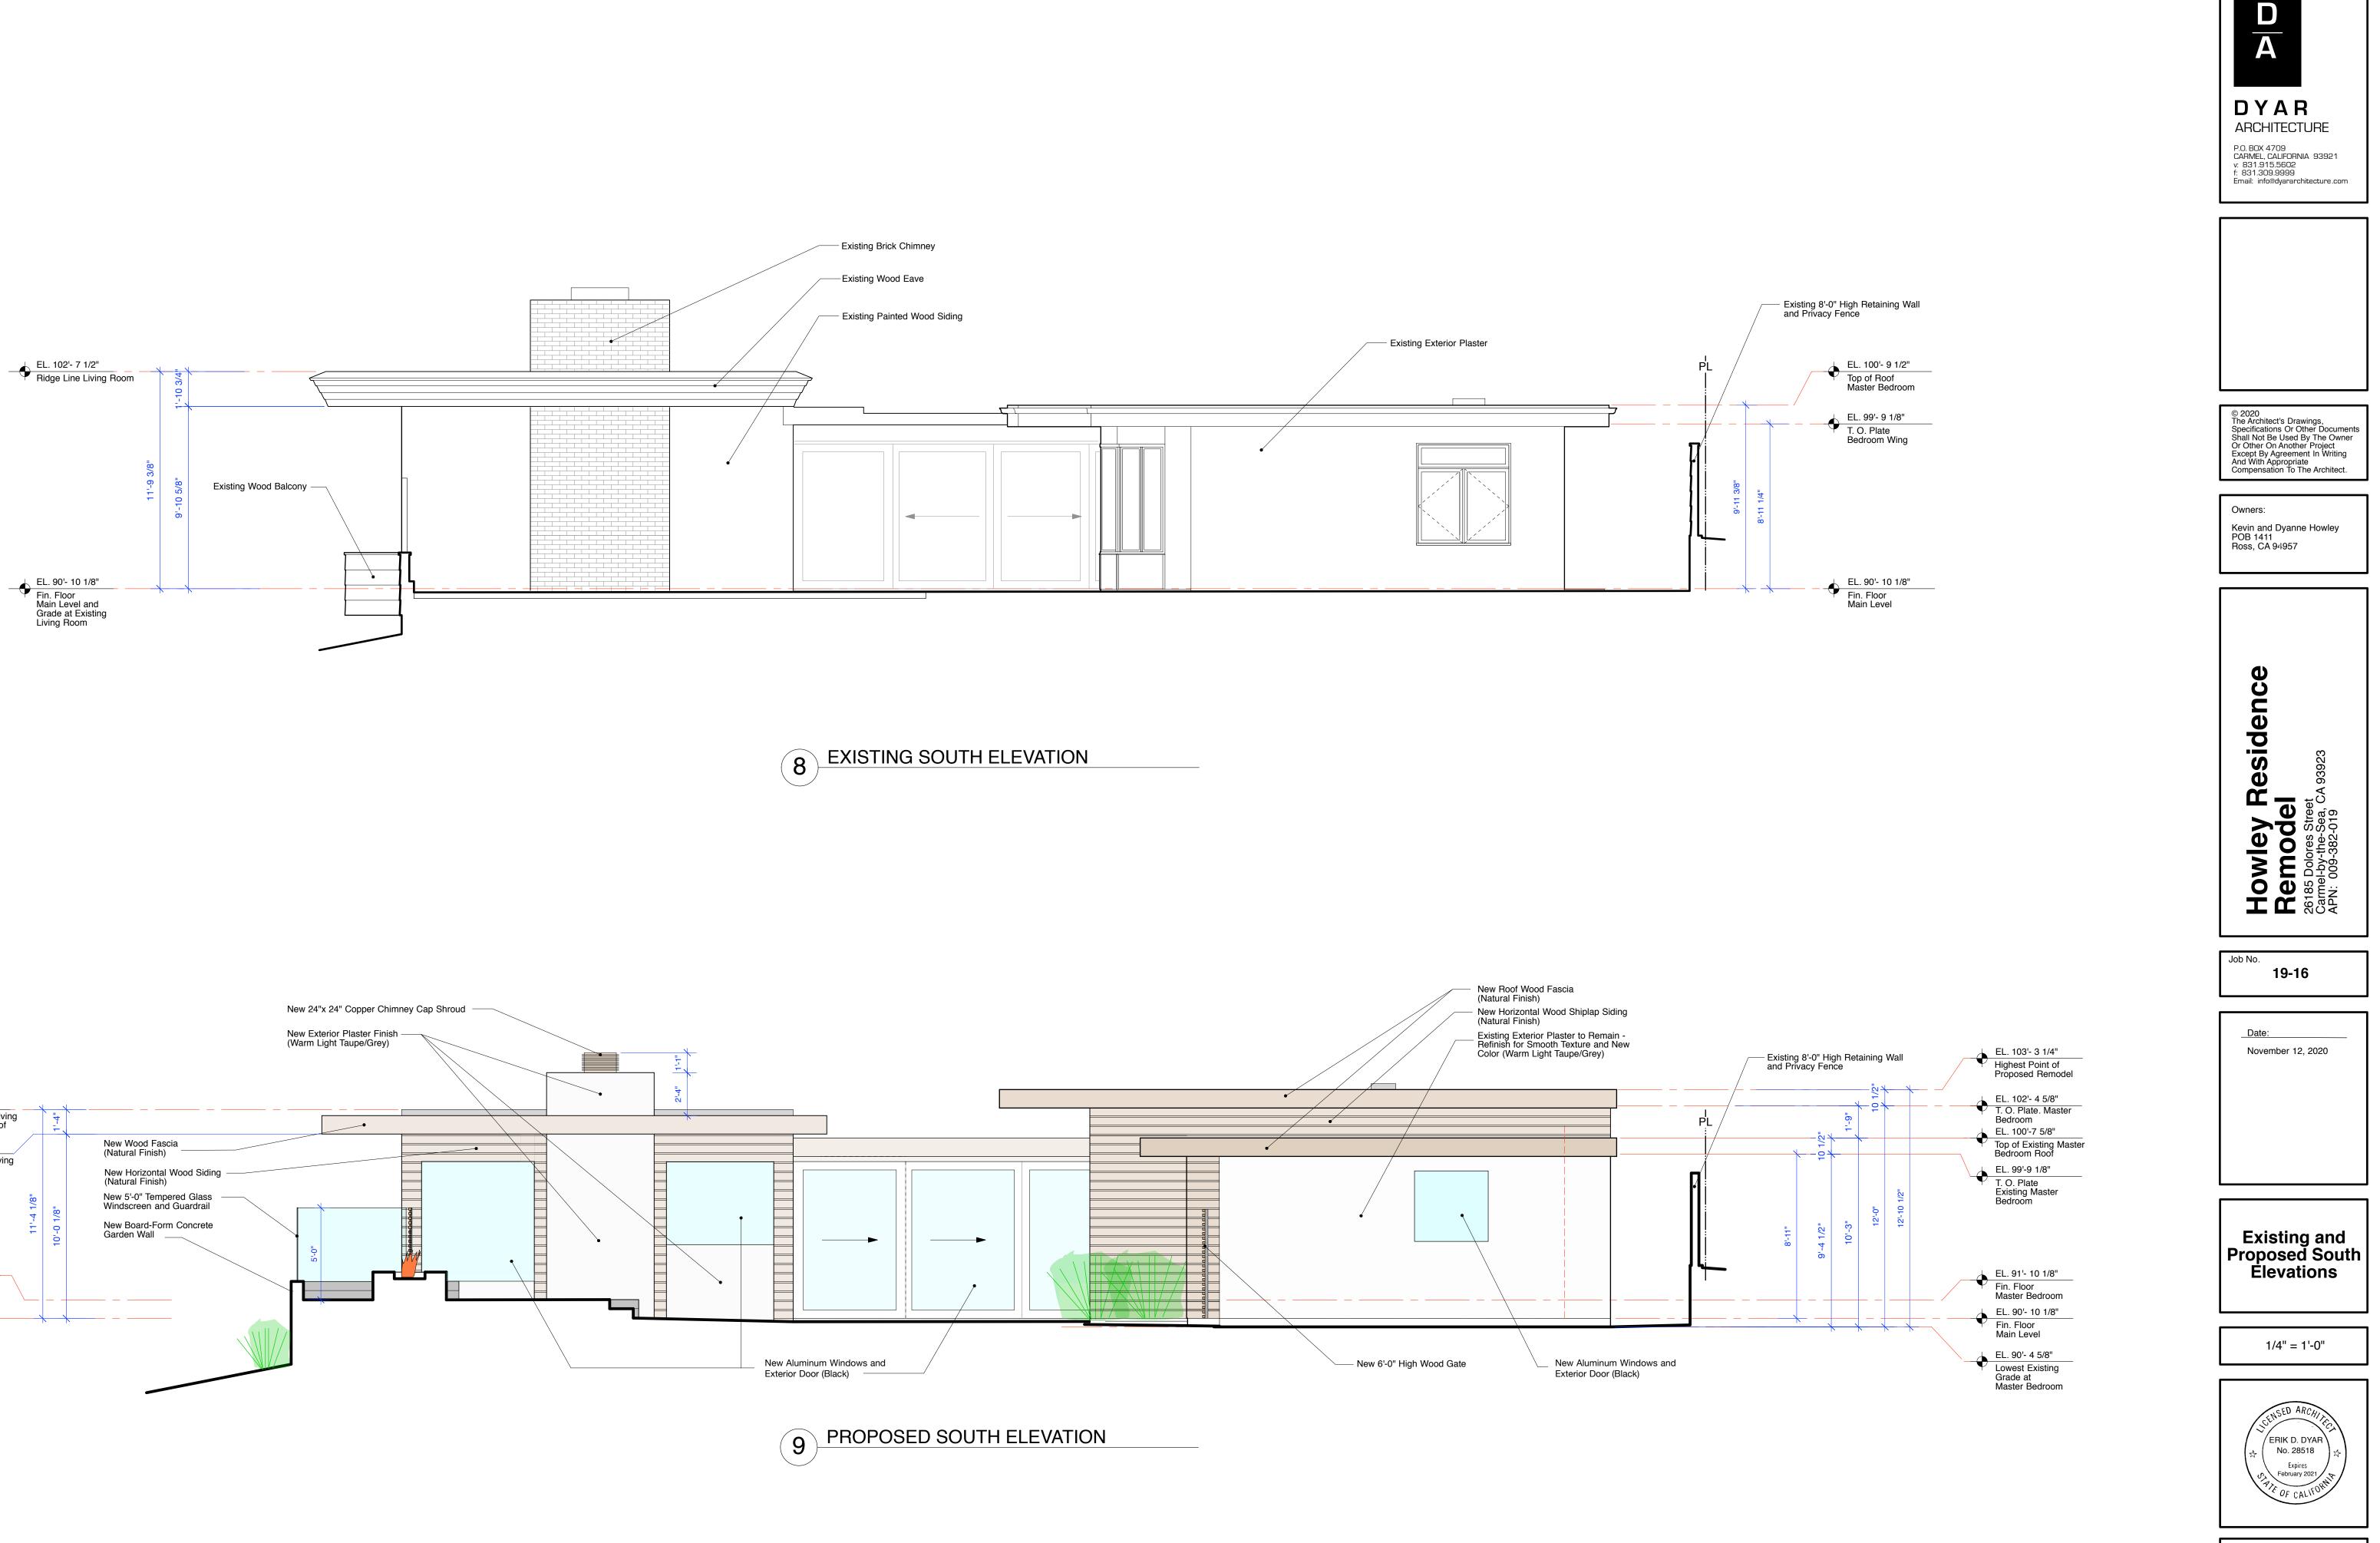


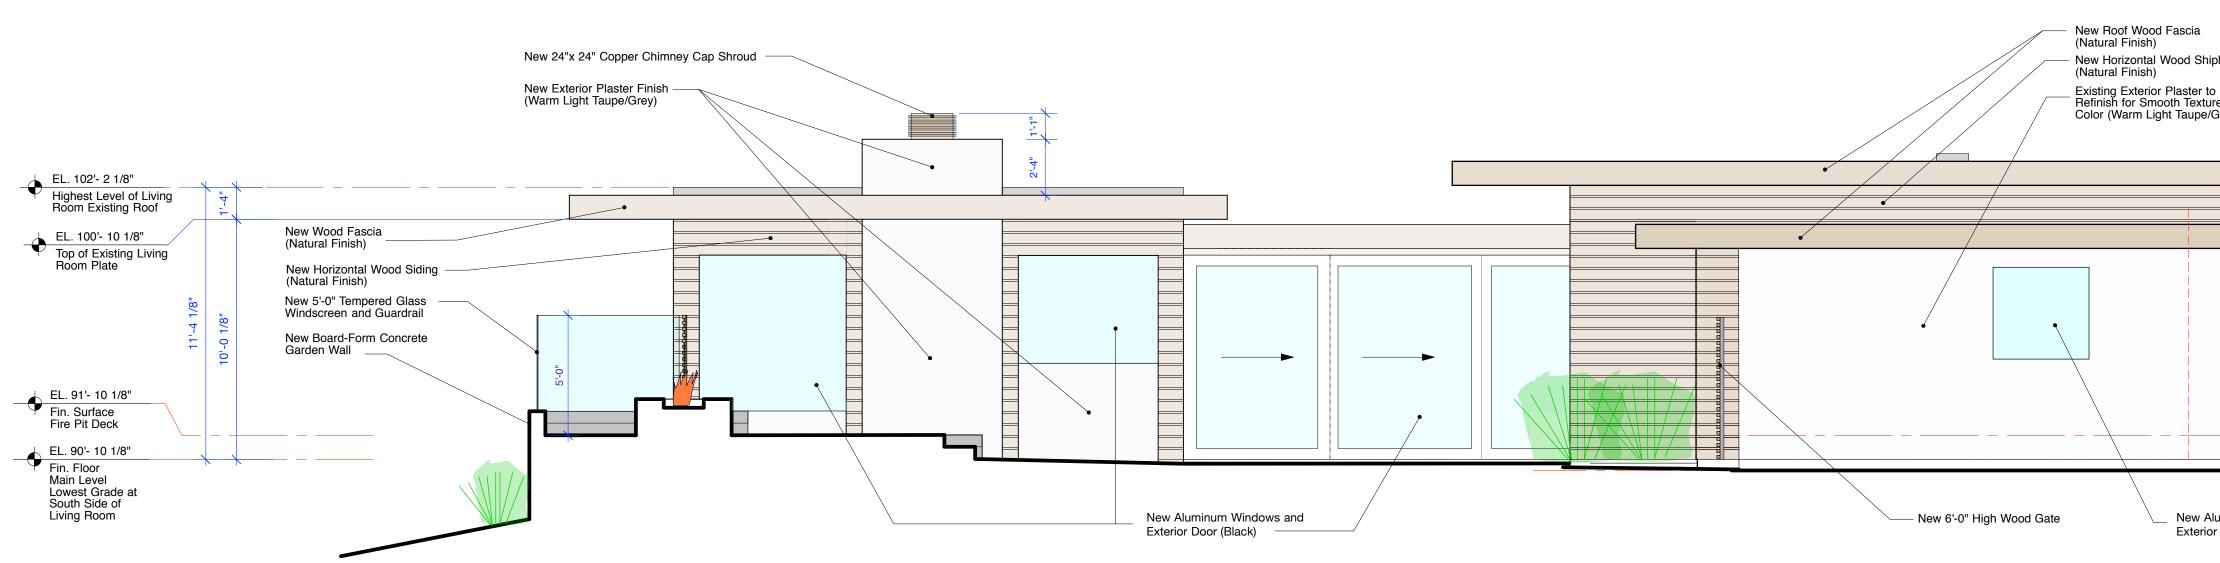

Sheet No.

12

## DOOR TYPES

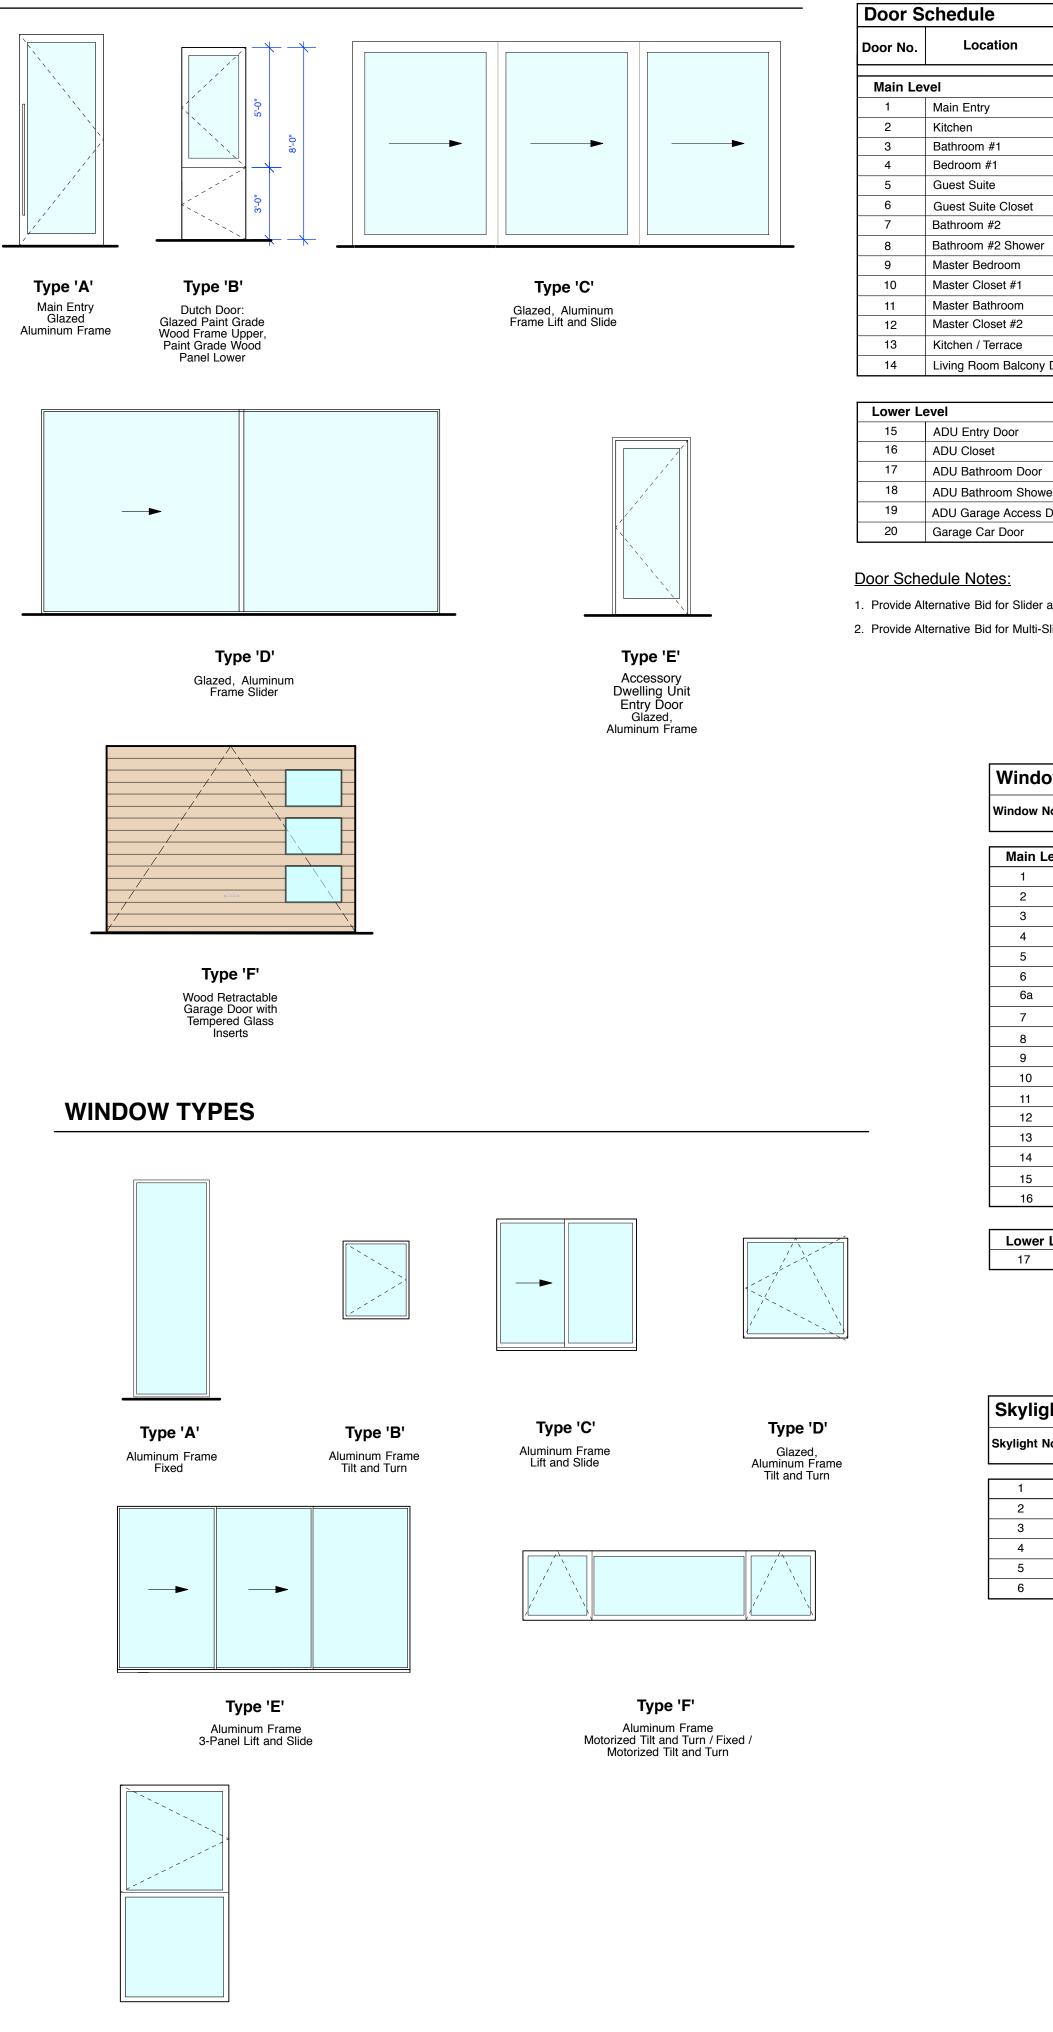

Type 'G' Aluminum Frame Top Tilt and Turn / Bottom Fixed

	Remarks	Head Jamb Sill Manufacturer	Frame Material	Glazing Type	Door Material	Туре	Thickness	R.O. R.O. Framing Framing Width Height	Frame Height	Frame Width	Rm. No.
					1						
	wing Door, Double Glazed, Tempered, Mulled to Fixed Window #1, Dark Bronze Anodized Finish		Aluminum	1" Low-E Tempered Insulated Glass	Aluminum	Α	1-3/4"		8'-9"	3'-6"	
	utch Door: Paint Grade Framed Glass Upper, Paint Grade Wood Panel Lower		Paint-Grade Wood	1" Low-E Tempered Insulated Glass	Solid Core Paint-Grade Wood	В	1-3/4"		8'-0"	2'-8"	
4			Paint-Grade Wood		Solid Core Paint-Grade Wood		1-3/4"		8'-0"	2'-6"	
Р			Paint-Grade Wood		Solid Core Paint-Grade Wood		1-3/4"		8'-0"	2'-8"	
C. v:			Paint-Grade Wood		Solid Core Paint-Grade Wood		1-3/4"		8'-0"	2'-6"	
f: Er			Paint-Grade Wood		Solid Core Paint-Grade Wood		1-3/4"		8'-0"	4'-0"	
			Paint-Grade Wood		Solid Core Paint-Grade Wood		1-3/4"		8'-0"	2'-8"	
			N/A		Tempered Glass		1/2"		6'-0"	2'-2"	
			Paint-Grade Wood		Solid Core Paint-Grade Wood		1-3/4"		8'-0"	3'-0"	
	ocket Door		Paint Grade Wood		Solid Core Paint-Grade Wood		1-3/4"		8'-0"	2'-6"	
	ocket Door		Paint-Grade Wood		Solid Core Paint-Grade Wood		1-3/4"		8'-0"	2'-6"	
	ocket Door		Paint-Grade Wood		Solid Core Paint-Grade Wood		1-3/4"		8'-0"	2'-6"	
	Panel Lift and Slide Door, Double Glazed, 2-Panel Slider, Dark Bronze Anodized Finish, Mulled to Fixed Window No. 15		Aluminum	1" Low-E Tempered Insulated Glass		С	1-3/4"		8'-6"	19'-2 1/2"	
	Panel Sliding Door, Double Glazed, 3-Panel Lift and Slide, Tempered, Dark Bronze Anodized Finish	2	Aluminum	1" Low-E Tempered Insulated Glass		D	1-3/4"		8'-6"	17'-2"	
	Swing Door, Double Glazed, Tempered, Dark Bronze Anodized Finish, Mulled to Fixed Window #1		Aluminum	1" Low-E Tempered Insulated Glass	Aluminum		1-3/4"		7'-0"	3'-0"	
			Existing		Existing				Existing	Existing	
			Existing		Existing				Existing	Existing	
			Existing		Tempered Glass to Remain				Existing	Existing	
	olid Core, 20 Minute Fire Rated Door		Paint-Grade Wood		Solid Core Paint-Grade Wood		1-3/4"		6'-8"	2'-8"	
© Th Sp Sh Or Ex An	etractable Solid Wood with Remote Control		Stain Grade Wood		Solid Core Stain-Grade Wood	F	1-3/4"		7'-8"	10'-4"	

1	facturer Remarks	Head Jamb Sill Manufact	Frame Material	Glazing Type	Door Material	Туре	R.O. Framing Height Height	R.O. Framing Width	Frame Height	Rm. No. Frame Width	
i	Swing Door, Double Glazed, Tempered, Mulled to Fixed Window #1, Dark Bronze Anodized Finish		Aluminum	1" Low-E Tempered Insulated Glass	Aluminum	Α	1-3/4"		8'-9"	3'-6"	
1	Dutch Door: Paint Grade Framed Glass Upper, Paint Grade Wood Panel Lower		Paint-Grade Wood	1" Low-E Tempered Insulated Glass	Solid Core Paint-Grade Wood	В	1-3/4"		8'-0"	2'-8"	
ł			Paint-Grade Wood		Solid Core Paint-Grade Wood		1-3/4"		8'-0"	2'-6"	
1			Paint-Grade Wood		Solid Core Paint-Grade Wood		1-3/4"		8'-0"	2'-8"	
1			Paint-Grade Wood		Solid Core Paint-Grade Wood		1-3/4"		8'-0"	2'-6"	
i			Paint-Grade Wood		Solid Core Paint-Grade Wood		1-3/4"		8'-0"	4'-0"	
i			Paint-Grade Wood		Solid Core Paint-Grade Wood		1-3/4"		8'-0"	2'-8"	
i			N/A		Tempered Glass		1/2"		6'-0"	2'-2"	
1			Paint-Grade Wood		Solid Core Paint-Grade Wood		1-3/4"		8'-0"	3'-0"	
i	Pocket Door		Paint Grade Wood		Solid Core Paint-Grade Wood		1-3/4"		8'-0"	2'-6"	
1	Pocket Door		Paint-Grade Wood		Solid Core Paint-Grade Wood		1-3/4"		8'-0"	2'-6"	
i	Pocket Door		Paint-Grade Wood		Solid Core Paint-Grade Wood		1-3/4"		8'-0"	2'-6"	
1	3-Panel Lift and Slide Door, Double Glazed, 2-Panel Slider, Dark Bronze Anodized Finish, Mulled to Fixed Window No. 15		Aluminum	1" Low-E Tempered Insulated Glass		С	1-3/4"		8'-6"	19'-2 1/2"	
1	2-Panel Sliding Door, Double Glazed, 3-Panel Lift and Slide, Tempered, Dark Bronze Anodized Finish		Aluminum	1" Low-E Tempered Insulated Glass		D	1-3/4"		8'-6"	17'-2"	
					1					1	
i	Swing Door, Double Glazed, Tempered, Dark Bronze Anodized Finish, Mulled to Fixed Window #1		Aluminum	1" Low-E Tempered Insulated Glass	Aluminum	E	1-3/4"		7'-0"	3'-0"	
i			Existing		Existing	_			Existing	Existing	
1			Existing		Existing				Existing	Existing	
1			Existing		Tempered Glass to Remain	_			Existing	Existing	r
i	Solid Core, 20 Minute Fire Rated Door		Paint-Grade Wood		Solid Core Paint-Grade Wood		1-3/4"		6'-8"	2'-8"	
	Retractable Solid Wood with Remote Control		Stain Grade Wood		Solid Core Stain-Grade Wood	F	1-3/4"		7'-8"	10'-4"	

1. Provide Alternative Bid for Slider and Multi-Slide Doors as 8'-0" High Units.

2. Provide Alternative Bid for Multi-Slide Doors as 8'-0" Lift and Slide Units.


### Window Schedule

low No.	Location	Rm. No.	Frame Width	Frame Height	R.O. Framing Width	R.O. Framing Height Glass Thickness	Туре	Operation	Glass Type	Frame Material	Manufacturer	Remarks
ain Lev	el											
1	Main Entry		2'- 11"	8'- 9"		1"	Α	0	1" Insulated Glass, Tempered as Required	Aluminum		Fixed, Double Glazed, Tempered, Dark Bronze Anodized Finish
2	Bathroom #1		2'- 6"	3'- 0"		1"	В	Х	1" Insulated Glass, Tempered as Required	Aluminum		Tilt and Turn, Push Out Casement, Double Glazed, Dark Bronze Anodized Finish
3	Bedroom #1		5'- 6"	5'- 0"		1"	С	X/O	1" Insulated Glass, Tempered as Required	Aluminum		Tilt and Turn, Slider, Double Glazed, Dark Bronze Anodized Finish
4	Guest Suite		8'- 0"	5'- 0"		1"	С	X/O	1" Insulated Glass, Tempered as Required	Aluminum		Tilt and Turn, Slider, Double Glazed, Dark Bronze Anodized Finish
5	Bathroom #2		2'- 0"	5'- 0"		1"	В	X	1" Insulated Frosted Glass, Tempered as Required	Aluminum		Tilt and Turn, Push Out Casement, Double Glazed, Dark Bronze Anodized Finish
6	Master Bath WC		1'- 9"	4'- 3 1/2"		1"	В	X	1" Insulated Frosted Glass, Tempered as Required	Aluminum		Tilt and Turn, Push Out Casement, Double Glazed, Dark Bronze Anodized Finish
6a	Master Bath Transom		12'- 2"	1'- 6"		1"	F	X / O / X	1" Insulated Frosted Glass, Tempered as Required	Aluminum		Motorized Awning / Fixed / Motorized Awning, Tempered, Double Glazed, Dark Bronze Anodized Finish
7	Master Bath Vanity		1'- 9"	4'- 3 1/2"		1"	В	Х	1" Insulated Frosted Glass, Tempered as Required	Aluminum		Tilt and Turn, Push Out Casement, Double Glazed, Dark Bronze Anodized Finish
8	Master Closet		4'-0"	3'-10"		1"	D	Х	1" Insulated Glass, Tempered as Required	Aluminum		Tilt and Turn, Awning, Double Glazed, Dark Bronze Anodized Finish
9	Master Bedroom		12'- 2"	6'- 11"		1"	E	X / X / X	1" Insulated Glass, Tempered as Required	Aluminum		Lift and Slide, Double Glazed, Dark Bronze Anodized Finish, Mulled to Window No. 10
10	Master Bedroom Transom		12'- 2"	2'- 8"		1"	F	X/O/X	1" Insulated Glass, Tempered as Required	Aluminum		Motorized Awning / Fixed / Motorized Awning, Tempered, Double Glazed, Dark Bronze Anodized Finish
11	Hall		7'-5"	5'- 0"		1"	С	X / O	1" Insulated Glass, Tempered as Required	Aluminum		2-Panel Lift and Slide, Tempered, Double Glazed, Dark Bronze Anodized Finish
12	Living Room		4'-0"	5'- 0"		3/4"	D	X	1" Insulated Glass, Tempered as Required	Aluminum		Tilt and Turn, Tempered, Double Glazed, Dark Bronze Anodized Finish
13	Living Room		5'-9"	4'- 6"		3/4"	D	X	1" Insulated Glass, Tempered as Required	Aluminum		Tilt and Turn, Tempered, Double Glazed, Dark Bronze Anodized Finish
14	Living Room		6'-0"	6'- 6"		3/4"	Α	0	1" Insulated Glass, Tempered as Required	Aluminum		Fixed, Tempered, Double Glazed, Dark Bronze Anodized Finish
15	Dining Room		8'-2 1/2"	7'- 0"		3/4"	A	0	1" Insulated Glass, Tempered as Required	Aluminum		Fixed, Tempered, Double Glazed, Dark Bronze Anodized Finish
16	Dining Room		4'- 0"	8'- 6"		1"	G	X/O	1" Insulated Glass, Tempered as Required	Aluminum		Tilt and Turn Top Panel, Bottom Panel Fixed, Double Glazed, Dark Bronze Anodized Finish
wer Le	vel											
17	Accessory Dwelling Unit		5'-1"	7'-0"		1"	Δ	0	1" Insulated Glass, Tempered	Aluminum		Fixed, Double Glazed, Tempered, Dark Bronze Anodized Finish


ylight	Schedule									
ght No.	Location	Rm. No. Frame Width	Frame Length	R.O. Framing Width	R.O. Framing Height Glass Thickness	Туре	Operation	Glass Type	Frame Material Manu	ufact'r. Remarks
			1							
	Kitchen	3'-0"	3'-0"		3/4"		0	Insulated Double Paine, Tempered, UV Protection	Annodized Dark Bronze Aluminum	Fixed, Automatic Night Shade Operation
2	Kitchen	3'-0"	3'-0"		3/4"		0	Insulated Double Paine, Tempered, UV Protection	Annodized Dark Bronze Aluminum	Fixed, Automatic Night Shade Operation
3	Bedroom #1	2'-6"	2'-6"		3/4"		0	Insulated Double Paine, Tempered, UV Protection	Annodized Dark Bronze Aluminum	Remote Control Operation, Automatic Night Shade Operation
4	Guest Suite	2'-6"	2'-6"		3/4"		0	Insulated Double Paine, Tempered, UV Protection	Annodized Dark Bronze Aluminum	Remote Control Operation, Automatic Night Shade Operation
5	Bathroom #2	2'-6"	2'-6"		3/4"		X	Insulated Double Paine, Tempered, UV Protection	Annodized Dark Bronze Aluminum	Remote Control Operation, Automatic Night Shade Operation
3	Master Bathroom	2'-6"	10'-8"		1"		0	Insulated Double Paine, Tempered, UV Protection	Annodized Dark Bronze Aluminum	Fixed, Automatic Night Shade Operation

Owners: Kevin and Dyanne Howley POB 1411 Ross, CA 94957

Howley Residence Remodel 26185 Dolores Street Carmel-by-the-Sea, CA 93923 APN: 009-382-019 Job No. 19-16

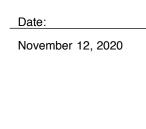

Proposed Door and Window Schedules

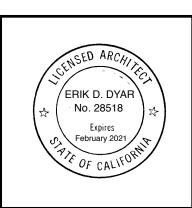

Sheet No.

13




WALL LIGHT LSM3 Micro Cascade, Auroralight Nickel PVD finish 2.5 Watt : 212 Lumen

Exterior Wall Light



Exterior Path Light

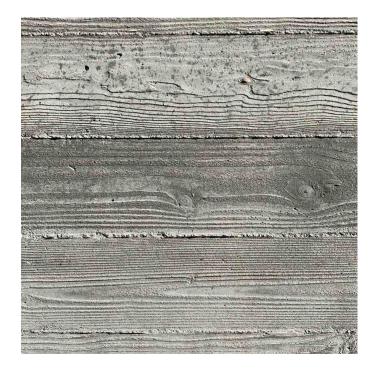

Concrete Balcony, Retaining and Fire Pit Walls Board Form Concrete with Natural Finish



New Concrete Walks, Landings and Stepping Stones Exposed Sand Finish



RECESSED SOFFIT LIGHT 55822, Bega, LED Recessed ceiling down light #4 Brushed aluminum 316 stainless steel finish 4.2 Watt: 299 Lumen

Exterior Recessed <u>Soffit Light</u>



Exterior Wall Sconce Light





Exterior Plaster Wall Finish Color 3-Part Exterior Plaster with Off-White & Light Taupe Gray Color



Exterior Wood Siding & Garage Door Clear Natural Finish



Gates and Screens Horizontal Boards, Clear Natural Finish

Concrete Pavers w/ Planting Strips Concrete Pavers with Low Growing Ground Cover




<u>Flat Roof</u> PTO in Light Gray Color






Existing Privacy Fence 11" Horizontal Clapboards, Painted Finish

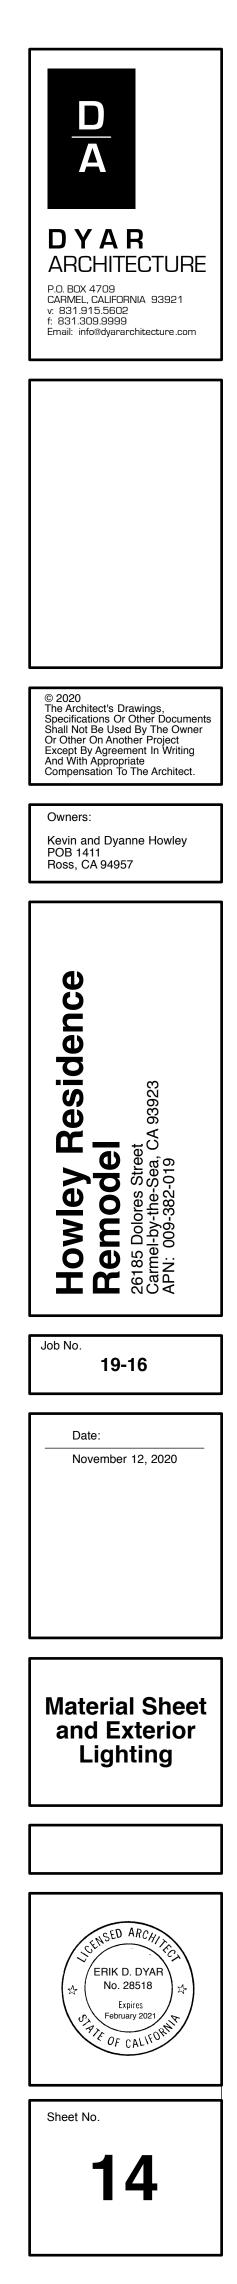



	LIGHTING LEGEND
Sym.	Description
$\oplus$	LED Path Light - HPL7 'Eclipse' by Auroralight, Nickel PVD Finish (2.5 Watt Max., 212 Lumens, 2700K and Dark Sky Compliant)
	LED Step Light - LSM3 'Micro Cascade' by Auroralight, Nickel PVD Finish (2.5 Watt I Lumens, 2700K and Dark Sky Compliant)
	LED Recessed Soffit Light - 55822, by Bega, Stainless Steel Finish (4.2 Watt Max., 2 Lumens, 2700K and Dark Sky Compliant)
¢	LED Wall Sconce Light - Lightology, Leev LED Wall Sconce Light Powder Coated Alur Charcoal Color (10 Watt: 235 Lumens and Dark Sky Compliant)

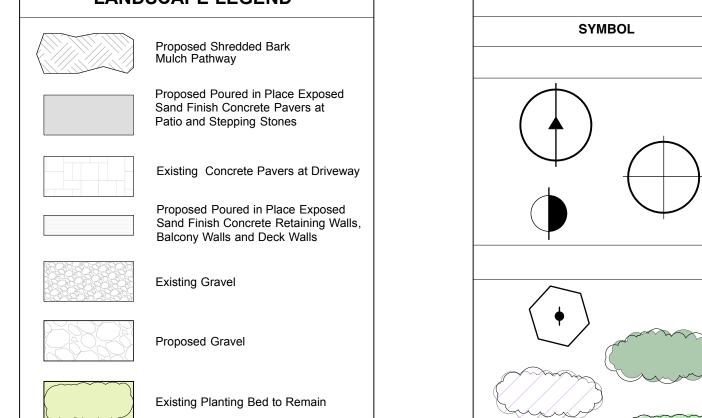

BOTANIC NAME
<u>SHRUBS</u>
Aloe sp.
Carpenteria californica
Polystichum munitum
PERENNIALS
Aloe sp.
Woodland Perennials: Heuchera, Myosot douglasiana
Low Growing Drought Tolerant Succulents Echeveria sp.
Ceratostigma plumbaginoides
VINES