



NOTICE OF APPROVAL

The Department of Community Planning & Building of the City of Carmel-by-the-Sea has approved a Project pursuant to the City's Municipal Code. Persons interested in the project may review additional materials available at the Department of Community Planning & Building located at City Hall on Monte Verde Street between Ocean and 7th Avenues, phone number 831-620-2010.

The decision to approve this project may be appealed within 10 days from the date of this by filing a written appeal with the Department of Community Planning & Building.

Planning Case #: Design Study 20273
Owner Name: FOGG RICHARD & SHARON NEBEN TRS
Case Planner: Marnie R. Waffle, AICP, Senior Planner
Date Posted:
Date Approved: 12/07/2020
Project Location: Junipero 3 SE of Ocean
APN #: 010084021000 BLOCK/LOT: 88/ALL LOT 14
Applicant: Brian Congleton
Project Description: Approval of Design Study (DS 20-273, Fogg-Neben) authorizes minor window and door modifications to an existing single-family dwelling located on Junipero 3 SE of Ocean in the R-1 Single Family Residential District. All project construction shall conform to the plans prepared by Brian Congleton Architect stamped approved and on file in the Community Planning & Building Department, unless modified by the conditions of approval.
Can this project be appealed to the Coastal Commission? Yes ☐ No ☑
Upon completion of the 10 calendar-day appeal period, please return this form, along with the Affidavit of Posting, to the case planner noted above.

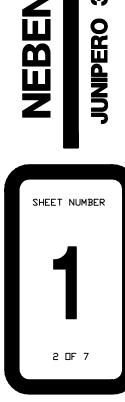

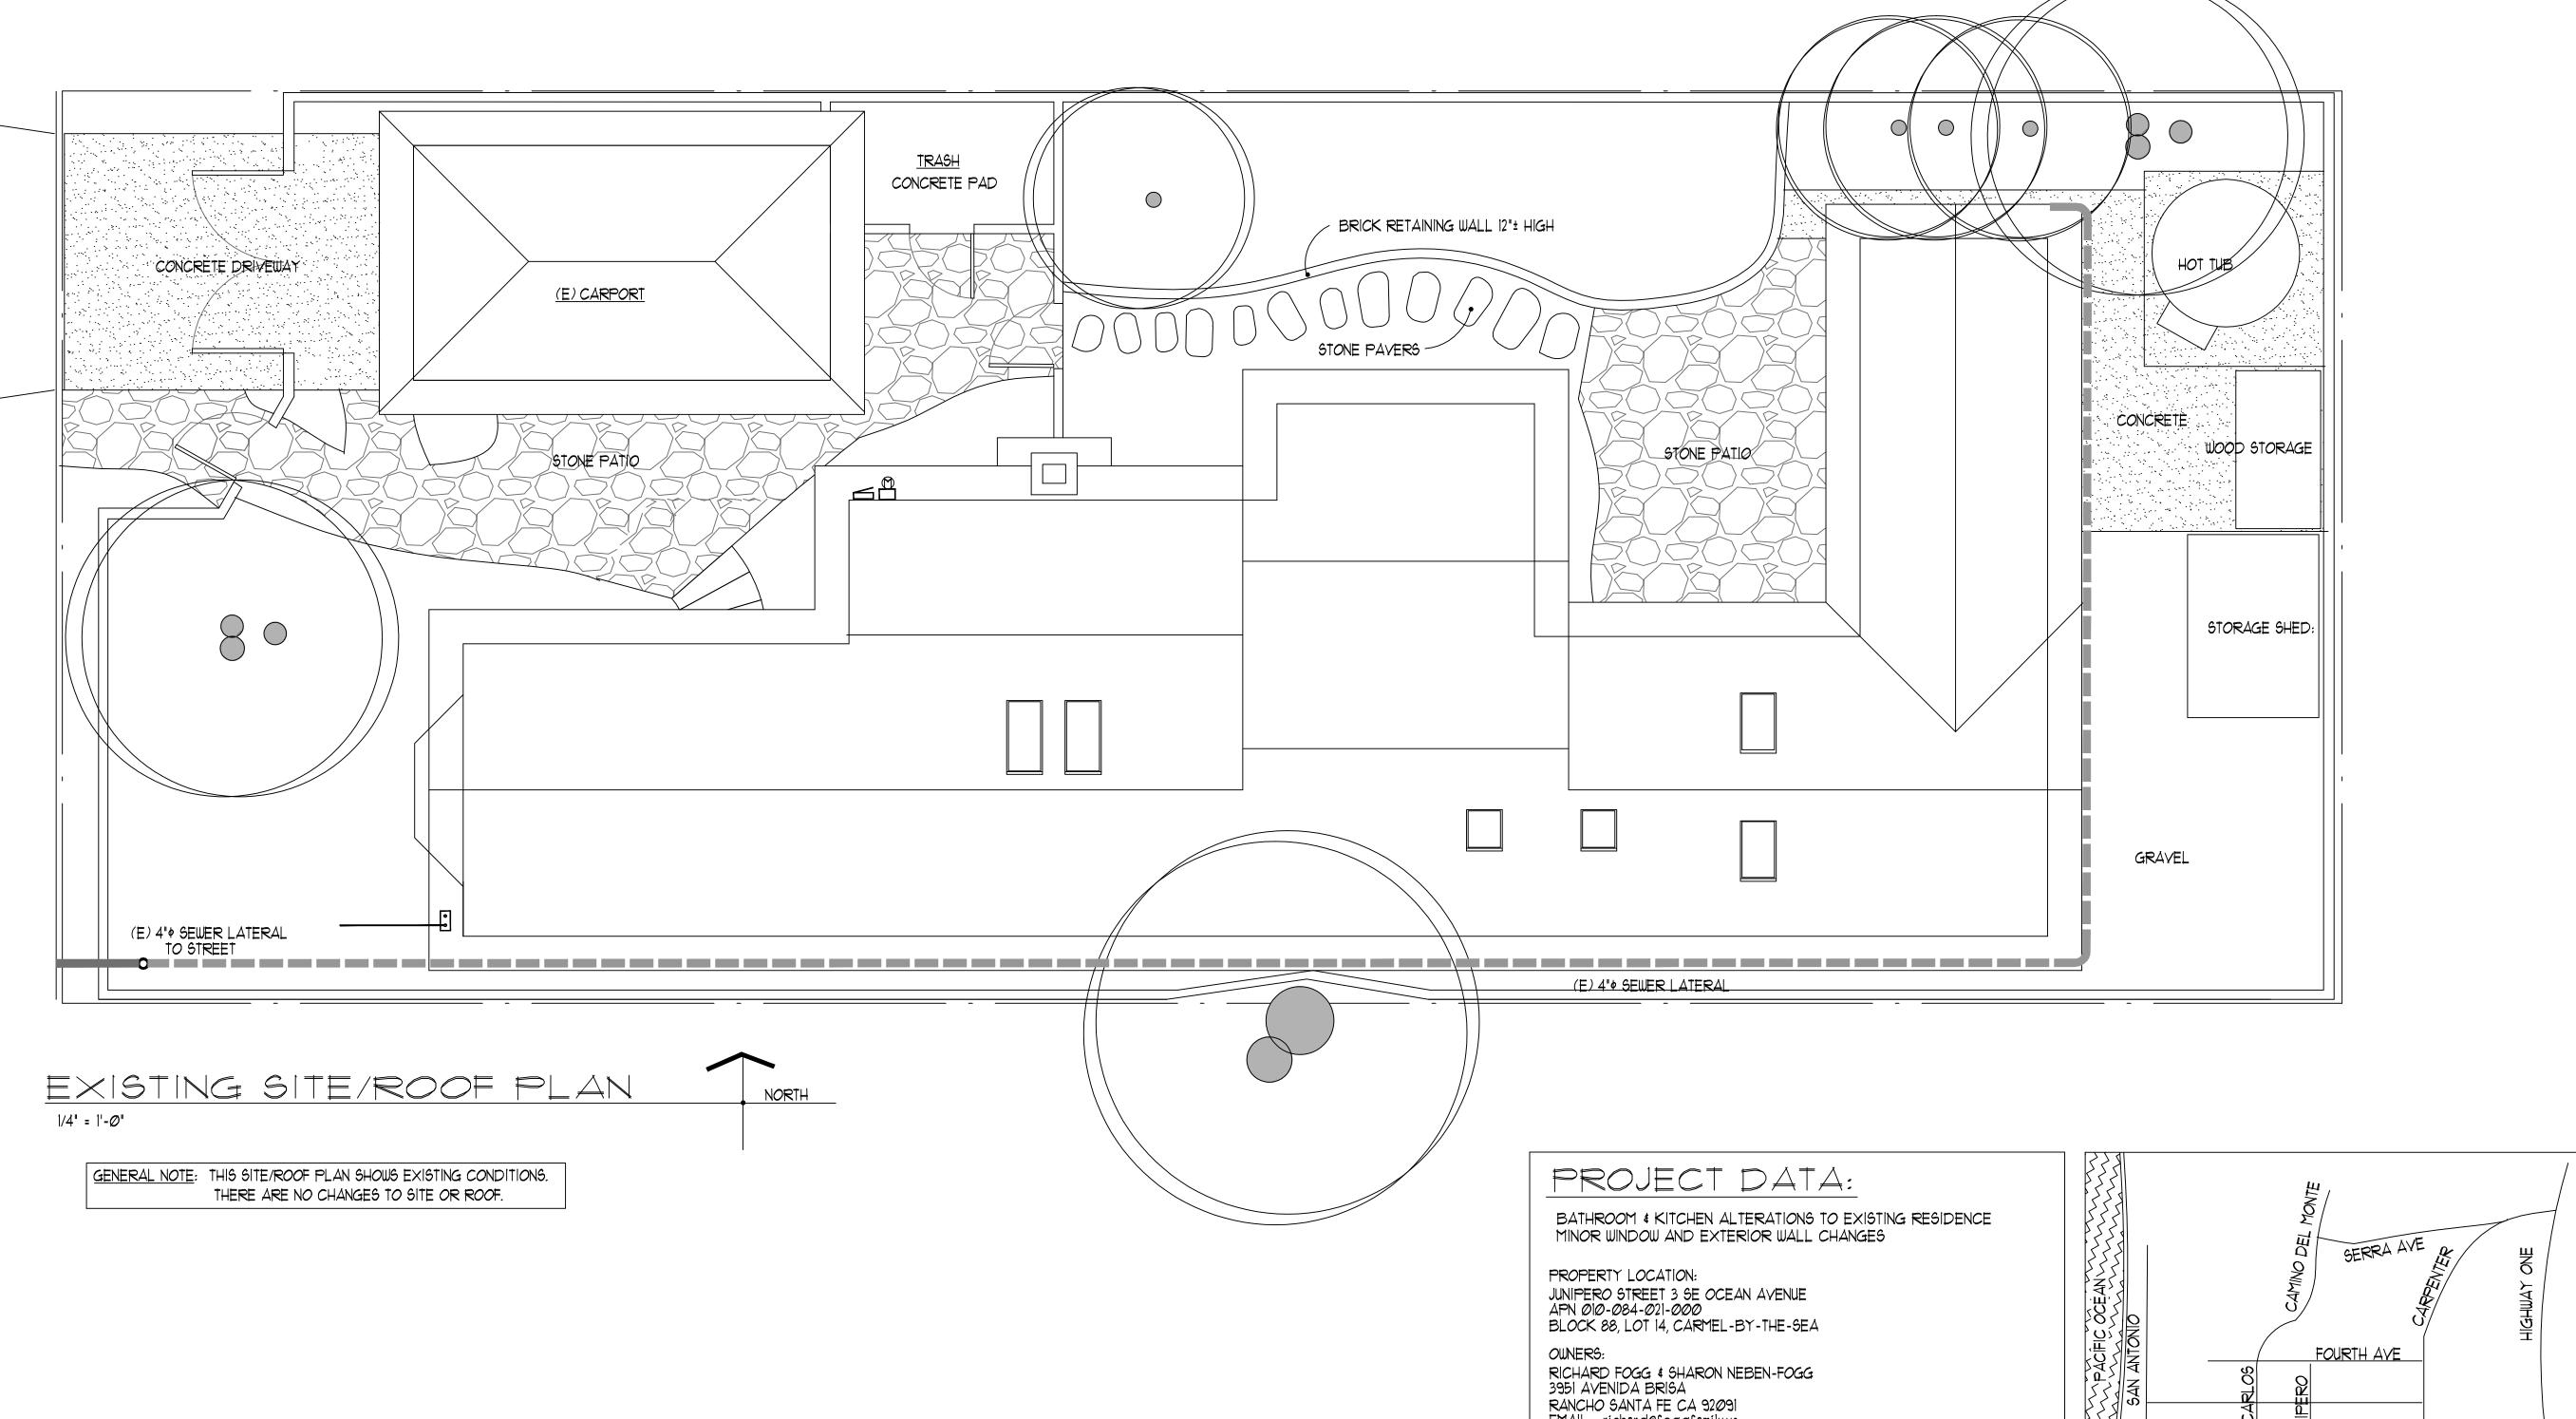

CARMEL-BY-THE-SEA PLANNING DEPARTMENT **APPROVED**

Permit #: DS 20-273 (Fogg-Neben)

Date Approved: <u>12/07/2020</u>

Planner: M. Waffle

RICHARD FOGG & SHARON NEBEN-FOGG 3951 AVENIDA BRISA RANCHO SANTA FE CA 92091 EMAIL: richard@foggfamily.us LOT SIZE: (40x100): 4,000 SQUARE FEET FLOOR AREA: 1,300 SQUARE FEET 188 SQUARE FEET EXISTING HOUSE: EXISTING CARPORT: EXISTING STORAGE SHED: 47 SQUARE FEET TOTAL EXISTING (NO CHANGE): 1,535 SQUARE FEET MAXIMUM ALLOWED FLOOR AREA: 1,800 SQUARE FEET APPLICABLE BUILDING CODES CONSTRUCTION TYPE: Y-B (EXISTING) APPLICABLE CODES:

2019 CALIFORNIA BUILDING CODE 2019 CALIFORNIA RESIDENTIAL CODE
2019 CBC-PLUMBING 2019 CBC-FIRE 2019 CBC-MECHANICAL 2019 CBC-ELECTRICAL 2019 CA RESIDENTIAL CODE 2019 GREEN BUILDING CODE APPLICABLE CONDITIONS OF APPROVAL & CITY PROGRAM REQUIREMENTS:

CARMEL CONSTRUCTION & DEMOLITION RECYCLING REQUIREMENTS MBARD HAZARDOUS MATERIAL REMOVAL AND DISPOSAL REQUIREMENTS CARMEL BMP IMPLEMENTATION

INDEX TO DRAWINGS

SEVENTH AVENUE

SITE/ROOF PLAN 2 FLOOR PLANS

VICINITY MAP

3 EXISTING BUILDING ELEVATIONS 4 PROPOSED BUILDING ELEVATIONS

5 INTERIOR KITCHEN & BATH ELEVATIONS DOOR & WINDOW SCHEDULES, BUILDING DETAILS 6 PROJECT SPECIFICATIONS

OCEAN AVE CHURCH

BMP 142 BEST METHODS PRACTICES SHEETS FS FIRE SPRINKLER CALCULATIONS (SPRINKLERS NOT REQUIRED)

REVISED DESIGN SUBMITTAL PLANNING - DESIGN REVIEW BUILDING - PLAN CHECK OCTOBER 26, 2020

REMOVAL OF IMPROVEMENTS:

REMOVE CABINETRY AND MILLWORK, WALL AND FLOOR FINISHES AS NOTED. REMOYE ANY PLUMBING ELEMENTS NOT TO BE A PART OF THE NEW WORK AND CAP BELOW FLOOR OR

REMOVE ANY ELECTRICAL ELEMENTS NOT TO BE A PART OF THE NEW WORK BACK TO PANEL OR JUNCTION BOX. REMOVE EXTRA OR "WILD" WIRING, REVIEW ALL CIRCUITS AND CLOSE OPEN J-BOXES. REMOVE NON-STRUCTURAL PARTITIONS OR PORTIONS THEREOF AS INDICATED BY DASHED LINE ON

PRESERVE AND PROTECT ELEMENTS NOT TO BE REMOVED, OR ITEMS SET ASIDE FOR RELOCATION AND

WHERE NEW WORK ADJOINS EXISTING, PROVIDE ATTACHMENT OF THE ELEMENTS FOR TIGHT FIT, SECURE CONSTRUCTION, PROPER ALIGNMENT AND PROPER VISUAL APPEARANCE WITHOUT PATCHES, CHANGES IN PAINT OR WALLCOVERING, OR BUTT JOINTING OF TRIM ELEMENTS. IF NECESSARY FOR INTEGRATION OF ELEMENTS, REMOVE SURFACE OF EXISTING ELEMENT AND INSTALL NEW.

NOTE: PROVIDE TEMPORARY SHORING & BRACING AS REQUIRED TO PROTECT EXISTING ELEMENTS DURING REMOVAL & CONSTRUCTION. SHORING & BRACIGN DESIGN IS NOT A PART OF THESE DOCUMENTS

PLUMBING FIXTURE SCHEDULE

TYPE	F.U.	E>	KISTING	PRO	POSED
KIT. SINK/ D.W. KIT. SINK W/ LOW-FLOW D.W.	2.Ø 1.5	1 -	2.Ø -	- 1	- 1.5
WASHER	2.0	1	2.Ø	-	-
LOW FLOW WASHER TUB OR STALL SHOWER	1.Ø 2.Ø	2	- 4.Ø	1	1.Ø 2.Ø
TUB PLUS SHOWER @ MASTER	₹ 3.Ø 1.Ø	- 2	2.0	<u> </u>	3.Ø 1.Ø
2 LAVS @ MASTER	1.0		-	<u> </u>	1.0
W.C. HET WC.	1.8 1.3	2	3.6 -	- 2	- 2.6
HOT WATER LOOP	-0.5	-	-	1	-0.5
TOTAL			13.6		11.6

MECHANICAL/ELECTRICAL SYMBOLS

EXISTING ELEMENTS TO REMAIN ARER NOT SHOWN. ITEMS TO BE REMOVED ARE NOT SHOWN -SEE DEMOLITION NOTES

HIGH-EFFICACY RECESSED DOWNLIGHT

SURFACE MOUNTED CEILING LIGHT WALL MOUNTED LIGHT

HIGH-EFFICACY UNDERCABINET LIGHT

EXHAUST FAN W/HUMIDISTAT CONTROL

PDISP

SMOKE DETECTOR - MOUNT ON CEILING OR @ TOP OF WALL - 110Y AC POWERED W/ BATTERY BACKUP.

CARBON MONOXIDE ALARM. MAY BE A COMBINATION UNIT WITH SMOKE DETECTOR.

ELECTRICAL PANEL

ELECTRIC METER/MAIN BREAKER

WATERPROOF/WEATHERPROOF

HIGH-EFFICACY LIGHT FIXTURE EXISTING OUTLET, SWITCH OR LIGHT TO REMAIN

WALL SWITCH

DIMMER WALL SWITCH

THREE WAY WALL SWITCH

110 V OUTLET

110 Y. DUPLEX WALL OUTLET GROUND FAULT CIRCUIT INTERRUPTER

220 V. OUTLET

RECESSED WASHER HOOKUP W/ HOT & COLD FAUCETS & 2" DRAIN

NOTES - MECHANICAL/ELECTRICAL:

LAYOUT

ELECTRICAL LAYOUT SHOWN ON THESE PLANS IS PROVIDED AS A GUIDE OWNER TO MAKE FINAL DETERMINATION OF FIXTURE, SWITCH AND OUTLET LOCATIONS, BUT IN ACCORDANCE WITH CODE REQUIREMENTS. OWNER LAYOUT AND/OR CODE REQUIREMENTS MAY RESULT IN VARIATIONS FROM ELEMENTS SHOWN. FIELD VERIFY WITH OWNER PRIOR TO INSTALLATION.

* CENTRALLY LOCATED IN CORRIDOR LEADING TO SLEEPING AREAS. ON CEILING OF UPPER LEVEL IN CLOSE PROXIMITY TO THE STAIRWAY.

ARC FAULT CIRCUIT INTERRUPTOR REQUIRED IN ALL AREAS EXCEPT BATHROOM: ARC-FAULT CIRCUIT INTERRUPTER CIRCUIT BREAKERS @ PANEL OR OUTLET. TUBS & SHOWERS: PRESSURE VALVE OR THERMOSTATIC MIXING VALVE TO LIMIT WATER TEMP TO 120 DEGRESS F.

BATHROOM FAN SHALL BE ENERGY STAR RATED W/HUMIDISTAT CONTROL LIGHT SOURCES SHALL BE CONTROLLED BY DIMMER OR VACANCY SENSOR:

A. CEILING RECESSED DOWNLIGHTS

B. GU-24 SOCKETS CONTAINING LED LIGHT SOURCES


C. ANY LIGHT SOURCE LISTED AS COMPLYING WITH REFERENCE JOINT APPENDIX JAS.

D. ONE BATH LIGHT SHALL BE CONTROLLED BY VACANCY SENSOR. LOCATED IN CLOSETS LESS THAN 10 SF OR IN HALLWAYS ARE EXEMPT. ALL LIGHTS TO BE HIGH-EFFICACY PER TABLE 150.0-A OF CEC 150(K)A.1.A PLUMBING FIXTURES SHALL MEET THE FOLLOWING WATER CONSERVATION

REQUIREMENTS (2019 CBGSC):

* TOILETS: 1.28 GALLONS PER FLUSH * SHOWERS: 1.8 GALLONS PER MINUTE FLOW.

* FAUCETS: 1.2 GALLONS PER MINUTE FLOW.

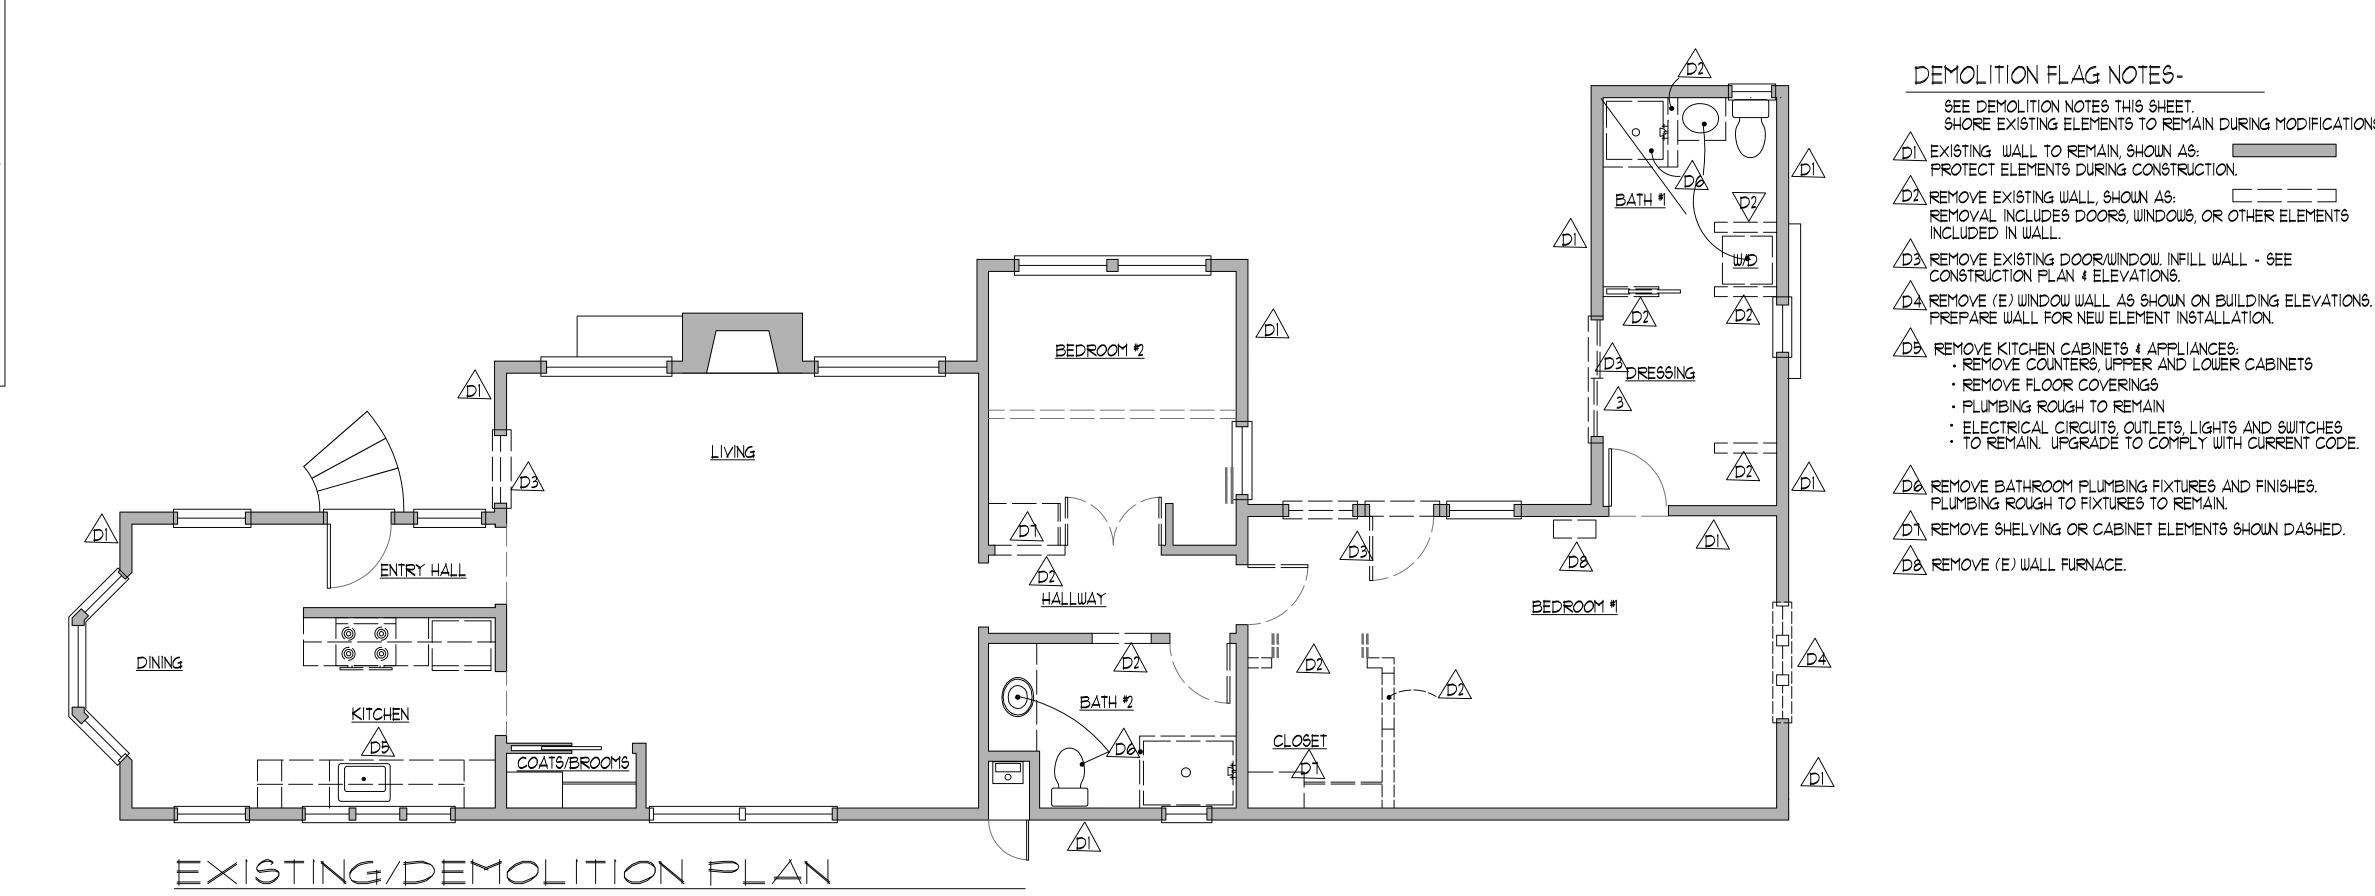

FLAG NOTES

/I\ EXISTING WALL TO REMAIN, SHOWN AS: PROTECT ELEMENTS DURING CONSTRUCTION.

SEE DEMOLITION NOTES THIS SHEET.

CONSTRUCTION PLAN & ELEVATIONS.

· REMOVE FLOOR COVERINGS · PLUMBING ROUGH TO REMAIN

PLUMBING ROUGH TO FIXTURES TO REMAIN.

INCLUDED IN WALL.

PROTECT ELEMENTS DURING CONSTRUCTION.

PREPARE WALL FOR NEW ELEMENT INSTALLATION.

SHORE EXISTING ELEMENTS TO REMAIN DURING MODIFICATIONS.

REMOVAL INCLUDES DOORS, WINDOWS, OR OTHER ELEMENTS

ELECTRICAL CIRCUITS, OUTLETS, LIGHTS AND SWITCHES
TO REMAIN. UPGRADE TO COMPLY WITH CURRENT CODE.

NEW INTERIOR WALL 2x4'S @ 16" O.C.

SÍNGLE PRESSÚRE-TREATED BOTTOM PLATE, DOUBLE TOP PLATE 31/5" SOUND BATTS 1/2" GYPSUM DRYWALL, SMOOTH FINISH & PAINTED.

INFILL OPENING FOLLOWING REMOYAL OF WINDOW OR DOOR.

MATCH ADJACENT (E) WALL MATERIALS. SEE ELEVATIONS. /A\ NEW DOOR IN (E) WALL.

NEW WINDOW IN EXISTING ROUGH OPENING REPLACES EXISTING ALUMINUM WINDOW. ALUMINUM CLAD WOOD, TEMPERED INSULATED

NEW WINDOW FRAMED INTO NEW INFILL WALL @ FORMER SLIDING GLASS DOOR. MATCH WINDOW ON EAST WALL OPPOSITE.

CONNECT NEW PLUMBING FIXTURE (TUB, SHOWER, LAY) TO EXISTING ROUGH WATER AND WASTE FOLLOWING REMOVAL OF EXISTING FIXTURES.

NEW HET TOILET REPLACES (E) TOILET. NO CHANGE TO PLUMBING ROUGH OR TOILET LOCATION.

EXTEND WATER & WASTE IN WALL FROM SHOWER TO RELOCATED LAVS.

STEAM SHOWER @ BATH #1: TEMPERED GLASS ENCLOSURE TO CEILING -SEE ELEVATIONS. SLOPE SHOWER CEILING I' TO NORTH TO DRAIN DOWN NORTH WALL. STEAM GENERATOR ON EAST EXTERIOR WALL

STEAMIST 'ELITE STEAM' ELS-7, I5" \times 6" \times 15.5" WALL MOUNT. 240V, 7.5 KW. TILE SEAT IN SHOWER. SEE BATH ELEVATIONS.

TEMPERED GLASS SHOWER ENCLOSURE

RELOCATED STACK WASHER/DRYER CONNECT WASTE, HOT & COLD WATER PIPES IN CRAWL SPACE. * PLUMBING VENT AND DRYER VENT THROUGH ROOF. * PAN UNDER STACK UNIT - DRAIN TO EXTERIOR

* ACCESS PANEL IN BATH *2 TO ACCESS HOOKUPS. * SEE INTERIOR ELEVATION G/5.


/B REPLACE KITCHEN CABINETS, FIXTURES, APPLIANCES AND FLOORING. * ALL EXISTING ELECTRICAL, PLUMBING ROUGH, AND FINISHES TO REMAIN. * UPGRADE ELECTRICAL LIGHTING AND OUTLETS TO COMPLY WITH CODE. * REPLACE (E) ELECTRIC RANGE W/ GAS RANGE.

/IA STONE OR TILE FLOORING IN KITCHEN/ENTRY, BATHROOMS & LALUNDRY. INSTALL TILE OVER CEMENTITIOUS BACKING BOARD IN ALL AREAS EXCEPT SHOWERS. INSTALL SHOWER PANS AS SHOWN IN DETAIL D/6. NON-SLIP TILE IN BATHROOM AREAS. OWNER TO SELECT TILE & GROUT.

/1A WIDEN DOOR OPENING TO ACOMMODATE 2'-8' MIN. DOOR FOR WASHER/ DRYER INSTALLATION.

RELOCATE LIGHT SWITCH ADJACENT TO RELOCATED DOOR.

ALIGN EAST FACE OF NEW WALL TO WEST SIDE OF (E) SKYLIGHTE UND

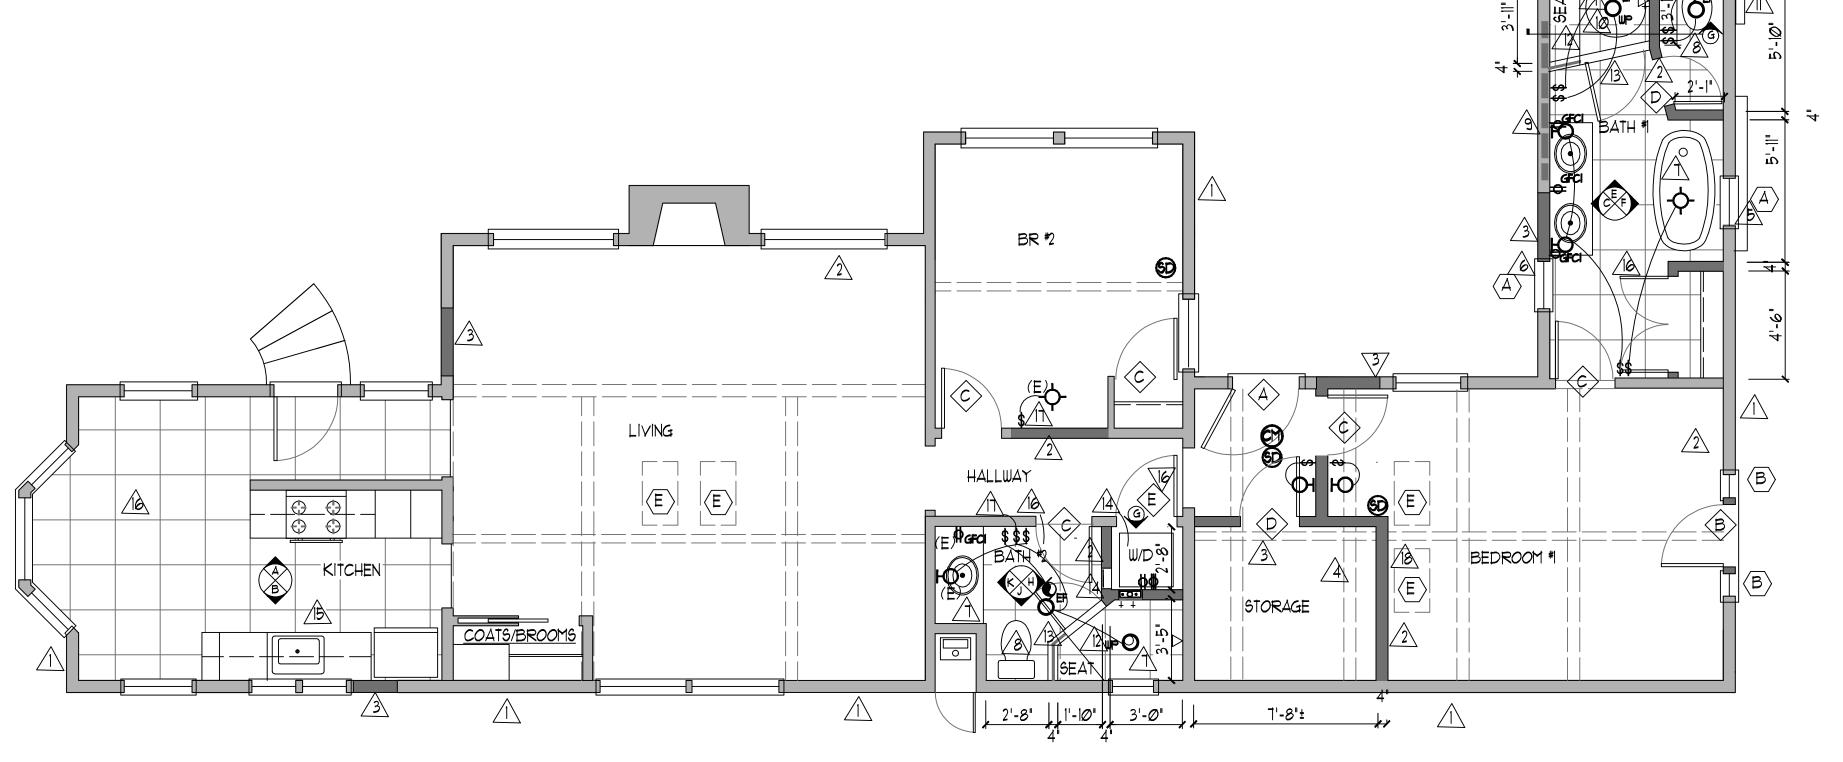

PROPOSED FLOOR PLAN

1/8" = 1'-0"


1/4" = $1'-\emptyset$ "

EXISTING & PROPOSED PLANS

manner is prohibited without the prior ex oress written cons the Architect. DRAWN: BTC DATE: 10-26-20

SHEET NUMBER



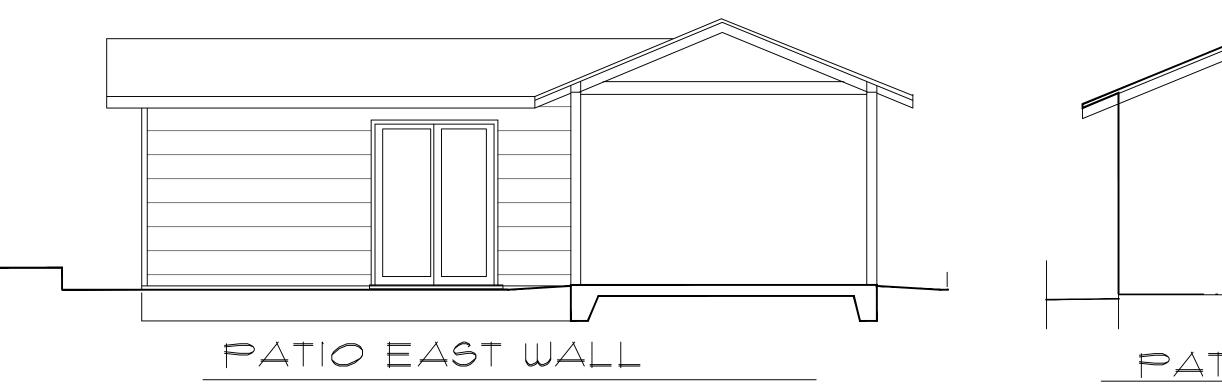









These drawings and the designs represented herein are the property of Brian T. Congleton, Architect. Use in any manner is prohibited without the prior express written consent of the Architect.

DRAWN: BTC
DATE: | 0-26-20
REVISED:

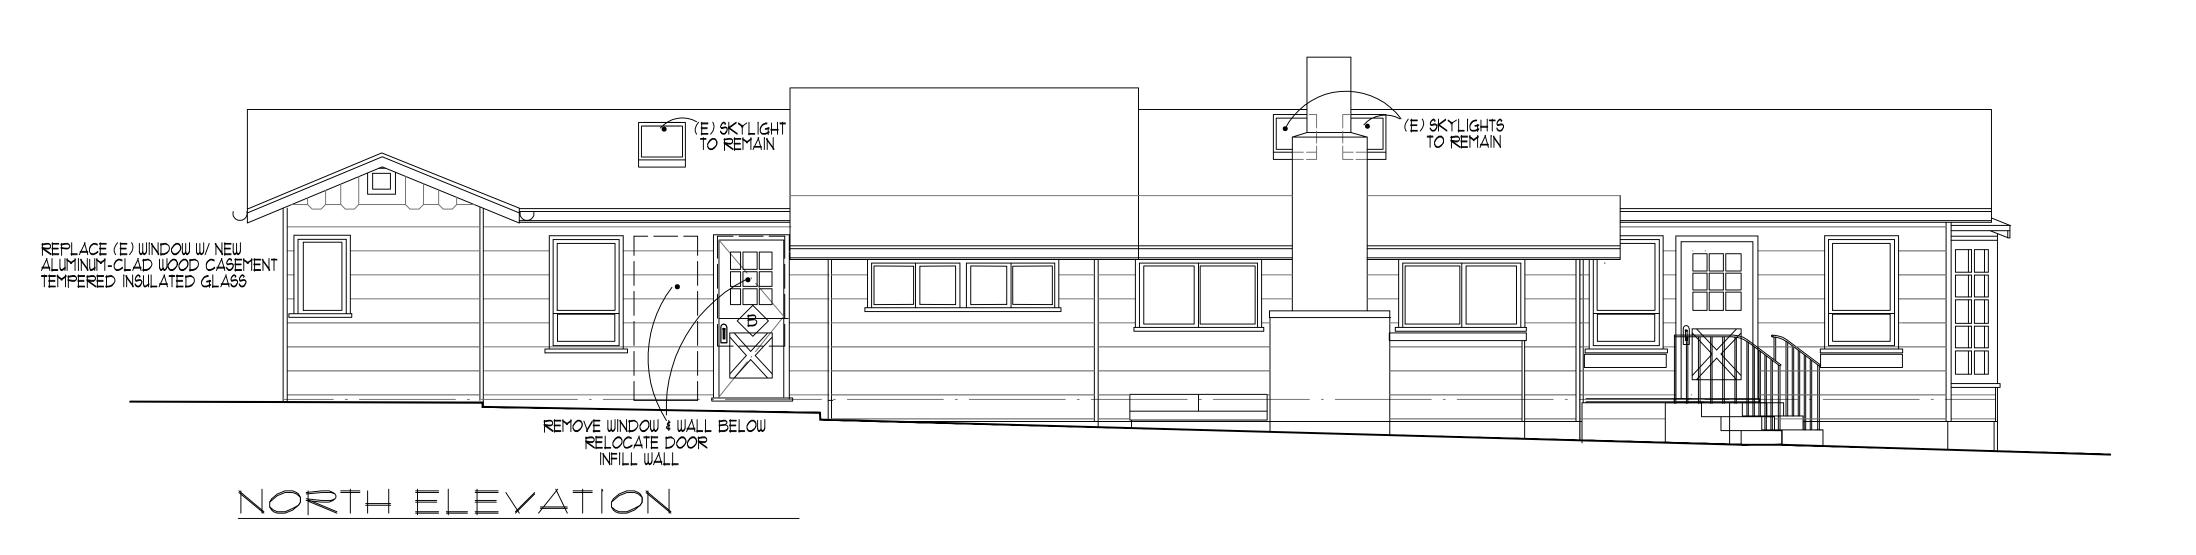




WEST ELEVATION

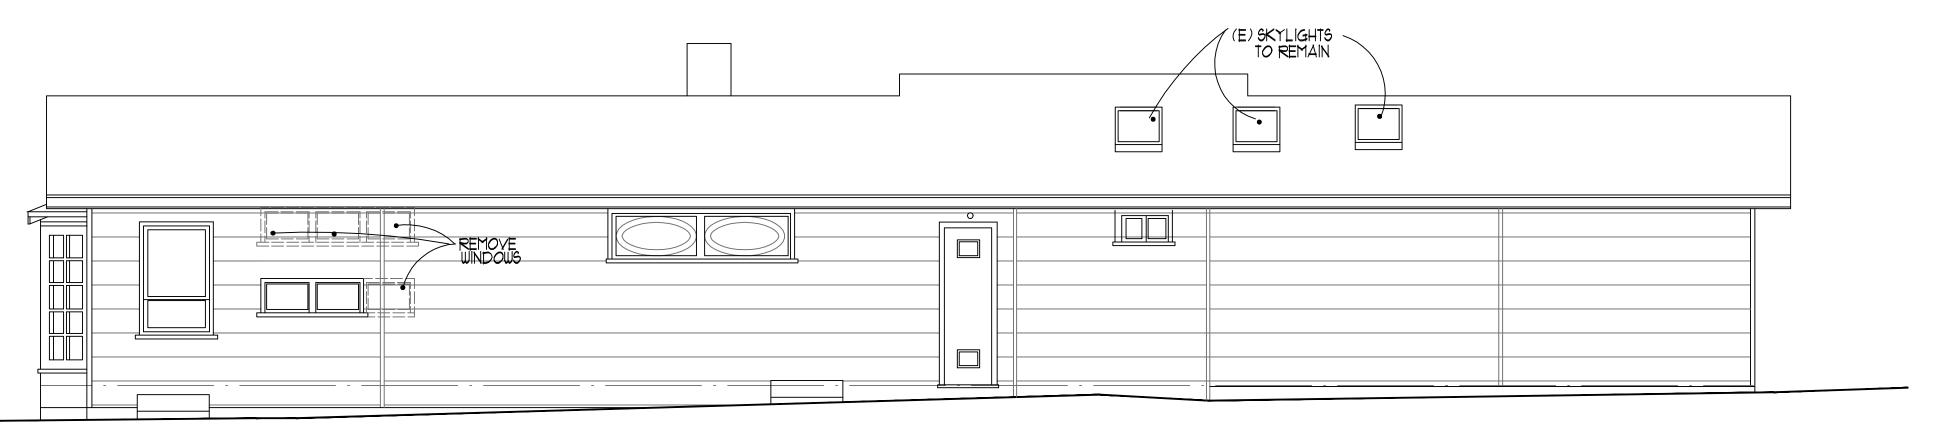


SOUTH ELEVATION

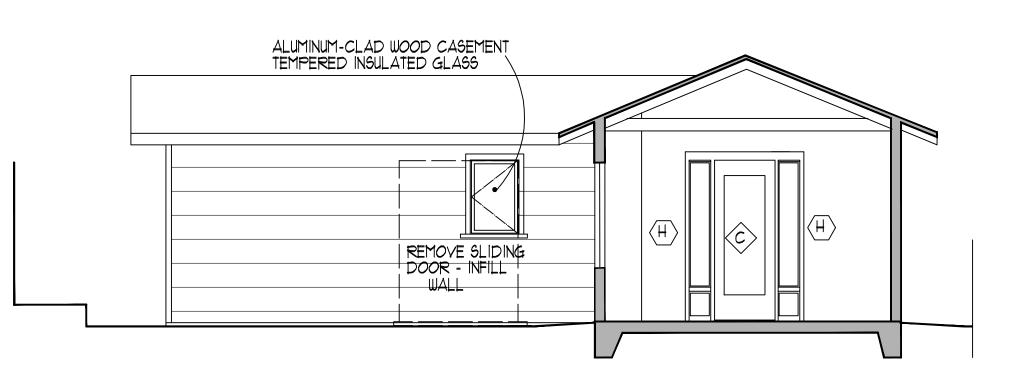


BATH WEST WALL FACING PATIO





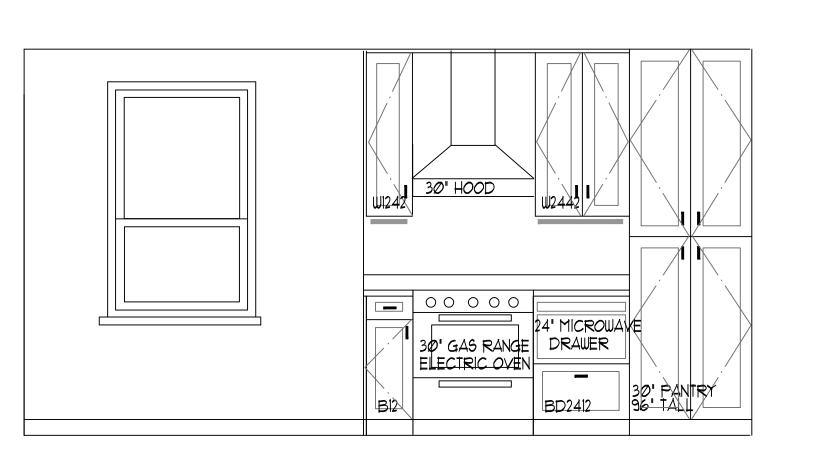


A KITCHEN NORTH WALL

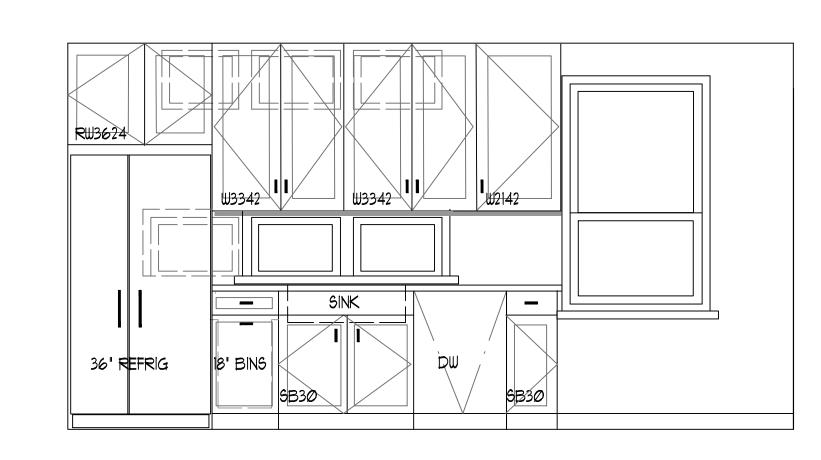

(B) KITCHEN SOUTH WALL

KITCHEN ELEVATIONS

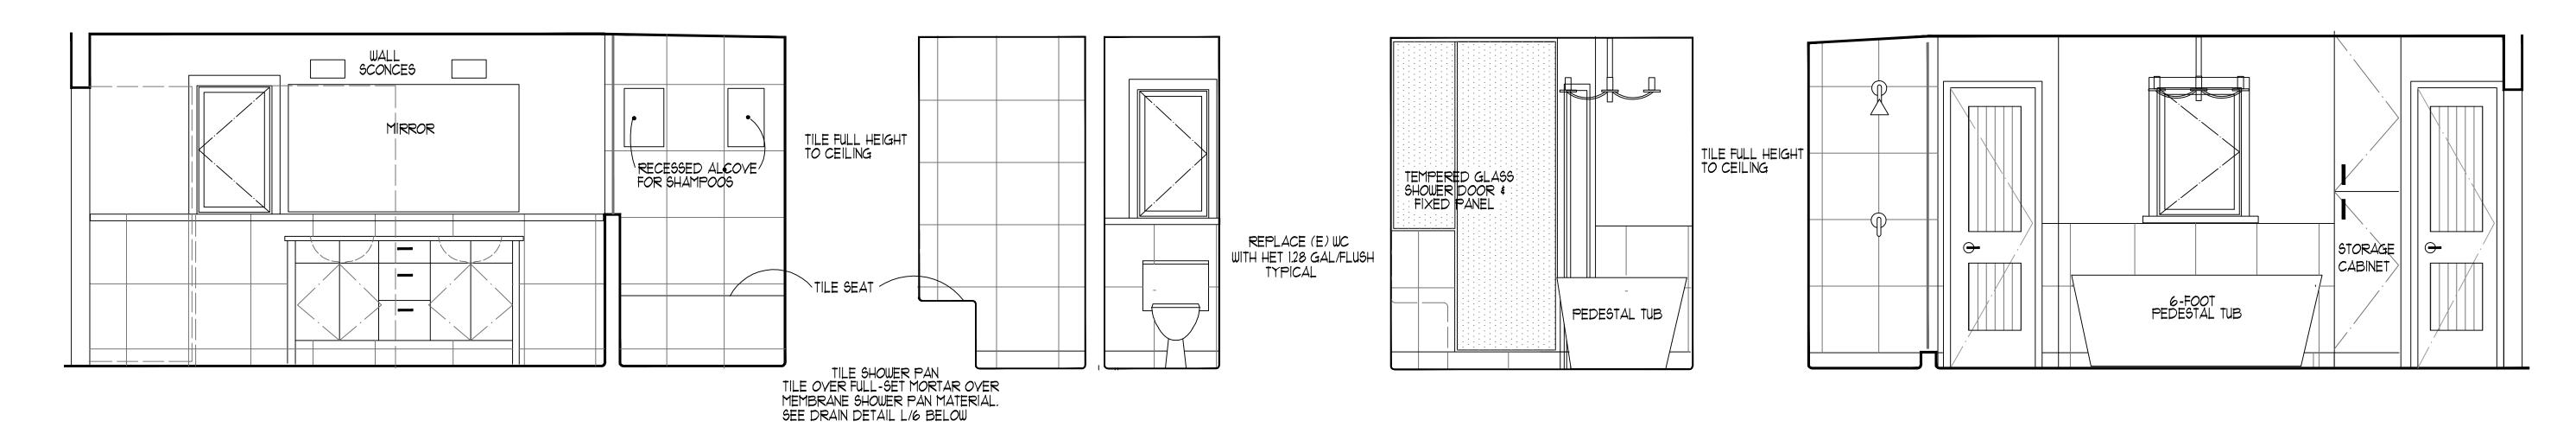


C BATH #1 WEST WALL

D BATH #1 NORTH WALL/SHOWER

EBATH # NORTH WALL

(F) BATH #1 EAST WALL

BATH #1 ELEVATIONS

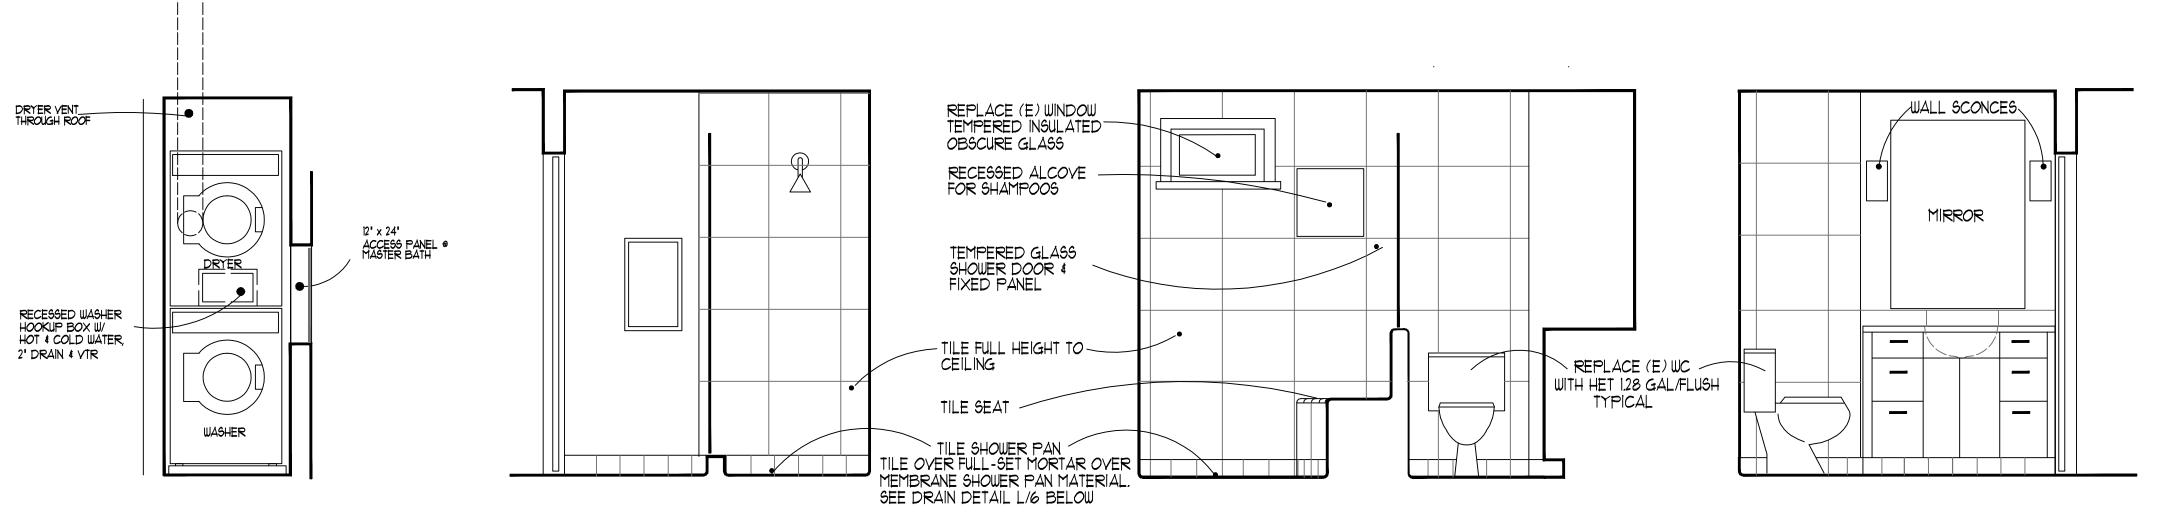

(G) WASHER/DRYER

(H) BATH #2 EAST WALL

(J) BATH #2 SOUTH WALL

(K) BATH #2 WEST WALL





DIVISION I - GENERAL REQUIREMENTS 1.01 Description of Project:

Interior (bath, kitchen) alterations to existing residence. Exterior alterations - window and door revisions.

.04 Instructions to Contractor: Unless otherwise stated, all items herein are instructions to the contractor in his execution of the work. All references refer to the general contractor; the general contractor is responsible for

coordination of all subcontractors, trades, and suppliers. .05 Licensed and qualified contractor: These drawings and designs are prepared for use by a properly licensed and certified contractor, having experience in executing projects of this scope and difficulty. By contracting to perform the work, contractor assumes responsibility for performance of the work in accordance with all applicable codes and ordinances, building and construction standards. These drawings are not prepared for

use by an owner/contractor, or other unlicensed or unqualified person or entity, and architect holds no liability for said use of the drawings.

1.06 Use of Alternate Materials or Methods: The use of alternative materials or methods or "equals" is prohibited unless submitted to and approved by the architect in writing prior to execution of the work. Contractor shall be responsible for any modifications required to incorporate said alternate into the work, including additional architect fees incurred to accomodate said incorporation. Where brand specification is not provided herein, contractor shall submit samples and cut sheets to owner and architect for approval prior to work.

12 Architect/Engineer review of work & project support: The architect will make periodic review of work during active periods of construction. The contractor shall notify the architect when work elements are in place but not covered over. Some review points include: concrete reinforcement prior to pour, framing and systems installation prior to wall covering, roof and waterproofing elements, and other elements unique to the project. Architect is also available to assist in interpretation and clarification of the design and drawings, and to resolve conflicts between the design and site conditions. Architect shall be contacted immediately if such conflicts are encountered, allowed to view the work and provide input for appropriate resolution. Obtain said input prior to proceeding with or covering work.

1.12 Existing Hazardous Materials:

These drawings do not include assessment or recommendations regarding possible presence of hazardous materials. The Architect does not have knowledge regarding presence of hazardous materials. If potential exists or required by code, have material tested by certified consultant.

..09 Project Closeout At completion of project:

A. Remove waste materials, debris and rubbish.

B. Remove grease, dust, dirt, stains, labels, fingerprints and foreign materials from surfaces,

C. Repair, patch and touch up marred surfaces. D. Vacuum clean all interior spaces inc. inside cabinets.

E. Broom clean paved surfaces, rake clean grounds. F. Assemble and provide for the owner all spare parts and maintenance materials, operation and maintenance manuals.

DIVISION SIX: WOODS

6.03 Finish Carpentry: Materials and workmanship shall conform to "Custom" grade requirements of the WIC quality standard specification.

A. Trim: Clear pine, paint grade. Fingerjoint ok for non-structural elements. B. Hardwood: Red oak, apple, ash, or approved equal clear, stain grade.

. Stain: To be determined and approved by owner. D. Cabinets: Selected by owner.

E. Countertops Selected by owner.

DIVISION SEVEN: THERMAL AND MOISTURE PROTECTION

7.05 Flashings and Sheet Metals

Provide flashings and sheet metal necessary to make building weathertite, whether or not indicated. Perform in accordance with Sheet Metal and Air Conditioning Contractor's Manual, "Architectural Sheet Metal Manual". Materials shall be galvanized steel, zinc coated sheet steel, Class D, ASTM A93, minimum 24-gauge US Standard. Solder for galvanized sheet metal shall conform to ASTM B32, Alloy grade 40A. Flux shall be rosin; use non-corrosive flux where application conditions prohibit use of rosin. Fastenings shall not support galvanic action. Installed sheet metal shall not be distorted, nor fastenings stressed from expansion or contraction. Expansion joints shall be provided where necessary, constructed weathertite. Exposed edges shall be smooth, free from burrs and cuts. Exposed surfaces shall be painted, color to be selected by architect.

7.06 Caulking and Sealants: A. Guarantee: Sealants shall be guaranteed by the contractor for a minimum of two years.

B. Materials: 1. General Exterior Caulking: One-part acrylic terpolymer (or approved equal) as

manufactured by Tremco. 2. General Interior Caulking: One-part acrylic caulking, "Sashco" water-release

type, or approved equal. 3. Back-Up Material: Untarred oakum, fiberglas, polyurethane or polyethylene foam.

No oily or asphaltic type materials may be used. 4. Colors: Shall be approved by architect.

C. Application: Surfaces must be clean, dry and free of corrosion, scale, rust, oil, wax, paint and other contaminants before primer is applied. Where necessary, pack joint with back-up material for desired sealant depth. Depth shall not be greater than the width and not less than 1/4" wide. Work that is exposed to view shall have a uniform surface with neat, straight edges and no excess material on adjacent surface.

DIVISION EIGHT: DOORS, WINDOWS AND GLASS

8.02 Wood stile and panel doors: Shall be manufactured door units, by T.M.Cobb or equal. Units shall be prehung asembly, with douglas fir, alder or pine stile—and —rail frames and inset panels. Door & frames shall be stain or paint grade, selected by the owner from standard TMCobb patterns.

8.04 Hardware:

A. Hinges: As manufactured by Stanley, Hager, Johnson or approved equal. Minimum of 1-1/2 pair of 4-1/2" butts per leaf. Exterior hinges shall have non-removable pin. B. Locks: As manufactured by Schlage or approved equal. Cylinders shall be 6-pin type, keyed according to owner requirements. Use Schlage D series or better lock sets. Keying shall be by Schlage Lock Company or a locksmith approved by the owner. Backsets shall be 2-3/4" unless otherwise noted.

C. Finish: Shall be selected by owner/architect based on contractor submittal. 8.07 Wood Windows: Manufactured by Marvin, Sierra-Pacific, or equal approved by owner and architect. Windows shall be aluminum clad stain or paint grade wood. See door & window schedule. Provide submittals & measure openings prior to ordering.

DIVISION NINE: FINISHES

9.02 Gypsum Wall Board: Shall be sheetrock, gypsum panels of the thickness indicated on the drawings or required by code. Gypsum board shall be taped and finished with a smooth finish. Joint treatment products, perforated tape and joint compound shall be applied in accordance with manufacturer's instructions. Install wonderboard wherever ceramic tile is to be applied. Radius (bullnose) gypsum board corners.

9.04 Painting: All exposed surfaces not factory finished, shall receive paint or stain as follows: Exterior Walls: Primer plus two coats latex house paint.

shall be made by owner and contractor, but must be code-compliant.

Exterior Trim: Primer plus two coats exterior latex semigloss. Interior Walls and Ceilings: Two coats latex flat.

Interior Trim: Primer plus two coats latex semigloss.

Bathroom Walls, Ceilings, Trim: Two coats latex semigloss. G.I. sheetmetal flashings, gutters, downspouts, etc.: Metal primer plus two coats latex

semigloss Colors: Selected by owner. DIVISION FIFTEEN - MECHANICAL:

15.01 Plumbing:

* Interior water piping: Copper tube, type L, wrought-copper fittings, soldered joints, 3/4" main lines, 1/2" fixture branch lines. Install hot water loop. Solder: Max. 2% lead (meet UPC requirement). * Interior water piping: (Contractor option): Pex supply water system. Install per mfgr. recommendations.

* Above-ground soil waste & vent piping: Cast-iron or ABS plastic. Wrap ABS with sound insulation. * Gas supply piping: Black iron.

* Plumbing fixtures shall meet the following water conservation requirements: Toilets: 0.8 gallons per flush; showers: 1.8 gallon per minute flow; faucets: 1.5 gpm flow.


* Trim shall be as manufactured by Delta, Moen, Kohler or approved equal. See allowances. * Fixtures selected by owner.


15.02 Heating & Ventilating * Exhaust Fans: Location as shown on plans, as manufactured by Moen, Penn-Zephr or approved


* Steam shower: Electric steam generator, Steamist 'Elite Steam ELS-7 steam generator, 240V, 7.5 KW

DIVISION SIXTEEN: ELECTRICAL

16.01 Electrical Service and Branch Wiring. Light, outlet, and switch locations are shown in these drawings. Locations are schematic, and provide a quide for permit review and construction layout. Verify locations of all elements with owner in open frame building prior to commencement of installation. Final location of elements

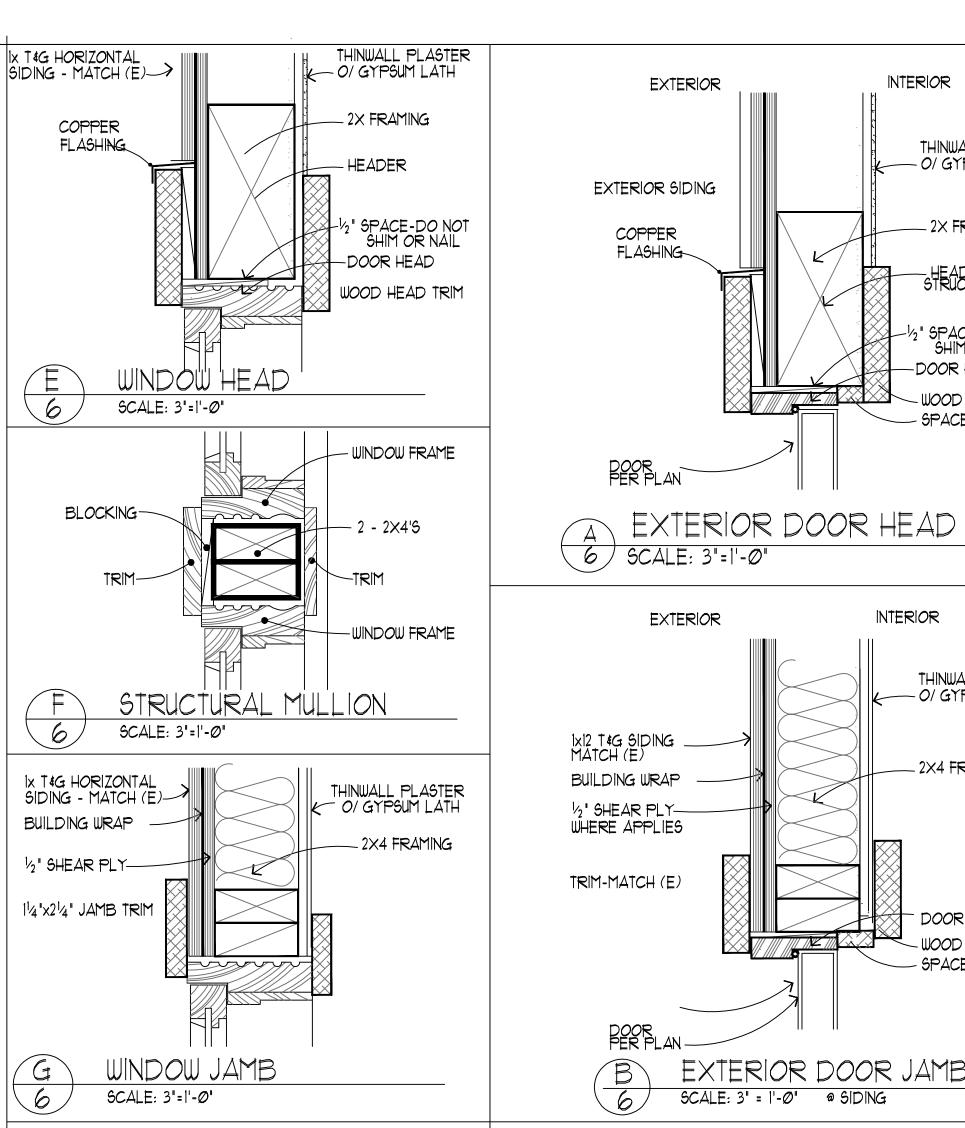

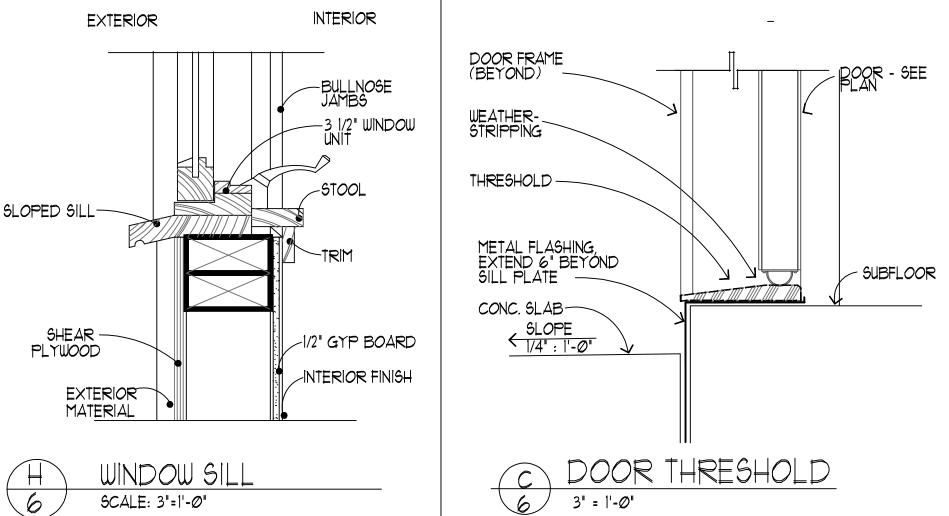


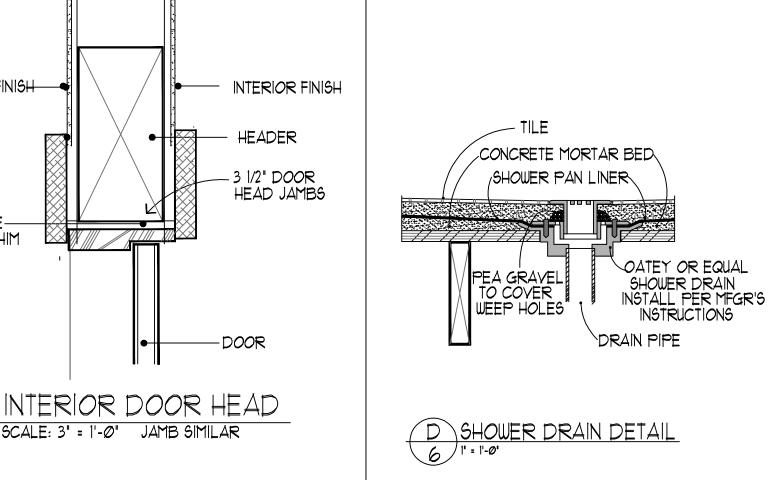

INTERIOR FINISH-

½"± SPACE-

DO NOT SHIM

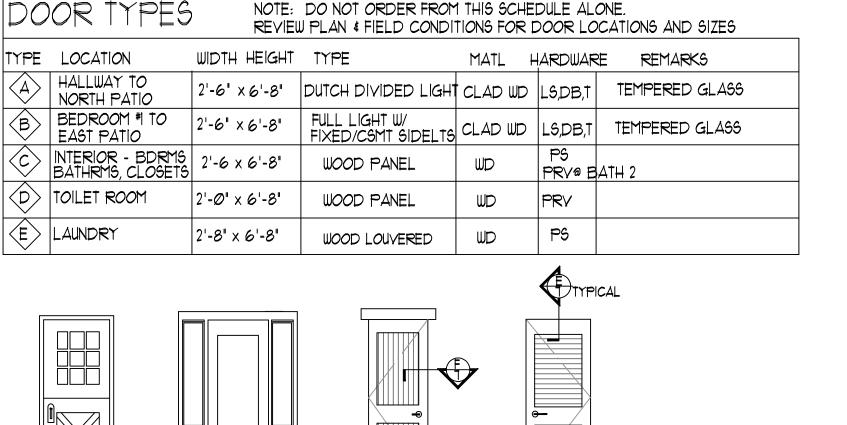

INTERIOR

THINWALL PLASTER

O/ GYPSUM LATH

2X FRAMING

" SPACE - DO NOT

SHIM OR NAIL

DOOR HEAD

SPACER

- O/ GYPSUM LATH


- 2X4 FRAMING

DOOR JAMB

SPACER

WOOD HEAD TRIM

INTERIOR

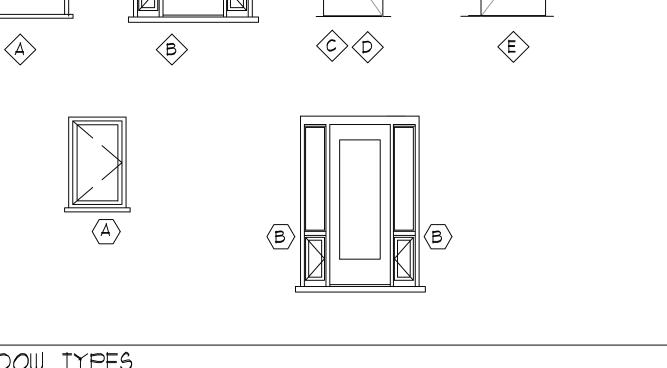

WINDOW TYPES								
WD0 TYPE	UNIT WIDTH		UNIT HEIGHT	MATERIAL	TYPE	FLOOR TO SILL	FLOOR TO HEAD	REMARKS
$\langle A \rangle$	2'-6"	X	3'-Ø"	CLAD WOOD		3'-8"	6'-8"	CLAD COLOR: WHITE TEMPERED GLASS
B	1'-10"	X	6'-6"±	CLAD WOOD	FIXED/CASEMENT SIDELIGHT DOOR C	Ø'-2"±	6'-8"	CLAD COLOR: WHITE TEMPERED GLASS
					<u> </u>			

T DB LS PS PRV TEMP. INGUL	THRESHOLD DEADBOLT LOCKSET PASSAGE SET PRIVACY SET TEMPERED INSULATED
INSUL	INSULATED
PR	PAIR

DOOR/WINDOW NOTES

"WINDOW WALL

WINDOWS.

FIELD VERIFY ALL OPNG

SIZES PRIOR TO WINDOW

MULTIPLE UNITS FORM A

FABRICATION. OPNGS MAY

2. NEW WINDOW UNITS SHALL BE

SHALL BE PAINTED WOOD.

. WINDOWS NOT LABELLED ON

PROVIDE SCREENS W/ ALL

OPERABLE WINDOWS.

3 TEMPERED GLASS WHERE

ELEVATIONS ARE EXISTING

6 INSTALL HEAD & SILL FLASHING @ ALL WINDOWS & DOORS.

REQUIRED BY CODE, WHETHER OR NOT INDICATED ON PLANS.

3. MULLIONS ON WINDOWS & DOORS

SHALL BE TRUE DIVIDED LIGHT.

CLAD WOOD SIERRA PACIFIC

VARY, PARTICULARLY WHERE

_EGEND

rchitect, Use in an anner is prohibited ithout the prior ex ess written cons the Architect. DRAWN: BTC DATE: 10-26-26 REVISED:

0 2. ALL WINDOW TRIM, DOORS & TRIM **(1)** 0 INSULATED GLASS ALL NEW WDOS.

Q

• |

SIDENCE **M** 5 0

DOOR & WINDOW SCHEDULES DOOR & WINDOW DETAILS **SPECIFICATIONS**





SHEET NUMBER







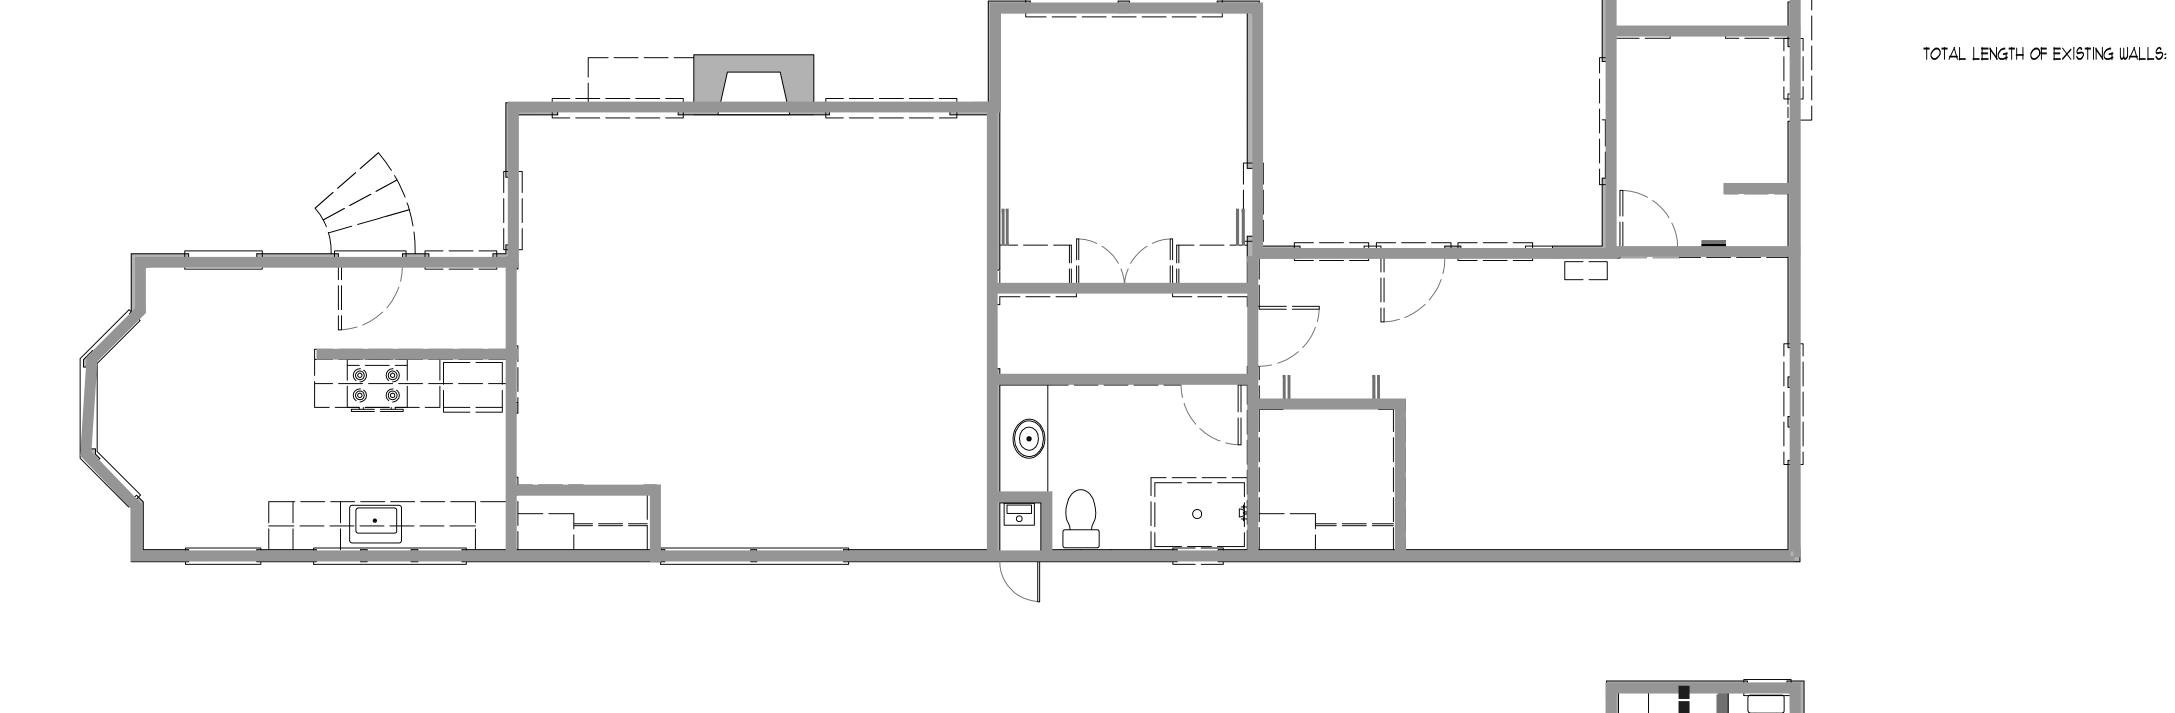

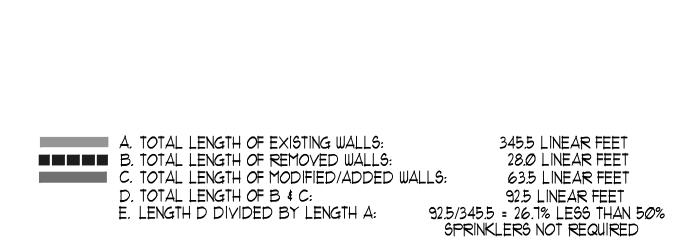

345.5 LINEAR FEET

