CARMEL BALCONY REPAIR

CARMEL-BY-THE-SEA, CALIFORNIA


GENERAL NOTES

- ALL CONSTRUCTION SHALL COMPLY WITH THE FOLLOWING CODES:
 - 2016 TITLE 24, PART 2, CALIFORNIA BUILDING CODE
- 2016 TITLE 24, PART 3, CALIFORNIA ELECTRICAL CODE 2016 TITLE 24, PART 4, CALIFORNIA MECHANICAL CODE 2016 TITLE 24, PART 5, CALIFORNIA PLUMBING CODE
- 2016 TITLE 24, PART 6, CALIFORNIA ENERGY CODE
- 2016 TITLE 24, PART 8, CALIFORNIA HISTORICAL BUILDING CODE 2016 TITLE 24, PART 9, CALIFORNIA FIRE CODE 2016 TITLE 24, PART 11, CALIFORNIA GREEN BUILDING STANDARDS CODE
- THE CONTRACTOR SHALL FURNISH AND INSTALL ALL ITEMS UNLESS OTHERWISE NOTED
- GENERAL DIMENSIONING GUIDELINES


CARMEL MUNICIPAL CODE

- A. ALL DIMENSIONS LOCATING EXTERIOR WALLS TO FACE OF STUD, FACE OF SHEATHING, OR FACE OF CONCRETE UNLESS OTHERWISE NOTED.
- B. DIMENSIONS LOCATING INTERIOR WALLS ARE TO FACE OF STUDS OR CENTERLINE OF STUDS WHERE INDICATED
- THE CONTRACTOR SHALL VERIFY ALL DIMENSIONS AND JOB CONDITIONS. ALL DISCREPANCIES SHALL BE BROUGHT TO THE ATTENTION OF THE ARCHITECT. THE CONTRACTOR SHALL BE SOLELY RESPONSIBLE FOR VISITING THE JOB SITE AND OBTAINING ALL CORRECT INFORMATION FOR THE COMPLETION OF THE CONTRACT.
- IN THE EVENT THAT CERTAIN DETAILS OF THE CONSTRUCTION ARE NOT FULLY SHOWN OR NOTED ON THE DRAWINGS OR CALLED FOR IN THE SPECIFICATIONS, THEIR CONSTRUCTION SHALL BE OF THE SAME SIZE AND CHARACTER AS FOR SIMILAR CONDITIONS WHICH ARE SHOWN OR NOTED.
- THE CONTRACTOR AGREES TO ASSUME SOLE AND COMPLETE RESPONSIBILITY FOR JOB SITE CONDITIONS DURING THE COURSE OF CONSTRUCTION OF THIS PROJECT, INCLUDING SAFETY OF ALL PERSONS AND PROPERTY. THIS REQUIREMENT SHALL APPLY CONTINUOUSLY AND SHALL NOT BE LIMITED TO NORMAL WORKING HOURS. THE CONTRACTOR FURTHER AGREES TO DEFEND, INDEMNIFY AND HOLD DESIGN PROFESSIONAL HARMFUL FROM ALL LIABILITY, REAL OR ALLEGED, IN CONNECTION WITH THE PERFORMANCE OF WORK ON THIS PROJECT, EXCEPTING LIABILITY ARISING FROM THE SOLE NEGLIGENCE OF THE DESIGN PROFESSIONAL.
- THE ARCHITECT PREPARING THESE PLANS WILL NOT BE RESPONSIBLE FOR, OR LIABLE FOR, UNAUTHORIZED CHANGES TO OR USES OF THESE PLANS. ALL CHANGES TO THE PLANS MUST BE IN WRITING AND MUST BE APPROVED BY THE PREPARER OF THESE PLANS.
- ONLY WORKING DRAWINGS STAMPED "ISSUED FOR CONSTRUCTION" ARE PERMITTED TO BE USED FOR CONSTRUCTION OF THIS PROJECT. ALL OTHER DRAWINGS ARE OBSOLETE AND ARE NOT PERMITTED ON THE JOB SITE. CONTRACTORS USING INCORRECT DRAWINGS ARE SOLELY RESPONSIBLE FOR ALL WORK NOT PERFORMED IN ACCORDANCE WITH THE DRAWINGS ISSUED FOR
- THE USE OF SOLDERS CONTAINING MORE THAN TWO-TENTHS OF ONE PERCENT OF LEAD IN MAKING JOINTS IN WATER SUPPLY SYSTEM IS PROHIBITED.

PARCEL MAP

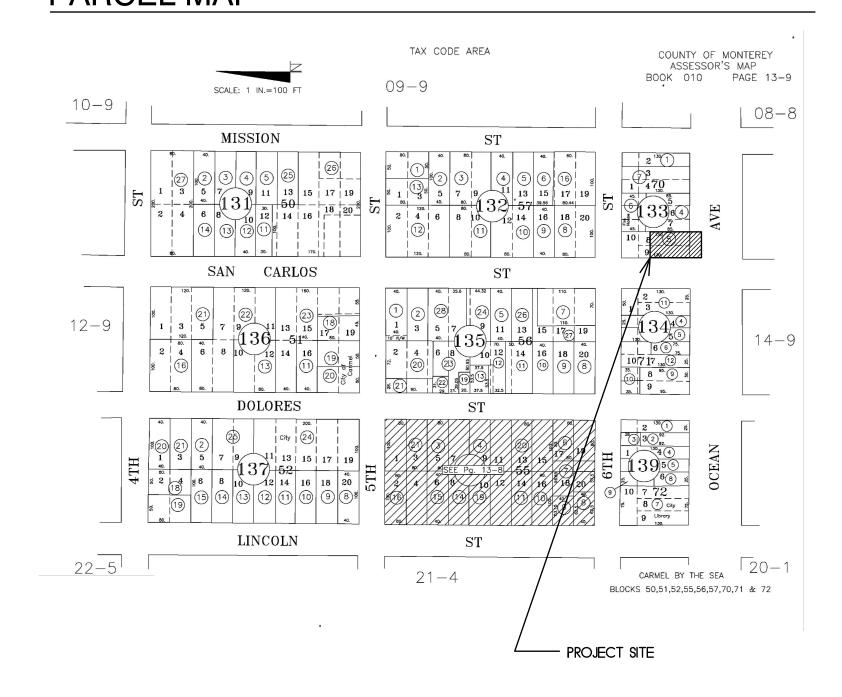

VICINITY MAP

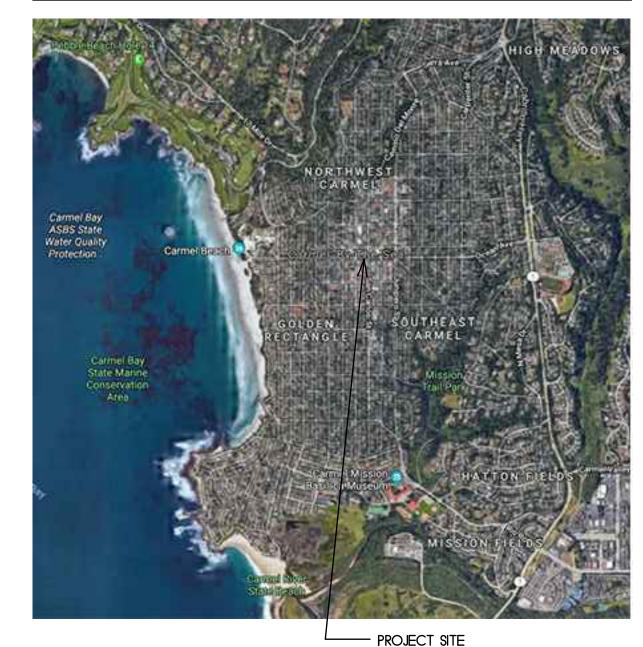

PROJECT DIRECTORY

<u>OWNER</u>

STRUCTURAL ENGINEER

GOULD FAMILY TRUST OCEAN AVE., NE OF SAN CARLOS ST. CARMEL-BY-THE-SEA, CALIFORNIA 93921

ART WERNER PACIFIC ENGINEERING GROUP, INC. 30 RYAN COURT, SUITE 200 MONTEREY, CALIFORNIA 93940 (831) 333-0644

<u>ARCHITECT</u>

(831) 373-5855

DANIEL FLETCHER DANIEL FLETCHER + ASSOCIATES ARCHITECTS 769 PACIFIC STREET MONTEREY, CALIFORNIA 93940

- A2.1 EXISTING/DEMOLITION & PROPOSED FLOOR PLANS
- A3.1 EXTERIOR ELEVATIONS
- A9.1 DETAILS

SHEET INDEX

- AO.1 TITLE SHEET
- EXISTING FLOOR PLANS

- SI.O STRUCTURAL PLANS, NOTES AND DETAILS

ABBREVIATIONS

&	AND
L	ANGLE
0	AT
©	CENTERLINE
P	PLATE
Ē Φ	DIAMETER OR ROUND
Ţ	PERPENDICULAR
TT .	PARALLEL
' <u>4</u>	POUND OR NUMBER
" (E)	EXISTING
(-/	
A.B.	ANCHOR BOLT
A.B.S.	ACRYLONITRILE BUTADIENE
	STYRENE
A.C.	ASPHALTIC CONCRETE
A/C	AIR CONDITIONING
ÁCOUS.	ACOUSTICAL
ADJ.	AIR CONDITIONING ACOUSTICAL ADJUSTABLE, ADJACENT
AGGR.	ADJUSTABLE, ADJACENT AGGREGATE
ALUM.	ALUMINUM
ANOD. A.P.A.	ANODIZED AMERICAN PLYWOOD
	ASSOCIATION
APPROX.	APPROXIMATE
ARCH.	ARCHITECT (URAL)
	` ,
BD.	BOARD
BIT.	BOARD BITUMINOUS
BIT.	BITUMINOUS
BIT. BLDG. BLK.	BITUMINOUS BUILDING BLOCK
BIT. BLDG. BLK.	BITUMINOUS BUILDING BLOCK
BIT. BLDG. BLK.	BITUMINOUS BUILDING
BIT. BLDG. BLK. BLKG. B.M. BM.	BITUMINOUS BUILDING BLOCK
BIT. BLDG. BLK. BLKG. B.M. BM. B.O.	BITUMINOUS BUILDING BLOCK BLOCKING BENCH MARK BEAM BOTTOM OF
BIT. BLDG. BLK. BLKG. B.M. BM. B.O.	BITUMINOUS BUILDING BLOCK BLOCKING BENCH MARK BEAM
BIT. BLDG. BLK. BLKG. B.M. BM. BO. BOT. BRG.	BITUMINOUS BUILDING BLOCK BLOCKING BENCH MARK BEAM BOTTOM OF BOTTOM BEARING
BIT. BLDG. BLK. BLKG. B.M. BM. BO. BOT. BRG.	BITUMINOUS BUILDING BLOCK BLOCKING BENCH MARK BEAM BOTTOM OF BOTTOM
BIT. BLDG. BLK. BLKG. B.M. BM. BO. BOT. BRG.	BITUMINOUS BUILDING BLOCK BLOCKING BENCH MARK BEAM BOTTOM OF BOTTOM BEARING
BIT. BLDG. BLK. BLKG. B.M. BM. BOT. BOT. BRG. BTWN. B.W.	BITUMINOUS BUILDING BLOCK BLOCKING BENCH MARK BEAM BOTTOM OF BOTTOM BEARING BETWEEN BOTH WAYS
BIT. BLDG. BLK. BLKG. B.M. BM. BOT. BOT. BRG. BTWN. B.W.	BITUMINOUS BUILDING BLOCK BLOCKING BENCH MARK BEAM BOTTOM OF BOTTOM BEARING BETWEEN BOTH WAYS CABINET
BIT. BLDG. BLK. BLKG. B.M. BM. B.O. BOT. BRG. BTWN. B.W. CAB. C.B.	BITUMINOUS BUILDING BLOCK BLOCKING BENCH MARK BEAM BOTTOM OF BOTTOM BEARING BEARING BETWEEN BOTH WAYS CABINET CATCH BASIN
BIT. BLDG. BLK. BLKG. B.M. BM. B.O. BOT. BRG. BTWN. B.W. CAB. CEM.	BITUMINOUS BUILDING BLOCK BLOCKING BENCH MARK BEAM BOTTOM OF BOTTOM BEARING BETWEEN BOTH WAYS CABINET CATCH BASIN CEMENT
BIT. BLDG. BLK. BLKG. B.M. BM. B.O. BOT. BRG. BTWN. B.W. CAB. C.B. CEM. CER.	BITUMINOUS BUILDING BLOCK BLOCKING BENCH MARK BEAM BOTTOM OF BOTTOM BEARING BETWEEN BOTH WAYS CABINET CATCH BASIN CEMENT CERAMIC
BIT. BLDG. BLK. BLKG. B.M. BM. B.O. BOT. BRG. BTWN. B.W. CAB. C.B. CEM. CER. C.F.	BITUMINOUS BUILDING BLOCK BLOCKING BENCH MARK BEAM BOTTOM OF BOTTOM BEARING BETWEEN BOTH WAYS CABINET CATCH BASIN CEMENT CERAMIC CUBIC FOOT
BIT. BLDG. BLK. BLKG. B.M. BM. B.O. BOT. BRG. BTWN. B.W. CAB. CEM. CEF. C.F.	BITUMINOUS BUILDING BLOCK BLOCKING BENCH MARK BEAM BOTTOM OF BOTTOM BEARING BETWEEN BOTH WAYS CABINET CATCH BASIN CEMENT CERAMIC CUBIC FOOT CAST IRON
BIT. BLDG. BLK. BLKG. B.M. BM. B.O. BOT. BRG. BTWN. B.W. CAB. CEM. CER. CIF. CII. CLKG.	BITUMINOUS BUILDING BLOCK BLOCKING BENCH MARK BEAM BOTTOM OF BOTTOM BEARING BETWEEN BOTH WAYS CABINET CATCH BASIN CEMENT CERAMIC CUBIC FOOT CAST IRON CAULKING
BIT. BLDG. BLK. BLKG. B.M. BM. B.O. BOT. BRG. BTWN. B.W. CAB. CEM. CER. C.F. C.I. CLKG. CLG.	BITUMINOUS BUILDING BLOCK BLOCKING BENCH MARK BEAM BOTTOM OF BOTTOM BEARING BETWEEN BOTH WAYS CABINET CATCH BASIN CEMENT CERAMIC CUBIC FOOT CAST IRON CAULKING CEILING
BIT. BLDG. BLK. BLKG. B.M. BM. B.O. BOT. BRG. BTWN. B.W. CAB. CEM. CER. C.F. C.I. CLKG. CLG. CL.	BITUMINOUS BUILDING BLOCK BLOCKING BENCH MARK BEAM BOTTOM OF BOTTOM BEARING BETWEEN BOTH WAYS CABINET CATCH BASIN CEMENT CERAMIC CUBIC FOOT CAST IRON CAULKING CELLING CLOSET
BIT. BLDG. BLK. BLKG. B.M. BM. B.O. BOT. BRG. BTWN. B.W. CAB. CCB. CER. C.F. C.I. CLKG. CLG. CLR.	BITUMINOUS BUILDING BLOCK BLOCKING BENCH MARK BEAM BOTTOM OF BOTTOM BEARING BETWEEN BOTH WAYS CABINET CATCH BASIN CEMENT CERAMIC CUBIC FOOT CAST IRON CAULKING CEILING CLOSET CLEAR (ANCE)
BIT. BLDG. BLK. BLKG. B.M. BM. BOT. BRG. BTWN. B.W. CAB. CCEM. CER. C.F. C.I. CLKG. CLL. CLR. COL.	BITUMINOUS BUILDING BLOCK BLOCKING BENCH MARK BEAM BOTTOM OF BOTTOM BEARING BETWEEN BOTH WAYS CABINET CATCH BASIN CEMENT CERAMIC CUBIC FOOT CAST IRON CAULKING CEILING
BIT. BLDG. BLK. BLKG. B.M. BM. B.O. BOT. BRG. BTWN. B.W. CAB. CEM. CER. CIF. CIKG. CLC. CLC. CUKG. COMP.	BITUMINOUS BUILDING BLOCK BLOCKING BENCH MARK BEAM BOTTOM OF BOTTOM BEARING BETWEEN BOTH WAYS CABINET CATCH BASIN CEMENT CERAMIC CUBIC FOOT CAST IRON CAULKING CLILING CLOSET CLEAR (ANCE) COLUMN COMPOSITION
BIT. BLDG. BLK. BLKG. B.M. BM. BOT. BRG. BTWN. B.W. CAB. CCEM. CER. C.F. C.I. CLKG. CLL. CLR. COL.	BITUMINOUS BUILDING BLOCK BLOCKING BENCH MARK BEAM BOTTOM OF BOTTOM BEARING BETWEEN BOTH WAYS CABINET CATCH BASIN CEMENT CERAMIC CUBIC FOOT CAST IRON CAULKING CLILING CLOSET CLEAR (ANCE) COLUMN COMPOSITION

CONNECT (ION

CONTINUOUS

CORRUGATED

CERAMIC TILE

COUNTERSUNK

CUBIC YARD

CASEMENT

CASEWORK

CONT.

CORR.

CSMT. CSWK. C.T.

CTSK. C.Y.

CONSTRUCT (ION

DBL. DEPT. DEPARTMENT DETAIL DOUGLAS FIR DOUBLE HUNG DIAMETER DIMENSION DISPENSER DOWN DRAWING DOWNSPOUT DRAWER EACH ELEVATION, ELEVATOR **EMERGENCY ENCLOSURE** EQUIPMENT EXHAUST EXPOSED, EXPANSION FIRE ALARM FASTEN, FASTENER FLOOR DRAIN FOUNDATION FIRE EXTINGUISHER

DIMEN. ELEV. ELEC. EMER. ENCL. EQUIP. EXIST. (E) EXISTING FDN. F.E. FIBERGL. FIBERGLASS FINISH (ED) F.H.M.S. FLAT HEAD MACHINE SCREW F.H.W.S. FLAT HEAD WOOD SCREW FLOOR (ING) FLUOR. FLUORESCENT FACE OF FACE OF CONCRETE FACE OF FINISH FACE OF MASONRY F.O.S. FACE OF STUDS FIREPLACE F.S. FULL SIZE FOOT OR FEET GAUGE GALV. GALVANIZED GRAB BAR GALVANIZED IRON GLASS, GLAZING

GYPSUM WALLBOARD

HBD. H.C. H.D.G. HARDBOARD HOLLOW CORE HOT DIPPED GALVANIZED HDR. HDWD. HEADER HARDWOOD HDWR. HARDWARE H.M. HOLLOW METAL HORIZ. HORIZONTAL HGT. HEIGHT HEATING H.W. HOT WATER HEATING, VENTILATING, AND AIR CONDITIONING HVAC I.C.B.O. INTERNATIONAL CONFERENCE OF BUILDING OFFICIALS INSIDE DIAMETER INCLUDED, INCLUDING INSUL. INSULATION INTERIOR INVERT

KITCHEN

LAG BOLT

MAXIMUM

MAN HOLE

MECHANICAL

MEMBRANE

MEZZANINE

MINIMUM MIRROR

MOULDING

MOUNTED

MULLION

METAL

NEW

NATURAL

NOMINAL

NOT TO SCALE

MAX. M.B.

M.H.

MECH. MEMB.

MEZZ.

MFR.

MLDG.

M.I.W.

M.O.

MTL.

N.I.C.

MULL.

O.F.C.I. OWNER FURNISHED CONTRACTOR INSTALLED 0.F.0.I O.H.M.S. OVALHEAD MACHINE SCREW O.H.W.S. OVALHEAD WOOD SCREW 0.S.B. PART.BD. PARTICLE BOARD PERF. P.L.F. P.S.I. P.T.D. RAD. REINF.

OBS. O.C. O.D.

OBSCURE

OFFICE

OPPOSITE

PAINT GRADE

PERFORATED

ON CENTER

OUTSIDE DIAMETER

OWNER FURNISHED OWNER INSTALLED

ORIENTED STRAND BOARD

POWDER ACTUATED FASTENER

POUNDS PER LINEAL FOOT PROPERTY LINE. PL. LAM. PLASTIC LAMINATE PLASTER PLYWOOD PAIR JOIST HANGER JOINT POUNDS PER SQUARE FOOT POUNDS PER SQUARE INCH PRESSURE TREADED PARTITION PAPER TOWEL DISPENSER LONG, LENGTH P.V.C. POLYVINYL CHLORIDE LAMINATE, LAMINATED LAVATORY RISER (S) RETURN AIR LOCATE, LOCATION RADIUS LIGHT WEIGHT ROOF DRAIN REGISTER REFRIGERATOR MATERIAL (S) REINFORCED, REINFORCING REQ'D. REQUIRED MACHINE BOLT REQMT. REQUIREMENT MEDICINE CABINET RESIL. RESILIENT R.H.M.S. ROUND HEAD METAL SCREW R.H.W.S. ROUND HEAD WOOD SCREW ROOM ROUGH OPENING MANUFACTURE (ER) R.O.W. RIGHT OF WAY RUBBER MISCELLANEOUS R.W.L. RAIN WATER LEADER MALLEABLE IRON WASHER MASONRY OPENING SOUTH SOLID BLOCKING SOLID CORE SCHED. SCHEDULE S.D. STORM DRAIN SECT. SECTION SERV. SERVICE SQUARE FEET (FOOT) NOT IN CONTRACT S.G. STAIN GRADE

SH. SHWR. SHT.

SHTG.

SHELF, SHELVING

SHOWER

SHEATHING


SIM. S.S. S.M. S.M.S. STAINLESS STEEL SHEET METAL SHEET METAL SCREW SPECS. SPECIFICATIONS STEEL STANDARD STD. STAG. STOR. STAGGERED STORAGE STRUCTURAL SUSPENDED SYMETRICAL SYSTEM

TO BE DETERMINED TOP OF CURB TELEPHONE TEMPERED T.E.N. TYPICAL EDGE NAILING T & G TONGUE AND GROOVE TOP OF GRATE THICK (NESS) THRESHOLD TOP OF PAVEMENT TOILET PAPER HOLDER TELEVISION UNIFORM BUILDING CODE UNDERWRITER'S LABORATORIES UNLESS OTHERWISE NOTED

VAPOR BARRIER VARIES VERTICAL VERTICAL GRAIN VINYL TILE WIDE, WIDTH WATER CLOSET WOOD WDW. WINDOW WATER HEATER WOODWORK INSTITUTE OF CALIFORNIA W/0 WATERPROOF W.R. WATER RESISTANT WOOD SCREW WSCT. WAINSCOT

W.W.M. WELDED WIRE MESH

SYMBOLS

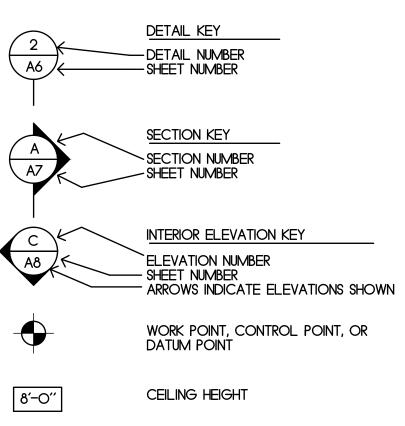

REVISION 3 DOOR SYMBOL (SEE DOOR SCHEDULE)

 $\langle A \rangle$ WINDOW SYMBOI (SEE WINDOW SCHEDULE)

PROJECT DATA:

PROJECT DESCRIPTION:

REPAIR AND/OR REPLACE EXISTING 168 S.F. SECOND FLOOR BALCONY DUE TO DRY ROT. ALL COLORS AND MATERIALS TO MATCH EXISTING.

A.P.N.: BASE ZONING DISTRICT: TYPE OF CONSTRUCTION:

OCCUPANCY TYPE:

MIXED (SEE CODE COMPLIANCE) NO CHANGE

010-133-005-000

V-B FIRE SPRINKLERED

CENTRAL COMMERCIAL (CC)

FLOOR AREAS (EXISTING)

HEIGHT:

1,228 S.F. BASEMENT: 5,622 S.F. FIRST FLOOR: 4,850 S.F. SECOND FLOOR: 11,700 S.F.

CODE COMPLIANCE DATA:

TYPE OF CONSTRUCTION: TYPE V-B. WITH FIRE SPRINKLER SYSTEM

				OCCUPANT	
FLOOR LEVEL:	LEASE SPACE	<u>USE</u>	FLOOR AREA	LOAD FACTOR	OCCUPANTS
BASEMENT:	FRAME SHOP	STORAGE	1,228 S.F.	300 GROSS	5
FIRST FLOOR:	DM FINE ART	RETAIL	1,003 S.F.	60 GROSS	17
	RETAIL SPACE	RETAIL	1,181 S.F.	60 GROSS	20
	COACH	RETAIL	3,438 S.F.	60 GROSS	58
SECOND FLOOR:	APARTMENTS	RESIDENTIAL	2,014 S.F.	200 GROSS	II
	OFFICE	OFFICE	2,836 S.F.	100 GROSS	<u>29</u>
TOTAL:			11,700 S.F.		139

EXITS:

LEASE		OCCUPANT	MAX. ALLOWABLE OCC.	NO. OF EXITS	NO. OF EXITS
<u>SPACE</u>	<u>OCCUPANCY</u>	LOAD	LOAD FOR 1 EXIT	REQUIRED	PROVIDED_
FRAME SHOP	S	15	29	1	1
DM FINE ART	М	17	49	1	1
RETAIL SPACE	М	20	49	1	1
COACH	М	58	49	2	2
APARTMENTS	R-3	11	Ю	2	2
OFFICE	В	29	49	1	2

TYPE OF CONSTRUC	HON:	TYPE V-B,	WITH FIRE SPRINKL	EK SYSTEM	
OCCUPANCY CLASSI STORAGE: RETAIL: RESIDENTIAL (APA RETAIL:		S-1 M R-3 B			
OCCUPANCY SEPARA S-1/M M/R-3 M/B B/R-3	ATIONS REQUIRED (P	PER CBC TABLI N 1 HR. N 1 HR.	E 508.4);		
ALLOWABLE FLOOF OCCUPANCY S-1 M R-3 B * MAXIMUM ALLO	R AREA FACTOR (PI	ALLOWAR 9000 9000 U.L. 9000	S.F.* S.F.*	<u>.</u>	
OCCUPANT LOAD:				OCCUDANT	
FLOOR LEVEL: BASEMENT: FIRST FLOOR:	LEASE SPACE FRAME SHOP DM FINE ART	<u>USE</u> STORAGE RETAIL	FLOOR AREA 1,228 S.F. 1,003 S.F.	OCCUPANT LOAD FACTOR 300 GROSS 60 GROSS	<u>OCCUPAN'</u> 5 17

REVISIONS:

DRAWN BY:

PRINT DATE:

DRAWING DATE:

DATE ISSUED FOR

CONSTRUCTION:

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SHEET NUMBER

Daniel Fletcher + Associates Architects

> 769 Pacific Street Monterey, CA 93940 831.373.5855

> > C-14778

CARMEL BALCONY

REPAIR

OCEAN AVE.

PROJECT NUMBER

OCEAN AVE,

SHEET TITLE

1915

OWNER

NE OF SAN CARLOS ST. CARMEL-BY-THE-SEA

GOULD FAMILY TRUST

NONE

12-23-19


NE OF SAN CARLOS ST CARMEL-BY-THE-SEA


CALIFORNIA 93921

TITLE SHEET

CALIFORNIA, 93921


CONSULTANT

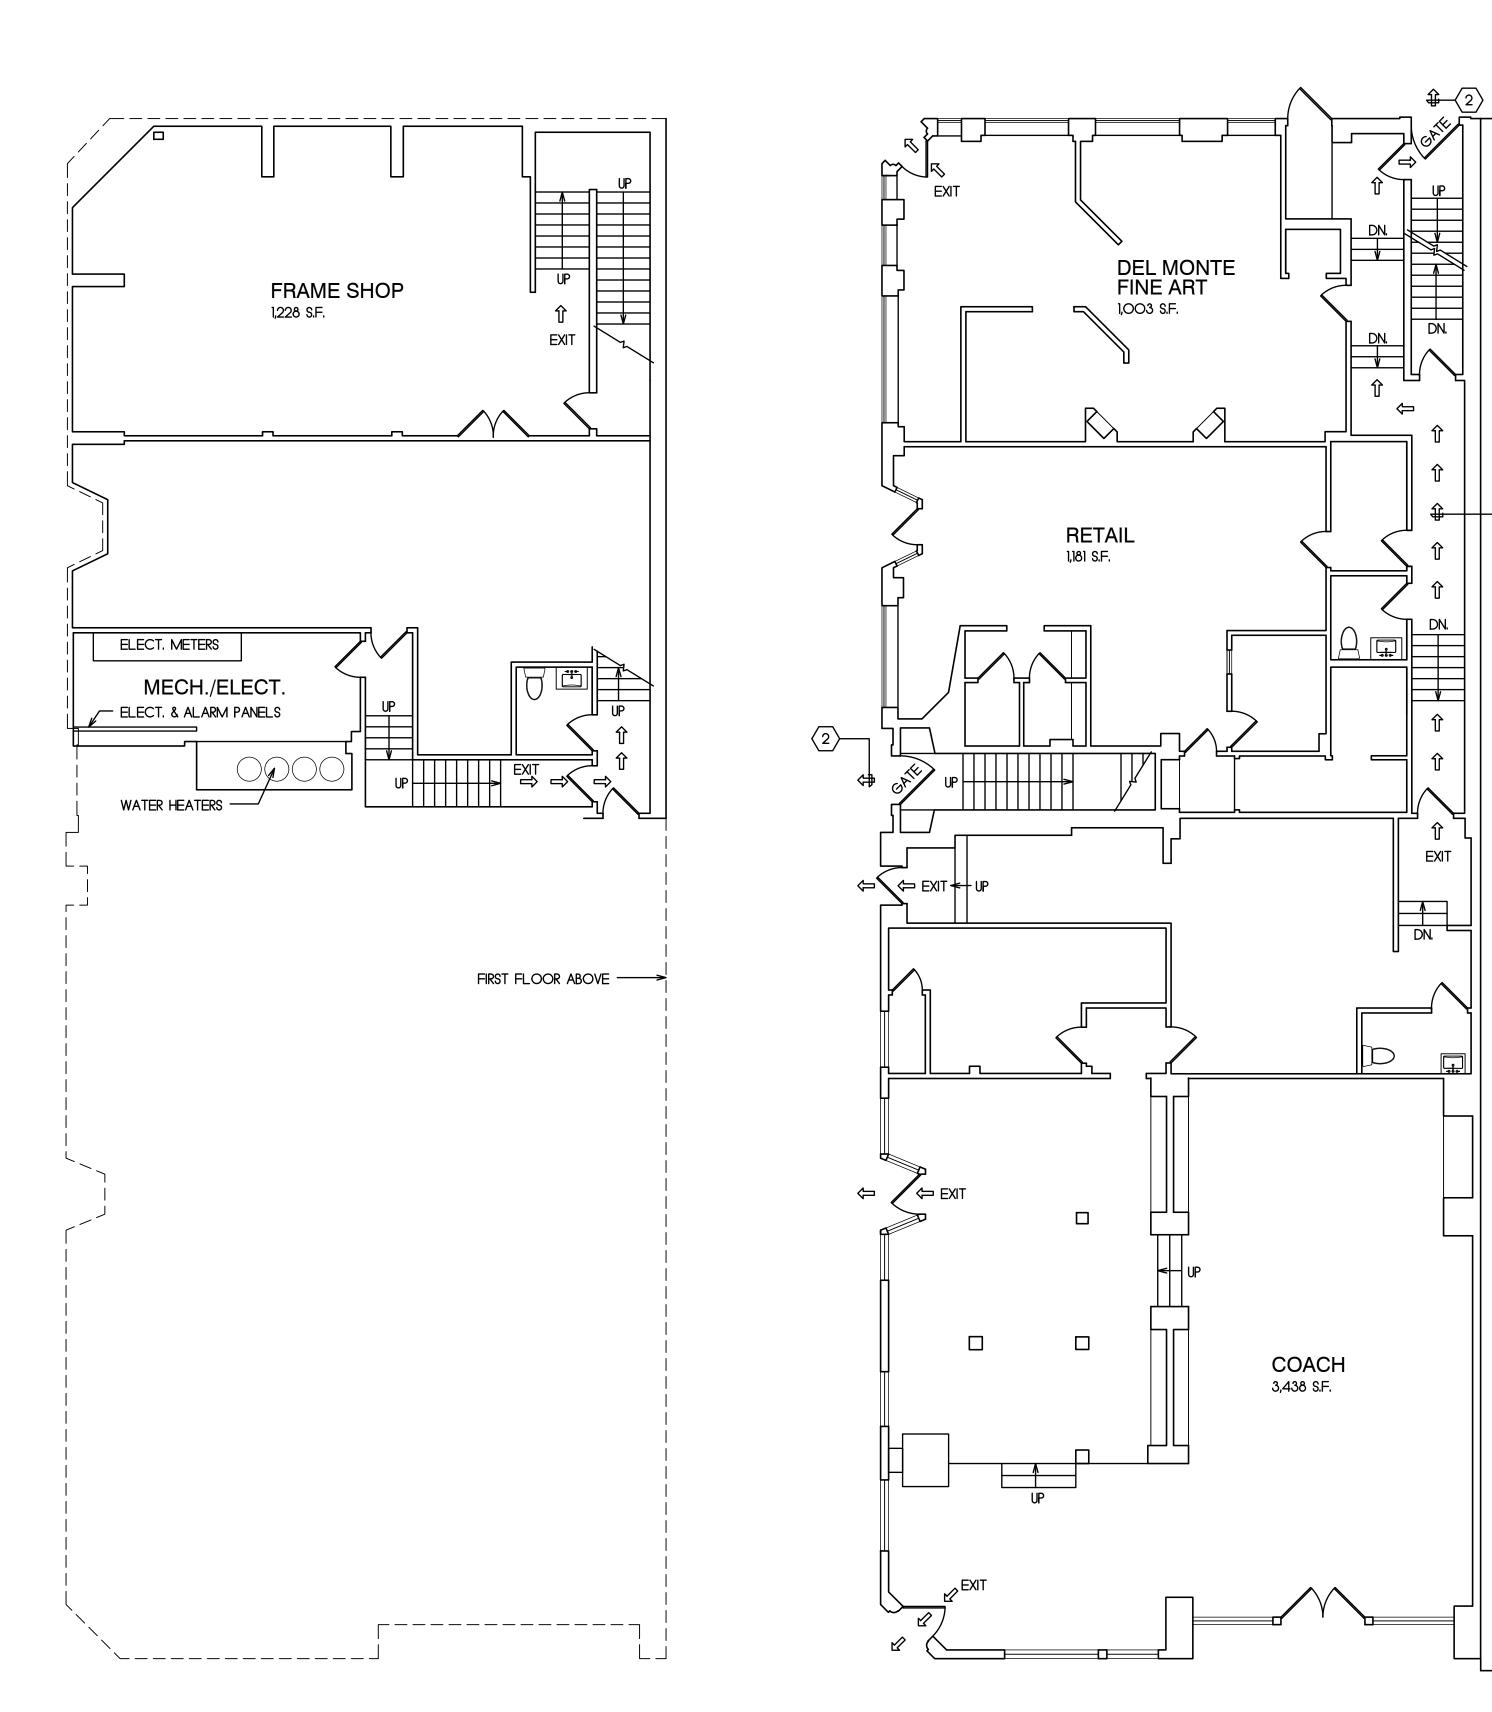

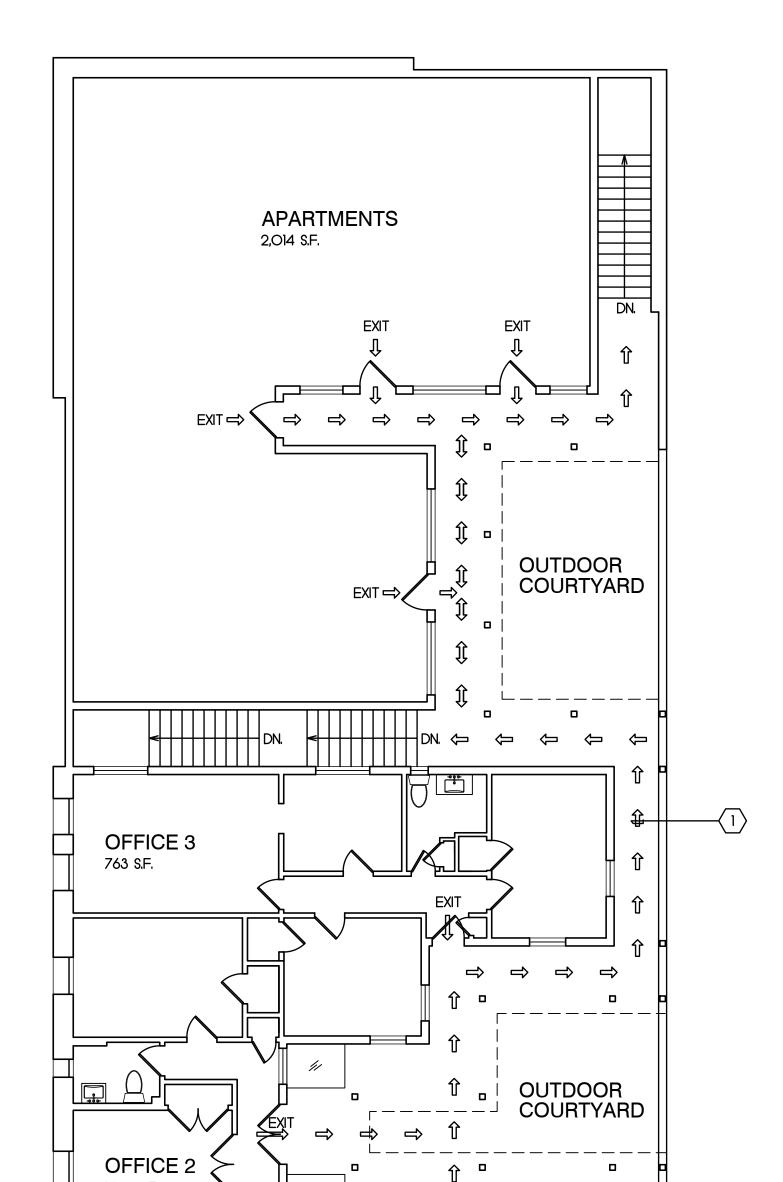

○ SHEET NOTES

- 1. EXISTING PATH OF EGRESS TYPICAL.
- 2. EXISTING EXIT AT SIDEWALK LEVEL (PUBLIC WAY) TYPICAL.

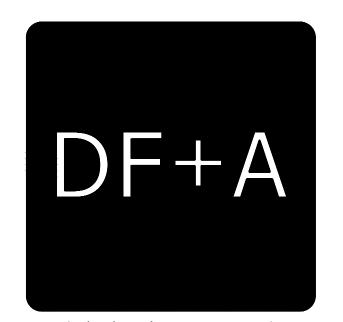

Daniel Fletcher + Associates
Architects

769 Pacific Street Monterey, CA 93940 831.373.5855



CONSULTANT

PROJECT

CARMEL BALCONY REPAIR

OCEAN AVE. NE OF SAN CARLOS ST. CARMEL-BY-THE-SEA CALIFORNIA, 93921

PROJECT NUMBER

1915

GOULD FAMILY TRUST

OCEAN AVE, NE OF SAN CARLOS ST. CARMEL-BY-THE-SEA CALIFORNIA 93921

SHEET TITL

EXISTING FLOOR PLANS

SCALE: 1/8" = 1'-0"

DRAWN BY: JRC

PRINT DATE: .

DRAWING DATE: 12-23-19

DATE ISSUED FOR
CONSTRUCTION:

DATE ISSUED FOR CONSTRUCTION: REVISIONS:

BASEMENT FLOOR PLAN

FIRST FLOOR PLAN


SECOND FLOOR PLAN


- SEE SHEET A2.1

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SHEET NUMBER





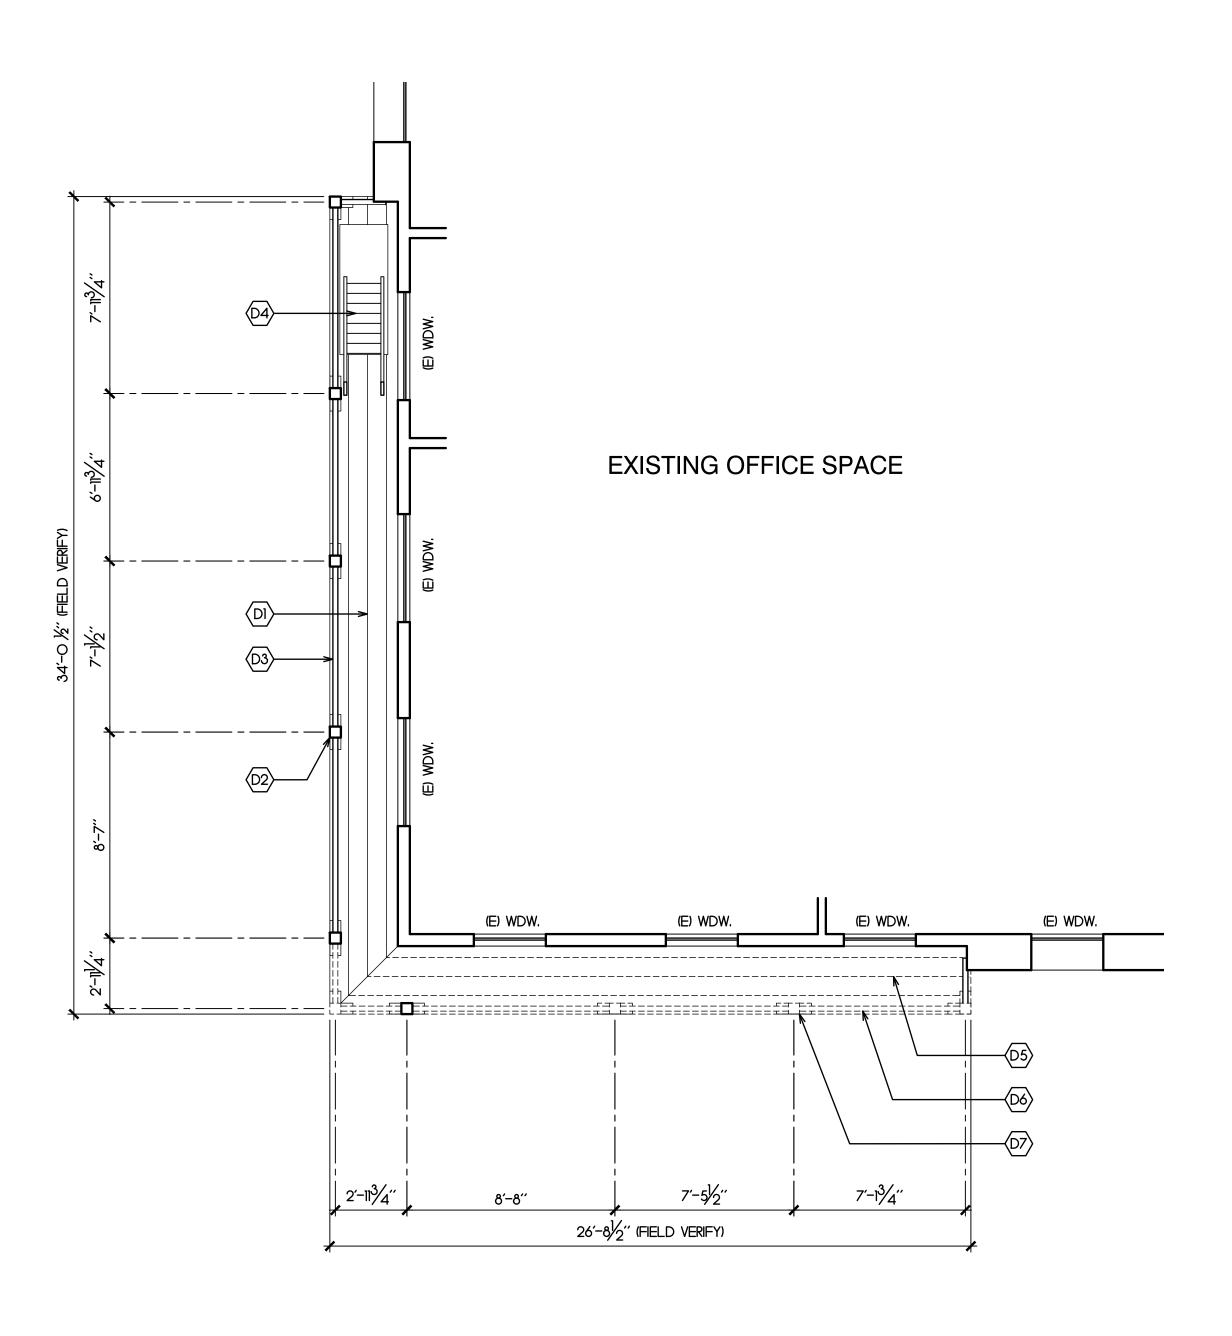

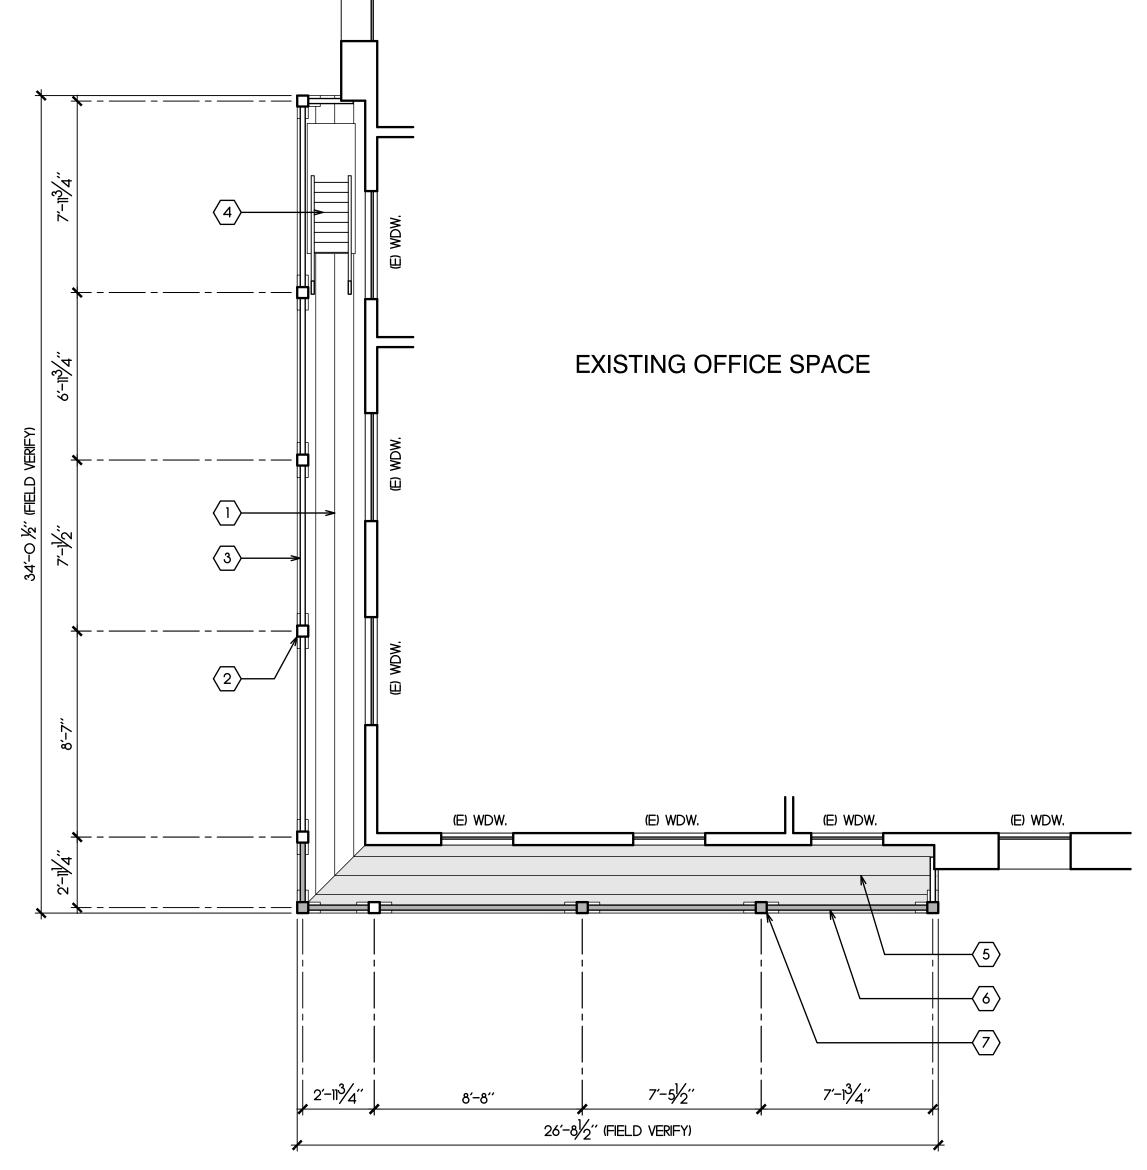○ DEMOLITIONS PLAN SHEET NOTES

- DI. EXISTING WOOD DECKING TO REMAIN.
- D2. EXISTING 6×6 POSTS, POST CAPS, AND POST BASES TO REMAIN EXCEPT WHERE NOTED OTHERWISE.
- D3. EXISTING GUARDRAILS AND BALUSTERS TO REMAIN EXCEPT WHERE NOTED OTHERWISE.
- D4. EXISTING PULL-DOWN STAIR TO REMAIN.
- D5. REMOVE EXISTING WOOD DECK BOARDS ON THIS SIDE OF BALCONY.
- D6. REMOVE GUARDRAILS AND BALUSTERS WHERE INDICATED (5 SECTIONS).
- D7. REMOVE EXISTING POSTS, POST CAPS, AND POST BASES WHERE INDICATED (TYPICAL FOR 4).


PROPOSED BALCONY PLAN

○ PROPOSED PLAN SHEET NOTES

- 1. EXISTING WOOD DECKING TO REMAIN.
- 2. EXISTING 6×6 POSTS, POST CAPS, AND POST BASES TO REMAIN (TYPICAL FOR 6).
- 3. EXISTING GUARDRAILS AND BALUSTERS TO REMAIN EXCEPT WHERE NOTED OTHERWISE.
- 4. EXISTING PULL-DOWN STAIR TO REMAIN.
- 5. NEW DECK BOARDS TO REPLACE EXISTING. MATCH EXISTING MATERIAL
- 6. NEW GUARDRAIL AND BALUSTERS TO MATCH EXISTING (5 SECTIONS).
- 7. NEW 6 \times 6 POSTS, POST CAPS, AND POST BASES TO MATCH EXISTING (TYPICAL FOR 4).

GENERAL DEMOLITION NOTES

- 1. DEMOLITION NOTES SHOW GENERAL DEMOLITION REQUIREMENTS AND ARE NOT INTENDED TO BE A COMPLETE AND EXHAUSTIVE INDICATION OF ALL ITEMS TO BE REMOVED OR DEMOLISHED. THE CONTRACTOR SHALL BE RESPONSIBLE FOR THE REMOVAL OF ALL EXISTING MATERIALS REQUIRED TO PROVIDE FOR NEW CONSTRUCTION AS SHOWN OR AS INTENDED.
- 2. THE CONTRACTOR SHALL PROVIDE DEMOLITION WORK AS REQUIRED TO PREPARE THE EXISTING BUILDING FOR THE NEW CONSTRUCTION AS SHOWN ON THESE DRAWINGS.
- 3. THE CONTRACTOR SHALL BE RESPONSIBLE FOR THE REMOVAL AND LEGAL DISPOSAL OF ALL DEMOLISHED MATERIALS.
- 4. THE CONTRACTOR SHALL COORDINATE WITH THE OWNER ON ANY MATERIALS, EQUIPMENT, ETC. TO BE SALVAGED AND KEPT BY THE OWNER.
- 5. VERIFY CONDITION OF EXISTING FRAMING, SHEATHING, AND OTHER MATERIALS UNCOVERED DURING DEMOLITION WORK. NOTIFY THE ARCHITECT OF ANY DAMAGED, DECAYED, OR SUBSTANDARD MATERIALS WHICH REQUIRE REPLACEMENT WHICH ARE NOT INDICATED ON THE DRAWINGS.
- 6. THE CONTRACTOR SHALL NOTIFY THE ARCHITECT OF ANY EXISTING CONDITIONS WHICH AREA AT VARIANCE WITH THESE PLANS OR WHICH WILL AFFECT THE DESIGN INTENT OF NEW CONSTRUCTION AS SHOWN IN THE DRAWINGS OR SPECIFICATIONS.
- 7. REFER TO STRUCTURAL DRAWINGS FOR ADDITIONAL DEMOLITION REQUIREMENTS.
- CONTRACTOR SHALL PROVIDE SHORING OF EXISTING STRUCTURE AS NECESSARY. CONTRACTOR IS SOLEY RESPONSIBLE FOR THE DESIGN OF SHORING AND ALL SAFETY REQUIREMENTS AND PROCEDURES.
- CONTRACTOR SHALL PROVIDE PROTECTION OF PEDESTRIANS IN THE AREA OF DEMOLITION AND CONSTRUCTION IN ACCORDANCE WITH CBC SECTION 3306 AND AS APPROVED BY BUILDING OFFICIAL. THE DESIGN, CONSTRUCTION, MAINTENANCE, AND REMOVAL OF PEDESTRIAN PROTECTION ARE THE SOLE RESPONSIBILITY OF THE CONTRACTOR.

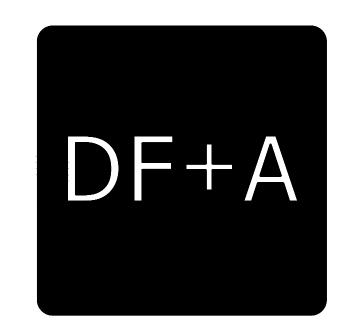

Daniel Fletcher + Associates Architects

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CONSULTANT

PROJE

CARMEL BALCONY REPAIR

OCEAN AVE. NE OF SAN CARLOS ST. CARMEL-BY-THE-SEA CALIFORNIA, 93921

PROJECT NUMBER

1915

OWNER

GOULD FAMILY TRUST

OCEAN AVE, NE OF SAN CARLOS ST. CARMEL-BY-THE-SEA CALIFORNIA 93921

SHEET TITLE

EXISTING / DEMOLITION & PROPOSED BALCONY PLANS

SCALE: 1/4" = 1'-0"

DRAWN BY: JRC

PRINT DATE: .

DRAWING DATE: 12-23-19

DATE ISSUED FOR

CONSTRUCTION: REVISIONS:

LEGEND

ITEMS TO BE REMOVED (DASHED)

EXISTING ITEMS TO REMAIN


NEW ITEMS TO REPLACE EXISTING AS NOTED

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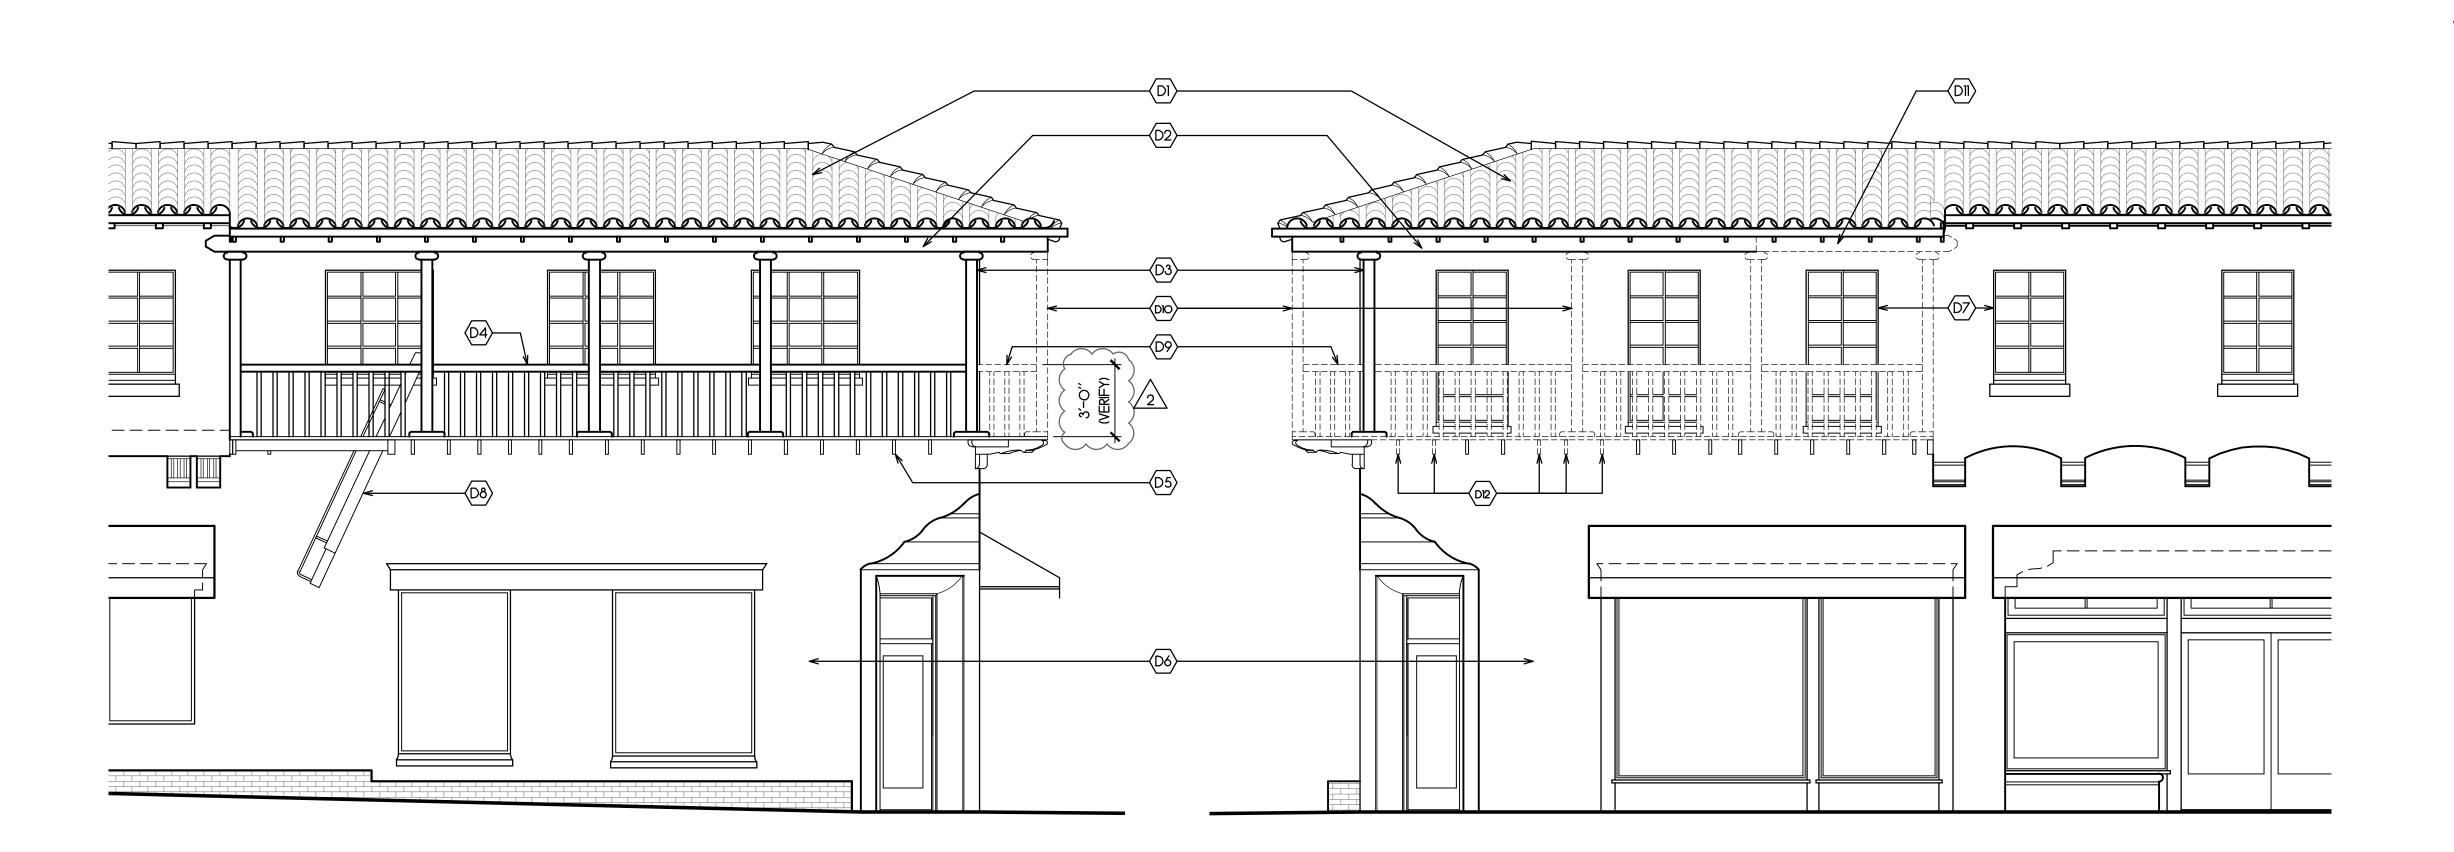
SHEET NUMBER

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PROPOSED EAST ELEVATION

PROPOSED SOUTH ELEVATION

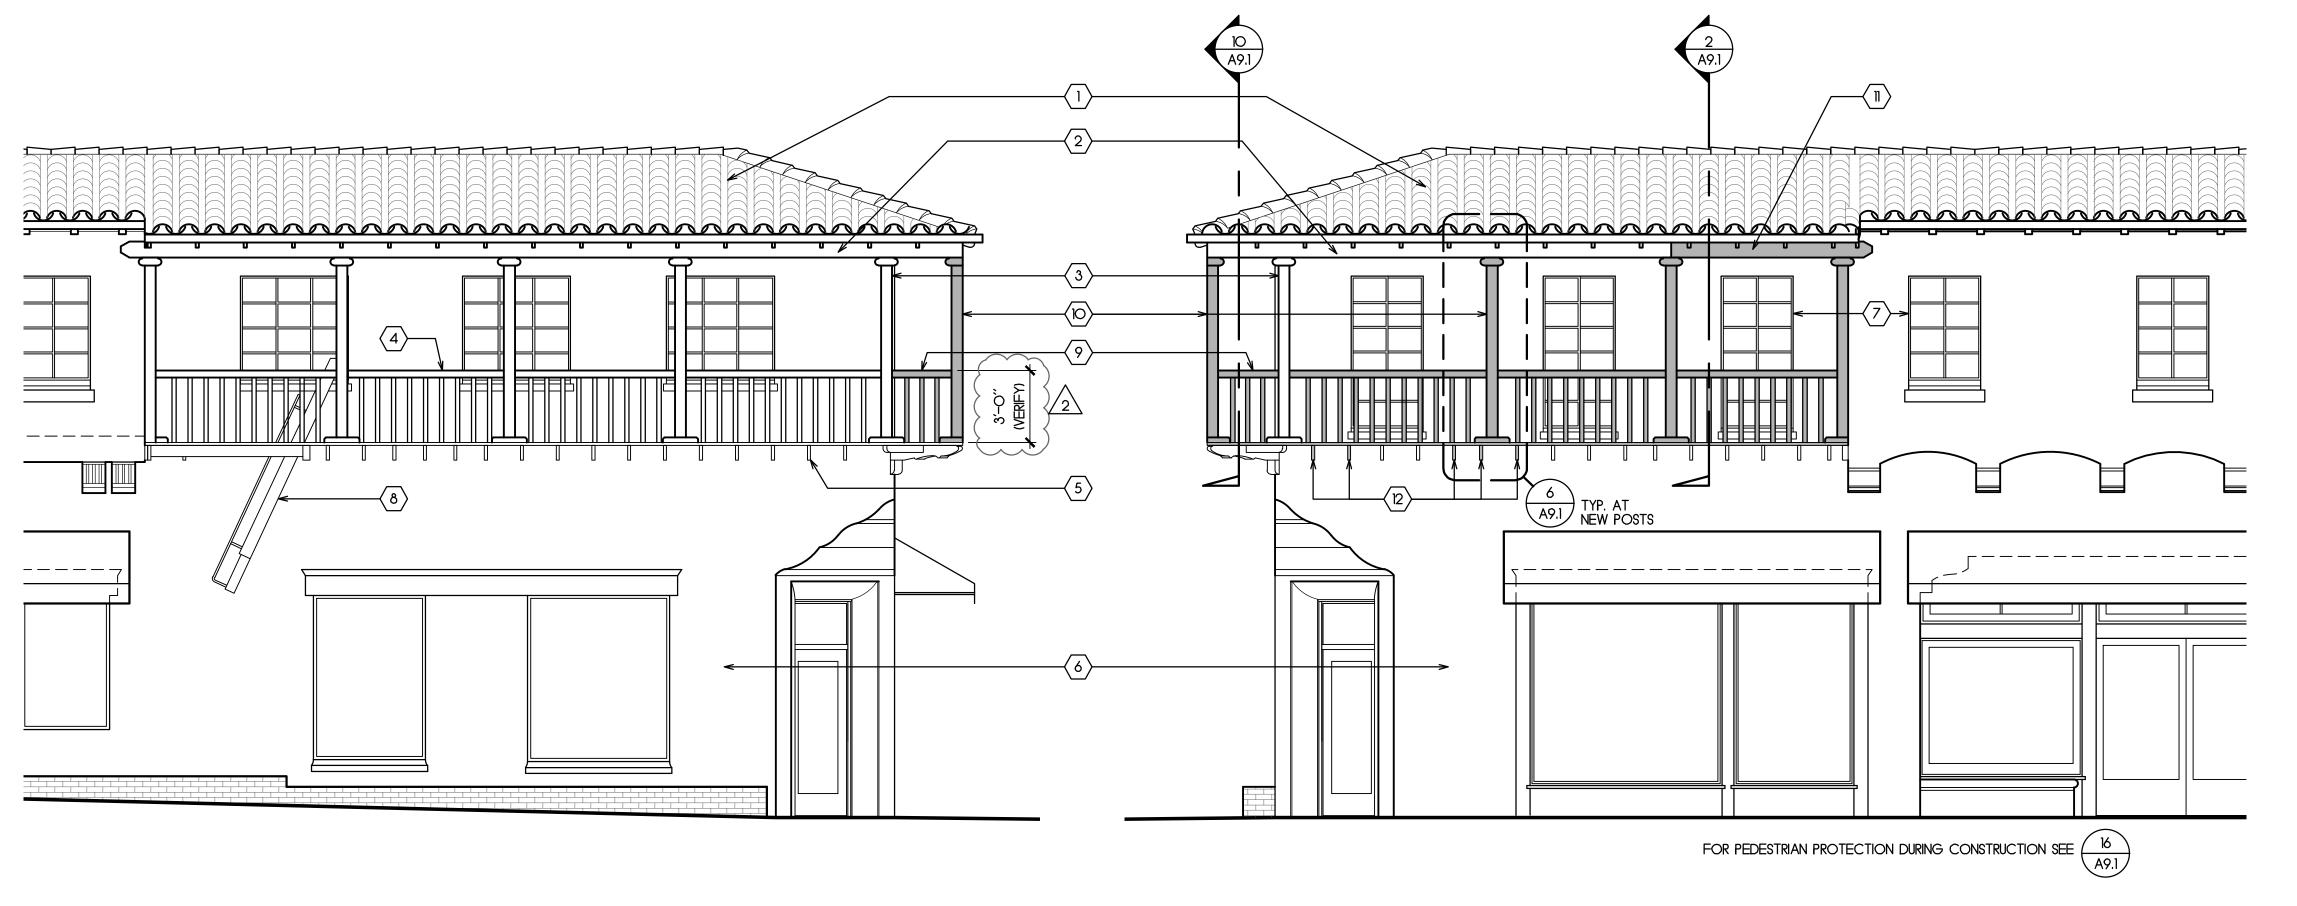


EXISTING/DEMOLITION EAST ELEVATION

EXISTING/DEMOLITION SOUTH ELEVATION

PROPOSED ELEVATION SHEET NOTES

- 1. EXISTING TILE ROOFING, ROOF RAFTERS, FASCIA, AND GUTTER TO REMAIN.
- 2. EXISTING WOOD BEAM TO REMAIN EXCEPT AS NOTED OTHERWISE.
- 3. EXISTING 6 x 6 POSTS, POST CAPS, AND POST BASES TO REMAIN EXCEPT AS NOTED OTHERWISE.
- 4. EXISTING GUARDRAILS AND BALUSTERS TO REMAIN EXCEPT AS NOTED OTHERWISE.
- 5. EXISTING WOOD DECK JOISTS TO REMAIN. REPAIR WHERE REQUIRED SEE DETAIL 8/A9.1.
- 6. EXISTING CEMENT PLASTER EXTERIOR FINISH TO REMAIN TYPICAL.
- 7. EXISTING WINDOWS TO REMAIN TYPICAL.
- . EXISTING PULL-DOWN STAIR TO REMAIN.
- 9. NEW GUARDRAIL AND BALUSTERS TO MATCH EXISTING (5 SECTIONS).
- 10. NEW 6 \times 6 POSTS, POST CAPS, AND POST BASES TO MATCH EXISTING (TYPICAL FOR 4).
- 1). NEW SECTION OF WOOD BEAM TO MATCH EXISTING. SPLICE OVER CENTER OF NEW POST AND SHAPE END TO MATCH EXISTING.
- 12. REPAIR EXISTING DECK JOISTS IN THIS AREA PER DETAIL 8/A9.1 (APPROX. 5-8 JOISTS FIELD VERIFY).

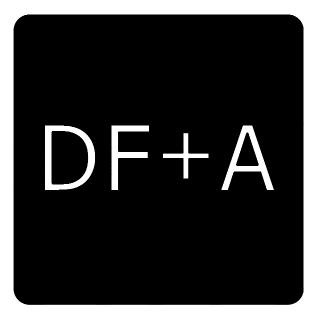

Daniel Fletcher + Associates
Architects

769 Pacific Street Monterey, CA 93940 831.373.5855



CONSULTANT

DEMOLITION ELEVATION SHEET NOTES

- DI. EXISTING TILE ROOFING, ROOF RAFTERS, FASCIA, AND GUTTER TO REMAIN.
- D2. EXISTING WOOD BEAM TO REMAIN EXCEPT AS NOTED OTHERWISE.
- D3. EXISTING 6 x 6 POSTS, POST CAPS, AND POST BASES TO REMAIN EXCEPT AS NOTED OTHERWISE.
- D4. EXISTING GUARDRAILS AND BALUSTERS TO REMAIN EXCEPT AS NOTED
- D5. EXISTING WOOD DECK JOISTS TO REMAIN. REPAIR WHERE REQUIRED -
- SEE DETAIL 8/A9.1.
- D6. EXISTING CEMENT PLASTER EXTERIOR FINISH TO REMAIN TYPICAL.
- D7. EXISTING WINDOWS TO REMAIN TYPICAL.
- D8. EXISTING PULL-DOWN STAIR TO REMAIN.
- D9. REMOVE GUARDRAILS AND BALUSTERS WHERE INDICATED (5 SECTIONS).
- DIO. REMOVE EXISTING POSTS, POST CAPS, AND POST BASES WHERE INDICATED (TYPICAL FOR 4).
- DII. CUT EXISTING WOOD BEAM AT MIDPOINT OF EXISTING POST AND REMOVE THIS PORTION OF BEAM.
- D12. REPAIR EXISTING DECK JOISTS IN THIS AREA PER DETAIL 8/A9.1 (APPROX. 5-8 JOISTS FIELD VERIFY).

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EXTERIOR ELEVATIONS

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 JRC

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 .

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REVISIONS:

2 02-13-2020

NOTE: EXAMINE EXISTING DECK JOISTS, BEAMS, DECK POSTS, POST BASES AND CAPITALS, AND GUARDRAIL MEMBERS FOR DRY ROT. IF DAMAGED MEMBERS ARE DISCOVERED REQUIRING REPAIR OR REPLACEMENT BEYOND THOSE IDENTIFIED ON DRAWINGS, NOTIFY ARCHITECT FOR INSPECTION PRIOR TO PROCEEDING.

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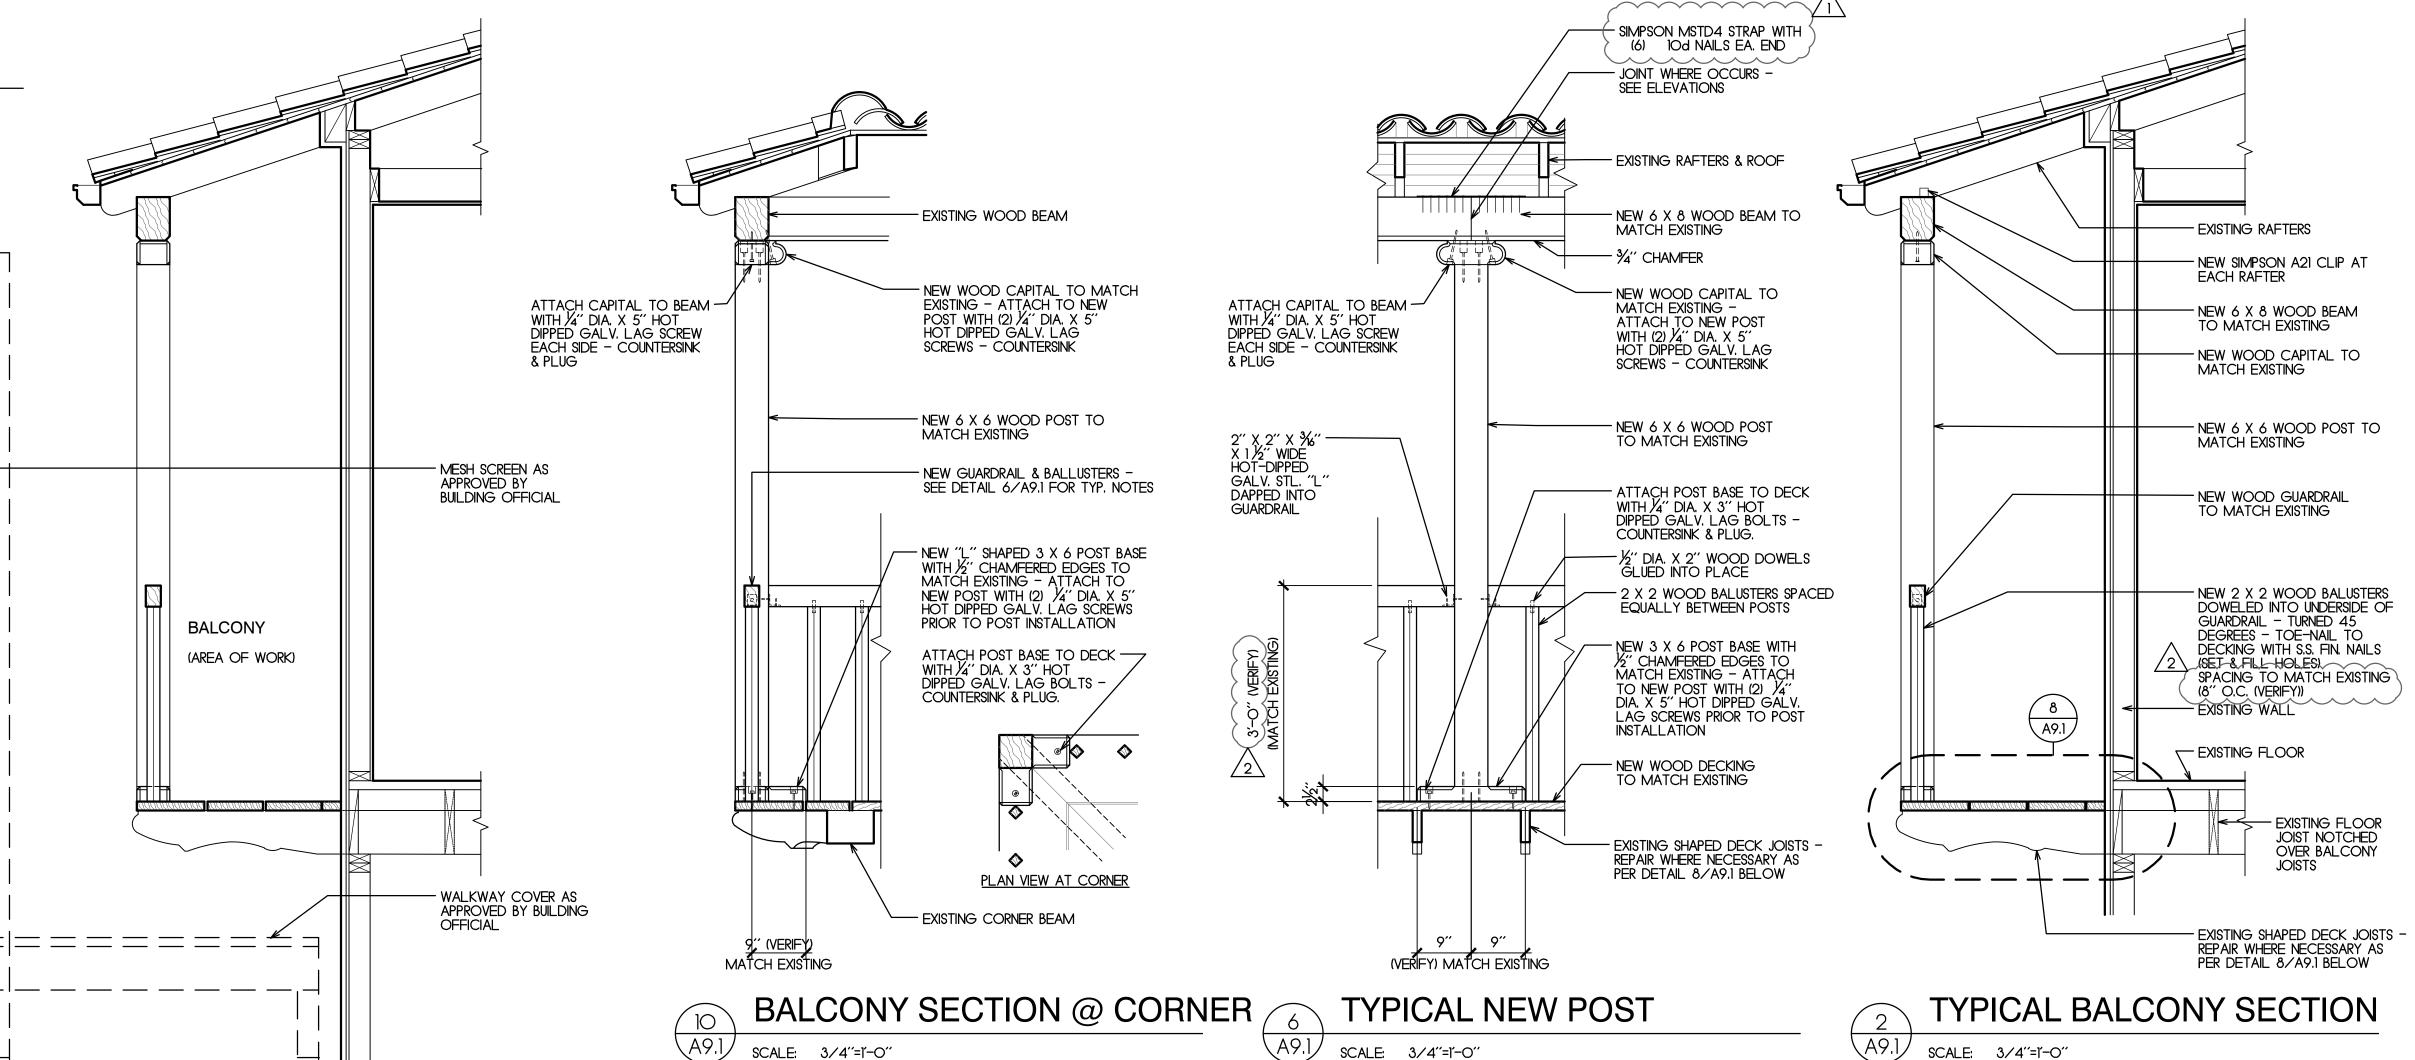
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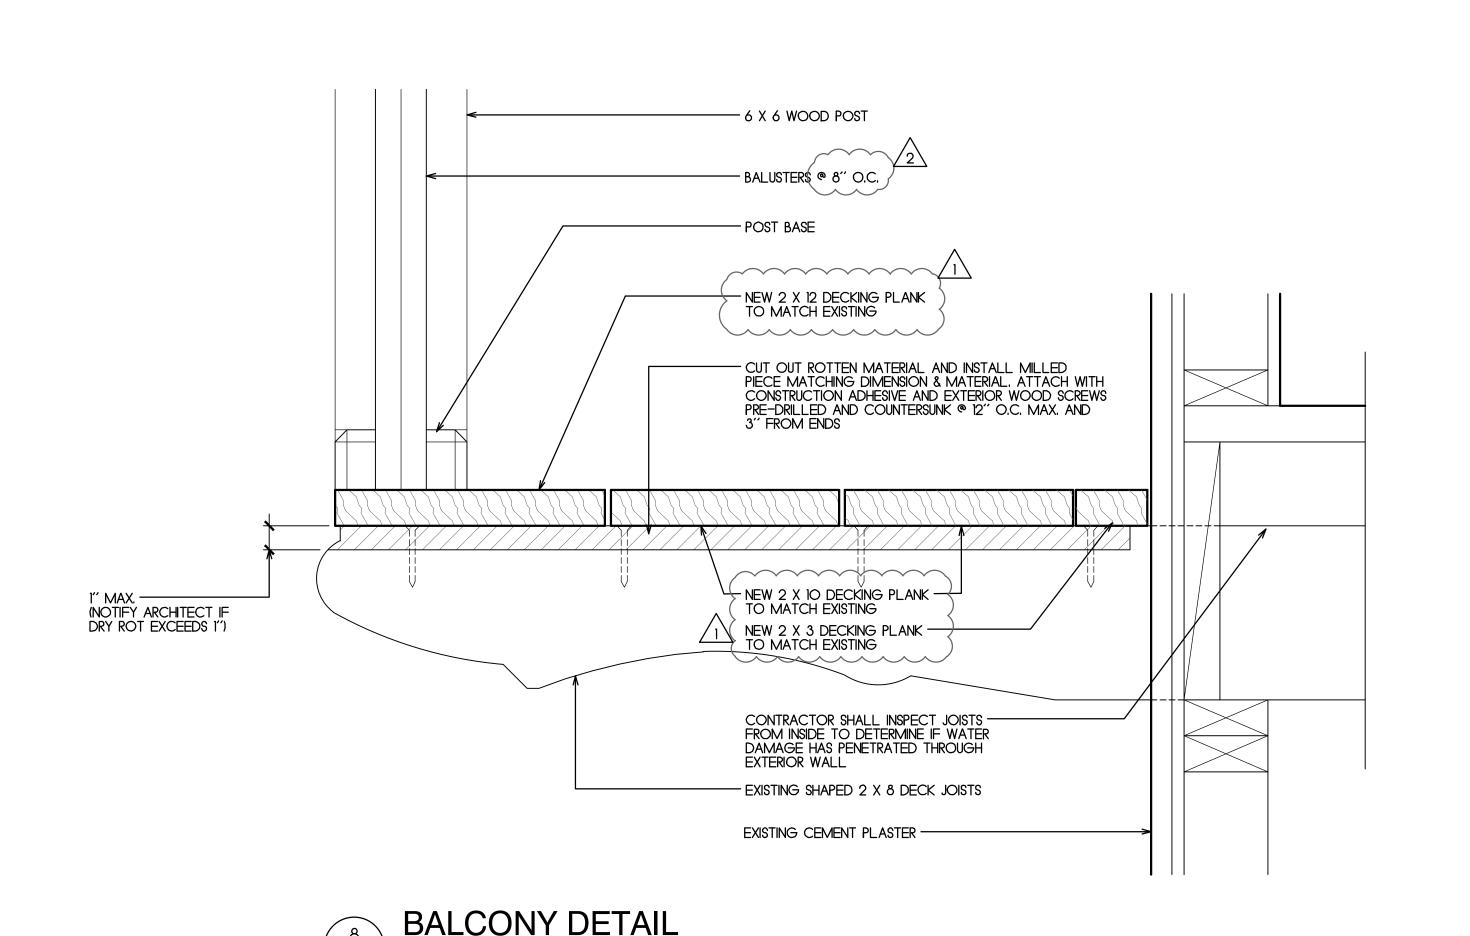
\3.1



- DEVICES AND SANITARY SAFEGUARDS SHALL BE MAINTAINED AT ALL TIMES DURING CONSTRUCTION.

 2. WASTE MATERIALS SHALL BE REMOVED IN A MANNER THAT PREVENTS
- INJURY OR DAMAGE TO PERSONS, ADJOINING PROPERTIES AND PUBLIC RIGHTS-OF-WAY.
- 3. SANITARY FACILITIES SHALL BE PROVIDED DURING CONSTRUCTION, REMODELING, AND DEMOLITION ACTIVITIES.
- 4. PEDESTRIANS SHALL BE PROTECTED DURING CONSTRUCTION, REMODELING, AND DEMOLITION ACTIVITIES AS REQUIRED BY CBC SECTION 3306 AND AS REQUIRED AND APPROVED BY THE BUILDING OFFICIAL.
- 5. SIGNS SHALL BE PROVIDED TO DIRECT PEDESTRIAL TRAFFIC AS APPROVED BY THE BUILDING OFFICIAL.
- 6. A COVERED WALKWAY SHALL BE PROVIDED IN THE AREA OF CONSTRUCTION, REMODELING, AND DEMOLITION ACTIVITIES IN ACCORDANCE WITH CBC SECTION 3306.7 AND AS REQUIRED AND APPROVED BY THE BUILDING OFFICIAL.
- a. THE DESIGN OF THE COVERED WALKWAY IS THE RESPONSIBILITY OF THE CONTRACTOR. CONTRACTOR SHALL SUBMIT THE DESIGN OF THE COVERED WALKWAY TO THE BUILDING DEPARTMENT FOR APPROVAL PRIOR TO STARTING DEMOLITION AND CONSTRUCTION. COVERED WALKWAYS SHALL BE DESIGNED TO SUPPORT ALL IMPOSED LOADS.
- b. PROVIDE ADEQUATE LIGHTING AT COVERED WALKWAY AT ALL TIMES. LIGHTING SHALL BE APPROVED BY THE BUILDING OFFICIAL.
- c. PROVIDE NETTING ON THE OUTSIDE OF THE BALCONY AND COVERED WALKWAY AS DIRECTED BY THE BUILDING OFFICIAL.
- 7. PEDESTRIAN PROTECTION SHALL BE MAINTAINED IN PLACE AND KEPT IN GOOD ORDER FOR THE ENTIRE LENGTH OF TIME PEDESTRIANS ARE SUBJECT TO BEING ENDANGERED. UPON THE COMPLETION OF CONSTRUCTION ACTIVITIES, IMMEDIATELY REMOVE PEDESTRIAN PROTECTION FACILITIES.
- 8. ADJOINING PUBLIC AND PRIVATE PROPERTY SHALL BE PROTECTED FROM DAMAGE DURING CONSTRUCTION, REMODELING, AND DEMOLITION WORK.
- 9. THE TEMPORARY USE OF STREETS OR PUBLIC PROPERTY FOR THE STORAGE OR HANDLING OF MATERIALS OR OF EQUIPMENT REQUIRED FOR CONSTRUCTION OR DEMOLITION, AND THE PROTECTION PROVIDED TO THE PUBLIC SHALL COMPLY WITH CBC SECTION 3308 AND THE PROVISIONS OF THE APPLICABLE GOVERNING AUTHORITY.





SCALE: 3"=1'-0"



4'-0" MIN.

- EXISTING AWNING -REMOVE & REPLACE AS NECESSARY

- SAFETY LIGHTING AS

OFFICIAL

THIS SHEET

EXISTING SIDEWALK

APPROVED BY BUILDING

PEDESTRIAN PROTECTION COVERED WALKWAY AS PER CBC SECTION 3306.7 -SEE "SAFEGUARDS DURING

CONSTRUCTION" NOTES



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CHIEL M FLETCHER

C-14778

COF CALIFORNIA

CONSULTANT

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DETAILS

SCALE:

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D. HOWE

PRINT DATE:

DRAWING DATE:

12-23-19

DATE ISSUED FOR CONSTRUCTION:

REVISIONS:

OI-15-2020 RFI #1

<u>2</u> 02-13-2020

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SHEET NUMBER

A9.1