

NOTICE OF APPROVAL

The Department of Community Planning & Building of the City of Carmel-by-the-Sea has approved a Project pursuant to the City's Municipal Code. Persons interested in the project may review additional materials available at the Department of Community Planning & Building located at City Hall on Monte Verde Street between Ocean and 7th Avenues, phone number 831-620-2010.

<u>The decision to approve this project may be appealed within 10 days from the date of this</u> by filing a written appeal with the Department of Community Planning & Building.

Planning Case #: Design Study 23344

Owner Name: HIPWELL FREDERICK W & KRISTINE M TRS

Case Planner: Alec Barton, Contract Planner

Date Posted: _____

Date Approved:

Project Location: TORRES STREET 10 SW OF 10TH

APN #: 010072025000 **BLOCK/LOT:** 119/ALL LOT 19

Applicant: Gretchen Flesher Architects

Project Description: WINDOW & DOOR REPLACEMENT, GUARDRAIL & EXT. LIGHTING MODIFICATIONS

Can this project be appealed to the Coastal Commission? Yes \Box No \checkmark

Upon completion of the 10 calendar-day appeal period, please return this form, along with the *Affidavit of Posting*, to the case planner noted above.

	CONDITIONS OF APPROVAL							
No.	Standard Conditions							
1.	Authorization. This approval of Design Study application DS 23-344 (Hipwell) finds the subject application consistent with the findings and requirements of CMC 17.10.030, and authorizes minor exterior modifications to the existing residence including replacing the railing and walking surface of an existing balcony, replacing painted wood windows with aluminum clad wood windows in existing openings, replacing French doors with aluminum clad wood doors in existing openings, removing and replacing exterior light fixtures, replacing a garage door and Dutch door, and painting the exterior of the residence at Torres 10 SW of 10th Avenue in the Single-Family Residential (R-1) zoning district, as depicted on plans marked approved by the Planning Division on February 6, 2024.							
2.	Codes and Ordinances. The project shall be constructed in conformance with all requirements of the R- 1 zoning district. All adopted building and fire codes shall be adhered to in preparing the working drawings. If any codes or ordinances require design elements to be changed, or if any other changes are requested when such plans are submitted, such changes may require additional environmental review and subsequent approval by the Community Planning and Building Department, the Planning Commission, and/or Historic Resources Board, as appropriate.							
3.	Permit Validity. In accordance with CMC Section 17.52.170 (Time Limits on Approvals and Denials), a residential design study approval remains valid for a period of 12 months from the date of action. During this time, the project must be implemented, or the approval becomes void. Implementation is effected by erecting, installing, or beginning the installation of the improvement authorized by the permit, as determined by the Director. Extensions to this approval may be granted consistent with CMC 17.52.170.C.							
4.	Modifications. The Applicant shall submit in writing, with revised plans, to the Community Planning and Building staff any proposed changes to the approved project plans prior to incorporating those changes. If the Applicant changes the project without first obtaining City approval, the Applicant will be required to submit the change in writing, with revised plans, within two weeks of the City being notified. A cease work order may be issued at any time at the discretion of the Director of Community Planning and Building until a) either the Planning Commission or Staff has approved the change, or b) the property owner has eliminated the change and submitted the proposed change in writing, with revised plans, for review. The project will be reviewed for its compliance with the approved plans prior to final inspection.							
5.	Water Use . Approval of this application does not permit an increase in water use on the project site without adequate supply. Should the Monterey Peninsula Water Management District determine that adequate water is unavailable for this site, this permit will be scheduled for reconsideration, and appropriate findings will be prepared for review and adoption by the Planning Commission.							
6.	Exterior Revisions to Planning Approval Form. All proposed modifications that affect the exterior appearance of the building or site elements shall be submitted on the "Revisions to Planning Approval" form on file in the Planning and Building Department. Any modification incorporated into construction drawings not listed on this form shall not be deemed approved upon issuance of a building permit.							
7.	Conflicts Between Planning Approvals and Construction Plans. It shall be the responsibility of the Owner, Applicant, and Contractor(s) to ensure consistency between the project plans approved by the Planning Staff, the Planning Commission, or the City Council on appeal and the construction plans submitted to the Building Division as part of the Building Permit review. Where inconsistencies between the Planning approval and the construction plans exist, the Planning approval shall govern unless otherwise approved in writing by the Community Planning & Building Director or their designee.							
	When changes or modifications to the project are proposed, the Applicant shall clearly list and highlight each proposed change and bring each change to the City's attention. Changes to the project incorporated into the construction drawings that were not clearly listed or identified as a proposed change shall not be considered an approved change. Should conflicts exist between the originally approved project plans and the issued construction drawings that were not explicitly identified as a proposed change, the plans approved as part of the Planning Department Review, including any Conditions of Approval, shall prevail.							

8.	Tree Removal. Trees on the site shall only be removed upon the approval of the City Forester or Forest						
	and Beach Commission, as appropriate; all remaining trees shall be protected during construction by						
	methods approved by the City Forester.						
9.	Tree Protection Measures. Requirements for tree preservation shall adhere to the following tree						
	 Prior to grading, excavation, or construction, the developer shall clearly tag or mark all trees to be preserved. 						
	 Excavation within 6 feet of a tree trunk is not permitted. No attachments or wires of any kind, other than those of a protective nature, shall be attached to any tree. 						
	 Per Municipal Code Chapter 17.48.110 no material may be stored within the dripline of a protected tree to include the drip lines of trees on neighboring parcels. 						
	 Tree Protection Zone The Tree Protection Zone shall be equal to dripline or 18 inches radially from the tree for every one inch of trunk diameter at 4.5 feet above the soil line, whichever is greater. A minimum of 4-foot-high transparent fencing is required unless otherwise approved by the City Forester. Tree protection shall not be resized, modified, removed, or altered in any manner without written approval. The fencing must be maintained upright and taught for the duration of the project. No more than 4 inches of wood mulch shall be installed within the Tree Protection Zone. When the Tree Protection Zone is at or within the drip line, no less than 6 inches of wood mulch shall be installed 18 inches radially from the tree for every one inch of trunk diameter at 4.5 feet above the soil line outside of the fencing. The Structural Root Zone Structural Root Zone shall be 6 feet from the trunk or 6 inches radially from the tree for every one inch of trunk diameter at 4.5' above the soil line, whichever is greater. Any excavation or changes to the grade shall be approved by the City Forester prior to work. Excavation within the Structural Root Zone shall be performed with a pneumatic excavator, hydro- 						
	 vac at low pressure, or another method that does not sever roots. If roots greater than 2 inches in diameter or larger are encountered within the approved Structural Root Zone the City Forester shall be contacted for approval to make any root cuts or alterations to structures to prevent roots from being damaged. 						
	If roots larger than 2 inches in diameter are cut without prior City Forester approval or any significant tree is endangered as a result of construction activity, the building permit will be suspended and all work stopped until an investigation by the City Forester has been completed and mitigation measures have been put in place.						
10.	Indemnification. The Applicant agrees, at his or her sole expense, to defend, indemnify, and hold harmless the City, its public officials, officers, employees, and assigns from any liability; and shall reimburse the City for any expense incurred, resulting from, or in connection with any project approvals. This includes any appeal, claim, suit, or other legal proceedings to attack, set aside, void, or annul any project approval. The City shall promptly notify the Applicant of any legal proceeding and cooperate fully in the defense. The City may, at its sole discretion, participate in any such legal action, but participation shall not relieve the Applicant of any obligation under this condition. Should any party bring any legal action in connection with this project, the Superior Court of the County of Monterey, California, shall be the situs and have jurisdiction for resolving all such actions by the parties hereto.						
11.	Conditions of Approval. Prior to the issuance of a building permit, these signed Conditions of Approval shall be printed on a full-size sheet within the construction plan set submitted to the Building Division.						
4.2	Special Conditions						
12. 13.	Building Permit . The applicant shall obtain a Building Permit from the Planning and Building Department. Exterior Lighting . Exterior lighting shall be limited to 25 watts or less (incandescent equivalent, i.e., 375 lumens) per fixture and shall be no higher than 10 feet above the ground. Landscape lighting shall be limited to 15 watts (incandescent equivalent, i.e., 225 lumens) or less per fixture and shall not exceed 18 inches above the ground. All fixtures shall be shielded and down facing.						

14.	Aluminum-Clad Wood Frame Windows and Doors. Prior to the issuance of a building permit, the								
	Applicant shall include the manufacturer's specifications for the approved aluminum-clad wood windows								
	and doors. The window style shall be consistent with authentic wood windows and doors with divided								
	lights that appear to be true divided light, including the use of internal and external mullions and muntins								
	on insulated windows. Any window pane dividers, which are snap-in or otherwise superficially applied,								
	are not permitted. The painted finish shall be matte or low gloss.								
15.	Copper Gutters & Downspouts Not Permitted. Copper gutters and downspouts are prohibited.								
16.	Conditions of Approval Acknowledgement. Prior to the issuance of a building permit revision, a								
	completed Conditions of Approval Acknowledgment form shall be included in the construction drawings.								
	The form shall be signed by the Property Owner, Applicant, and Contractor prior to the issuance of a								

Acknowledgment and acceptance of conditions of approval:

Property Owner Signature

Printed Name

Date

Applicant Signature

building permit.

Printed Name

Date

ABBREVIATIONS

&	AND
L	ANGLE
0	AT
Q.	CENTERLINE
φ _τ	DIAMETER OR ROUND
ΨT	PERPENDICULAR
	PERPENDICULAR
#	POUND OR NUMBER
Þ.	PROPERTY LINE
ABV	ABOVE
AFF	ABOVE FINISH FLOOR
ACOUS	ACOUSTICAL
ADJ	ADJUSTABLE
-	
AGG	AGGREGATE
ALT	ALTERNATE
AL	ALUMINUM
AB	ANCHOR BOLT
	APPROXIMATE
ARCH	ARCHITECTURAL
AC	ASPHALTIC CONCRETE
ВМ	BFAM
	BITUMINOUS
BITUM	
BLK	BLOCK
BLKG	BLOCKING
BD	BOARD
-	
вот	BOTTOM
BLDG	BUILDING
BUR	BUILT-UP ROOFING
CAB	CABINET
-	
CA	CARPET
CLKG	CAULKING
СВ	CATCH BASIN
CI	CAST IRON
-	CEILING
CLG	
CEM	CEMENT
CNTR	CENTER
СТ	CERAMIC TILE
-	
CLR	CLEAR
CW	COLD WATER
COL	COLUMN
CONC	CONCRETE
CMU	CONCRETE MASONRY UNIT
CONN	CONNECTION
CONST	CONSTRUCTION
CJ	CONTROL JOINT
CONT	CONTINUOUS
CONTR	CONTRACTOR
CTSK	COUNTERSINK
DET	DETAIL
DIAG	DIAGONAL
-	
DIA	DIAMETER
DIM	DIMENSION
DR	DOOR
DS	DOWNSPOUT
DWG	
-	DRAWING
DF	DRINKING FOUNTAIN
	OR DOUGLAS FIR
DP	DIMENSION POINT
EA	EACH
EIFS	EXTERIOR INSULATION

	ELECTRICAL	L
	ELECTRIC PANELBOARD	Ľ
	ELEVATION	Ľ
	ELEVATOR	Μ
	ENCLOSURE	Μ
	ENGINEER	Μ
	EQUAL	M
	EQUIPMENT	M
(E)	EXISTING	M
(∟)	EXPANSION JOINT	M
	EXPOSED	IV
	FACE of CONCRETE	Μ
	EXTERIOR	M
		M
		M
	FIBERGLASS REINFORCED	M
	PLASTIC	N
	FINISH	N
	FINISH FLOOR	N
	FIRE ALARM	Ν
	FIRE EXTINGUISHER/BRACKET	0
	FIRE EXTINGUISHER/CABINET	0
	FIXTURE	0
	FLASHING	0
	FLEXIBLE	0
	FLOOR	0
	FLOOR DRAIN	0
2	FLUORESCENT	Ρ
	FOOTING	Ρ
	FOOT OR FEET	Ρ
	FOUNDATION	Ρ
	FRAME	Р
	FURRING	Р
	GALVANIZED	Ρ
	GALVANIZED SHEET METAL	P
	GAUGE	P
	GENERAL	P
	GLASS	P
	GLULAM BEAM	Q
	GRADE	R
	GROUND	R
	GYPSUM	R
	GYPSUM WALL BOARD	R
	HANDRAIL	R
	HARDWARE	R
	HARDWOOD	R
	HEADER	R
	HEIGHT	R
	HOLLOW METAL	S
	HORIZONTAL	S
	HOSE BIBB	S
	HOUR	S
	HOT WATER	S
	INCLUDE	S
	INSIDE DIAMETER	S
	INSULATION	S
	INTERIOR	s
	JOINT	S
	JOIST	S
	LAMINATE	s
		0

ELEC

EQPT FXIST

FOC

FOS

FFC FIXT **FLASH**

FLEX

FLUOF

FTG

FDN FR

FURR

GALV GSM

GA GENL GI

GI B

GR GND

GYP

GWF

HDWD

HDR

HOR7

JST

LAM

HR HDWF

FT

FLR FD

EP

EL ELEV ENCL ENGR EQ

AV	LAVATORY	SPEC	SPECIFICATIO
T	LIGHT	SQ	SQUARE
WC	LIGHTWEIGHT CONCRETE	SS	STAINLESS ST
ИB	MARKER BOARD	STD	STANDARD
MFR	MANUFACTURER	STL	STEEL
MO	MASONRY OPENING	STRUCT	STRUCTURAL
MAX	MAXIMUM	SUSP	SUSPENDED
MECH	MECHANICAL	SAT	SUSPENDED A
MEMB	MEMBRANE	SYM	SYMETRICAL
MEPS	MOLDED EXPANDED	SYS	SYSTEM
VILF J	POLYSTYRENE BOARD	T	TREAD
MET MIN	METAL	TEMP	TEMPERED
			THICKNESS
MISC	MISCELLANEOUS	THRES	THRESHOLD
MTD	MOUNTED		TACKBOARD
MUL	MULLION	TCA	TILE COUNCIL
MOM	NOMINAL	T&G	TONGUE & GR
NIC	NOT IN CONTRACT	TOC	TOP of CONCR
NTS	NOT TO SCALE	TOP	TOP of PAVEM
NO /#	NUMBER	TOS	TOP of STEEL
D/	OVER	TOW	TOP of WALL
C	ON CENTER	TS	TUBE STEEL
OPP	OPPOSITE	TYP	TYPICAL
opp HND	OPPOSITE HAND	TEN	TYPICAL END
DD	OUTSIDE DIAMETER	UON	UNLESS OTHE
DA	OVERALL	VIF	VERIFY IN FIEI
ЭН	OVERHEAD	VERT	VERTICAL
РΤ	PAINT	VGDF	VERTICAL GR/
PR	PAIR	VCT	VINYL COMPO
PNL	PANEL	VWF	VINYL WALL F
PTN	PARTITION	WP	WATERPROOF
PLAS	PLASTER	WPM	WATERPROOF
P LAM	PLASTIC LAMINATE	WWM	WELDED WIRE
PL	PLATE	WDW	WINDOW
PWD	PLYWOOD	W/	WITH
PS	PLYWOOD SHEATHING	W/O	WITHOUT
РΤ	POINT OR PAINT	WD	WOOD
PVMT	PAVEMENT		
ΩT	QUARRY TILE		
ર	RADIUS OR RISER		
RWL	RAIN WATER LEADER		
RWD	REDWOOD		
REINF	REINFORCED		
REQ	REQUIRED		
RESIL	RESILIENT		
REV	REVISION OR REVISED		
RD	ROOF DRAIN		
20	ROUGH OPENING		
SCHED	SCHEDULE		
SECT	SECTION		
SAD	SEE ARCHITECTURAL DRAW	INGS	
SED	SEE ELECTRICAL DRAWINGS		
SLD	SEE LANDSCAPE DRAWINGS		
SMD	SEE MECHANICAL DRAWINGS		
SSD	SEE STRUCTURAL DRAWING		
SHT	SHEET	.	
SH	SHELF		
SHWR	SHOWER		
SIM	SIMILAR		
SIN	SOLID CORE		
50	JULID GURE		

GENERAL NOTES

FINISH SYSTEM

I. GENERAL DIMENSIONING GUIDELINES:

- 1. CONTRACTOR TO VERIFY ALL EXISTING CONDITIONS IN THE FIELD BEFORE COMMENCING WORK. CONTRACTOR TO FURNISH AND INSTALL ALL MATERIALS NECESSARY TO COMPLETE THE WORK INDICATED ON THE DRAWINGS AND SPECIFIED.
- 2. DIMENSIONS AT EXTERIOR WALLS ARE GIVEN TO FACE OF SHEATHING/FOUNDATION, UNLESS OTHERWISE NOTED.
- 3. DIMENSIONS AT INTERIOR WALLS ARE GIVEN TO FACE OF STUDS, UNLESS OTHERWISE NOTED.

II. DETAILS:

IN THE EVENT THAT CERTAIN DETAILS OF THE CONSTRUCTION ARE NOT FULLY SHOWN OR NOTED ON THE DRAWINGS OR CALLED FOR IN THE SPECIFICATIONS. THEIR CONSTRUCTION SHALL BE OF THE SAME SIZE AND CHARACTER AS FOR SIMILAR CONDITIONS WHICH ARE SHOWN AND NOTED.

III. LIGHT FIXTURES:

1. RECESSED LIGHT FIXTURES LOCATED IN NEW JOIST SPACES WILL CONTROL THE LOCATION OF JOISTS.

IV. WATER:

ALL PLUMBING FIXTURES WITHIN THIS PROJECT SCOPE MUST COMPLY WITH THE FOLLOWING REQUIREMENTS.

- 1.28 GALLONS/FLUSH MAXIMUM, U.O.N. TOILETS: 2. SHOWER HEADS: 2.0 GALLONS PER MINUTE MAXIMUM @ 80 PSI
- 3. FAUCETS:

WASHBASIN MUST HAVE AERATORS WHICH RESTRICT FLOW TO1.2 GALLONS PER MINUTE @ 60 PSI, ALL OTHER FAUCETS, 1.8 GPM.

V. PLUMBING:

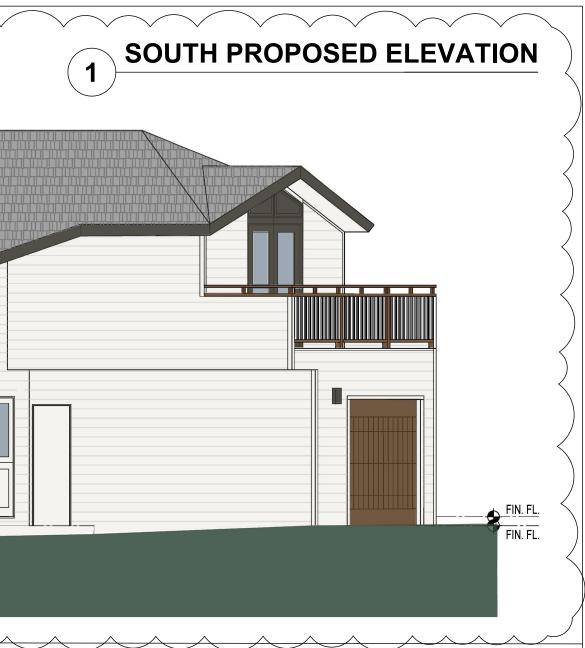
- 1. THE USE OF SOLDERS CONTAINING MORE THAN TWO TENTHS OF ONE PERCENT LEAD IN MAKING JOINTS ON PRIVATE OR PUBLIC WATER SUPPLY SYSTEMS IS PROHIBITED PER SB 164.
- 2. THE USE OF PLUMBING PIPELINES AS AN ELECTRICAL GROUND IS PROHIBITED PER SB 164.
- 3. NO PERSON MAY TAP INTO ANY FIRE HYDRANT FOR ANY PURPOSE OTHER THAN FIRE SUPPRESSION OR EMERGENCY AID WITHOUT FIRST OBTAINING WRITTEN APPROVAL FROM THE WATER PURVEYOR SUPPLYING WATER TO THE HYDRANT AND FROM THE MONTEREY COUNTY HEALTH DEPARTMENT PER SECTION 6(K), ORD 3522.
- 4. ALL HOSES USED IN CONNECTION WITH ANY CONSTRUCTION ACTIVITIES SHALL BE EQUIPPED WITH A SHUTOFF NOZZLE. WHEN AN AUTOMATIC SHUTOFF NOZZLE CAN BE PURCHASED OR OTHERWISE OBTAINED FOR THE SIZE OR TYPE OF HOSE IN USE, THE NOZZLE SHALL BE AN AUTOMATIC SHUTOFF NOZZLE PER SEC. 6(K), ORD 3522.
- 5. NO POTABLE WATER MAY BE USED FOR COMPACTION OR DUST CONTROL PURPOSES IN CONSTRUCTION ACTIVITIES WHERE THERE IS A REASONABLY AVAILABLE SOURCE OF RECLAIMED OR OTHER SUBPOTABLE WATER APPROVED BY THE MONTEREY COUNTY HEALTH DEPARTMENT AND APPROPRIATE FOR SUCH USE PER SECTION 6(K), ORD 3522.

VI. GLAZING

1. NEW DOORS WITH GLAZING SHALL HAVE A U-FACTOR EQUAL TO OR LESS THAN 0.45 AND COMPLY WITH PACKAGE 'D' SHDG REQUIREMENTS.

- PER SEC. 10-111 OF THE CAGBS.

ЛC STEEL ACOUSTIC TILE L of AMERICA ROVE RETE MENT NAIL ERWISE NOTED ELD FIN. FL. RAIN DOUGLAS FIR **OSITION TILE** ABRIC OF MEMBRANE RE MESH SYMBOLS **DRAWING INDEX** Site Plan TITLES A2.0 **BUILDING SECTIONS** A3.0 EXISTING FLOOR/DEMO PLANS PROPOSED FLOOR PLANS A3.1 A4.0 SCHEDULES & RAILING DETAIL Target Target, & Detail Number (Project Manual) Sheet Number PLAN DETAILS A5.0 A5.1 X3.100 Detail Number (Project Manual A10) DETAIL DRAWINGS Window Number (See Window Schedule) WINDOWS Door Number (See Door Schedule) (3)DOORS + 10' - 6" Point at Plan SC SOLID CORE FLOOR ELEVATIONS EL + 10' - 6" General at Plan At Exterior Elevations & Sections **+** 10' - 6" **PROJECT INFORMATION** VICINITY MAP 2. A PERMANENT LABEL PER CBC SECTION 2406.2 SHALL IDENTIFY EACH LIGHT OF SAFETY GLAZING. OWNER 3. EVERY MANUFACTURED FENESTRATION PRODUCT SHALL HAVE PERMANENT LABELING THAT CERTFIES COMPLIANCE WITH AIR LEAKAGE, U-FACTOR, SHGC AND VT ARCHITECT VII. FINISHES/POLLUANT CONTROL PENETRATIONS AND OPENINGS SHALL BE PROTECTED DURING CONSTRUCTION IN CONFORMANCE WITH CAGBS SEC. 4.504.1. 2. FINISHES AND ADHESIVES SHALL COMPLY WITH VOC LIMITS PER CGBC SEC. 4.504 LOCATION TABLES 4.504.1-4.505.3. CONTRACTOR SHALL PROVIDE DOCUMENTATION OF INSTALLED PROJECT MATERIALS AND FINISHES. 12TH AVE LEGAL DESCRI VIII AIR LEAKAGE & INSULATION APN PARCEL AREA 1. ALL JOINTS, PENETRATIONS AND OTHER OPENINGS IN THE BUILDING ENVELOPE THAT ZONING ARE POTENTIAL SOURCES OF AIR LEAKAGE SHALL BE CAULKED, GASKETED, FIRE DEPARTM WEATHERSTRIPPED OR OTHERWISE SEALED TO LIMIT INFILTRATION. IX. ENHANCED DURABILITY AND REDUCED MAINTENANCE 1. ANNULAR SPACES AROUND PIPES, ELECTRIC CABLES, CONDUITES OR OTHER OPENINGS SCOPE OF WOF IN SOLE/BOTTOM PLATES AT EXTERIOR WALLS SHALL BE CLOSED CEMENT MORTAR, CONCRETE MANSONRY OR SIMILAR METHOD ACCEPTABLE TO THE ENFORCING AGENCY TO PREVENT PASSAGE OF RODENTS. 11th Ave OPENINGS IN THE BUILDING ENVELOPE SEPARTING CONDITIONED AND NON-CONDITIONED SPACE NEEDED TO ACCOMMODATE GAS, PLUMBING, ELECTRICAL LINES AND OTHER NECESSARY PENETRATIONS, MUST BE SEALED AS REQUIRED BY THE CAEC. X. CONSTRUCTION WASTE REDUCTION RECYCLE AND/OR SALVAGE FOR REUSE A MINIMUM OF 65% OF THE NON-HAZARDOUS CONSTRUCTION AND DEMOLITION WASTE OR MEET A MORE STRINGENT LOCAL CONSTRUCTION AND DEMOLITION WASTE MANAGEMENT ORDINANCE. EXCEPTIONS: A. EXCAVATED AND LAND-CLEARING DEBRIS. B. ALTERNATE WASTE REDUCTION METHODS BY WORKING WITH LOCAL AGENCIES IF DIVERSION OR RECYCLE FACILITIES CAPABLE OF COMPLICANCE DO NOT EXIST SITEWORK OR ARE NOT LOCATED REASONABLY CLOSE TO THE JOBSITE. TREE REMOVA WHERE A LOCAL JURISDICTION DOES NOT HAVE A MORE STRINGENT WASTE MANAGEMENT ORDINANCE, A CONSTRUCTION WASTE MANAGEMENT PLAN SHALL BE REQUIRED PAR SUBMITTED FOR APPROVAL TO THE ENFORCING AGENCY. OTHER OPTIONS FOR CARMEL-BY-THE-SEA OCCUPANCY MEETING THE 50% WASTE REDUCTION REQUIREMENTS INCLUDE UTILIZING A WASTE MANAGEMENT COMPANY APPROVED BY THE LOCAL ENFORCING AGENCY OR REDUCING CONSTRUCTION PLANNING DEPARTMENT TOTAL CONSTRUCTION WASTE GENERATION TO BELOW 4 POUNDS PER SQUARE FOOT WATER OF BUILDING AREA. APPROVED SEWER XI. APPLICABLE CODES: THIS PROJECT SHALL CONFORM TO : CUT AND FILL CALIFORNIA BUILDING CODE, 2022 EDITION (CBC) FIRE PROTECT CALIFORNIA PLUMBING CODE, 2022 EDITION (CPC) Permit #: DS 23-344 (Hipwell) SPRINKLERS CALIFORNIA MECHANICAL CODE, 2022 EDITION (CMC) CALIFORNIA ELECTRICAL CODE, 2022 EDITION (CEC) Date Approved: February 6, 2024 TITLE 24 CALIFORNIA BUILDING ENERGY CODE, 2022 EDITION (CAEC) **PROJECT ARE** TITLE 24 CALIFORNIA GREEN BUILDING STANDARDS CODE, 2022 EDITION (CAGBS) Planner: <u>A. Barton</u> FLOOR AREA CALIFORNIA RESIDENTIAL CODE, 2022 EDITION (CRC) EXISTING F CALIFORNIA FIRE CODE, 2022 EDITION (CFC) GARAGE CITY OF CARMEL BY THE SEA AMENDMENTS AND REGULATORY REQUIREMENTS



A1.0 TITLE SHEET, VICINITY MAP, PROJECT DATA, SITE PLAN AND EXTERIOR LIGHT FIXTURES EXTERIOR ELEVATIONS, EXISTING RESIDENCE PHOTOS EXTERIOR ELEVATIONS, MATERIALS

	FRED & KRIS HIPWELL
	P.O. BOX CARMEL, CA 93923
	GRETCHEN FLESHER ARCHITECTS 550 HARTNELL ST, SUITE E
	MONTEREY, CA 93940
	831.375.4868 gretchen@gfastudio.com
	TORRES STREET 10 SW OF 10TH CARMEL-B7-THE-SEA, MONTEREY COUNTY, CALIFORNIA
IPTION:	LOTS 19, BLOCK 119, ADDITION NO.5 TO CARMEL-BY-THE-SEA
	010-072-025 4000 SQ. FT.
	4000 SQ. FT. R-1
IENT	CARMEL FIRE
RK	THE PROJECT SCOPE INCLUDES MINOR EXTERIOR WORK; 1. REPLACE THE FRONT SECTION OF THE BALCONY GUARDRAIL WITH
	 REPLACE THE FRONT SECTION OF THE BALCONY GUARDRAIL WITH (N) STAINED WOOD RAILING, REPLACE BALCONY WALKING SURFACE;
	 REPLACEMENT OF (E) PAINTED WOOD WINDOWS WITH (N) ALUM. CLAD WOOD WINDOWS IN THE EXISTING OPENINGS;
	3. REPLACE 3 (E) FRENCH DOORS WITH NEW ALUM. CLAD WOOD DOORS
	IN (E) OPENINGS; 4. REMOVE SELECT EXTERIOR DECORATIVE LIGHT FIXTURES AND
	REPLACE REMAINING WITH NEW WALL FIXTURES;
	 REPLACE (E) PAINTED WOOD GARAGE DOOR WITH NEW STAINED DOOR, REPLACE (E) PAINTED DUTCH DOOR W/(N) STAINED WOOD
	DUTCH DOOR;
	6. EXTERIOR PAINT OF ENTIRE RESIDENCE.
	INTERIOR REMODELING INCLUDES REMODELING IN PLACE TWO
	BATHROOMS AND THE KITCHEN. NEW INTERIOR FLOORING, LIGHTING FIXTURE UPGRADES, REPLACEMENT OF METAL FIREPLACES, SURROUNDS,
	AND HEARTHS IN (E) LOCATIONS.
	NONE (PREVIOUS WORK DONE UNDER BLDG. PERMIT 17165)
L	NONE
RKING	NA
	SFD
N TYPE	V-B
	EXISTING CAL AM METER
	CITY SEWER
	NONE
ION/	NO <5% REMOVAL OR ADDITION OF LINEAR INTERIOR AND EXTERIOR WALLS.
<u>A</u>	EXISTING/PROPOSED
RESIDENCE	1435 SQ. FT.
	370 SQ. FT.
	2422 SQ. FT.

Gretchen Flesher AIA



architecture

550 Hartnell St., Suite E Monterey CA 93940 831.375.4868

HIPWELL RESIDENCE REMODEL

TORRES ST. 10 SW OF 10th CARMEL BY THE SEA, CA

APN 010-072-025

1317.01

CONSTRUCTION PERMIT SUBMITTAL

Title:

PROJECT INORMATION VICINITY MAP & SYMBOLS SHEET INDEX **ABBREVIATIONS & NOTES**

Revisions:

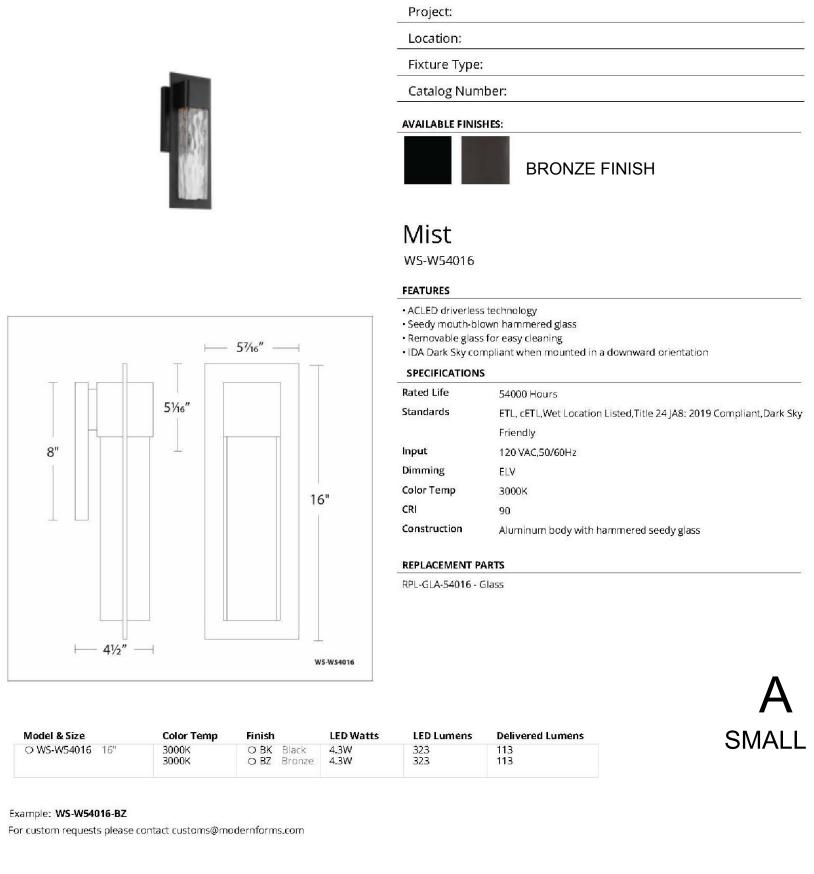
▲ DSA REVISIONS 1.31.24

Scale: 1/4"=1'-0"

Sheet No:

A1.0

Date: NOV. 7, 2023

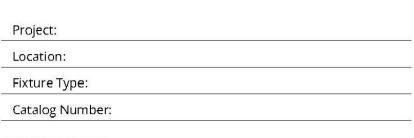




61/4"

⊢ 6½″ →

.





AVAILABLE FINISHES:

BRONZE FINISH

Mist

WS-W54020

PRODUCT DESCRIPTION A contemporary outdoor sconce inspired by the handmade colonial era glass window

panes. The seeded and hammered glass is captivatingly framed and weather resistant finished. FEATURES

 ACLED driverless technology Seedy mouth-blown hammered glass

Removable glass for easy cleaning

IDA Dark Sky compliant when mounted in a downward orientation

SPECIFICATIONS Rated Life

54000 Hours Standards ETL, cETL,Wet Location Listed,Title 24 JA8: 2019 Compliant,Dark Sky

Friendly

Input 120 VAC,50/60Hz

Dimming ELV

Color Temp 3000K

CRI 90

Construction Aluminum body with hammered seedy glass

REPLACEMENT PARTS RPL-GLA-54020 - Glass

Model & Size **Delivered Lumens** Color Temp Finish LED Watts LED Lumens O WS-W54020 20" 228 228

WS-W54020

O BK Black 8W O BZ Bronze 8W 3000K 3000K 600 600

20

Example: WS-W54020-BZ For custom requests please contact customs@modernforms.com

•

<u>├── 5½″</u> ─ |

10"

В LARGE

ModernForms.com | Phone: (866) 810-6615 | Fax (800) 526-2585 Central Distribution Center: 1600 Distribution Ct, Lithia Springs, GA 30122 Western Distribution Center: 1750 Archibald Avenue, Ontario, CA 91760

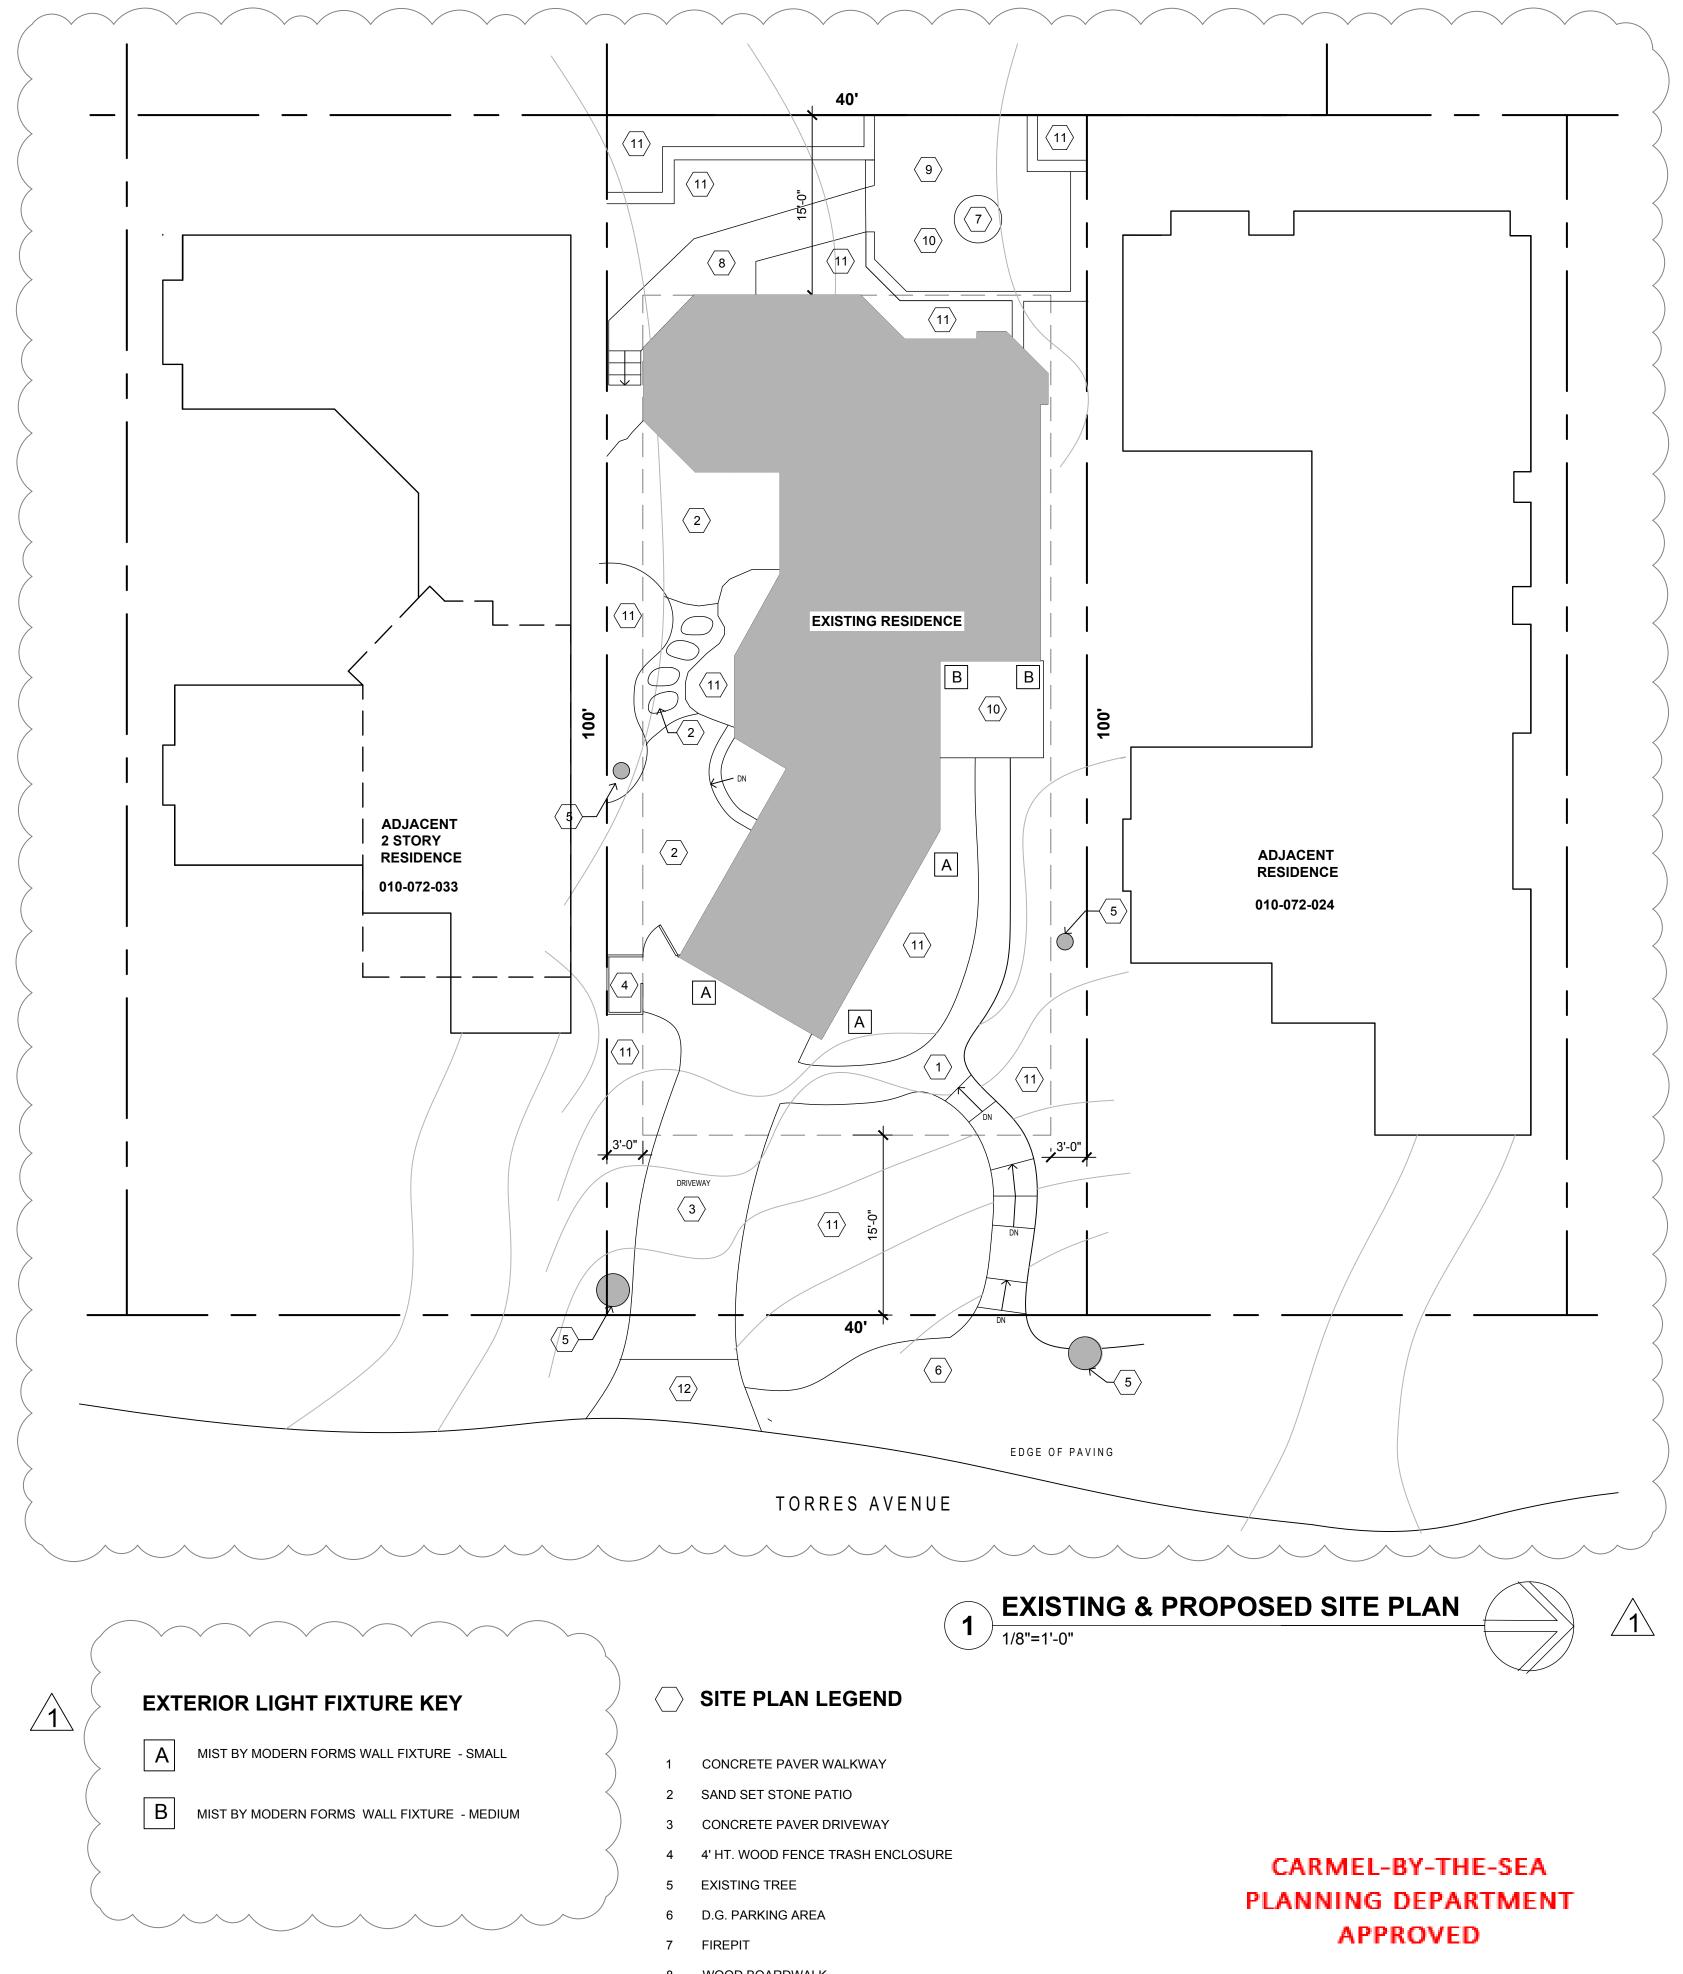
MODERN FORMS

2 PROPOSED EXTERIOR LIGHTING

1







- 8 WOOD BOARDWALK
- 9 LOW LANDSCAPE WALLS
- 10 CONCRETE ENTRY LANDING
- 11 PLANTING AREA
- 12 A.C. PAVING

Plan

mit <u>#:</u> DS 23-344 (Hipwell)	
e Approved: February 6, 2024	
nner: _ A. Barton	

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HIPWELL RESIDENCE REMODEL

TORRES ST. 10 SW OF 10th CARMEL BY THE SEA, CA

APN 010-072-025

1317.01

TRACK 1 DESIGN REVIEW

Title: SITE PLAN EXTERIOR LIGHT FIXTURES

Revisions: A DSA REVISIONS 1.31.24

Sheet No: Scale: 1/8"=1'-0"

Date: NOV. 7, 2023

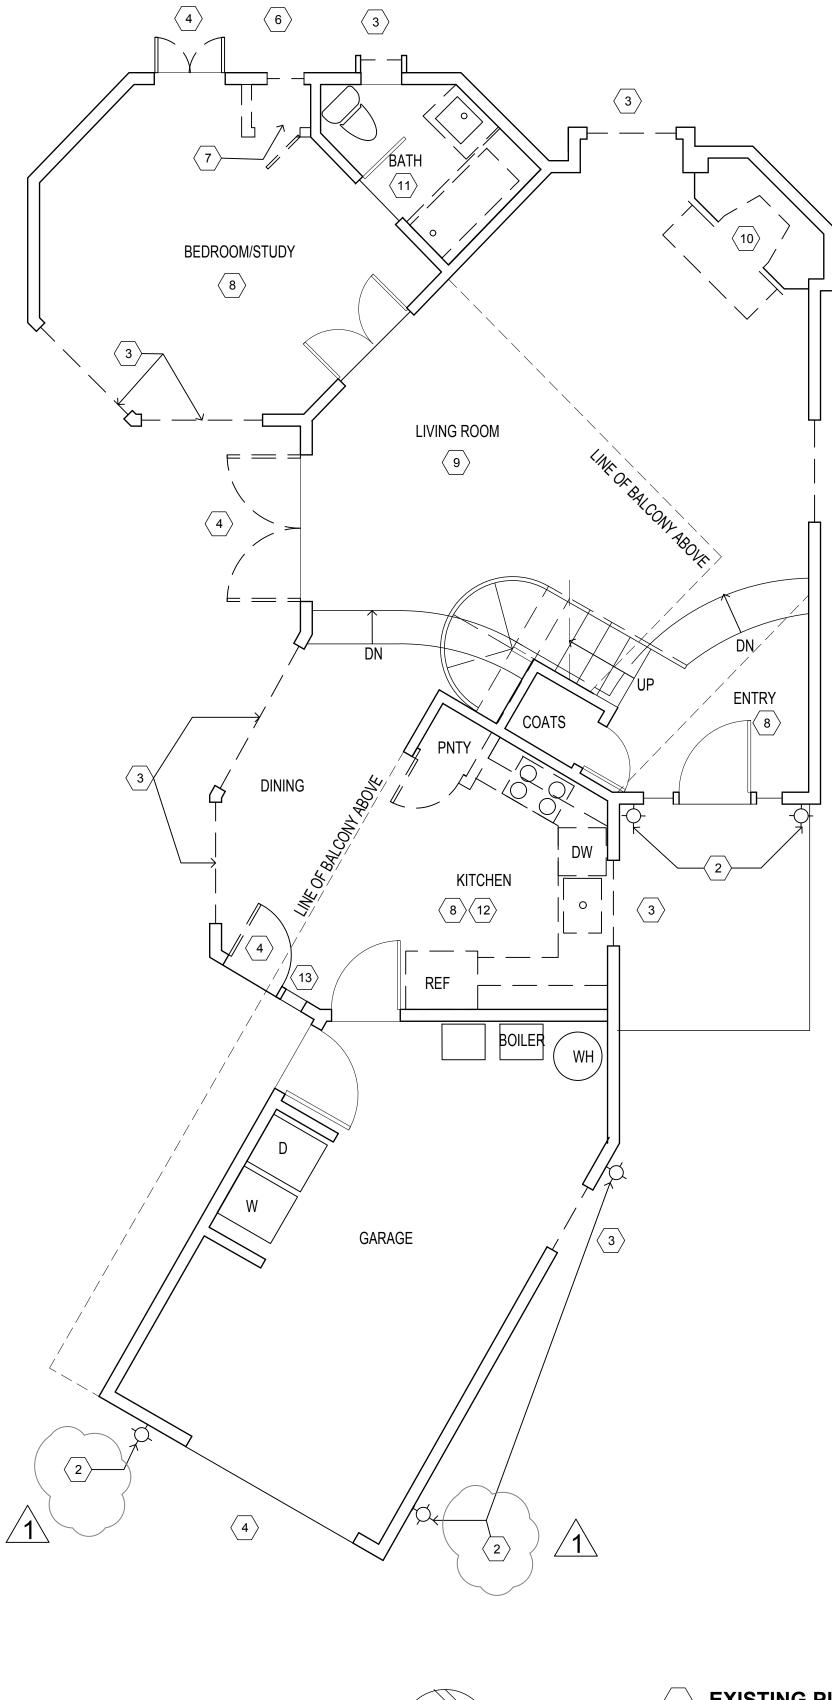
A2.0

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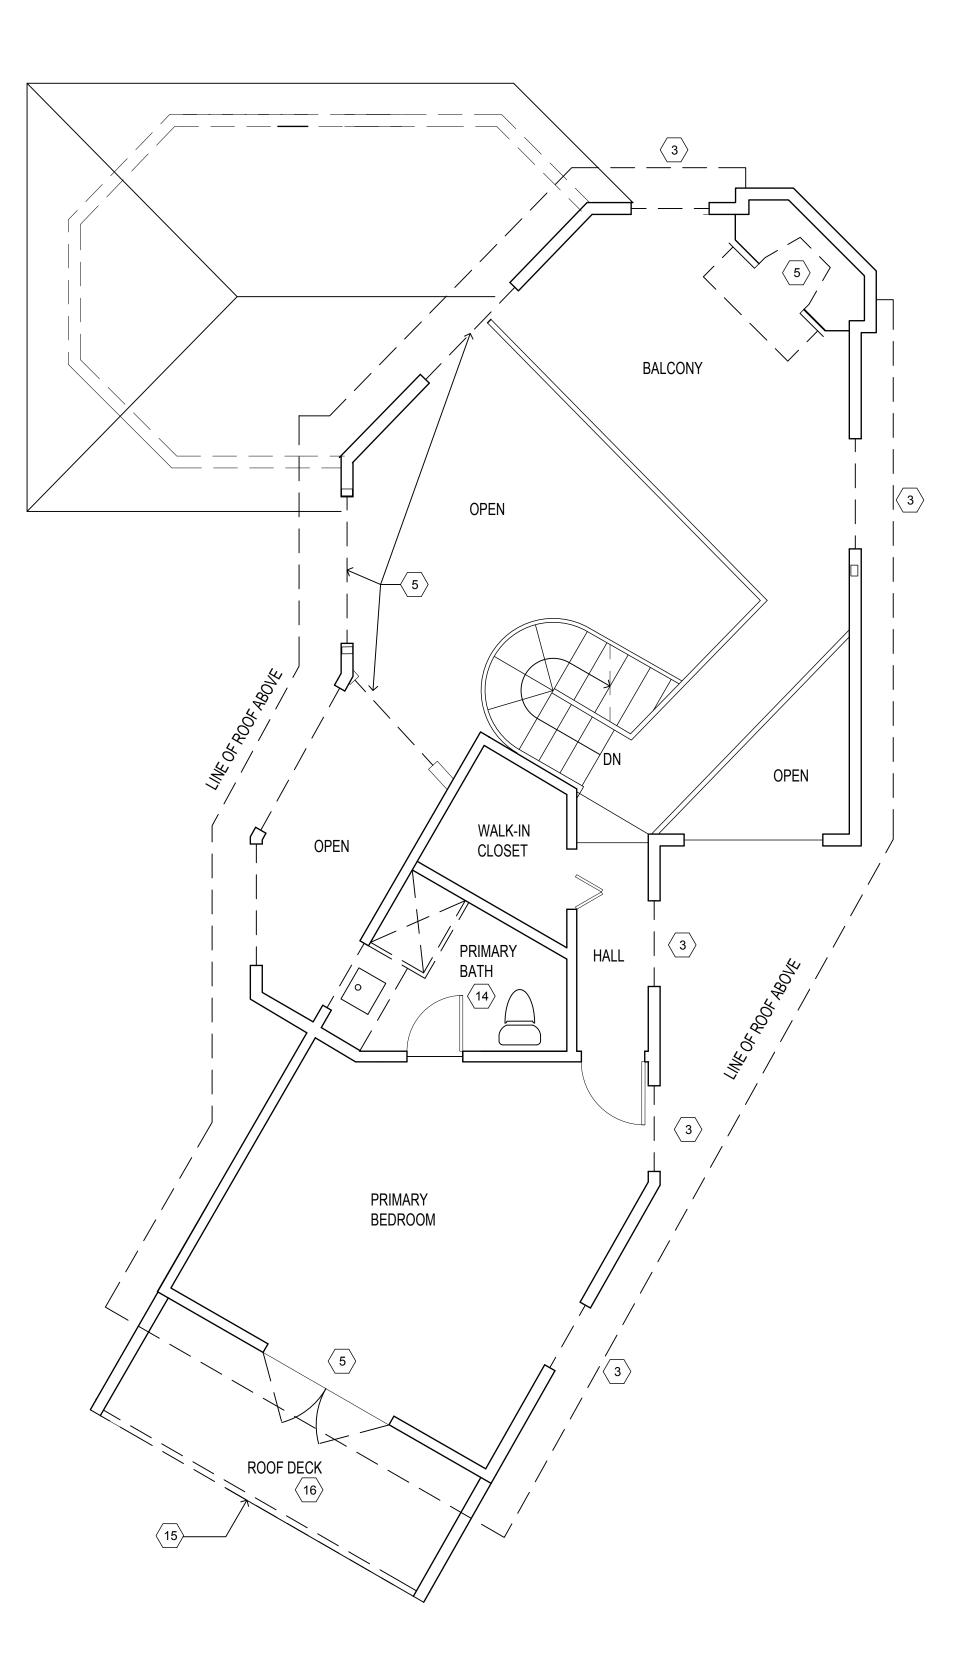
Permit <u>#:</u> DS 23-344 (Hipwell) Date Approved: <u>February 6, 2024</u> Planner: <u>A. Barton</u>

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\supset EXISTING PLAN DEMO NOTES

 $\langle 3 \rangle$

NOT USED

REPLACE (E) WALL LIGHT FIXTURE

WINDOW(S) TO BE REPLACED IN (E) OPENING

DOOR TO BE REPLACED IN (E) OPENING DOOR AND TRANSOM ABOVE TO BE REPLACED IN (E) OPENING

- WINDOW TO BE REMOVED, PATCH WALL FINISHES TO MATCH ADJ. FINISHES
- CLOSET WALLS AND DOOR TO BE REMOVED

REMOVE TILE FLOORING

- 9 REPLACE WOOD FLOORING10 REPLACE PREFAB GAS FIREF
- REPLACE PREFAB GAS FIREPLACE, HEARTH AND TILE SURROUND
 REMOVE BATHTUB, TILE SURROUND, VANITY AND FLOOR FINISHES
 REMOVE KITCHEN CABINETS, APPLIANCES, PANTRY AND FIXTURES FOR
- REPLACEMENT
- 13 REMOVE THRU-WALL PET DOOR OPENING, PATCH WALL FINISHES14 REMOVE TUB/SHOWER, VANITY, TOILET AND WOOD FLOORING
- 15 REMOVE WOOD GUARDRAIL AND CURB AT FRONT WALL16 REMOVE WATERPROOF DECK FINISH



LEGEND

- (E) WALLS TO REMAIN
- NEW 2 X STUD WALL

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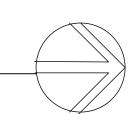
TRACK 1 DESIGN REVIEW

Title: EXISTING FLOOR/DEMO PLAN

Revisions:

 Scale: 1/4"=1'-0"
 Sheet No:

 Date: NOV. 7, 2023
 A3.0

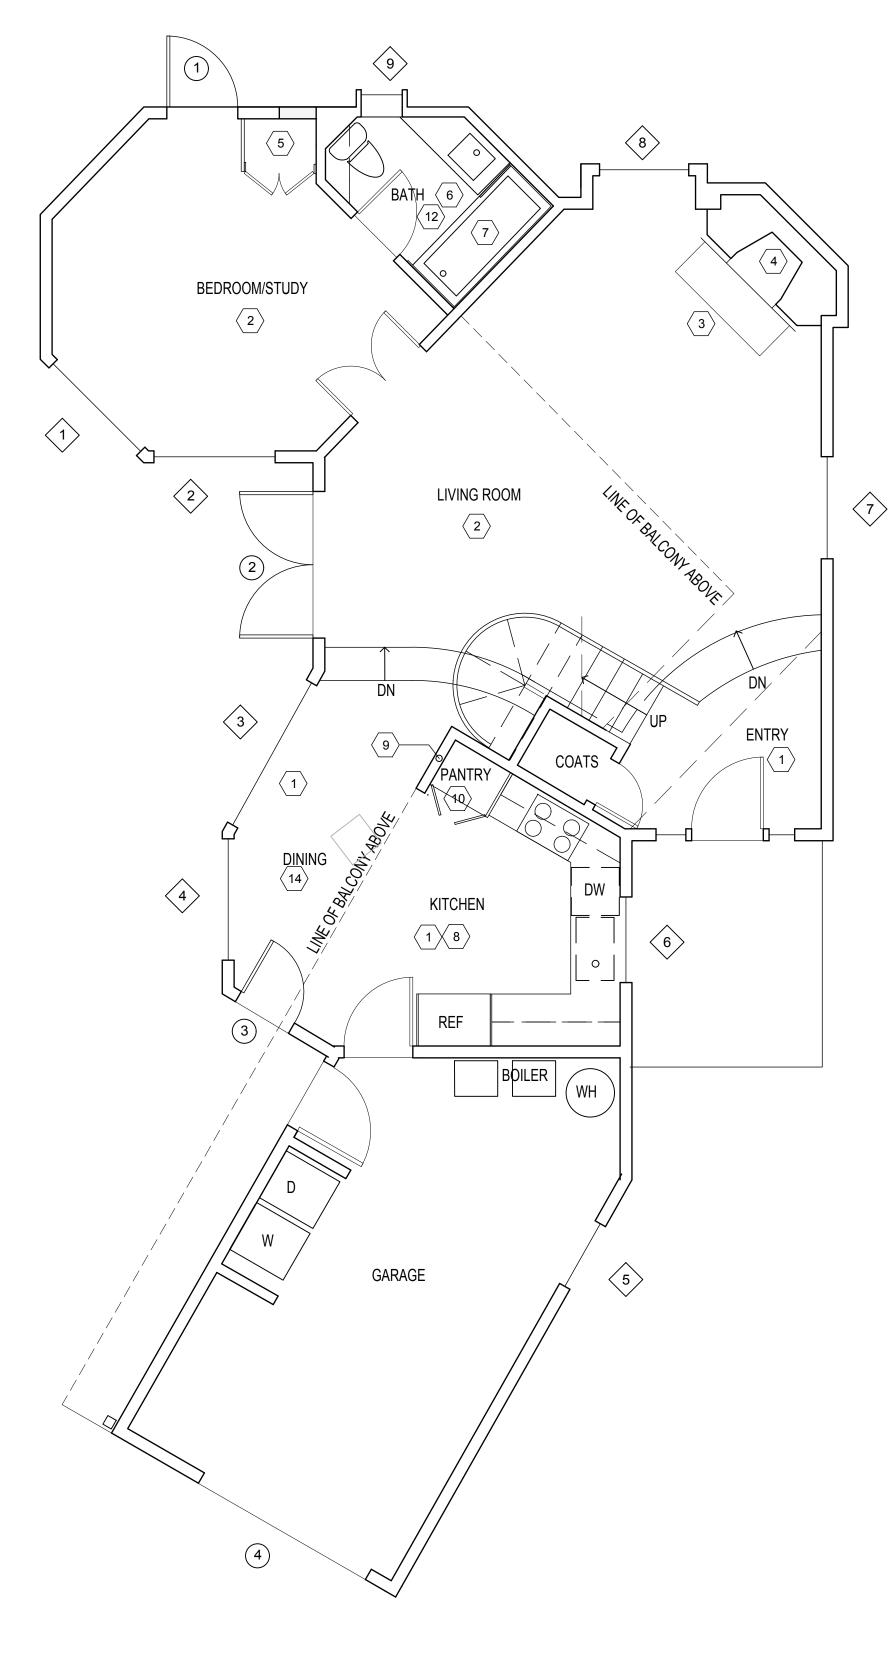


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Permit <u>#:</u> DS 23-344 (Hipwell) Date Approved: February 6, 2024 Planner: <u>A. Barton</u>

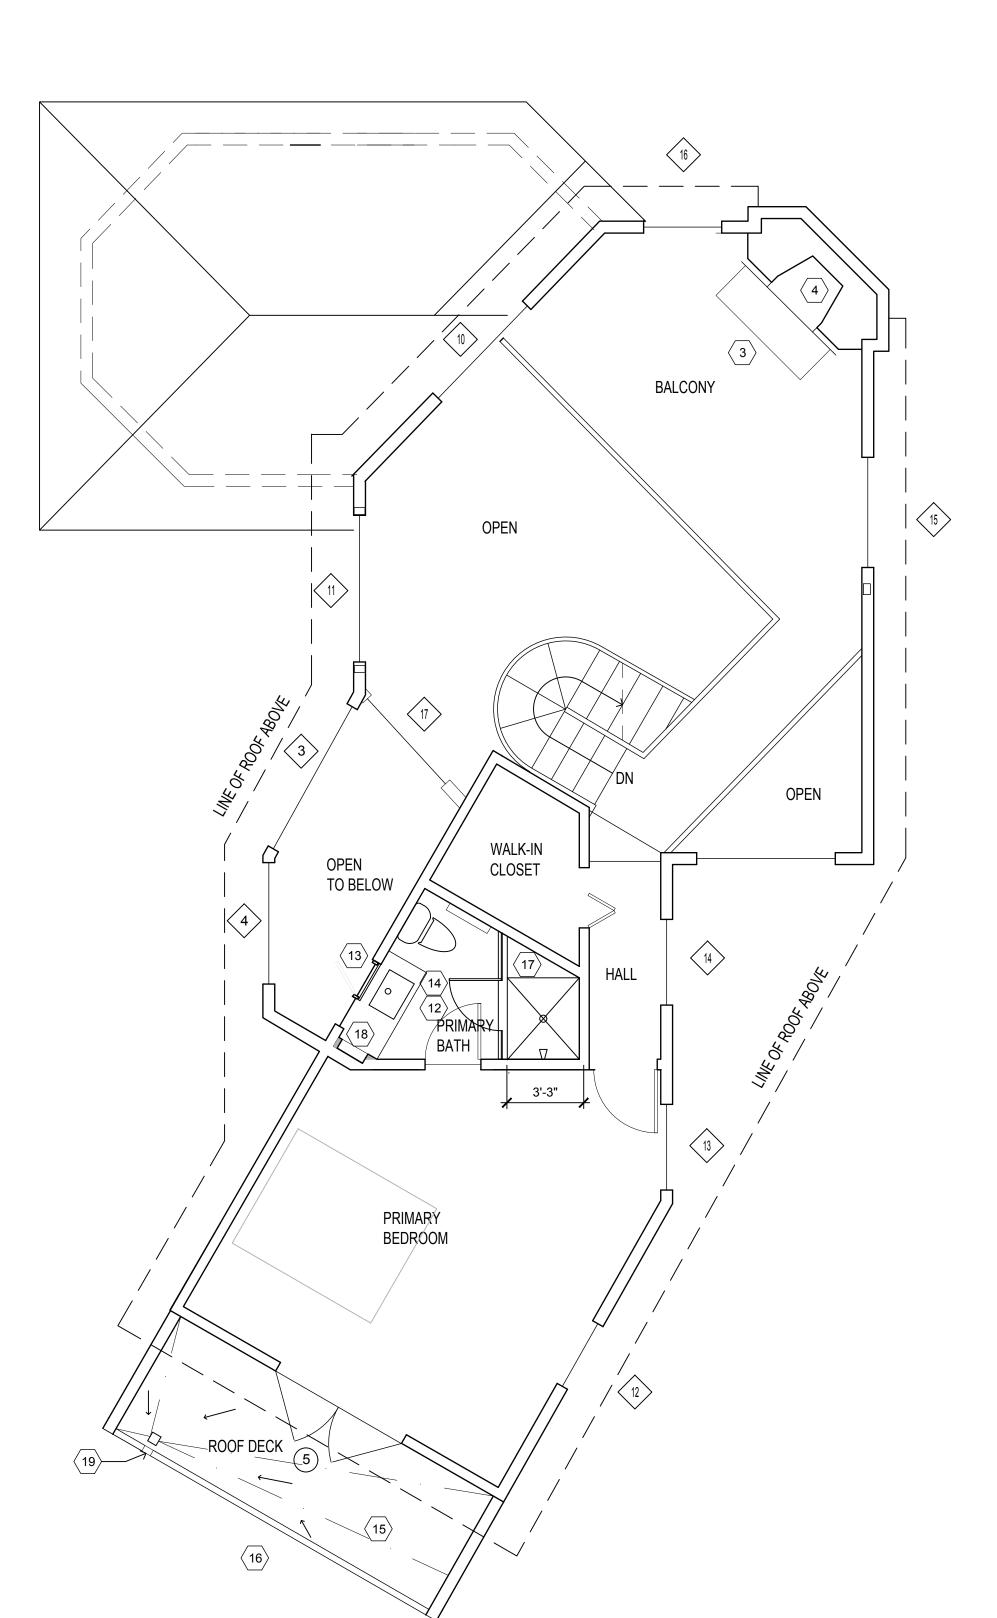
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NOTE: SEE SHEET A4 FOR WINDOW AND DOOR SCHEDULES AND TYPES. DOORS WITHOUT SYMBOLS WILL NOT BE REPLACED.



R PLAN

$\bigcirc\,$ FLOOR PLAN SHEET NOTES

1 NEW STONE TILE FLOORING

- 2 NEW WOOD FLOORING OVER (E) RADIANT HEATING3 NEW STONE HEARTH AND FIREPLACE SURROUND
- REPLACE (E) METAL GAS FIREPLACE WITH NEW IN (E) LOCATION
- NEW FULL HEIGHT CLOSET CABINET
- NEW BATHTUB, TILE SURROUND, VANITY AND FIXTURES IN (E) LOCATIONS NEW TEMP. GLASS ENCLOSURE, SEE INT. ELEVS.
- NEW KITCHEN CABINETS, APPLIANCES AND FIXTURES IN (E) LOCATIONS
 NEW WASTE LINE IN WALL
- NEW FULL HEIGHT PANTRY CABINET
 NEW DRAIN LINE FROM DECK ABOVE, TIE TO (E) SITE DRAINAGE
- NEW STONE/TILE FLOORING
 NEW MIRROR AT (E) WINDOW, CLEAR FIXED GLASS AT EACH SIDE
- TO FILL (E) OPENING
- NEW VANITY, FIXTURES, SHOWER WITH BENCH, AND TEMP. GLASS ENCLOSURE
 REPLACE (E) DECK SURFACE W/NEW WALKING SURFACE AND DRAINAGE. UTILIZ
- (E) SLOPE OF SUBSTRATE16 NEW WOOD GUARDRAIL AND END WALL CAP TRIM
- 17 FLOATING BENCH
- 18 (N) FURRED WALL & MEDICINE CABINET19 NEW SCUPPER OVERFLOW

1 UPPER FLOOR PLAN 1/4"=1'-0"

LEGEND (E) WALLS TO REMAIN NEW 2 X STUD WALL DEMOLISHED FEATURES

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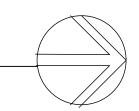
TRACK 1 DESIGN REVIEW

Title: PROPOSED FLOOR PLANS

Revisions:

 Scale: 1/4"=1'-0"
 Sheet No:

 Date: NOV. 7, 2023
 A3.1



DOOR SCHEDULE

MARK	DOOR			FRAME	FRAME			
	TYPE	SIZE		DETAILS	DETAILS			
		WIDTH	HEIGHT	HEAD	JAMB	THRESHOLD		
1	E	3'-0"	6'-8"				ALUM.	
2	С	6'-0"	6'-8"	4/A5.1	6/A5.1	5.A5.1	ALUM.	
3	В	2'-8"	6'-8"	4/A5.1	6/A5.1	5.A5.1	WD. &	
4	А	8'-0"	7'-0"				WOOD	
5	D	6'-0"	6'-8"				OUTSV	

1. ROUGH OPENING SIZES ESTIMATED. ALL DOORS ARE REPLACEMENTS TO (E) DOORS IN (E) OPENINGS. CONTRACTOR TO VERIFY ALL DIMENSIONS. 2. FRENCH DOORS BASED ON ULTIMATE WOOD ALUM. CLAD SERIES BY MARVIN, INC. 3. FENESTRATION MUST HAVE A MAXIMUM U-FACTOR 0.45

4. WHERE REQUIRED PROVIDE TEMPERED GLAZING. A PERMANENT LABEL PER CRC SEC. R308.1 SHALL IDENTIFY EACH LIGHT OF SAFETY GLAZING.

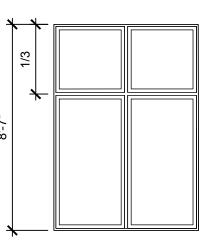
5. EVERY MANUFACTURED FENESTRATION PRODUCT SHALL HAVE TEMPORARY AND PERMANENT LABELING THAT CERTIFIES COMPLIANCE W/AIR LEAKAGE, U-FACTOR, SHGC AND VT PER CAEC SEC. 110.6(A)

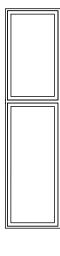
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FIXED PICTURE WINDOW

E

WINDOW SCHEDULE \bigcirc

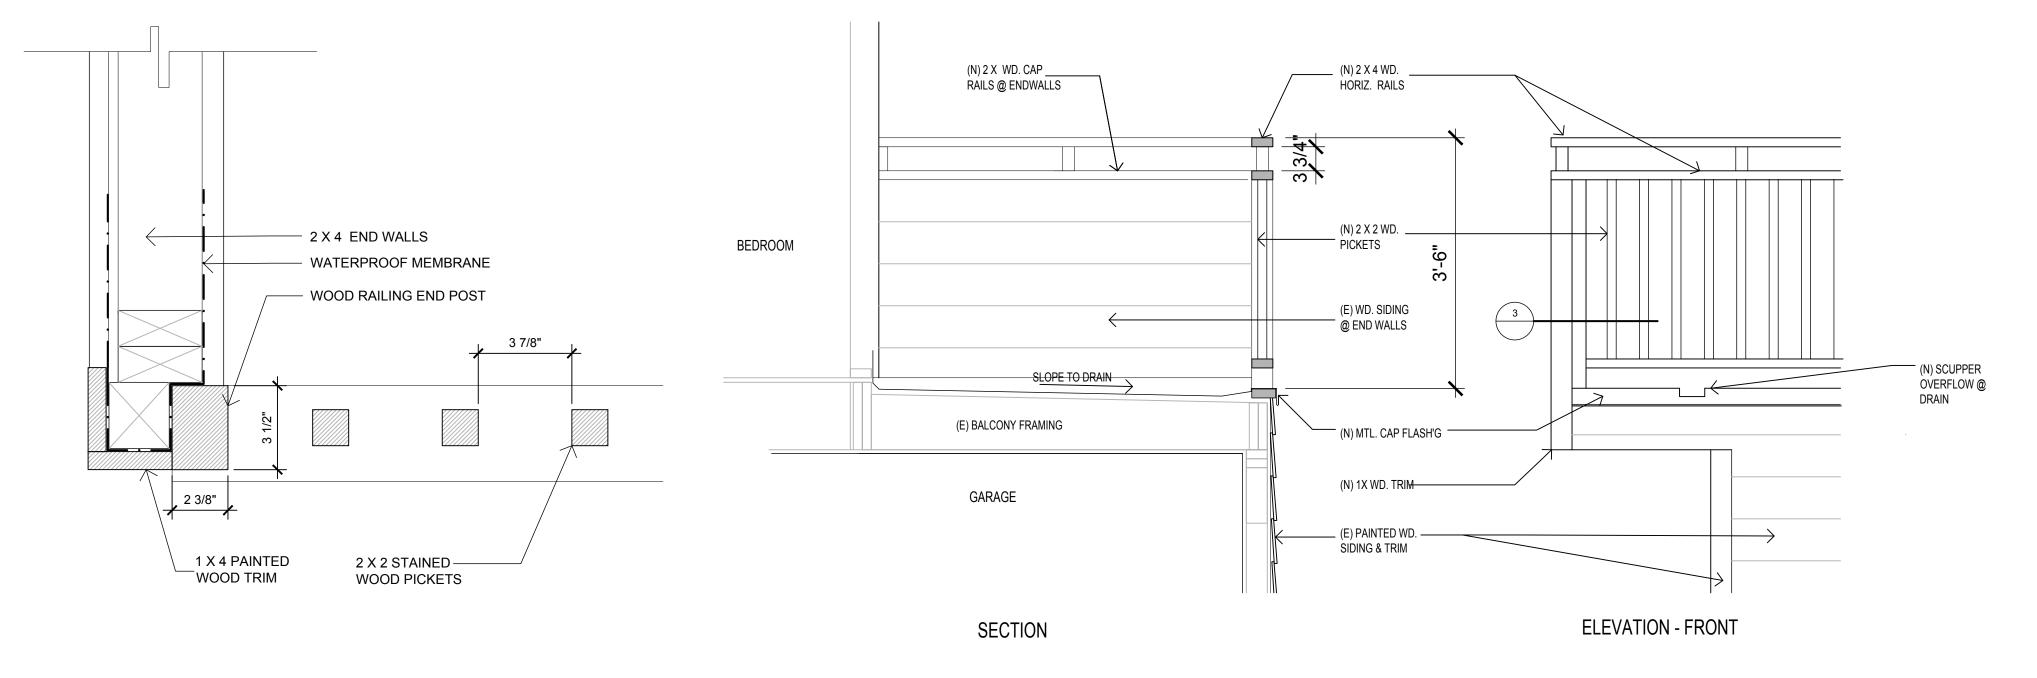
MARK	WINDOW		FRAME			REMARKS	NOTE	
	TYPE SIZE			DETAILS				
		WIDTH	HEIGHT	HEAD	JAMB	SILL		
1	I	5'-0"	4'-2"				3 EQ. LIGHTS, 2 CASEMENTS W/ CENTER PICTURE	
2	I	5'-0"	4'-2"				3 EQ. LIGHTS, 2 CASEMENTS W/CENTER PICTURE	
3	G	6'-9"	9'-1"				MULLED 6 PANEL UNIT W/1 CASEMENT	
4	Н	5'-0"	9'-1"				MULLED 4 PANEL UNIT W/1 CASEMENT	
5	М	3'-6"	3'-6"					
6	Ν	3'-6"	3'-6"					
7	L	3'-6"	4'-8"					
8	М	3'-6"	2'-8"					
9	0	1'-10"	2'-8"					
10	J						TRAPIZOID PICTURE WINDOW	
11	F	6'-0"	8'-7"				4 PANE PICTURE WINDOW	
12	М	3'-6"	3'-6"					
13	М	3'-6"	3'-6"					
14	М	3'-6"	3'-6"					
15	М	3'-6"			DOUBLE CASEMEMT W/TRANSOM			
16	F	3'-6"	2'-8"					
17	K						TRAPIZOID PICTURE WINDOW	

1. WINDOW ROUGH OPENING SIZES ESTIMATED. ALL WINDOWS ARE REPLACEMENTS IN (E) OPENINGS U.O.N. CONTRACTOR TO VERIFY ALL DIMENSIONS.

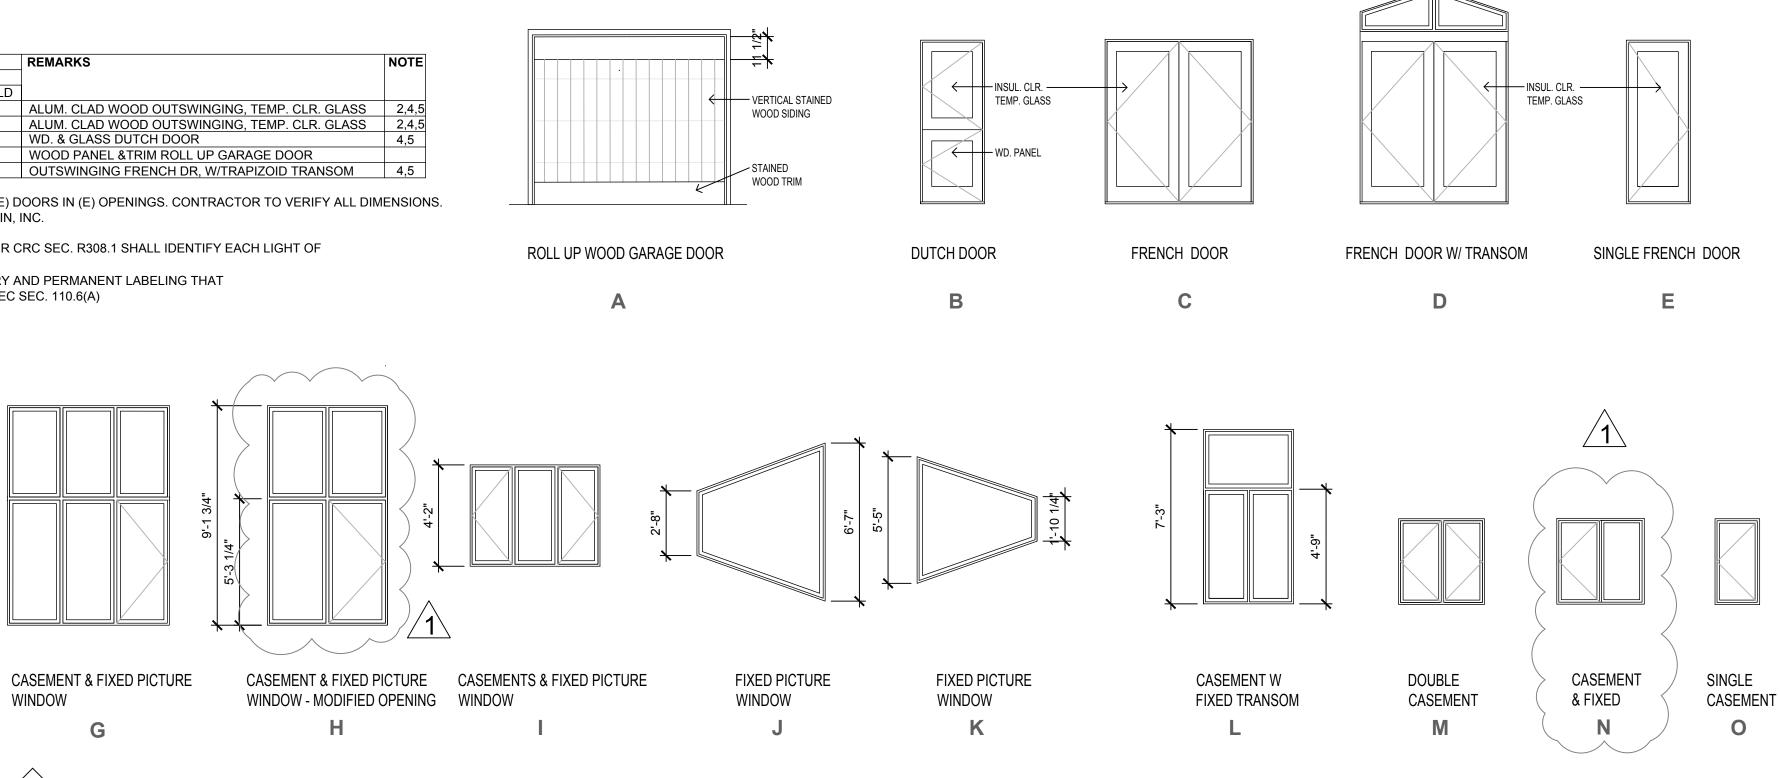
2. WINDOWS BASED ON ULTIMATE WOOD ALUM. CLAD CASEMENT AND PICTURE SERIES BY MARVIN, INC. 3. FENESTRATION PRODUCTS MUST HAVE A MAXIMUM U-FACTOR 0.45

4. WHERE REQUIRED PROVIDE TEMPERED GLAZING PER CRC SECTION R308.1.

5. EVERY MANUFACTURED FENESTRATION PRODUCT SHALL HAVE TEMPORARY AND PERMANENT LABELING THAT CERTIFIES COMPLIANCE W/AIR LEAKAGE, U-FACTOR, SHGC AND VT PER CAEC SEC. 110.6(A)



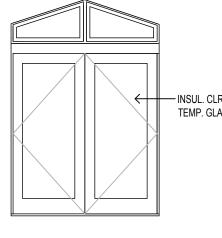


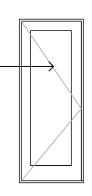


BALCONY CORNER DETAIL



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DOOR & WINDOW TYPES) 1/4"=1'-0"

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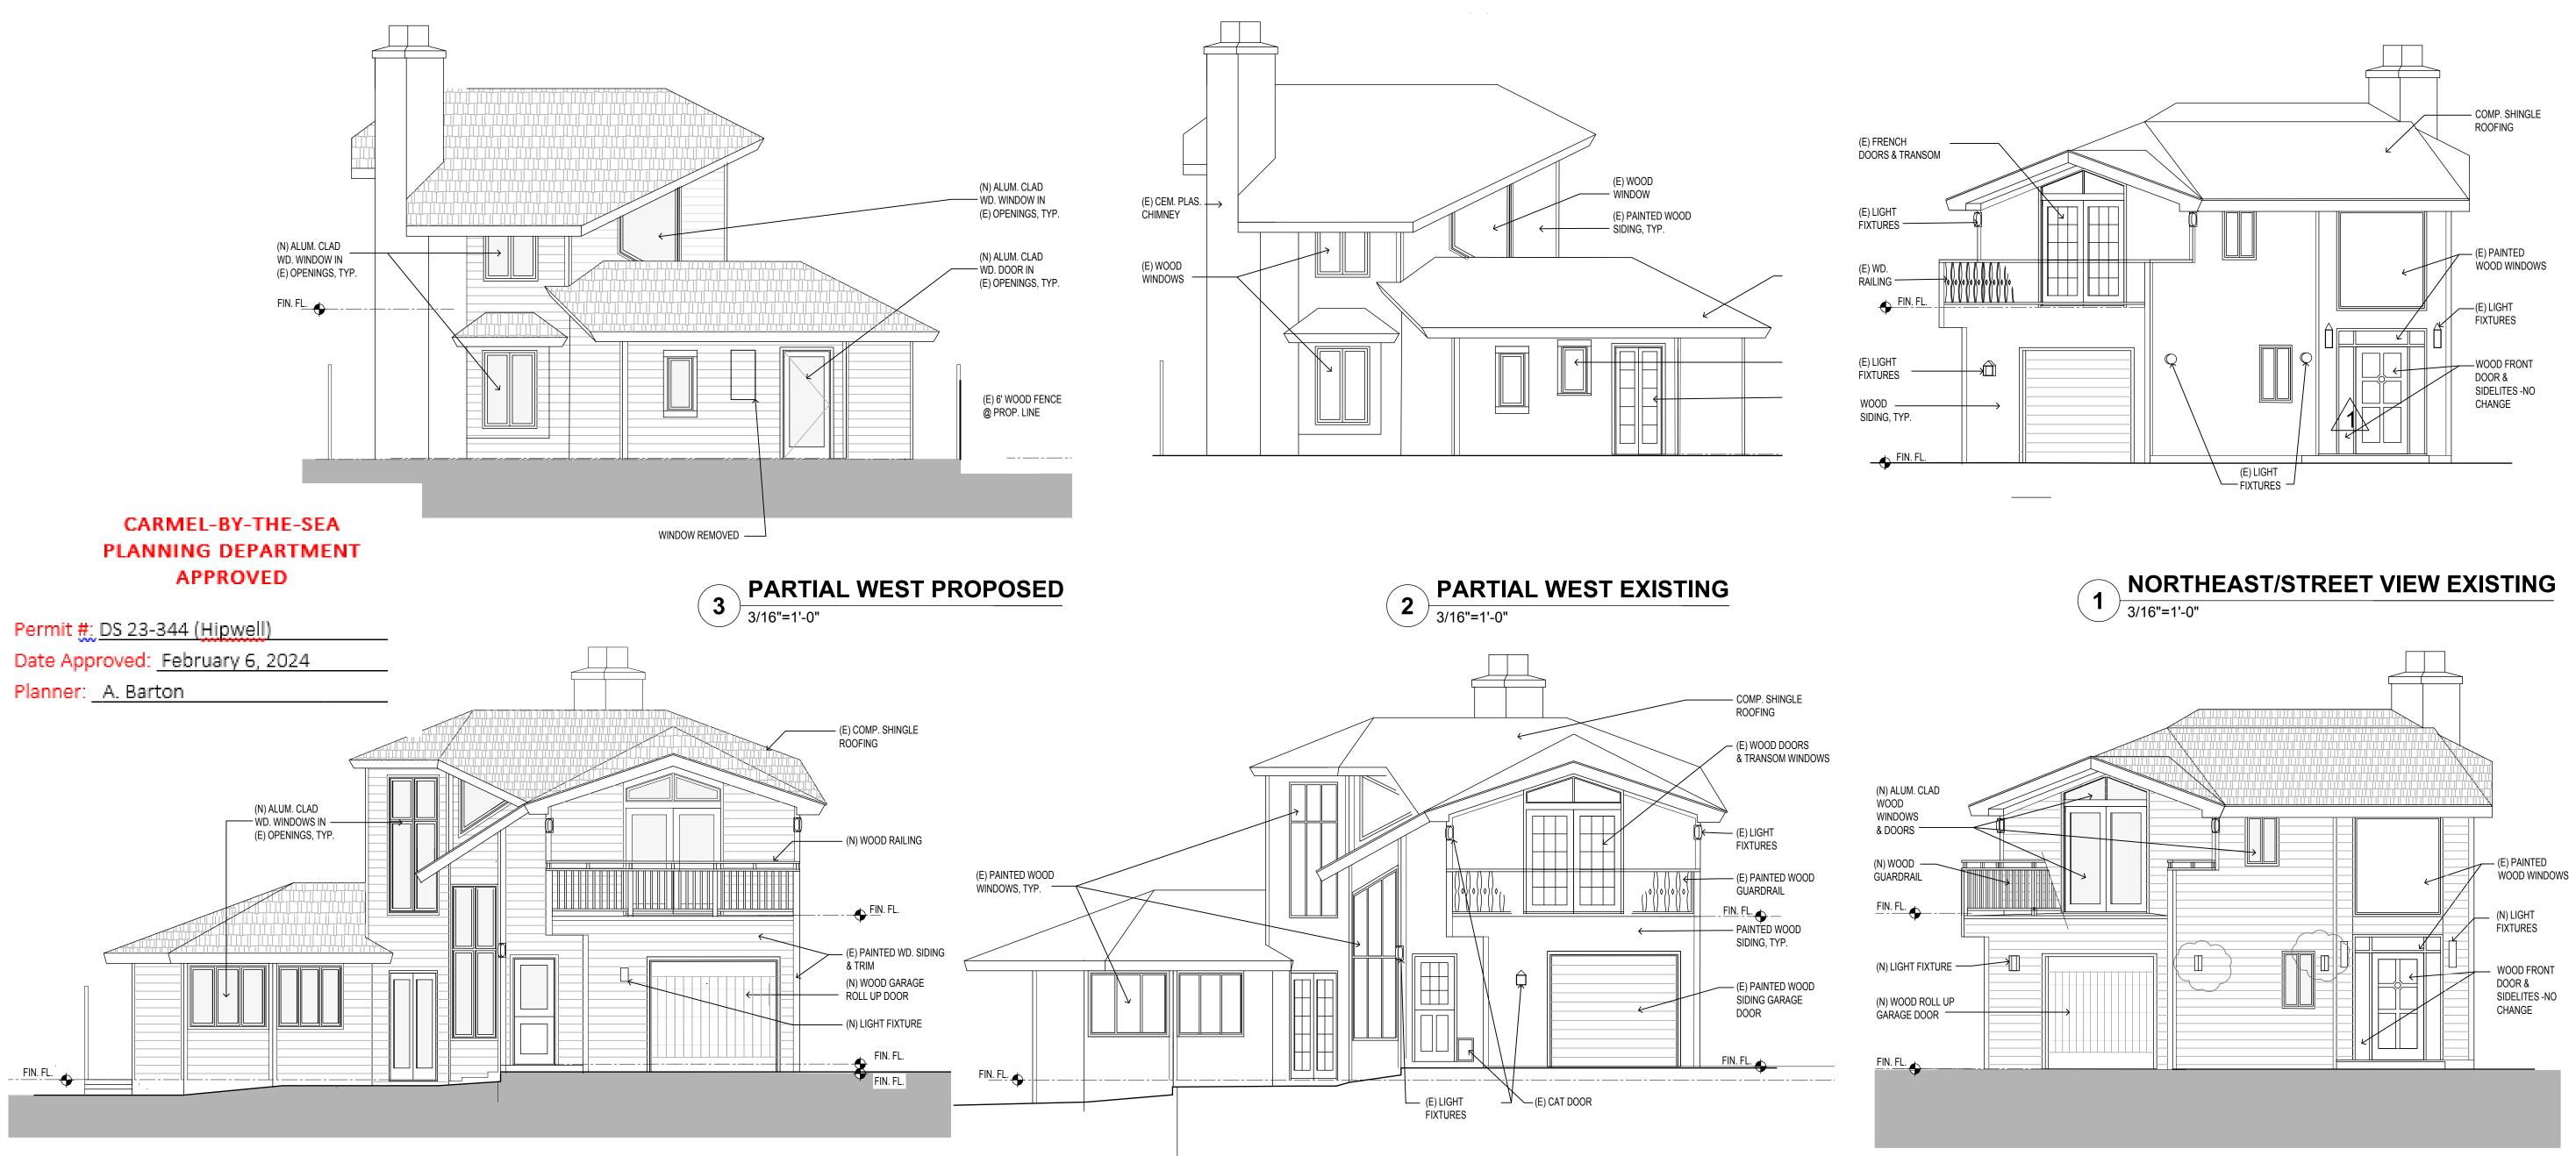
TRACK 1 DESIGN REVIEW

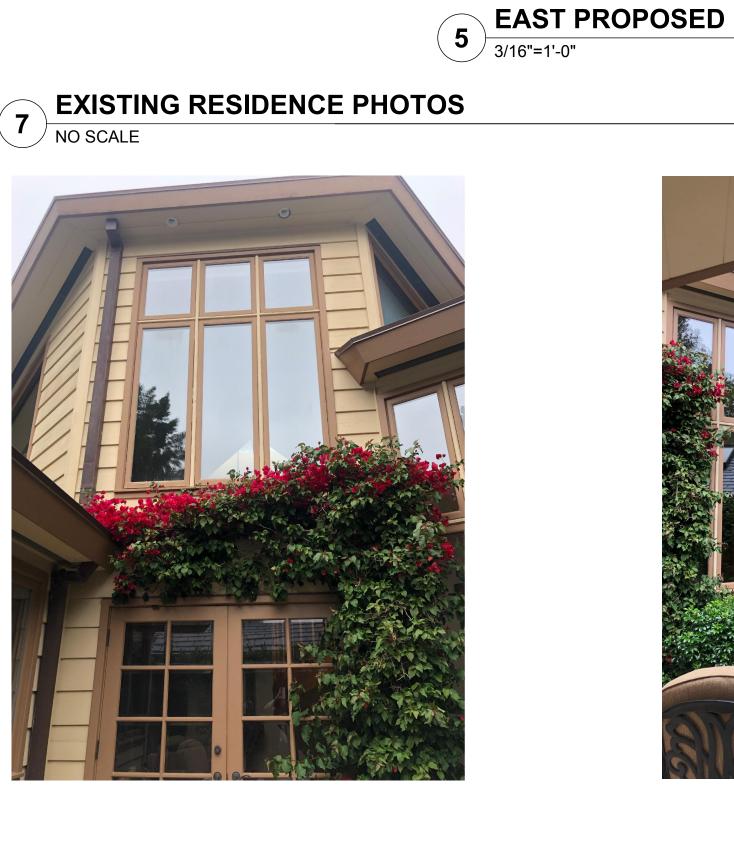
Title:

DOOR & WINDOW SCHEDULES BALCONY GUARDRAIL ELEV., **SECTION & DETAIL**

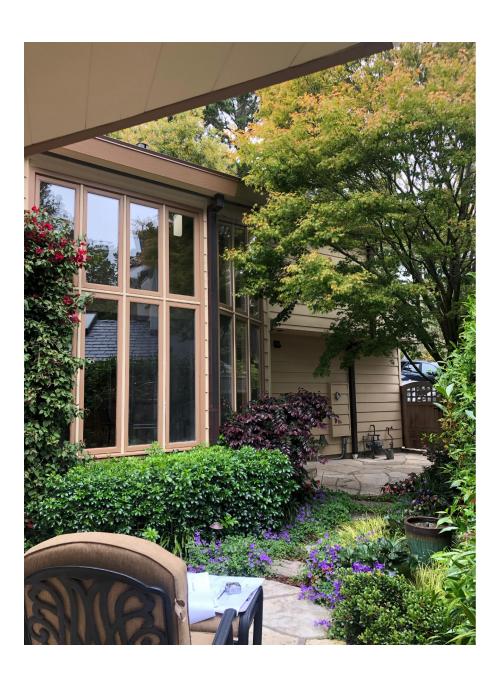
Revisions: ⚠ DSA REVISIONS 1.31.24

Sheet No: Scale: AS NOTED A4.0 Date: NOV. 7, 2023

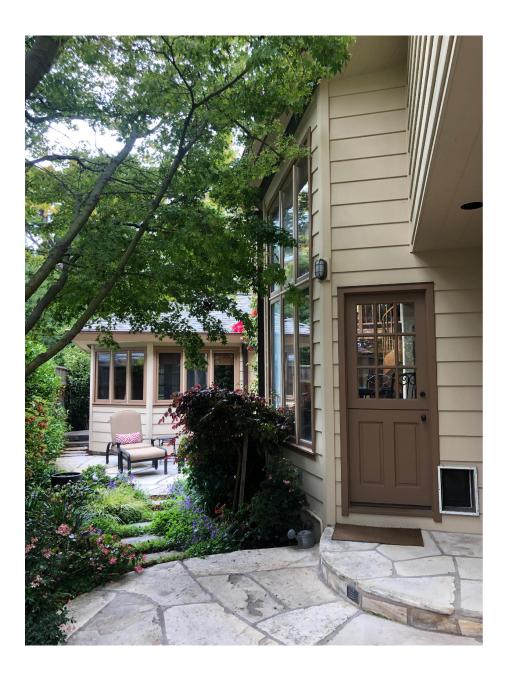




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TRACK 1 DESIGN REVIEW

Title: **EXISTING & PROPOSED** EXTERIOR ELEVATIONS **RESIDENCE PHOTOS**

Revisions: ⚠ DSA REVISIONS 1.31.24

Scale: 1/4"=1'-0"

Sheet No:

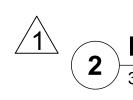
Date: NOV. 7, 2023

A5.0

6 NORTHEAST/STREET PROPOSED

	(E) SKYLIGHT
(E) COMP. SHINGLE ROOF (E) WOOD FASCIA	
(N) WOOD CAP RAILING— (E) PAINTED WOOD — SIDING FIN. FL. (N) LIGHT FIXTURES (N) ALUM. CLAD WOOD WINDOWS, TYP.	
FIN. FL.	

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4 SOUTH PROPOSED 3/16"=1'-0"

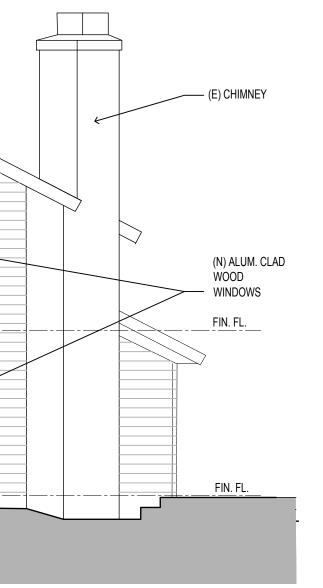
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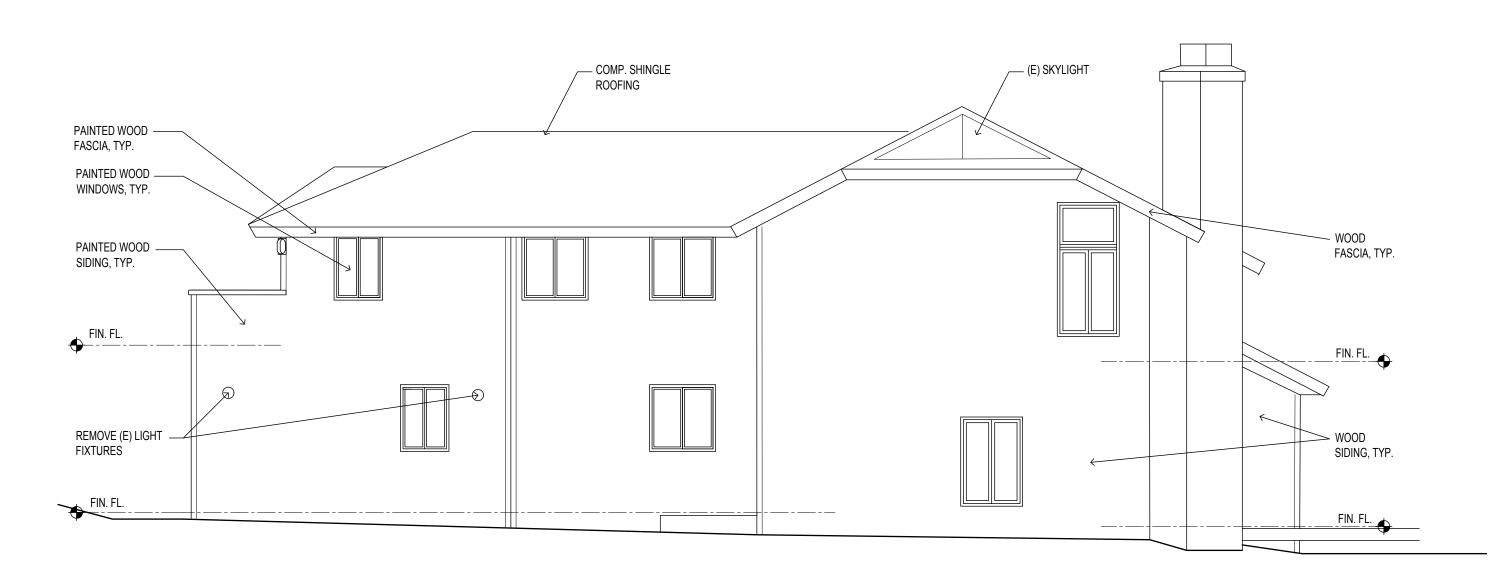
Permit #: DS 23-344 (Hipwell)

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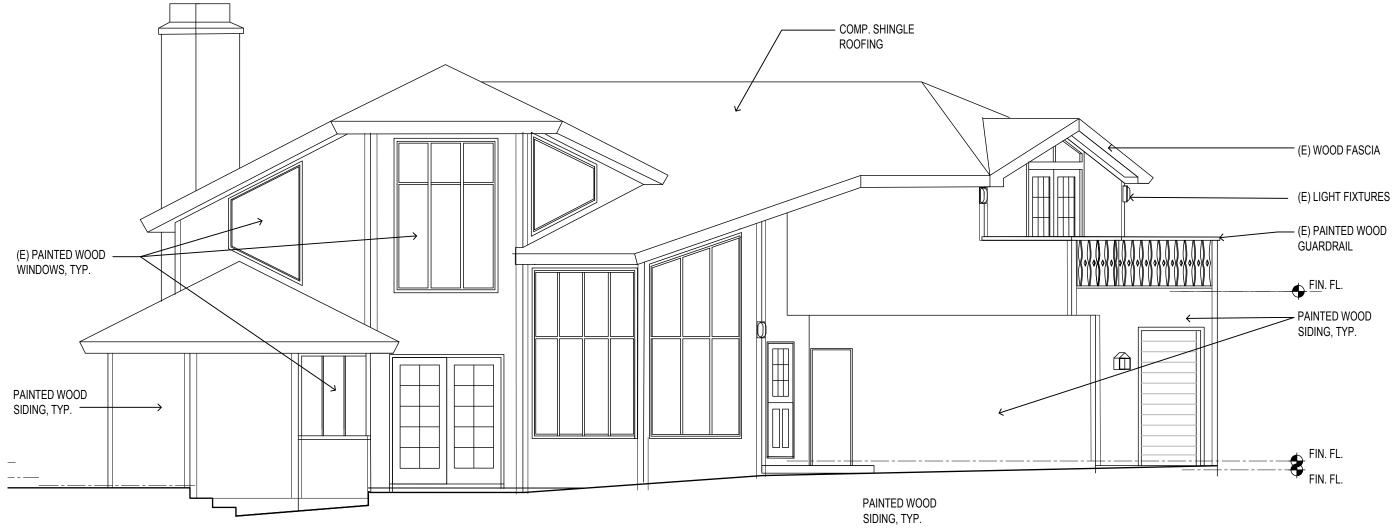
Date Approved: February 6, 2024 Planner: <u>A. Barton</u>

BENJAMIN MOORE "ABALONE" SIDING & BODY TRIM BENJAMIN MOORE __ "MIDSUMMER NIGHT" WINDOW & DOOR TRIM, FASCIA





2 NORTH PROPOSED 3/16"=1'-0"





WOOD STAIN







ALUM. CLAD COLOR

ALUM. CLAD WOOD WOOD WINDOWS

PAINT; SIDING & WINDOW TRIM/ FASCIA

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TRACK 1 DESIGN REVIEW



NORTH EXISTING

1

3/16"=1'-0"



EXISTING & PROPOSED EXTERIOR ELEVATIONS MATERIALS

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ALUM. CLAD WOOD FRENCH DOORS

5 MATERIALS

A5.1