
ASPHALT SHINGLE ROOF BY CERTAINTEED - PRESIDENTIAL TL SOLARIS IN 'AUTUMN BLEND'



BOARD & BATT WOOD SIDING - PAINTED TAUPE/GREEN COLOR



NATURAL STONE SIDING

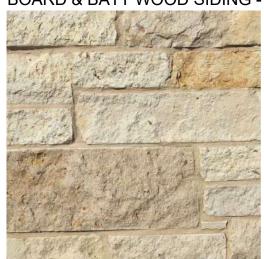

DRIVEWAY PAVERS BY CALSTONE -ANTIQUED COBBLE IN 'BROWN,



STAINED WOOD & GLASS GARAGE & ALUM. CLAD WINDOWS & DOORS - GRAY FINISH ENTRY DOOR



SIDE & REAR YARD FENCE - VERTICAL WOOD BOARDS, DARK **BROWN STAIN**

EXISTING SITE PHOTOS




FRONT OF (E) HOUSE LOOKING EAST



BACK OF (E) HOUSE & (P) AREA FOR A.D.U.

VICINITY MAP

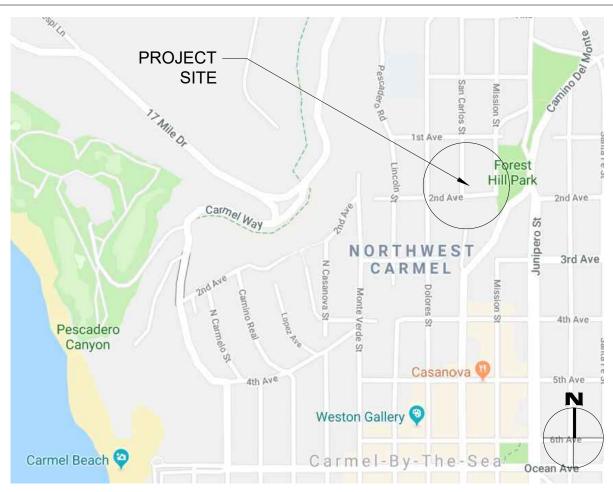

_		PARCEL MAP	
PROJECT — SITE	MISSION MISSION 11 MISSION 12 13 17 17 17 17 18 18 18 18 18 18	10 10 10 10 10 10 10 10 10 10	PROMINE OF THE TORS UNED FOR PROMINE P
	SAN CARLOS 10	17p129 9 19 0 0 10 10 10 10 10 10 10 10 10 10 10 10	57. (2) (3) (5) (7) (9) (2) (4) (6) (8) (20) (12
	DOLORES 1-12 5		\$7. \$ \(\frac{1}{2} \) \(\f
	9-12	22	CARMEL BY THE SEA BLOCKS 33, 34435

CARMEL BY THE SEA ADD'N 4 BLOCKS 9,10,11,28,29\$30

PROJECT DATA LOT SIZE 4,000 SF ALLOWABLE FLOOR AREA 1,800 SF (E) FLOOR AREA: 1,205 SF (E) HOUSE (E) LOWER LEVEL STORAGE 115 SF TOTAL 1,320 SF

(P) FLOOR AREA: (P) GARAGE 200 SF 1,283 SF (P) HOUSE (P) LOWER LEVEL OFFICE 178 SF SUB-TOTAL 1,661 SF

> 394 SF (P) A.D.U. TÓTAL 2,055 SF

ALLOWABLE LOT COVERAGE 396 SF (556 SF WITH BONUS)

582 SF (78.1% PERMEABLE) (E) LOT COVERAGE 395 SF (51.2% PERMEABLE) (P) LOT COVERAGE *SEE SITE PLANS FOR MORE INFORMATION ON LOT COVERAGE

(E) HOUSE SETBACKS: (E) FRONT YARD 13'-0" 23'-4" (E) REAR YARD 6'-10" (E) NORTH SIDE YARD (E) SOUTH SIDE YARD 8'-6" (P) HOUSE SETBACKS: 15'-0"

(P) FRONT YARD 3'-7" (P) REAR YARD 6'-10" (P) NORTH SIDE YARD 4'-2" (P) SOUTH SIDE YARD

(P) GARAGE SETBACKS: 0'-6" (P) FRONT YARD 79'-6" (P) REAR YARD 3'-0" (P) NORTH SIDE YARD 27'-0" (P) SOUTH SIDE YARD

(E) HEIGHT:

15'-6¹" (E) MAX. PLATE HT. 16'-7["] (E) MAX RIDGE HT.

(P) HEIGHT:

(P) MAX. PLATE HT. @ 1 STORY PORTION 14'-0" (E) CONDITION (P) MAX PLATE HT. @ 2 STORY PORTION $17'-1\frac{1}{2}"$ (P) MAX RIDGE HT. @ 1 STORY PORTION $15'-3\frac{3}{4}"$ (P) MAX RIDGE HT. @ 2 STORY PORTION 22'-11"

WATER SOURCE CAL AM

WASTE DISPOSAL SYSTEM SEWER - C.A.W.D.

TREES TO BE REMOVED (1) 8" PITTOSPORUM

(1) 8" ACACIA

TREES TO BE PLANTED (3) MONTEREY PINE TREES

GRADING ESTIMATES (P) CUT = 29.1 CU.YDS.(P) FILL = 6.5 CU.YDS. (P) NET CUT = 22.6 CU.YDS.

(E) PARKING 1 SPACE (UNCOVERED) 1 SPACE (COVERED) (P) PARKING

(E) BUILDING SPRINKLERED NO

(P) BUILDING SPRINKLERED YES (SEE CALC'S BELOW)

EXISTING STRUCTURE ALTERATION CALCULATIONS

EXISTING WALLS = 644.25 LINEAR FEET NEW WALLS = 612.25 LINEAR FEET WALLS TO REMOVE = 328.0 LINEAR FEET

(612.25' + 328.0') / 644.25' = 188% CHANGE = FIRE SPRINKLERS REQUIRED

PROJECT TEAM

OWNER **NINA HARRISON** SAN CARLOS, 2 N.E. OF 2ND AVE.

CARMEL-BY-THE-SEA, CA 93923

ARCHITECT SAMUEL PITNICK ARCHITECTS, INC.

LICENSE # C-34362 PO BOX 22412, CARMEL, CA 93922 PHONE: (831) 241-1895 SAMUELPITNICK@GMAIL.COM

SURVEYOR RASMUSSEN LAND SURVEYING, INC. 2150 GARDEN ROAD, SUITE A-3 MONTEREY, CA 93942

PHONE: (831) 375-7240

ARCHAEOLOGIST ACHASTA ARCHAEOLOGICAL SERVICES 3059 BOSTICK AVE., MARINA, CA 93955 PHONE: (831) 262-2300

PROJECT INFORMATION

SAN CARLOS, 2 N.E. OF 2ND AVE. PROPERTY ADDRESS CARMEL-BY-THE-SEA, CA 93923

BLOCK: 11 LOT: 18

APN 010-121-005

YEAR BUILT

A4.0

ZONING R-1-AS

(SINGLE FAMILY RESIDENTIAL -ARCHAEOLOGICAL SIGNIFICANCE)

TYPE OF CONSTRUCTION TYPE V-B

OCCUPANCY GROUP R-3 / SINGLE FAMILY RESIDENCE

U / GARAGE

1951 (REMODELED 2019)

SHEET INDEX

G1.0	PROJECT INFORMATION
G1.1	STREET VIEWS & RENDERING
G1.2	CITY FORESTER TREE SURVEY
G1.3	SURVEY
A1.0	EXISTING SITE PLAN
A1.1	PROPOSED SITE PLAN
A1.2	GŘAĎINĞ, ČOŇSŤRŮCŤIOŇ MAŇAĞEMEŇT PLÁN)
A1.3	SITÉ LIGHTHNG & DETAILS
A2.0	EXISTING FLOOR PLANS
A2.1	EXISTING ROOF PLAN
A2.2	DEMOLITION FLOOR PLANS
A2.3	DEMOLITION ROOF PLAN
A2.4	PROPOSED FLOOR PLANS
A2.5	PROPOSED ROOF PLAN
A3.0	BUILDING ELEVATIONS
A3.1	BUILDING ELEVATIONS
A3.2	BUILDING ELEVATIONS
A3.3	BUILDING ELEVATIONS

SCOPE OF WORK

DOOR & WINDOW SCHEDULES

REMODEL & ADDITION TO AN (E) 1,320 SF SINGLE FAMILY HOUSE. ADD 78 SF TO (E) MAIN FLOOR OF HOUSE. ADD 63 SF TO (E) LOWER LEVEL STORAGE ROOM & CHANGE TO NEW HOME OFFICE. CONSTRUCT NEW DETACHED 200 SF ONE CAR GARAGE. CONSTRUCT NEW 394 SF A.D.U., ATTACHED TO REAR OF (E) HOUSE. INSTALL NEW BOARD & BATTEN WOOD SIDING, STONE SIDING, NEW ALUMINUM CLAD WINDOWS & DOORS, NEW ASPHALT SHINGLE ROOF. REPLACE (E) WOOD DECK WITH NEW. INSTALL NEW GRAPE STAKE & VERTICAL WOOD FENCING, NEW FLAGSTONE WALKWAY & PATIOS, NEW LANDSCAPING.

BUILDING CODE INFO

THIS PROJECT SHALL COMPLY WITH THE FOLLOWING:


2022 CALIFORNIA BUILDING CODE 2022 CALIFORNIA RESIDENTIAL CODE 2022 CALIFORNIA MECHANICAL CODE

2022 CALIFORNIA PLUMBING CODE 2022 CALIFORNIA ELECTRICAL CODE

2022 CALIFORNIA ENERGY CODE 2022 CALIFORNIA FIRE CODE

2022 CALIFORNIA GREEN BUILDING STANDARDS CODE

HARRISON RESIDENCE REMODEL SAN CARLOS, 2 N.E. OF 2ND AVENUE CARMEL, CA 93923

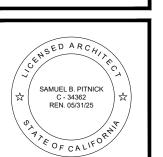

N P E

REVISIONS DATE △ PLANNING 1/11/24 NEVISION

ARCHITECTURAL

PROJECT **INFORMATION**

Scale: SEE DWG. Drawn By: SBP Job: -

G1.0

01/11/2024



RENDERING OF FRONT ELEVATION
SCALE: N.T.S.

HARRISON RESIDENCE REMODEL SAN CARLOS, 2 N.E. OF 2ND AVENUE CARMEL, CA 93923



SAMUEL PITNICK ARCHITEC P.O. BOX 22412, CARMEL, CA 93922 PHONE: (831) 241-1895 EMAIL: SAMUELPITNICK@GMAIL.COM

REVISIONS DATE

PLANNING 1/11/24

ARCHITECTURAL

STREET VIEWS & RENDERING


Scale: SEE DWG.

Drawn By: SBP

Job: -

G1.1

01/11/2024

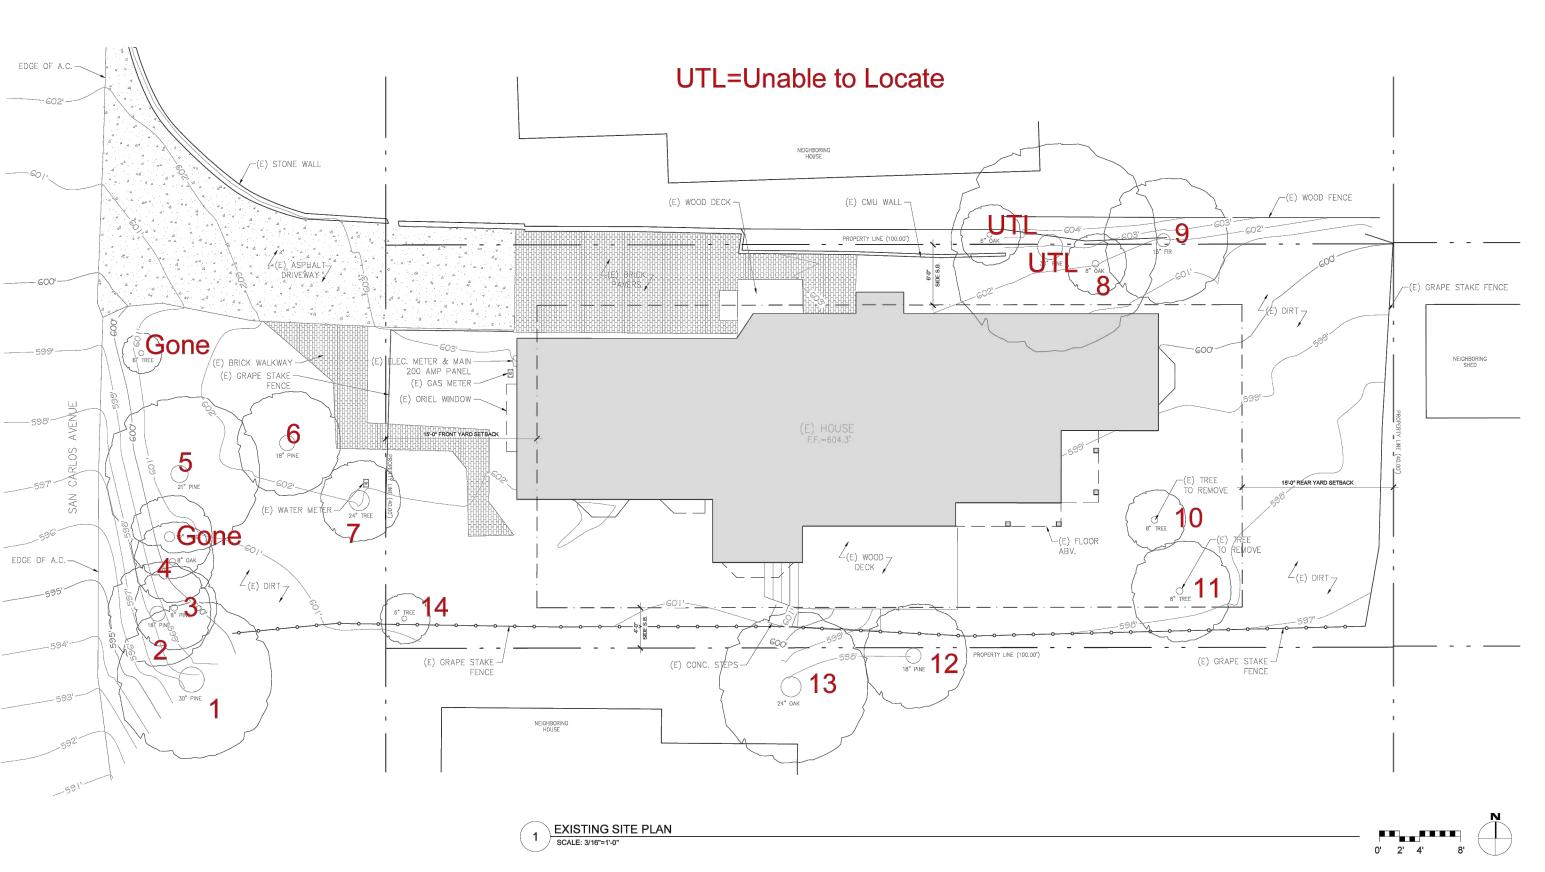

G. <u>Are</u>	envir	<u>onme</u>	<u>ntal d</u>	<u>condit</u>	<u>ions fa</u>	<u>avoral</u>	<u>ole to</u>	the tr	<u>:ee?</u>						
Tree #	1	2	3	4	5	6	7	8	9	10	11	12	13	14	15
score	1	1	1	1	1	1	2	1	2	2	2	1	2	2	

O points: The tree is crowded or has no room for growth to maturity. The tree has poor access to light, air or has poor soil for the species.

The tree has average environmental conditions including room for growth to maturity, access to light, air and soils suitable for the species.

The tree has room for growth to maturity with no crowding from other significant trees or **2 points**: existing buildings nearby. The tree also has excellent access to light, air and excellent soils for root development.

Part Three: Final Assessment

Record the total points scored on D - G for each tree.

Tree # 1 2 3 4 5 6 7 8 9 10 11 12 13 14 15

Total 5 3 5 7 6 6 9 7 8 9 9 9 9 9 9 9 9

A. <u>Did</u>	all ass	sessm	ent c	atego	ries in	Part ⁻	Two a	chieve	e a mi	nimur	n scoi	e of 1	-poin	<u>t</u> ?	
Tree #	1	2	3	4	5	6	7	8	9	10	11	12	13	14	15
YES	Х		Х	Х	Х	Х	Х	Х	Х	Х	Х		Х	Х	
NO		v										v			

B. Are there any other factors that would disqualify a tree from a determination of significance? (Explain any 'yes' answer)

Yes

Conclusion: Does The Tree Qualify As Significant Or Moderately Significant?

If the tree meets the species, size and safety criteria identified in Part One and scores at least one point under each of the criteria in Part Two, it shall be classified as Significant if it achieves a score of **6 or more points** or shall be classified as Moderately Significant if it achieves a score of **4 or 5 points**. Tree species not listed in Part One-B that meet other screening criteria in Part One may be classified by the City Forester as Significant if they score **at least 7 points**, or as Moderately Significant if they score **at least 4 points**. All other trees are classified as non-significant.

Tree #	1	2	3	4	5	6	7	8	9	10	11	12	13	14	15
SIGNIF				Х	Х	Х	Х	Х	Х	Х	Х		Х	Х	
MOD SIGNIF	х		х												
NOT SIGNIF		х										х			

Items to note:

Require	d Stru	ctural	Root	Zone											
Tree #	1	2	3	4	5	6	7	8	9	10	11	12	13	14	15
Feet	6	6	6	6	6	6	6	6	6	6	6	6	6	6	

Required Tree Protection Zone

Nequire	unee	FIOLE	CLIOII	ZOIIE											
Tree #	1	2	3	4	5	6	7	8	9	10	11	12	13	14	15
YES	12	10	6	6	10	12	10	6	10	6	8	8	10	6	

Requirements for tree preservation shall adhere to the following tree protection measures on construction site.

· Prior to grading, excavation, or construction, the developer shall clearly tag or mark all trees to be preserved.

Excavation within 6 feet of a tree trunk is not permitted.

No attachments or wires of any kind, other than those of a protective nature shall be attached to any tree.

• Per Municipal Code Chapter 17.48.110 no material may be stored within the dripline of a protected tree to include the drip lines of trees on neighboring parcels.

Tree Protection Zone -- The Tree Protection Zone shall be equal to dripline or 18 inches radially from the tree for every one inch of trunk diameter at 4.5 feet above the soil line, whichever is greater. Minimum of 4 foot high transparent fencing is required unless otherwise approved by the City Forester. Tree protection shall not be resized, modified, removed, or altered in any manner without written approval. The fencing must be maintained upright and taught for the duration of the project. No more than 4 inches of wood mulch shall installed be within the Tree Protection Zone. When the Tree Protection Zone is at or within the drip line, no less than 6 inches of wood mulch shall be installed 18 inches radially from the tree for every one inch of trunk diameter at 4.5 feet above the soil line outside of fencing.

The Structural Root Zone -- Structural Root Zone shall by 6 feet from the trunk or 6 inches radially from the tree for every one inch of trunk diameter at 4.5' above the soil line, whichever is greater. Any excavation or changes to the grade shall be approved by the City Forester prior to work. Excavation within the Structural Root Zone shall be performed with pneumatic excavator, hydrovac at low pressure, or other method that does not sever roots.

If roots greater than 2 inches in diameter or larger are encountered within the approved Structural Root Zone the City Forester shall be contacted for approval to make any root cuts or alterations to structures to prevent roots from being damaged.

If roots larger than 2 inches in diameter are cut without prior City Forester approval or any significant tree is endangered as a result of construction activity, the building permit will be suspended and all work stopped until an investigation by the City Forester has been completed and mitigation measures have been put in place.

Significant Tree Evaluation Worksheet

APN: 010-121-005-000
Street Location: San Carlos 2 NE 2nd
Planner: Kort

City Forester: Ono Property Owner: Harrison

Recommended Tree Density: 3 upper, 1 lower

Part One: Initial Screening:

Complete Part One to determine if further assessment is warranted. Trees must pass all criteria

in Part One to be considered significant or moderately significant.

A. Does the tree pose an above-normal potential risk to life and property?

A. <u>DUCS</u>	the ti	ee po	se an	above	1101111	ai pote	- III lai	13K tU	ille ai	iu pro	Derty:				
Tree #	1	2	3	4	5	6	7	8	9	10	11	12	13	14	15
YES															
NO	v	v	V	v	v	v	v	V	V	V	v	v	v	v	

Any tree with structural impairment likely to cause failure should be marked as unsafe and removed. Use page five of this worksheet to document the safety risk. Trees that have limited and specific defects that can be remedied with selective pruning or other mitigation should be marked as safe and specific recommendations should be given to the owner for tree care. Such trees may still be assessed for significance.

MP-Monterey pine MC- Monterey cypress BP-Bishop pine CR -coast redwood CO- coast live oak
CI -- Catalina ironwood CS -- California sycamore BL -- big leaf maple Pod -- Podocarpus OT -- other
(Note: Other species on the recommended tree list may be determined to be Significant Trees only if they are exceptional examples of the species.
Such trees also must exhibit excellent health, form, vigor, and substantial size to rate an overall score of at least 7 points in Part Two of the

C. Does the tree meet the minimum size criteria for significance?

Tree #	1	2	3	4	5	6	7	8	9	10	11	12	13	14	15
YES	Х	Х	х	Х	Х	Х	Х	Х	Х	Х	Х	Х	Х	Х	
NO															

Monterey pine, Monterey cypress, Bishop pine, Coast redwood: 6" DBH

Coast live oak – single trunk tree: 6" DBH

Coast live oak – multi-trunk tree measured per industry standard: 6" DBH California sycamore, Big leaf maple, Catalina ironwood, other: 10" DBH

dbh = diameter at breast height or 4.5 feet above the adjacent ground surface

Part Two: Assessment For Tree Significance

For each of the criteria below assign points as shown to assess the tree. If any criteria score is zero the assessment may stop as the tree cannot qualify as significant or moderately significant.

D. What is the health and condition of the tree?

score 1 0 1 2 2 2 2 2 2 2 2 2 2 2 2 2 2 2	L	14	13	12	11	10	9	8	7	6	5	4	3	2	1	Tree #
		2	2	0	2	2	2	2	2	2	2	2	1	0	1	score

The tree is heavily infested with pests or has advanced signs of disease that indicates the tree is declining and has very limited life expectancy.

1 point: The tree shows some pests or disease that impair its condition, but which does not immediately threaten the health of the tree. The tree may recover on its own, or with appropriate intervention.

2 points: The tree appears healthy and in good condition.

3 points: The tree shows excellent health, is free of pests and disease and is in very strong condition.

E. What is the overall form and structure of the tree?

Tree # 1 2 3 4 5 6 7 8 9 10 11 12 13 14 15

score 2 1 2 2 2 2 2 2 2 2 1 2 2

Prior pruning, disease or growth habit have left the tree deformed or unsound to an extent that it cannot recover or will never be a visual asset to the neighborhood or will likely deteriorate into a structural hazard.

The tree has poor form or structure but (a) can recover with proper maintenance or (b) it provides visual

1 point: interest in its current form, and does not have structural defects that are likely to develop into a safety

hazard.

The tree has average form and structure for the species but does not exhibit all the qualities of excellent

2 points:
form and structure.

The tree exhibits excellent form and structure. For all species there will be a good distribution of foliage on multiple branches with no defects. For conifers, the tree will have a single straight leader with balanced branching and with good taper. Oaks will exhibit a well-developed canopy with no suppressed branches.

Oaks may be single-trunked or multi-trunked and will have a balanced distribution of foliage on each

F. What is the age and vigor of the tree?

Tree # 1 2 3 4 5 6 7 8 9 10 11 12 13 14 15 score 1 0 1 2 1 1 2 2 2 2 2 0 2 2


The tree is over-mature or shows signs of poor or declining vigor such as die-back of major limbs or of the crown, small leaves/needles and/or minimal new growth.

The tree is mature but retains normal vigor and is likely to continue as a forest asset for a substantial period into the future.

2 points: The tree is young to middle age and shows normal vigor.

3 points: The tree is young to middle age and shows exceptional vigor.

HARRISON RESIDENCE REMODEL SAN CARLOS, 2 N.E. OF 2ND AVENUE CARMEL, CA 93923

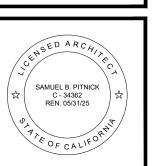

2 ARCHIECIS

SAMUEL PITNICK
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PHONE: (831) 241-1895
EMAIL: SAMUELPITNICK@GMAIL.COM

REVISIONS DATE


ARCHITECTURAL


CITY FORESTER TREE SURVEY

Scale: SEE DWG.
Drawn By: SBP


Job: -

G1.2

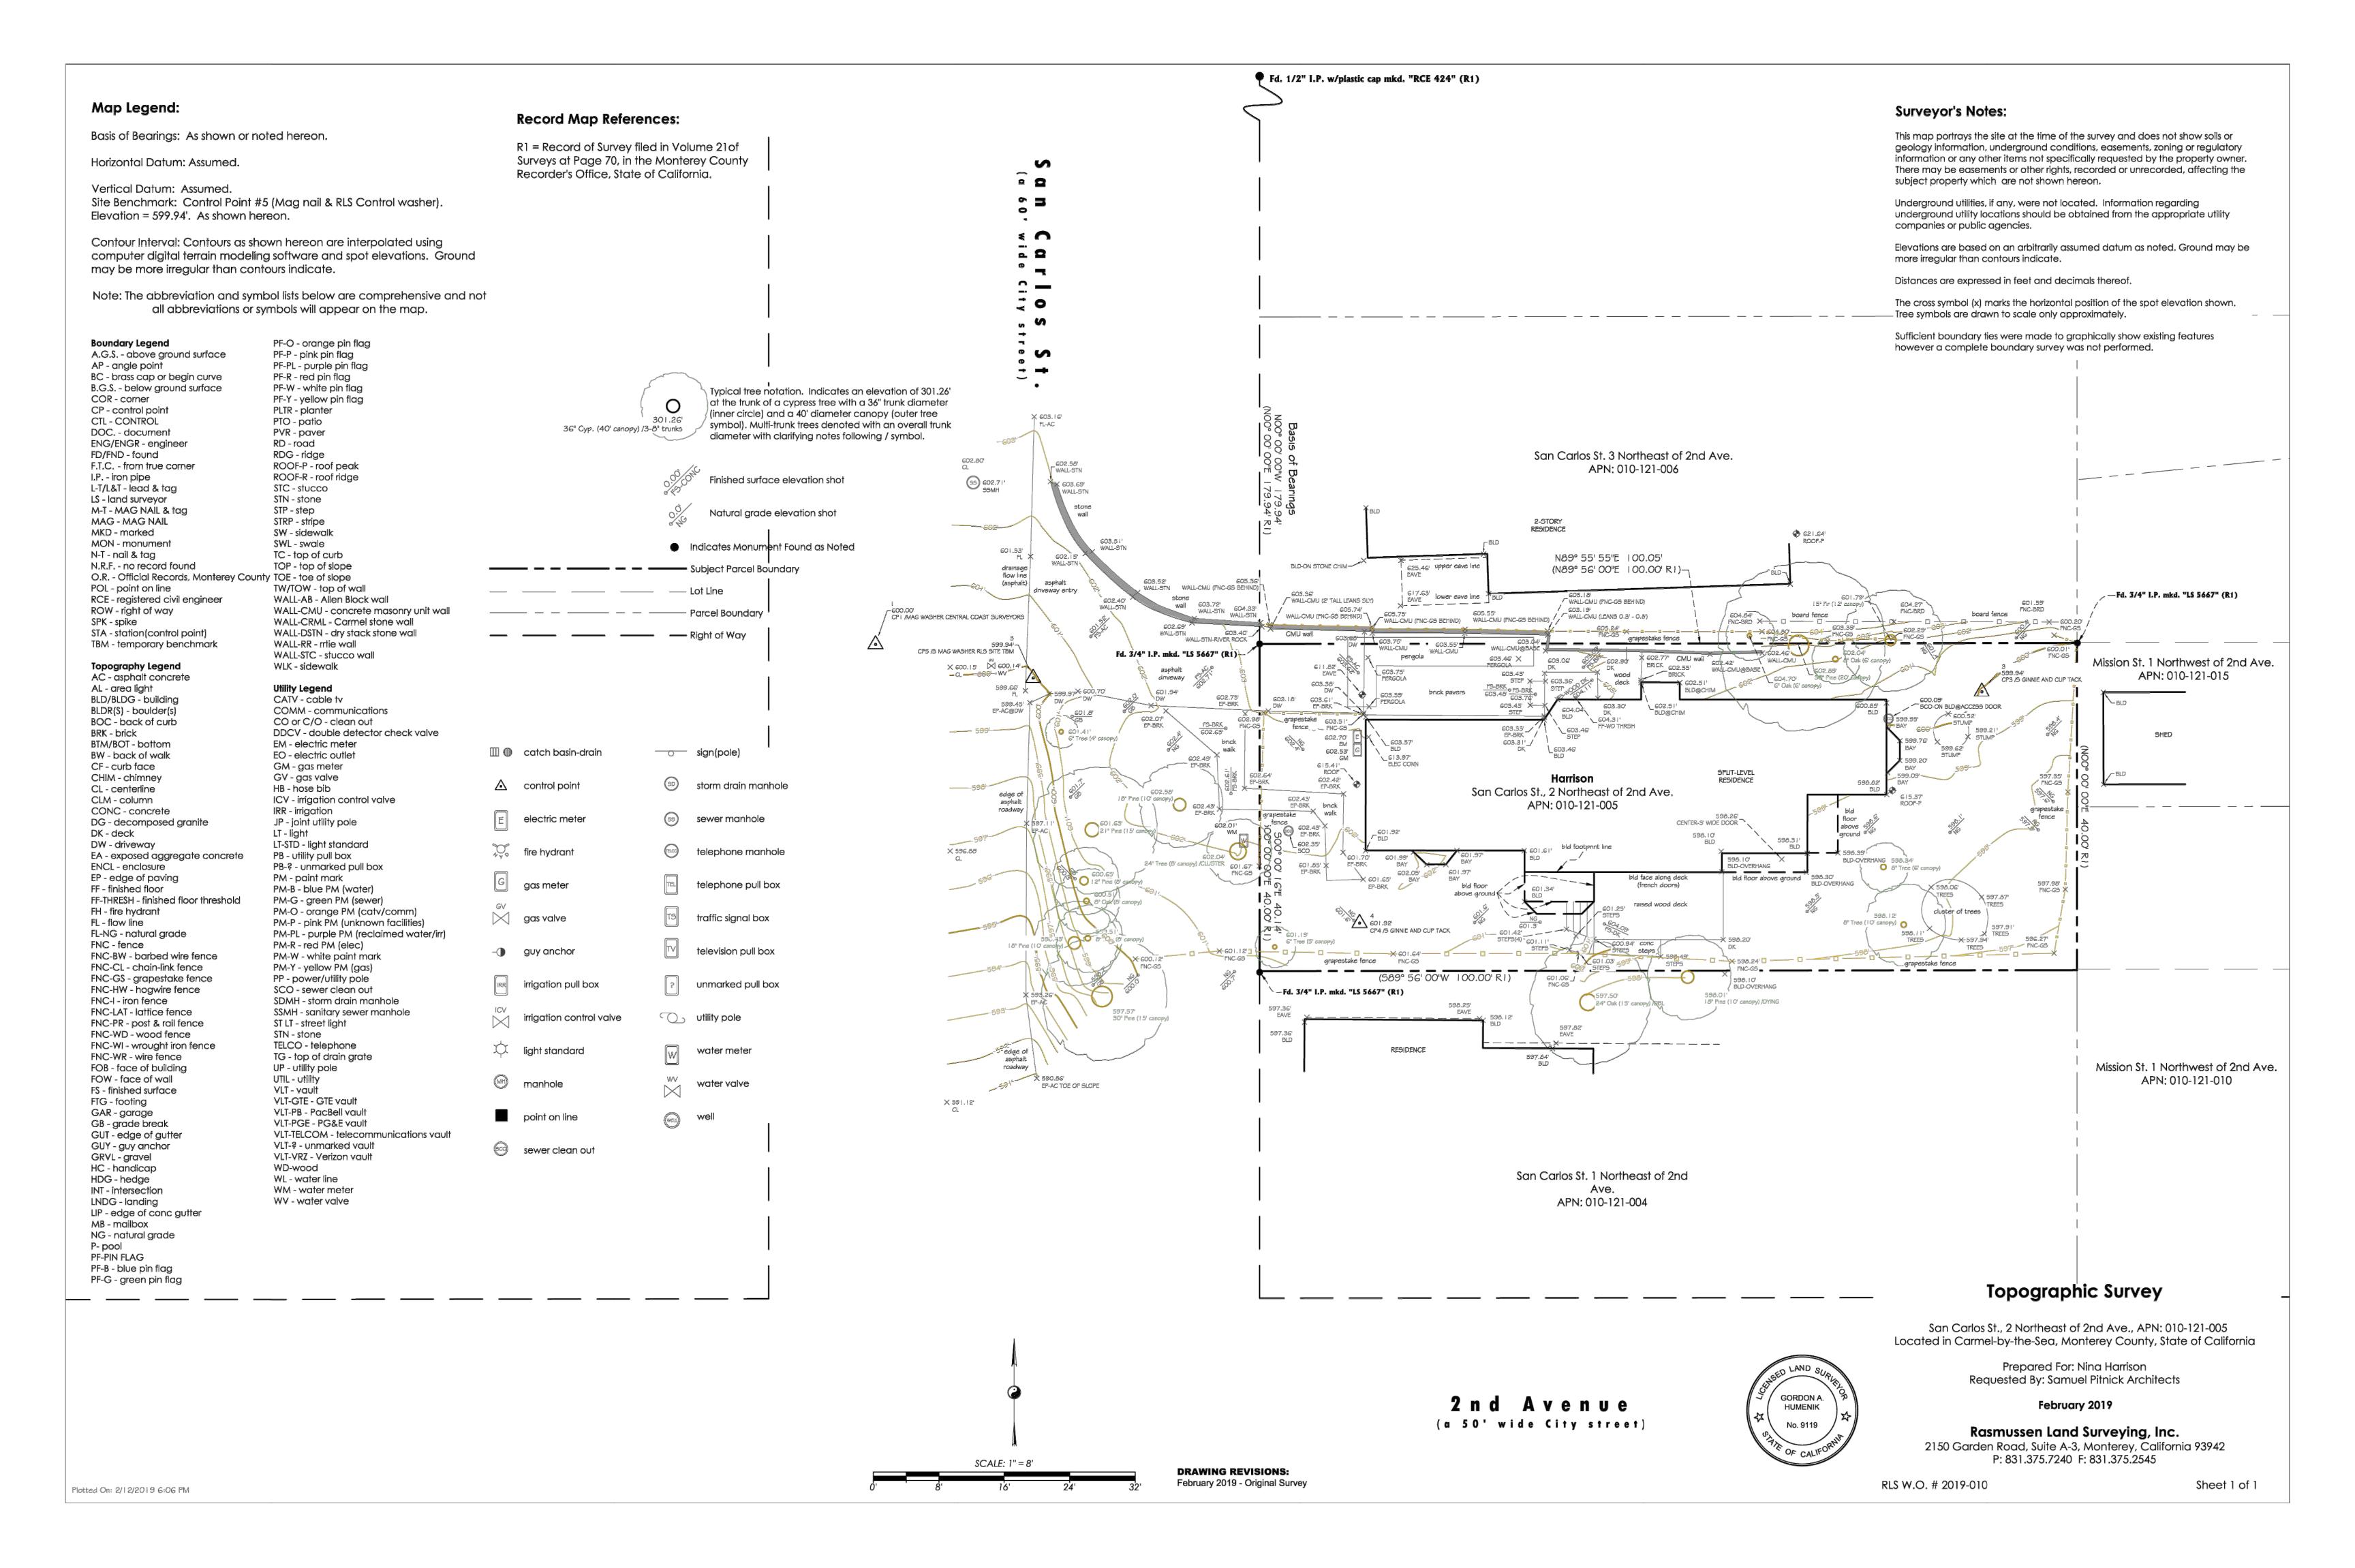

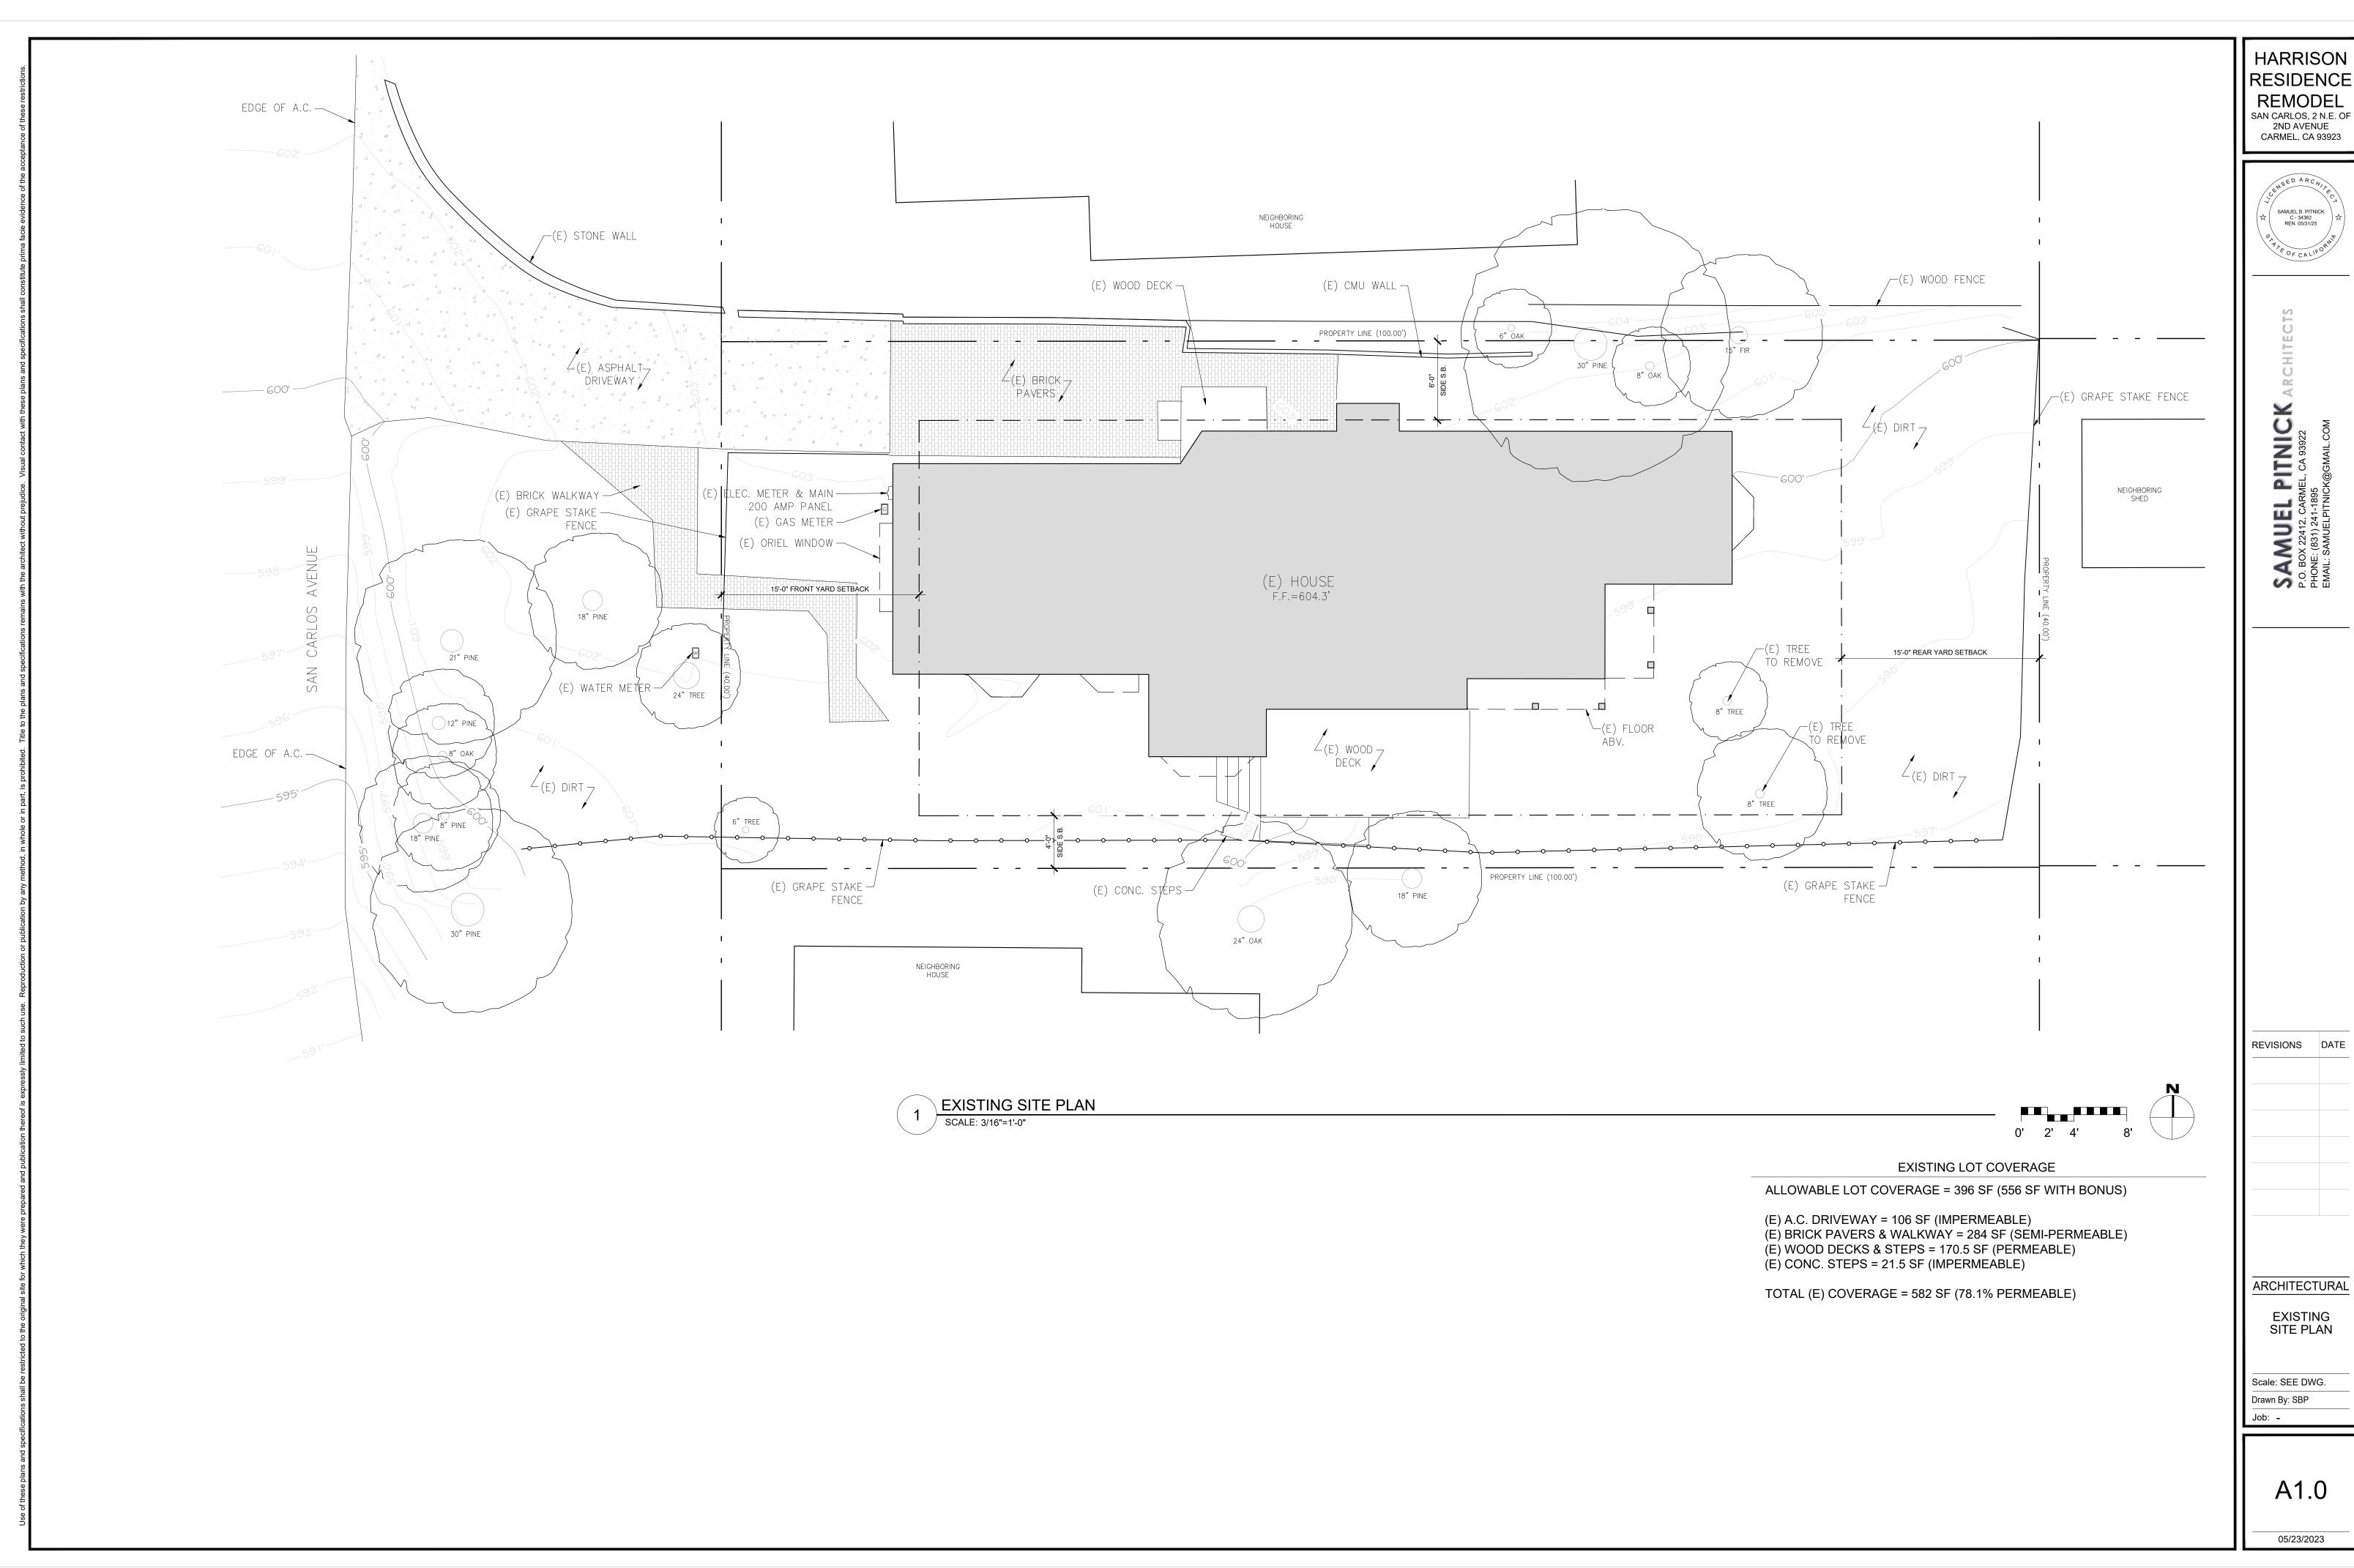



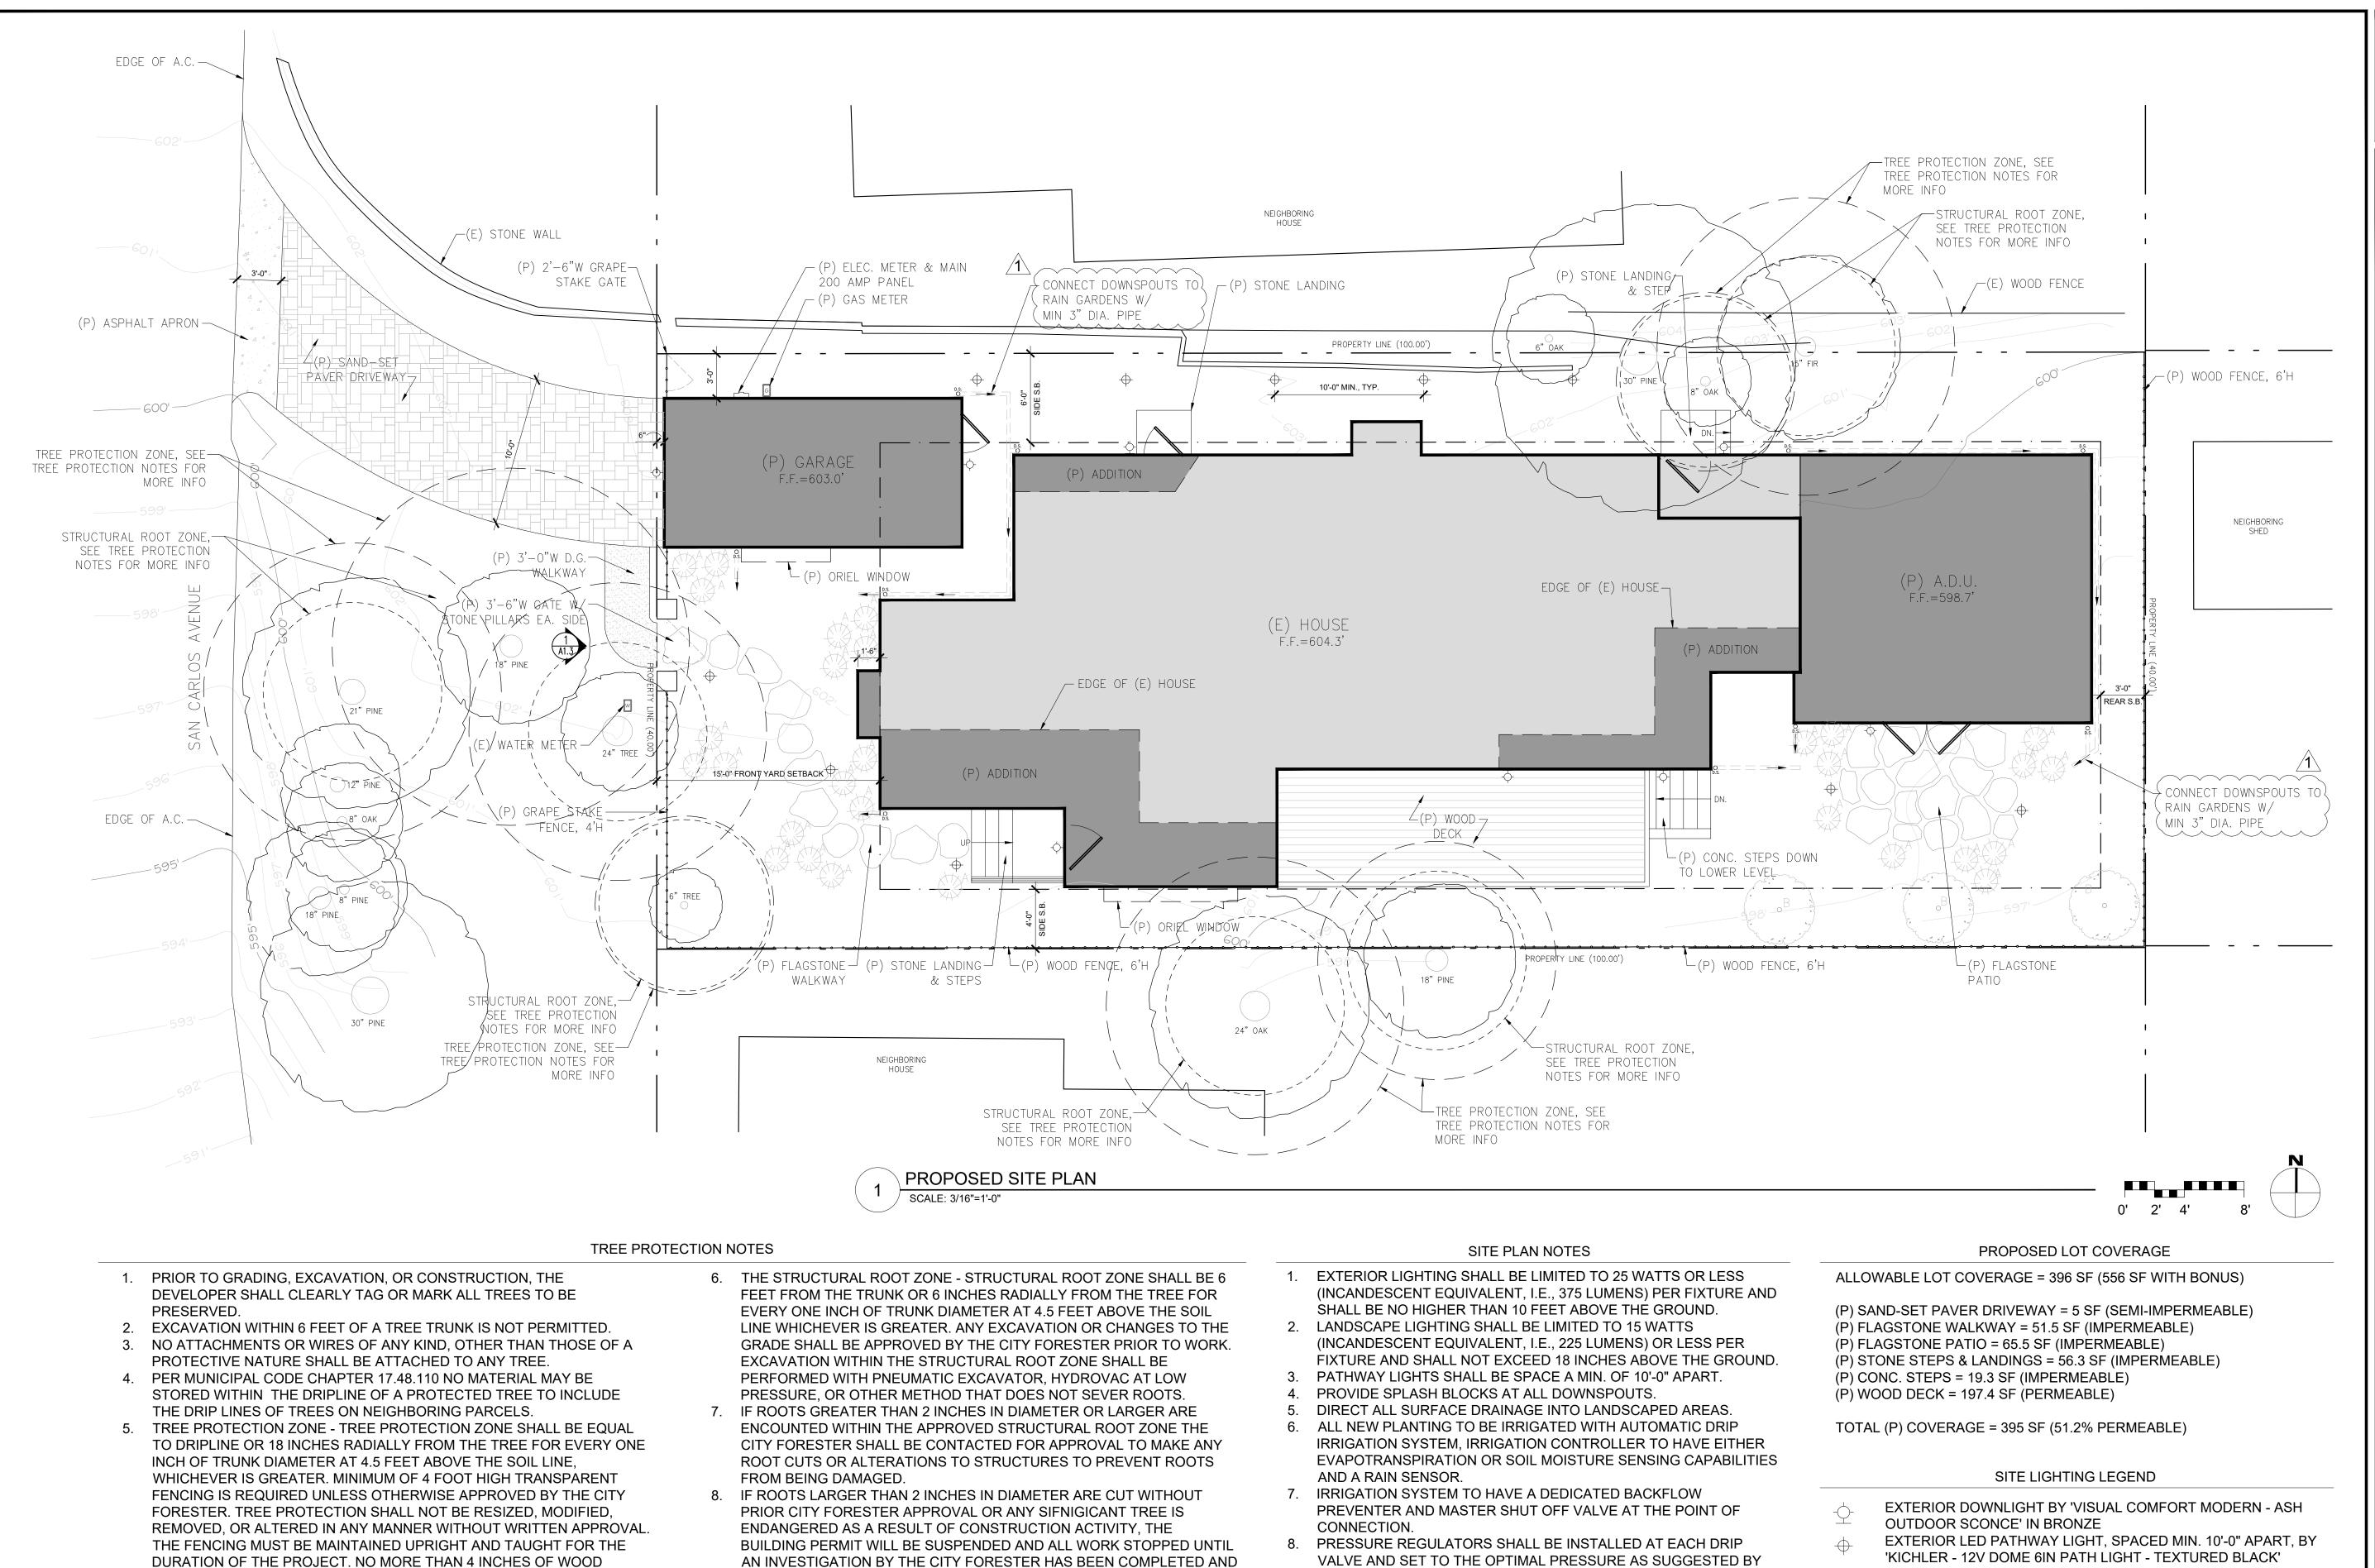

MITIGATION MEASURES HAVE BEEN PUT IN PLACE.

MULCH SHALL BE INSTALLED WITHIN THE TREE PROTECTION ZONE

AT 4.5 FEET ABOVE THE SOIL LINE OUTSIDE OF FENCING.

WHEN THE TREE PROTECTION ZONE IS AT OR WITHIN THE DRIP LINE, NO

LESS THAN 6 INCHES OF WOOD MULCH SHALL BE INSTALLED 18 INCHES

RADIALLY FROM THE TREE FOR EVERY ONE INCH OF TRUNK DIAMETER

THE MANUFACTURER OF THE DRIP EMITTERS. ALL DRIP ZONES

INSTALLED ON SLOPES TO BE FITTED WITH CHECK VALVES AND

9. MANUAL-SHUT-OFF VALVE SHALL BE INSTALLED AS CLOSE AS

POSSIBLE TO THE POINT OF CONNECTION AND AT VALVE

ALL LINES TO INCLUDE FLUSH PORTS.

MANIFOLDS.

HARRISON RESIDENCE REMODEL SAN CARLOS, 2 N.E. OF 2ND AVENUE CARMEL, CA 93923



 $\overline{\mathbf{c}}$ **MUEL**OX 22412 CAT

REVISIONS DATE A PLANNING 1/11/24

REVISION

ARCHITECTURAL

PROPOSED SITE PLAN

Scale: SEE DWG. Drawn By: SBP

A1

Job: -


*SEE SHEET A1.3 FOR LIGHT FIXTURE CUT SHEETS


QUANTITY = 29 SIZE = 1 GAL. B PINUS RADITA - 'MONTEREY PINE TREE' QUANTITY = 3 SIZE = 15 GAL.


SITE LANDSCAPING LEGEND

WESTRINGIA FRUTICOSA - 'GREY BOX COAST ROSEMARY'

01/11/2024

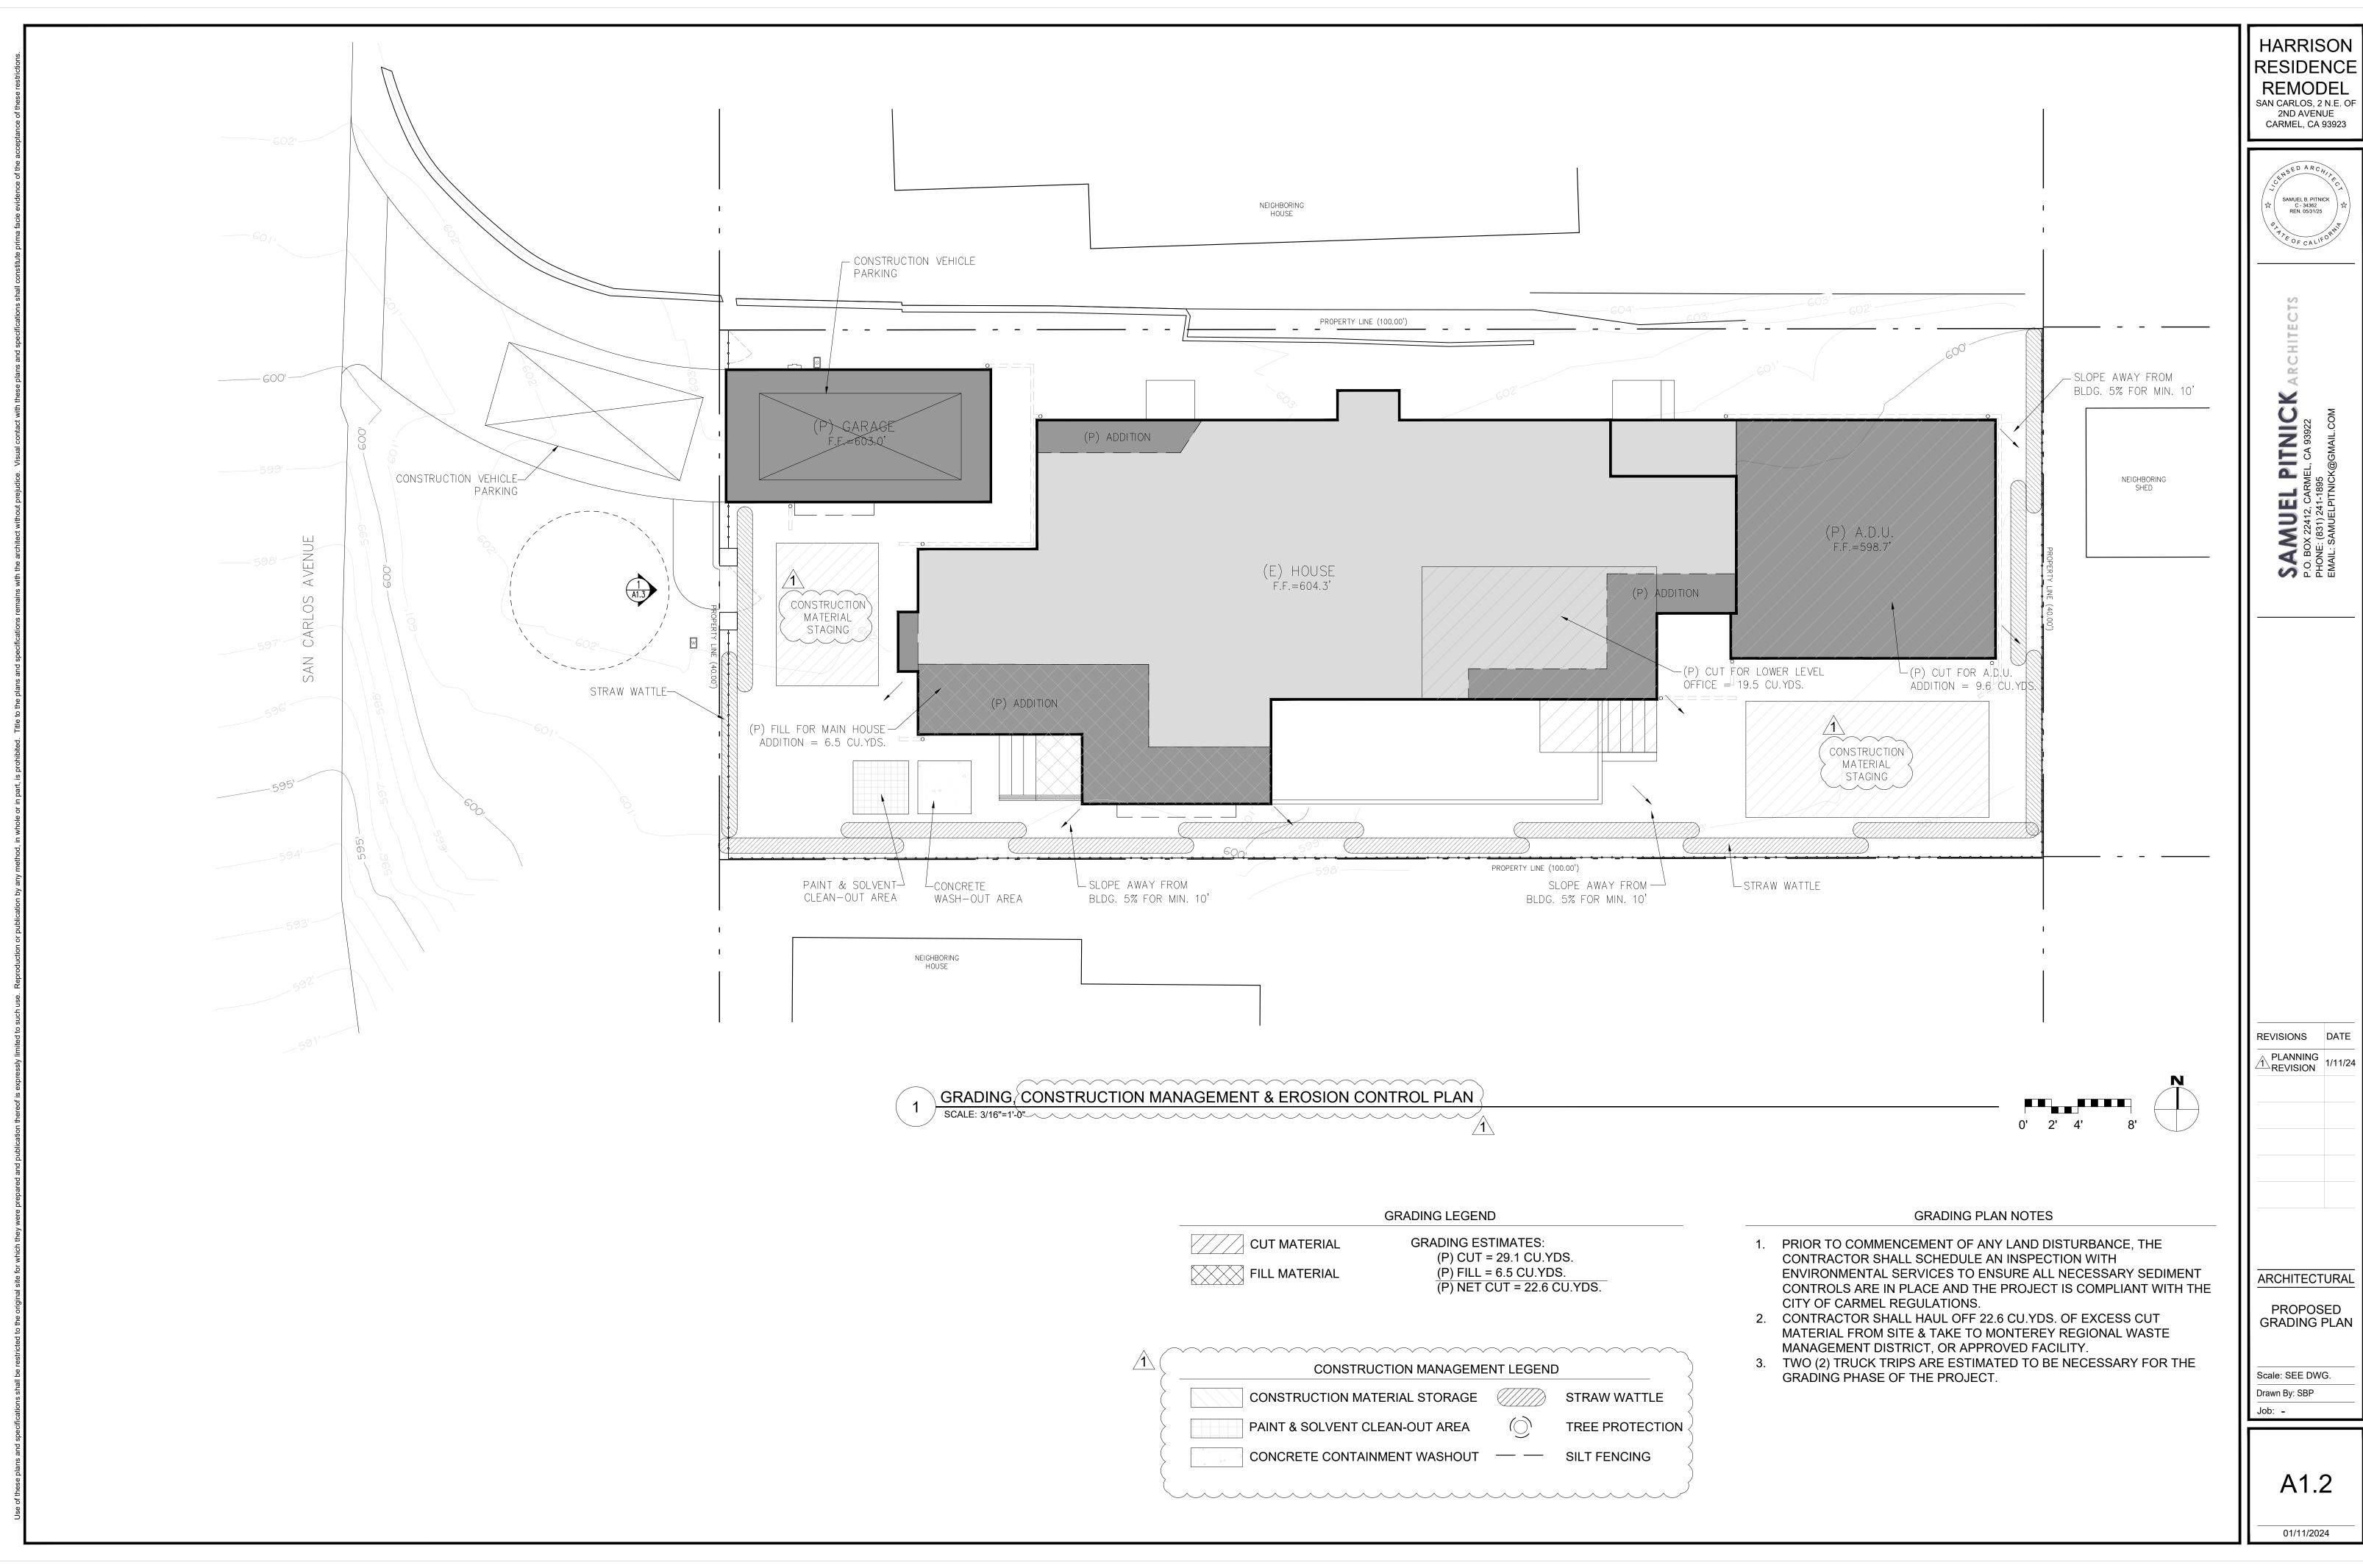

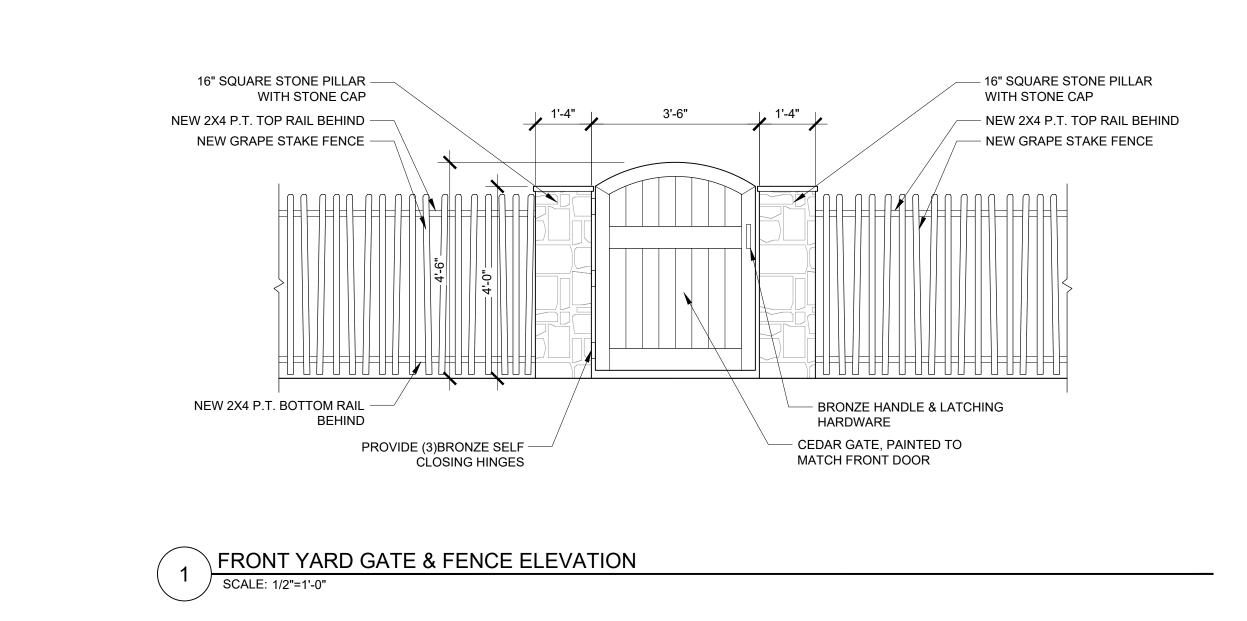

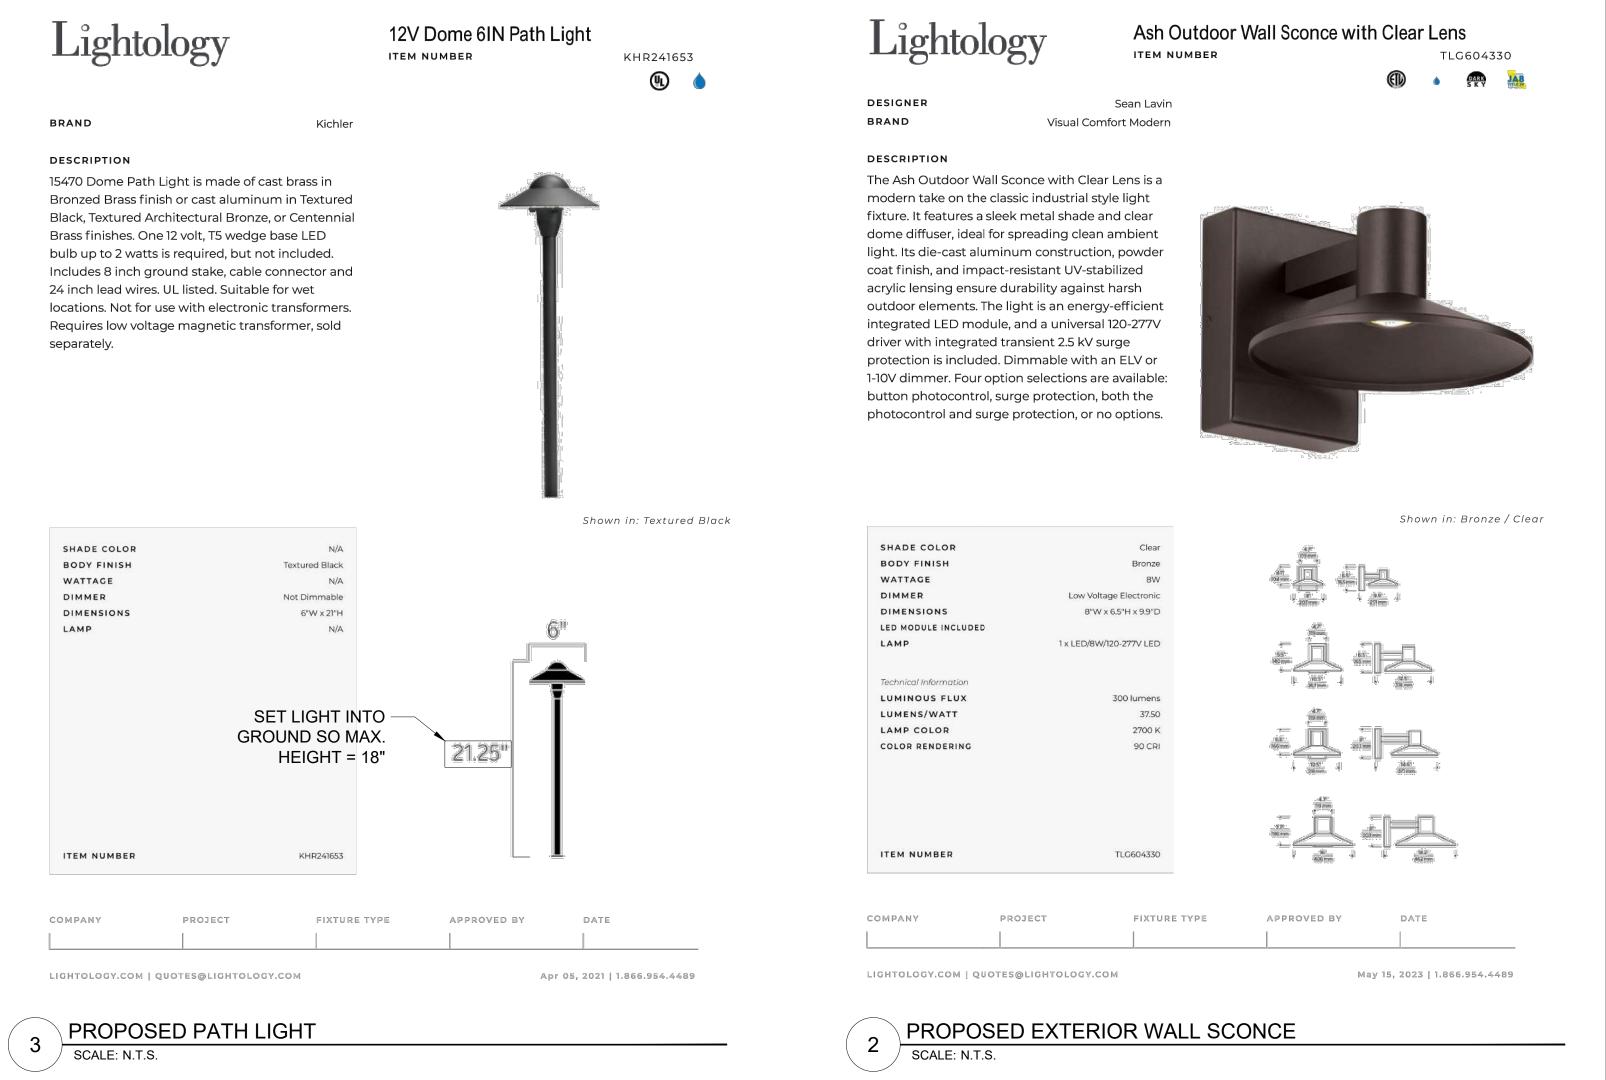

HARRISON RESIDENCE REMODEL SAN CARLOS, 2 N.E. OF 2ND AVENUE CARMEL, CA 93923



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EMAIL: SAMUELPITNICK@GMAIL.COM

REVISIONS DATE

PROPOSED SITE LIGHTING


& DETAILS


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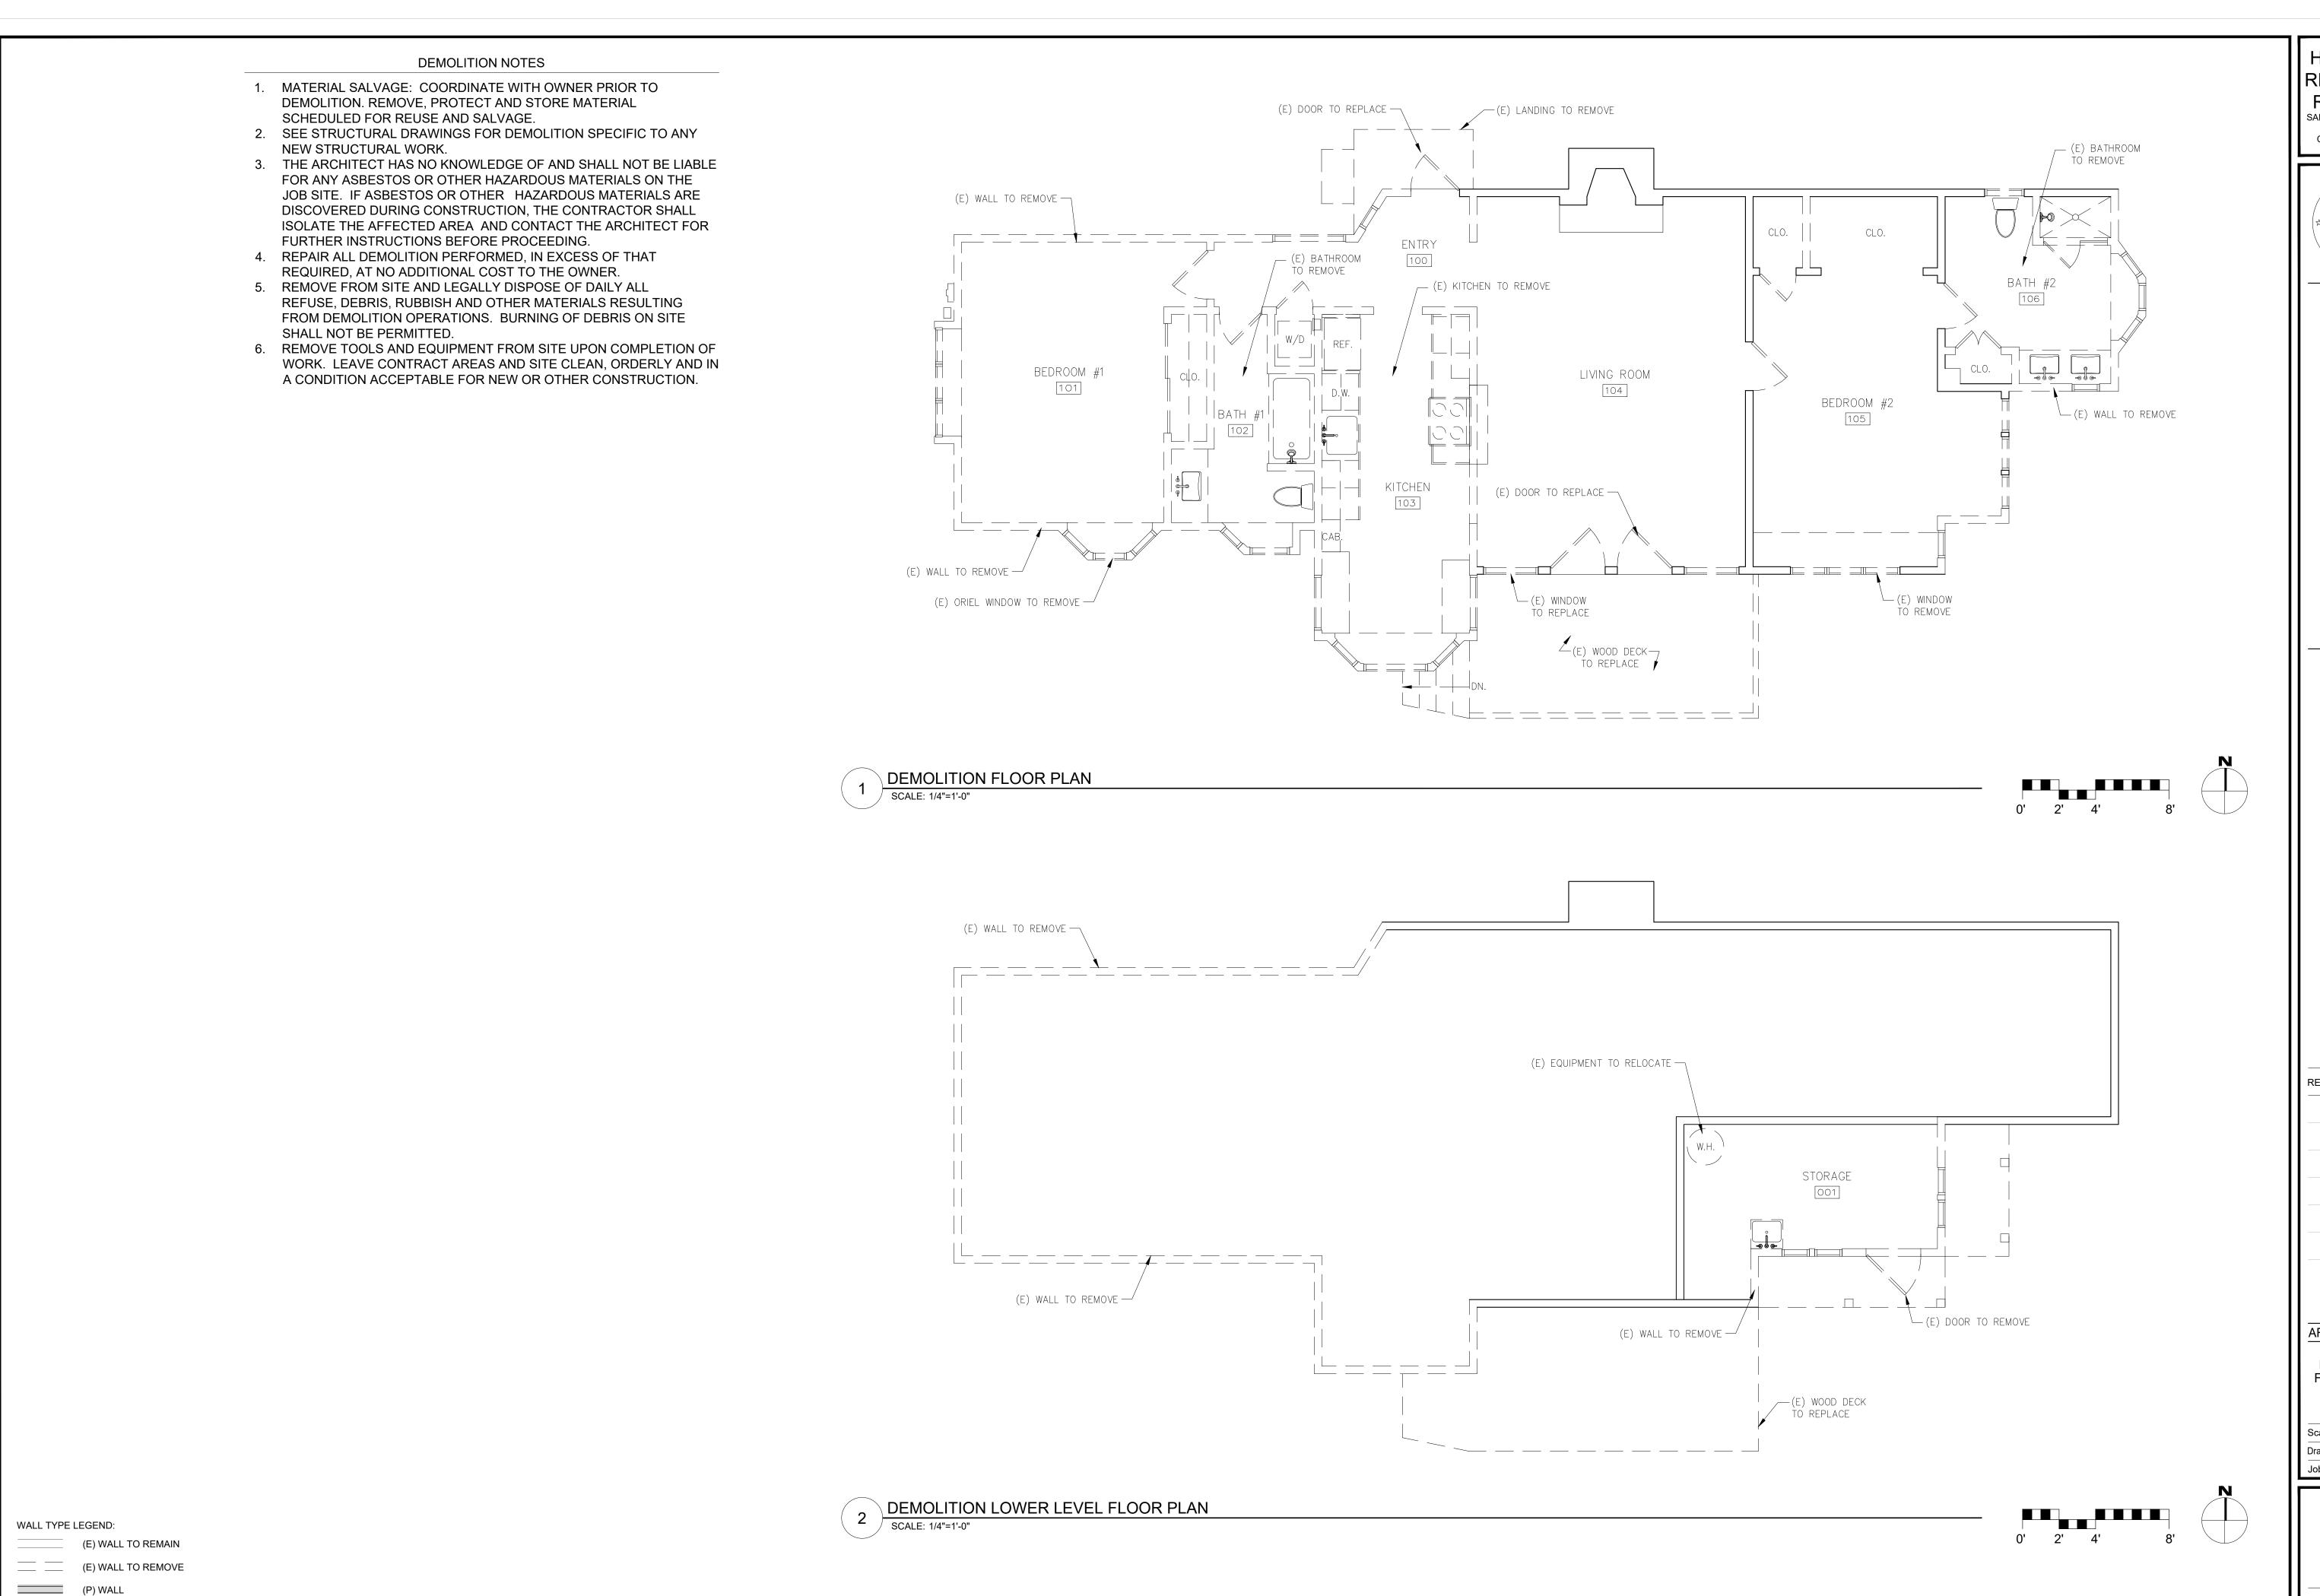
Drawn By: SBP

Job: -


A1.3



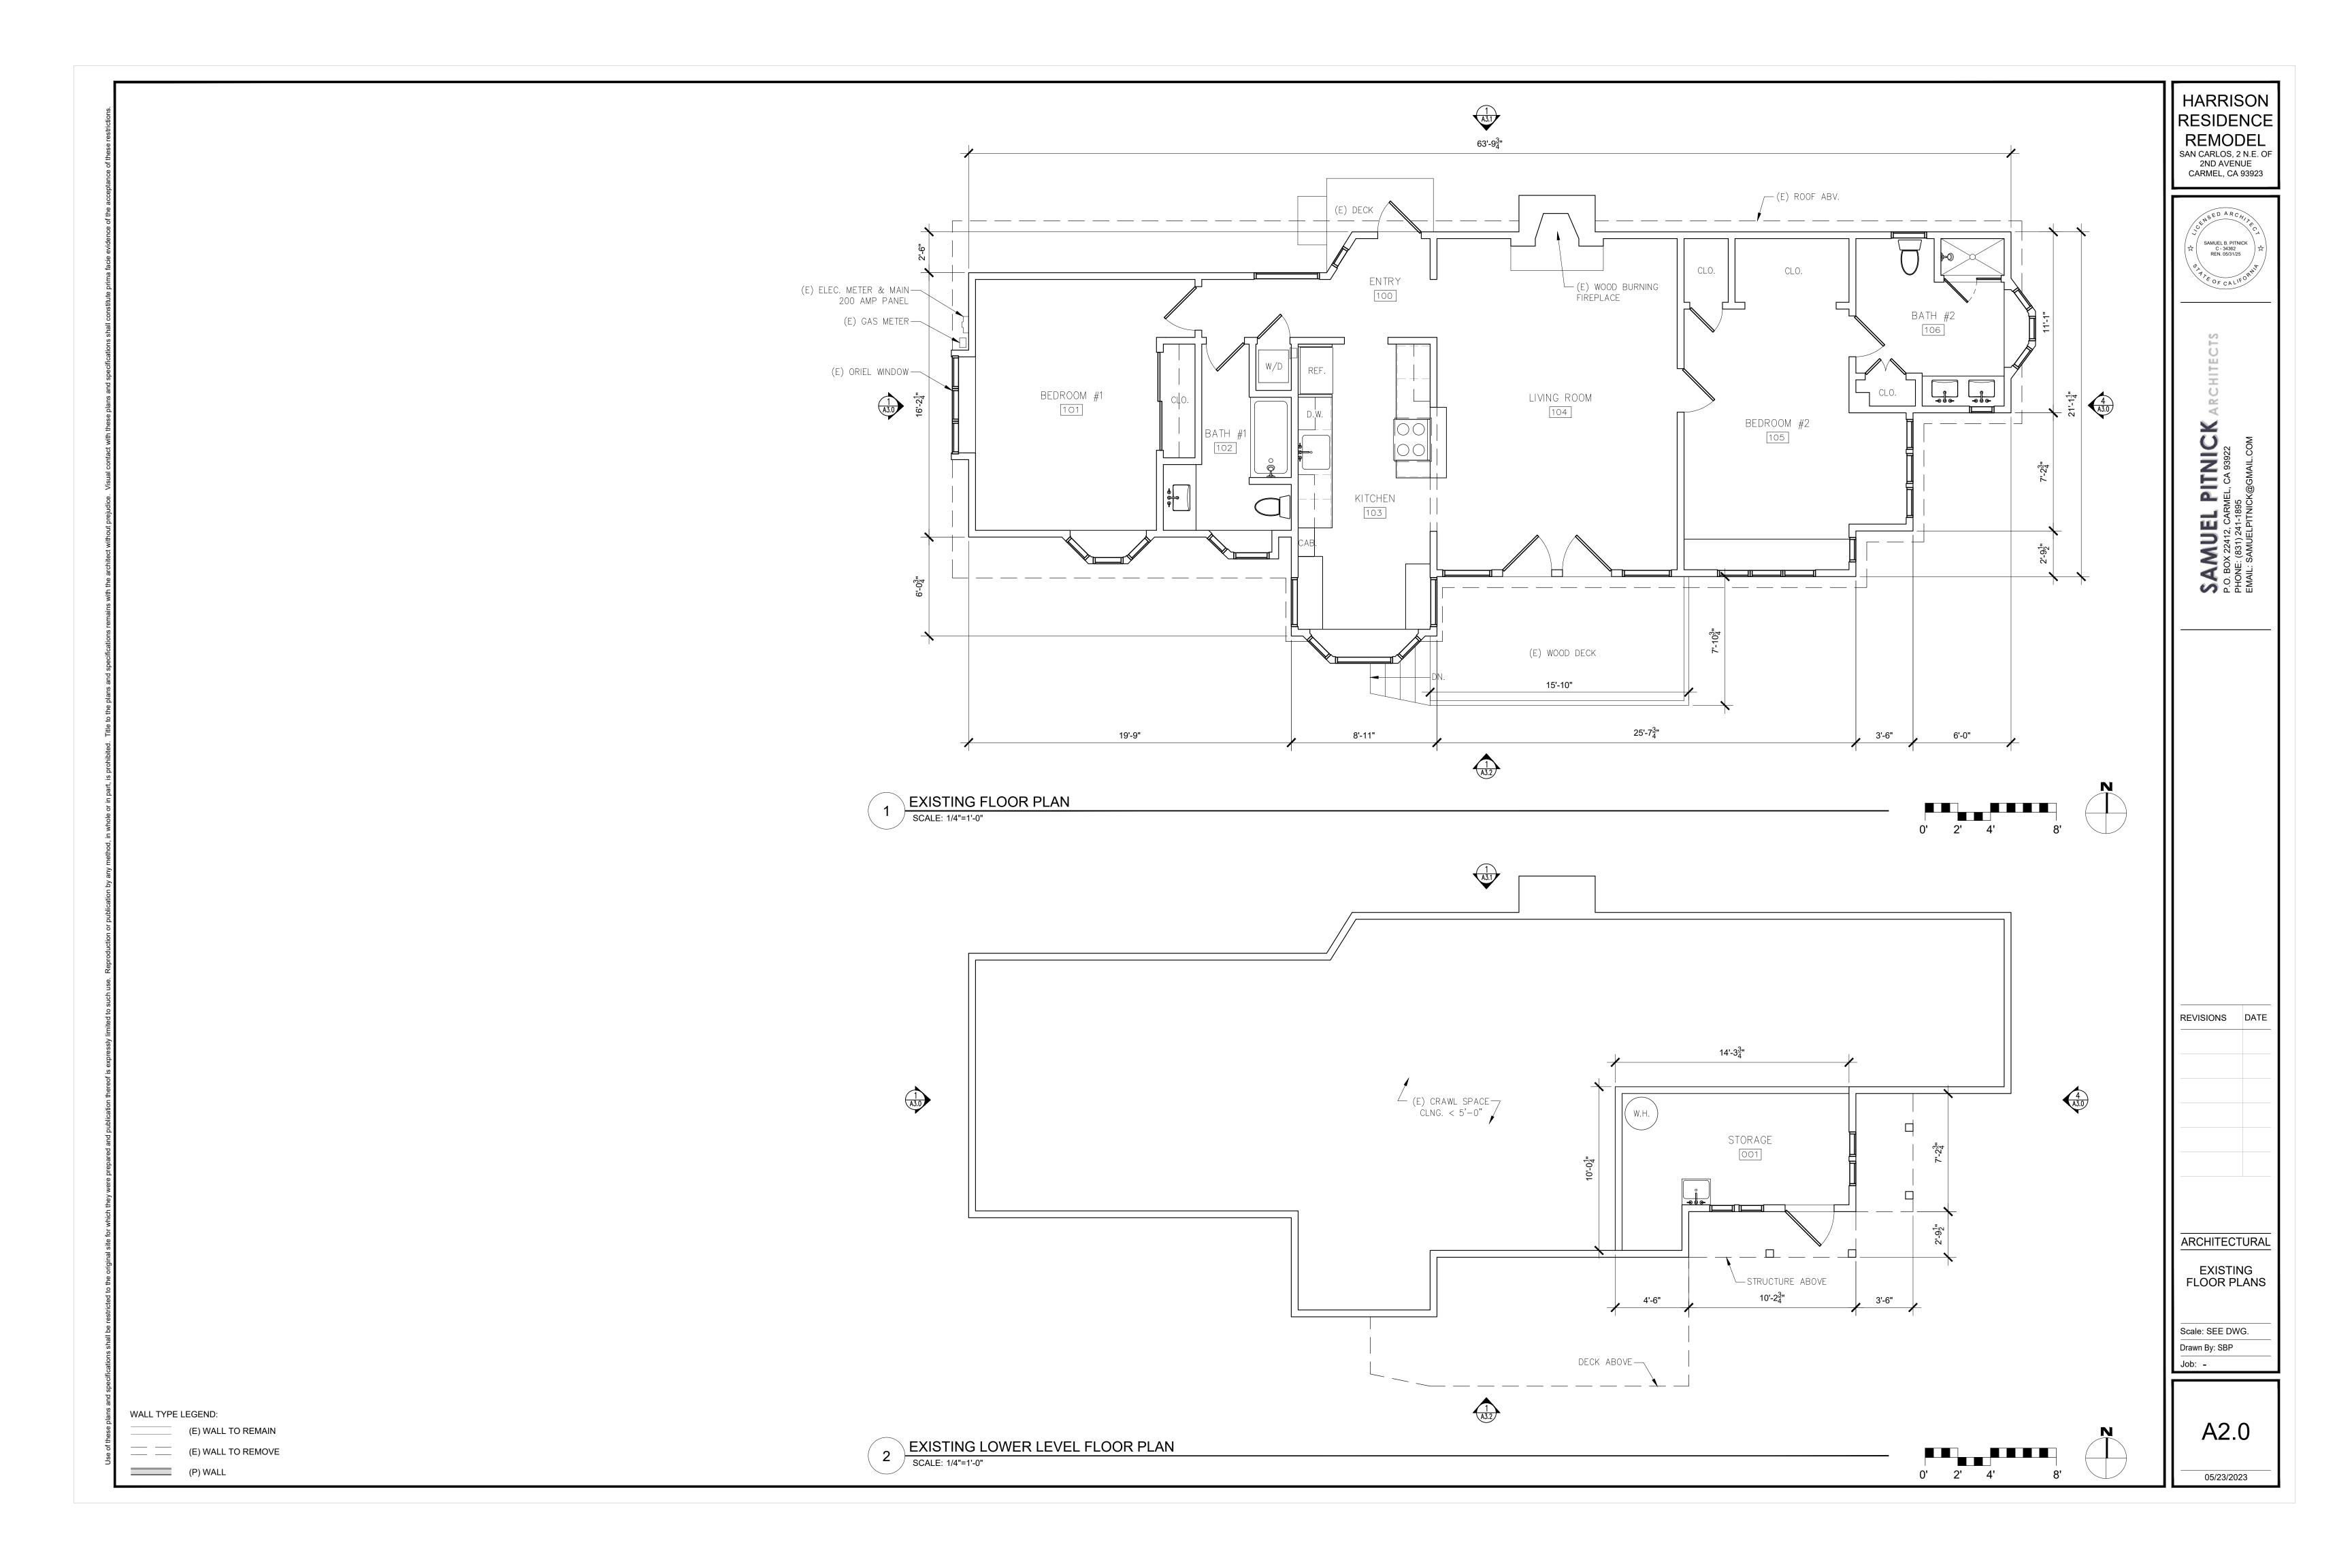

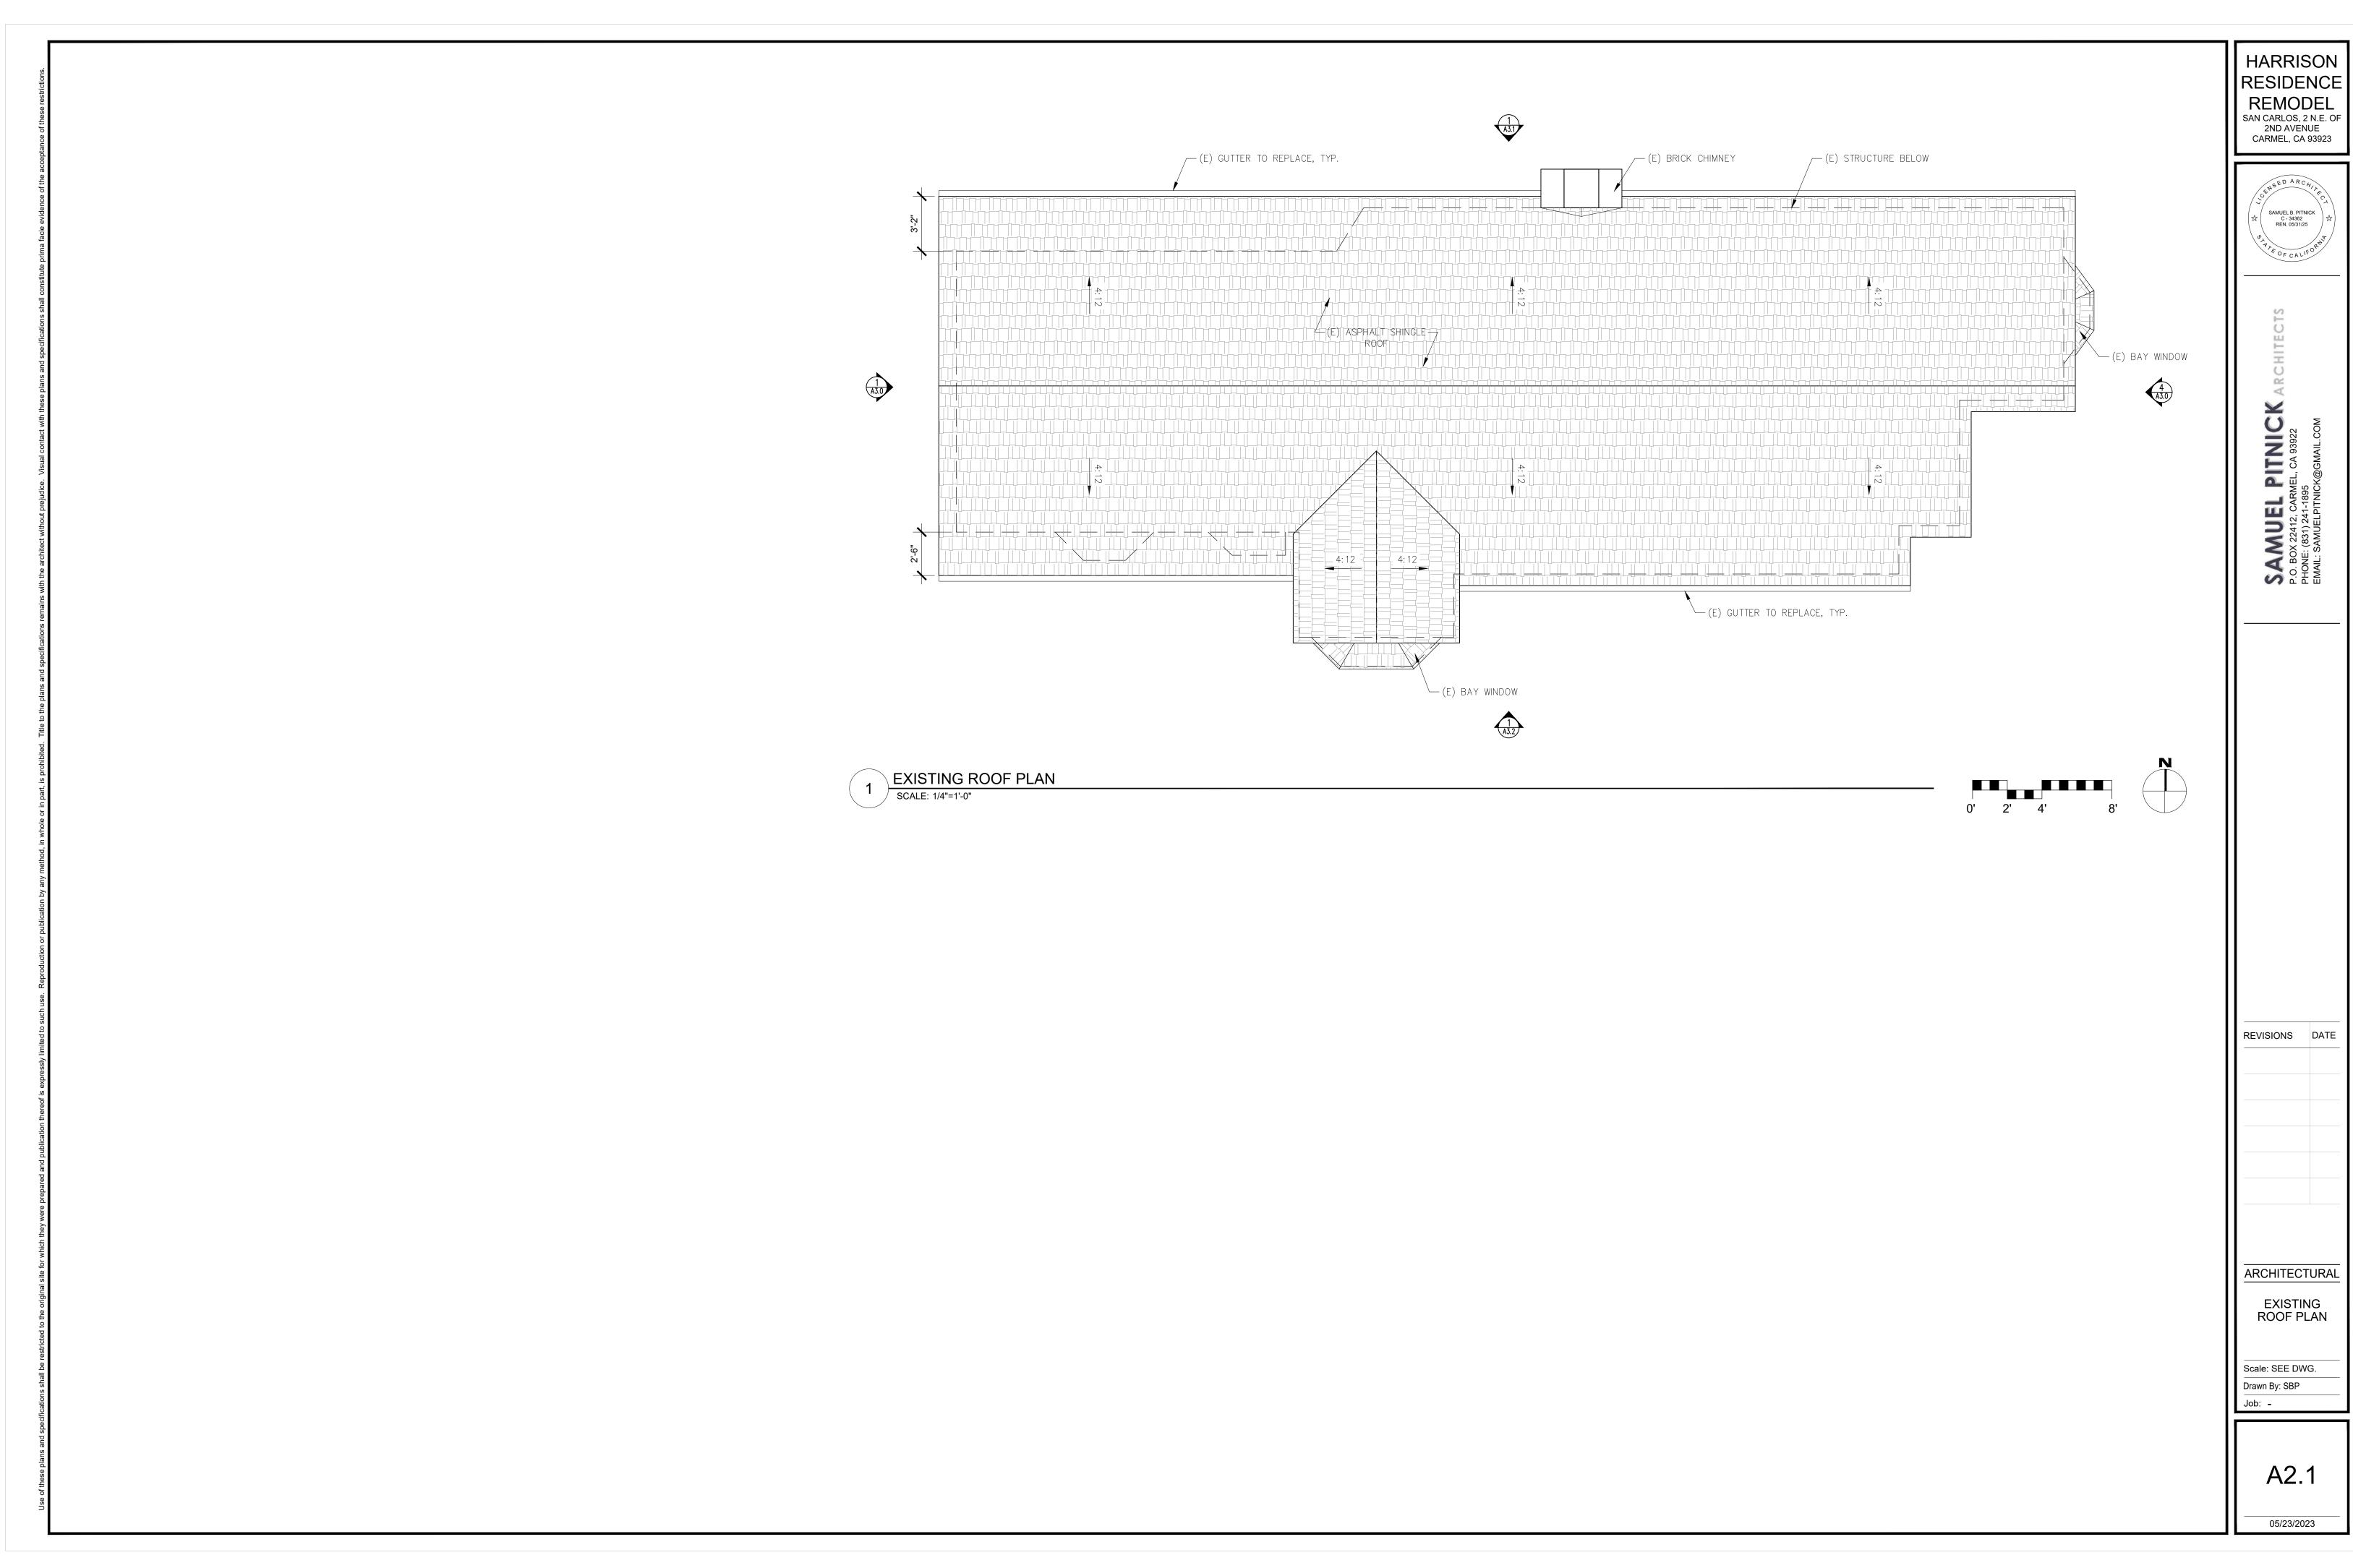

HARRISON RESIDENCE REMODEL SAN CARLOS, 2 N.E. OF 2ND AVENUE CARMEL, CA 93923

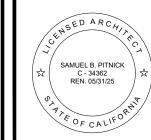

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REVISIONS DATE

ARCHITECTURAL


DEMOLITION FLOOR PLANS

Scale: SEE DWG.

Drawn By: SBP

Job: -

A2.2

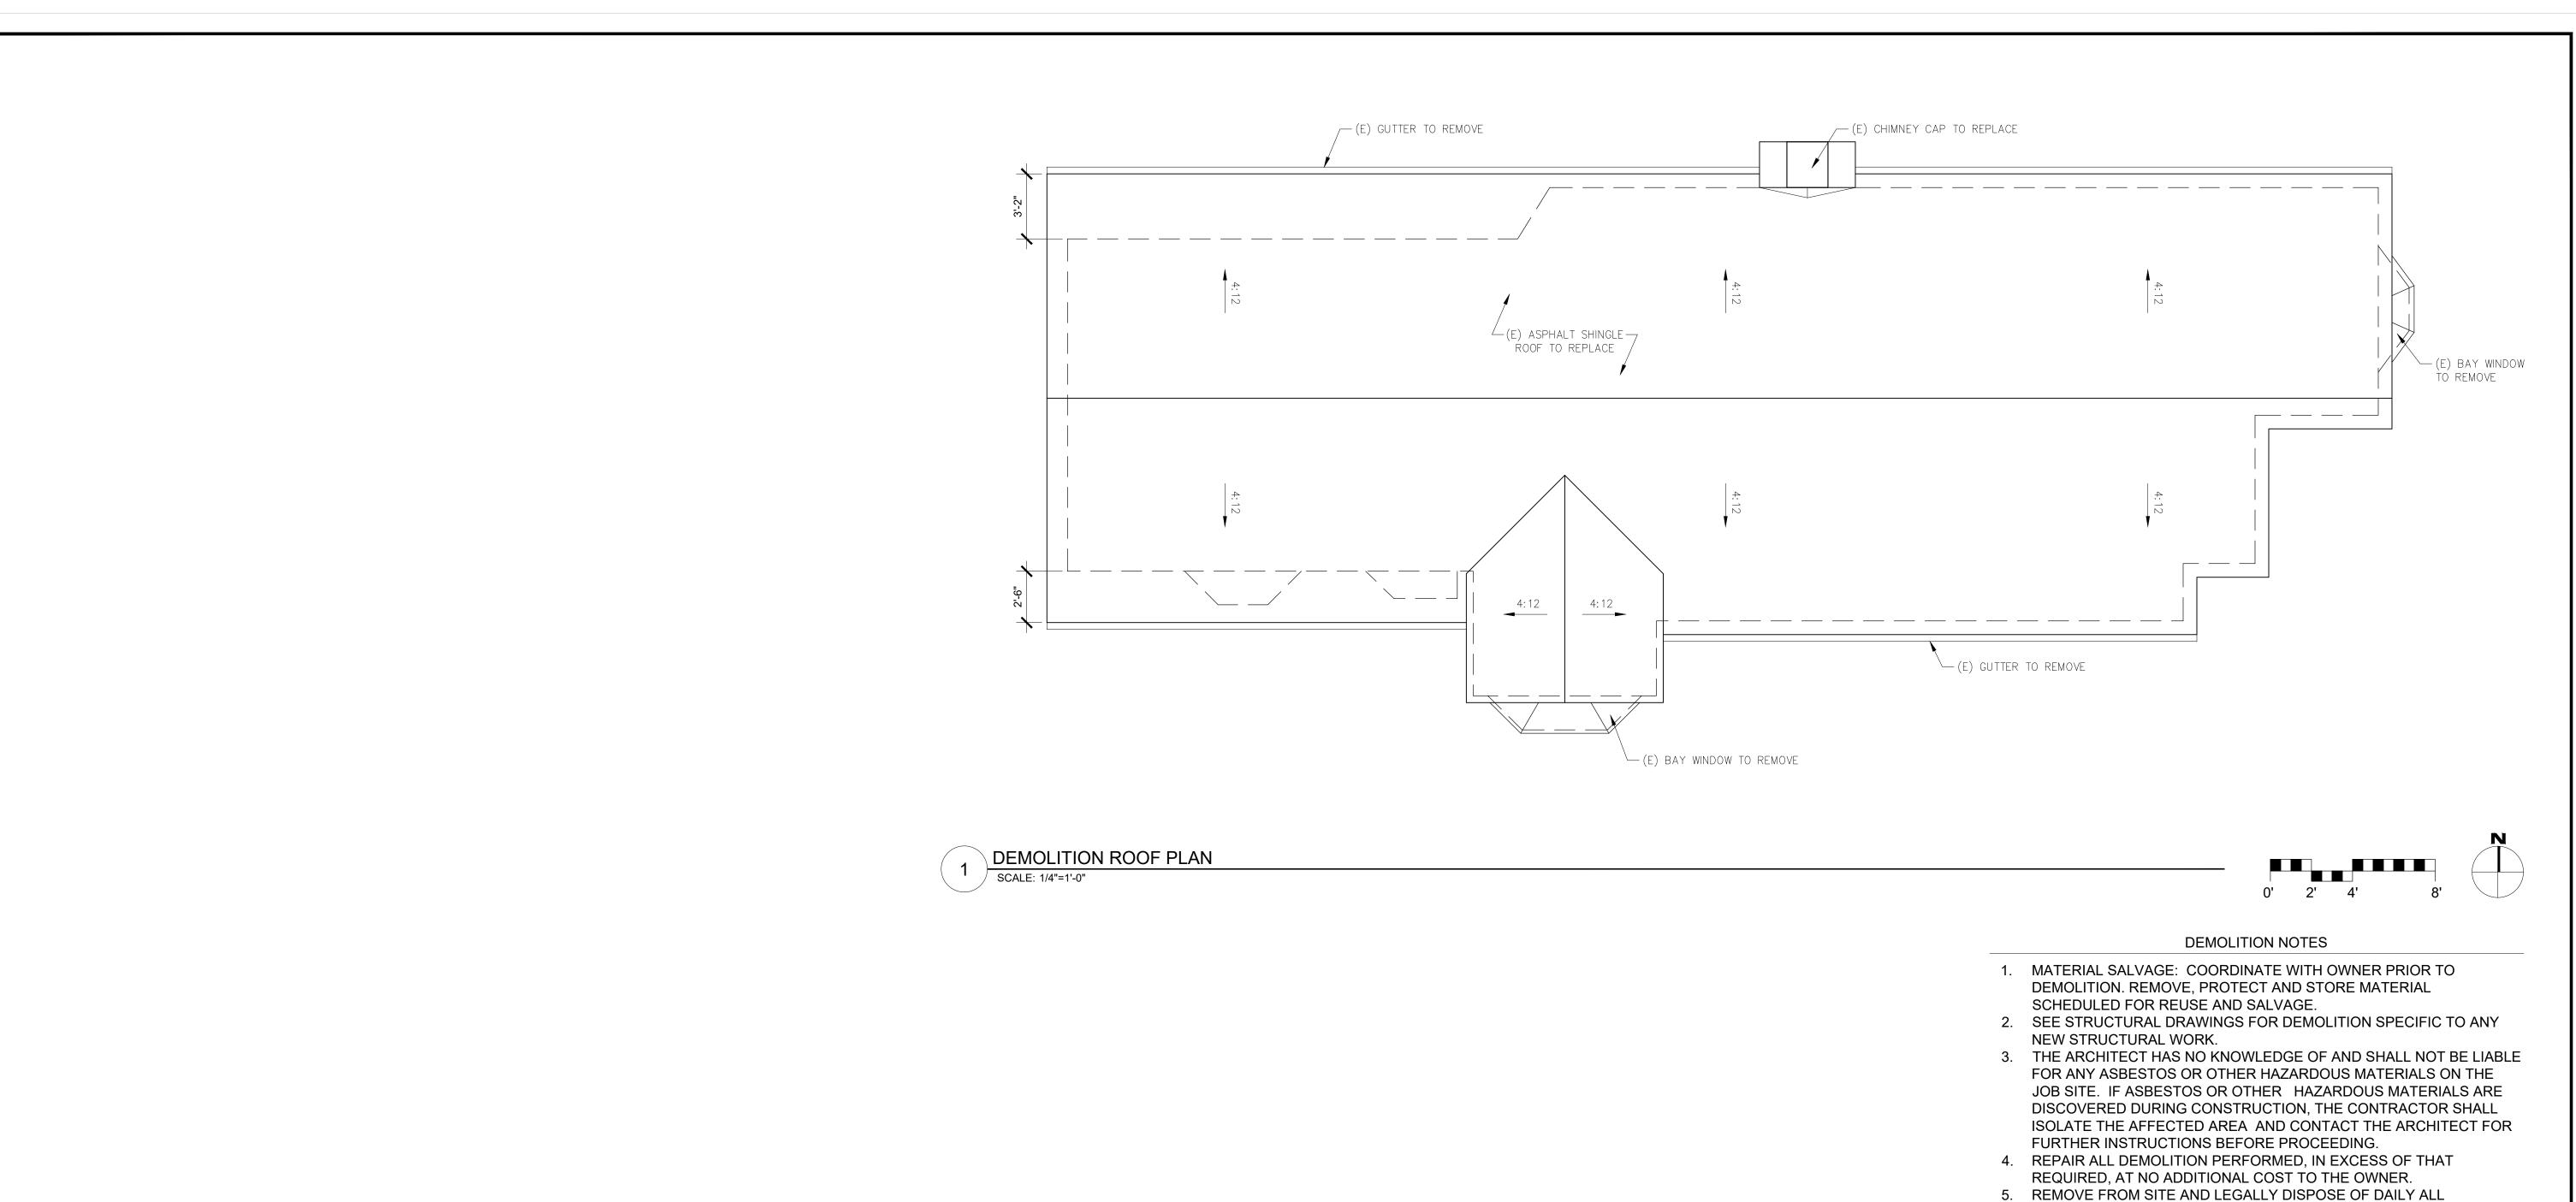

HARRISON RESIDENCE REMODEL SAN CARLOS, 2 N.E. OF 2ND AVENUE CARMEL, CA 93923



SAMUEL
P.O. BOX 22412, CARN
PHONE: (831) 241-1896
EMAIL: SAMUELPITNIC


- REFUSE, DEBRIS, RUBBISH AND OTHER MATERIALS RESULTING FROM DEMOLITION OPERATIONS. BURNING OF DEBRIS ON SITE SHALL NOT BE PERMITTED.
- 6. REMOVE TOOLS AND EQUIPMENT FROM SITE UPON COMPLETION OF WORK. LEAVE CONTRACT AREAS AND SITE CLEAN, ORDERLY AND IN A CONDITION ACCEPTABLE FOR NEW OR OTHER CONSTRUCTION.


REVISIONS DATE


ARCHITECTURAL


DEMOLITION **ROOF PLAN**


Scale: SEE DWG. Drawn By: SBP Job: -

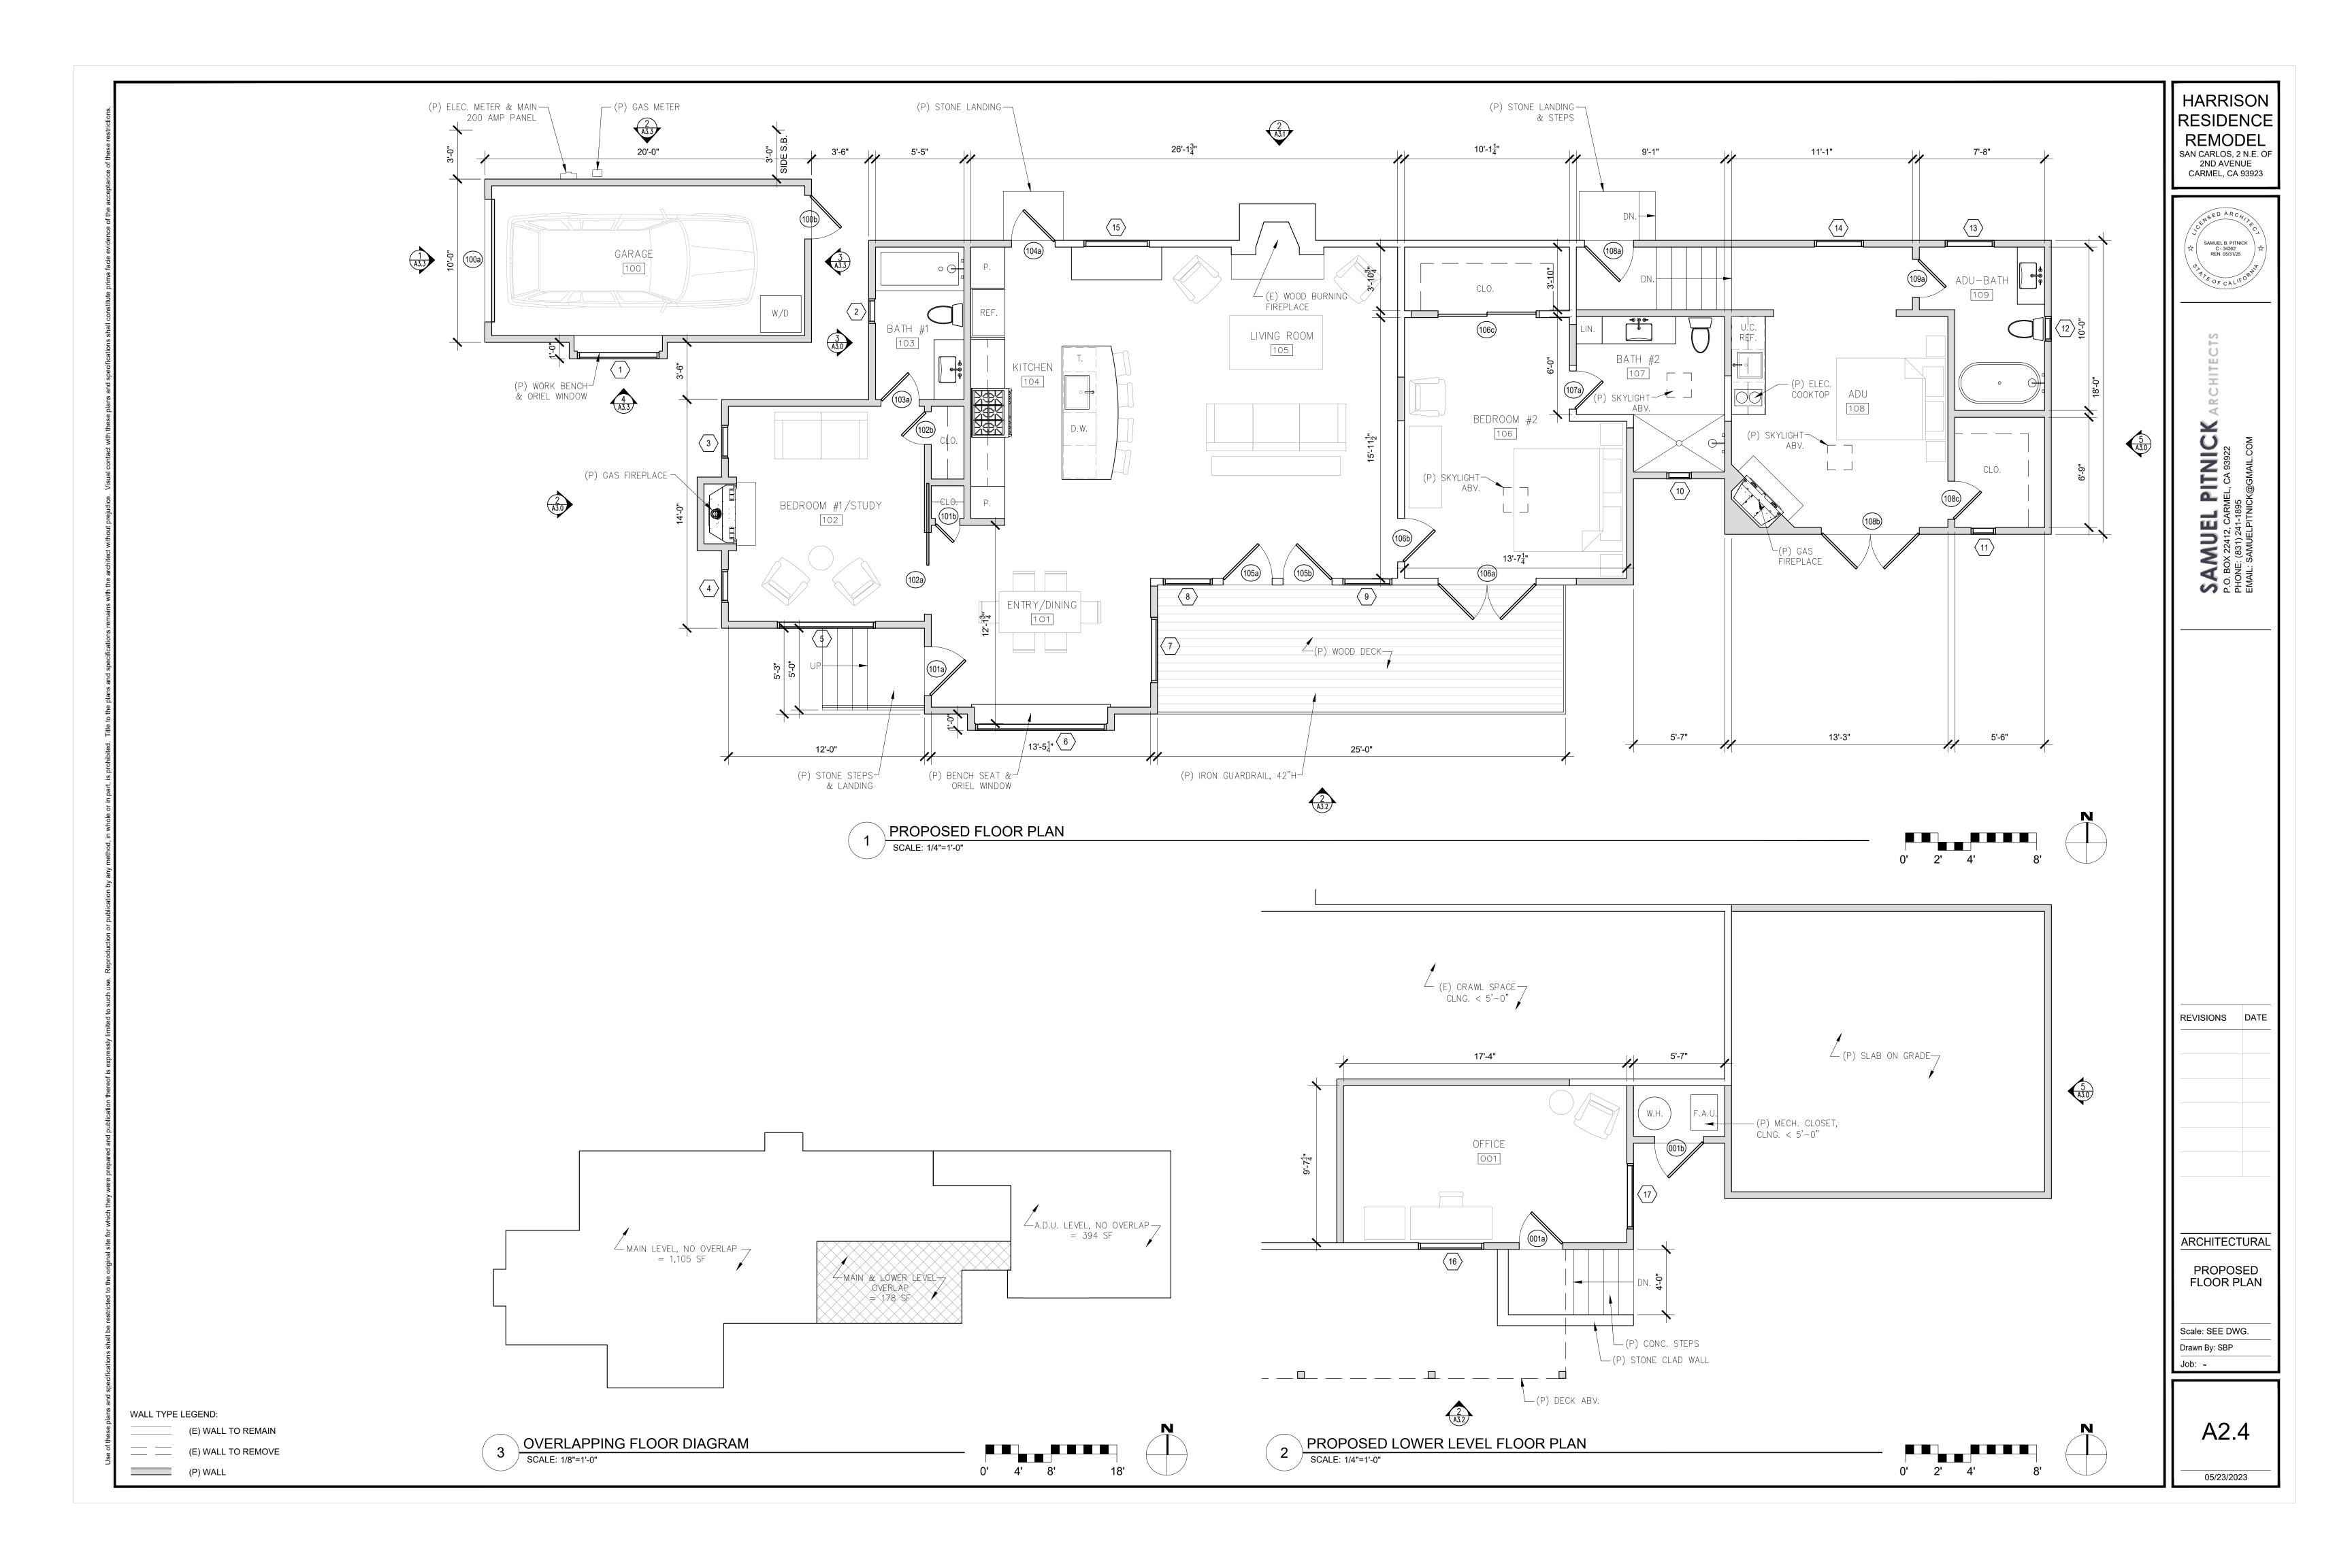


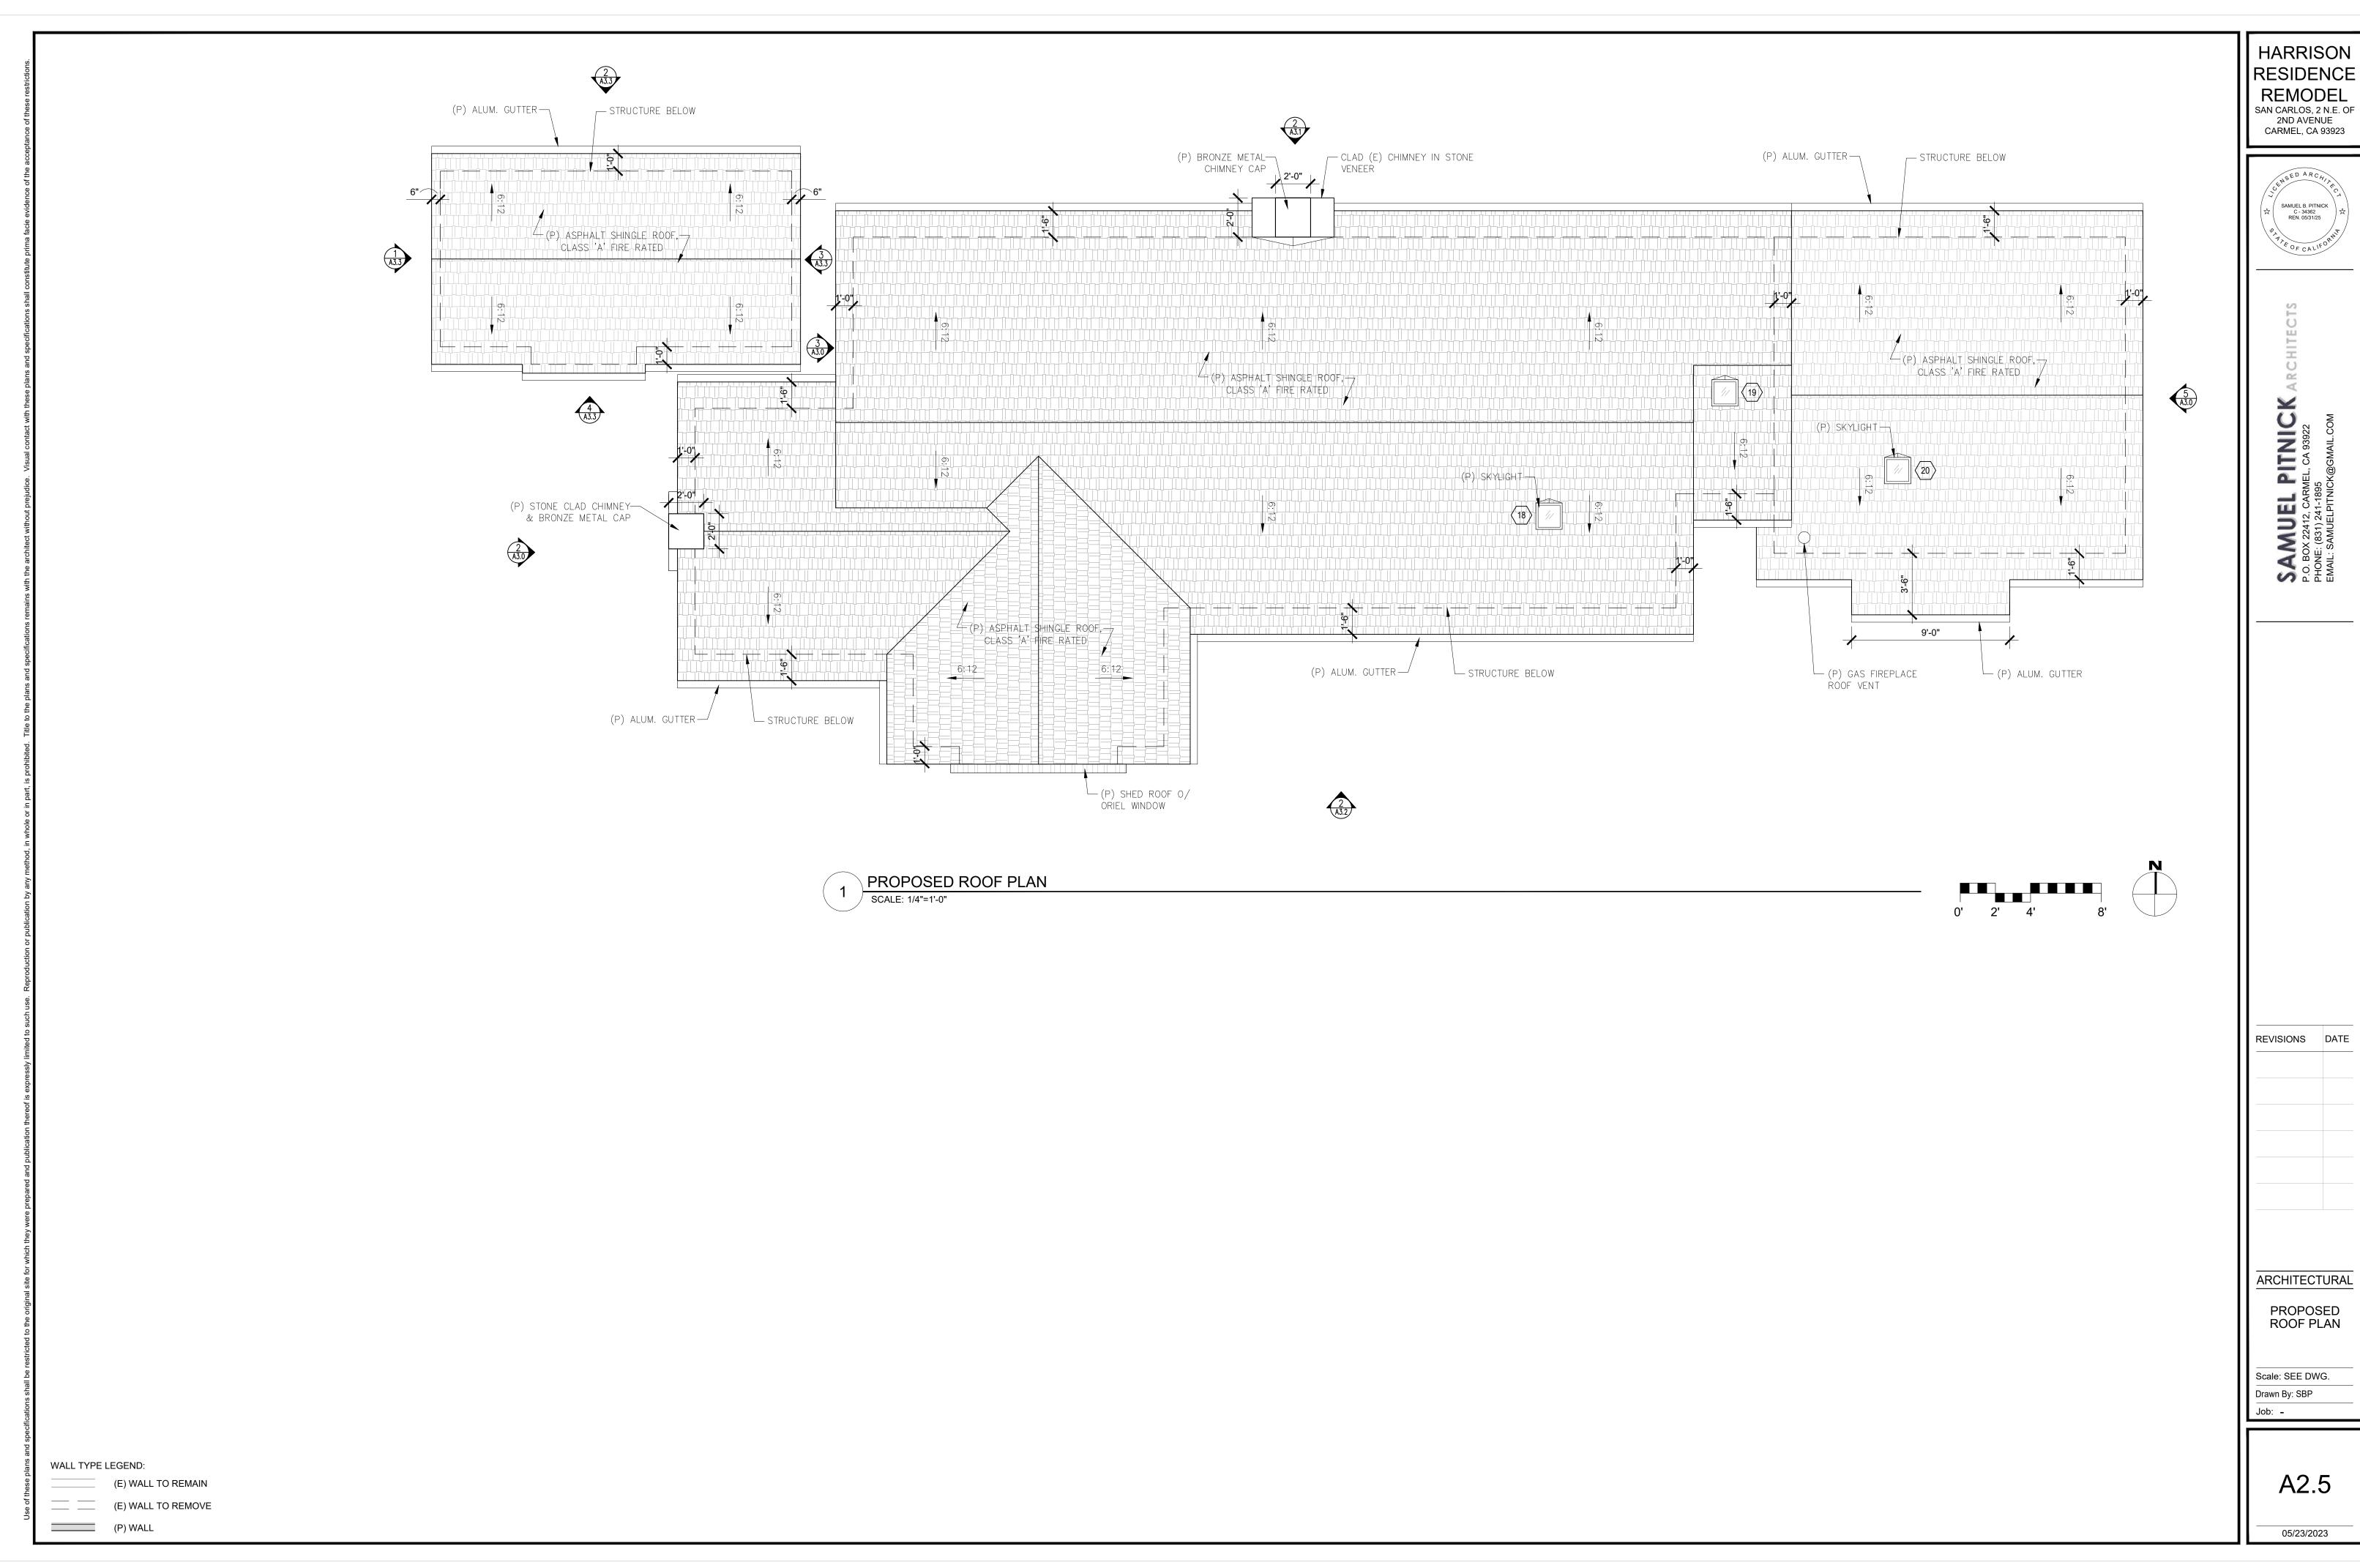

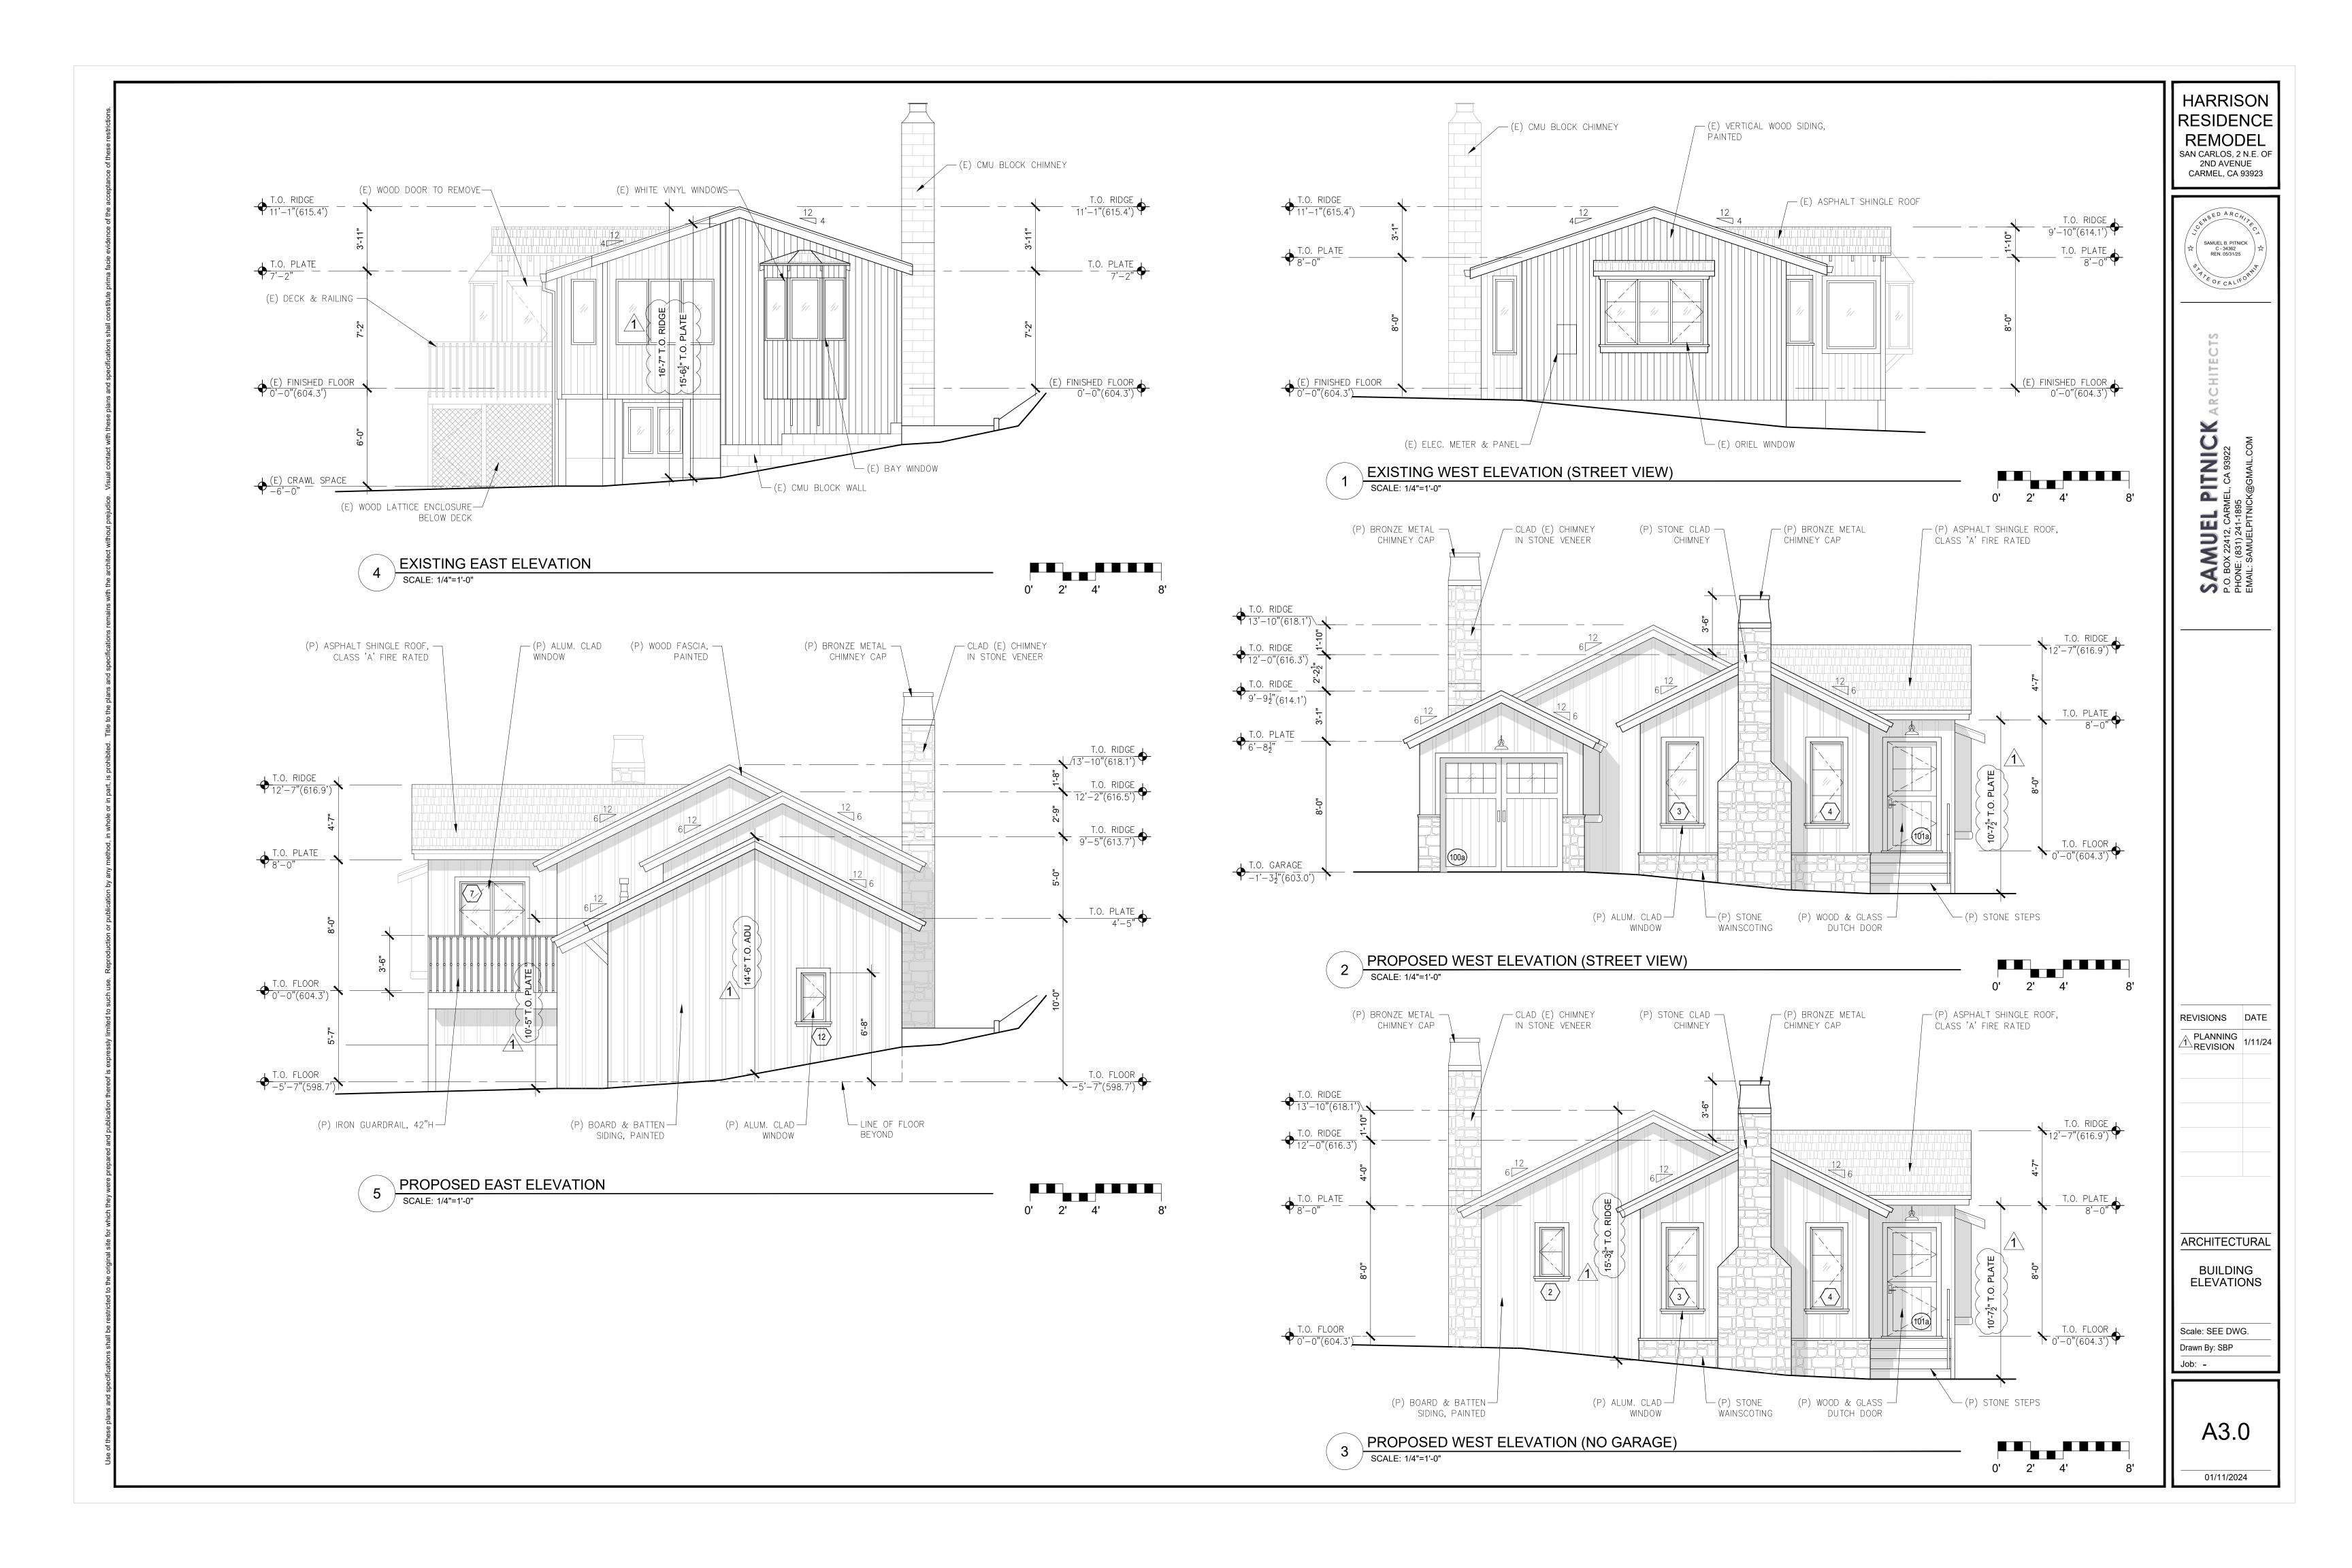

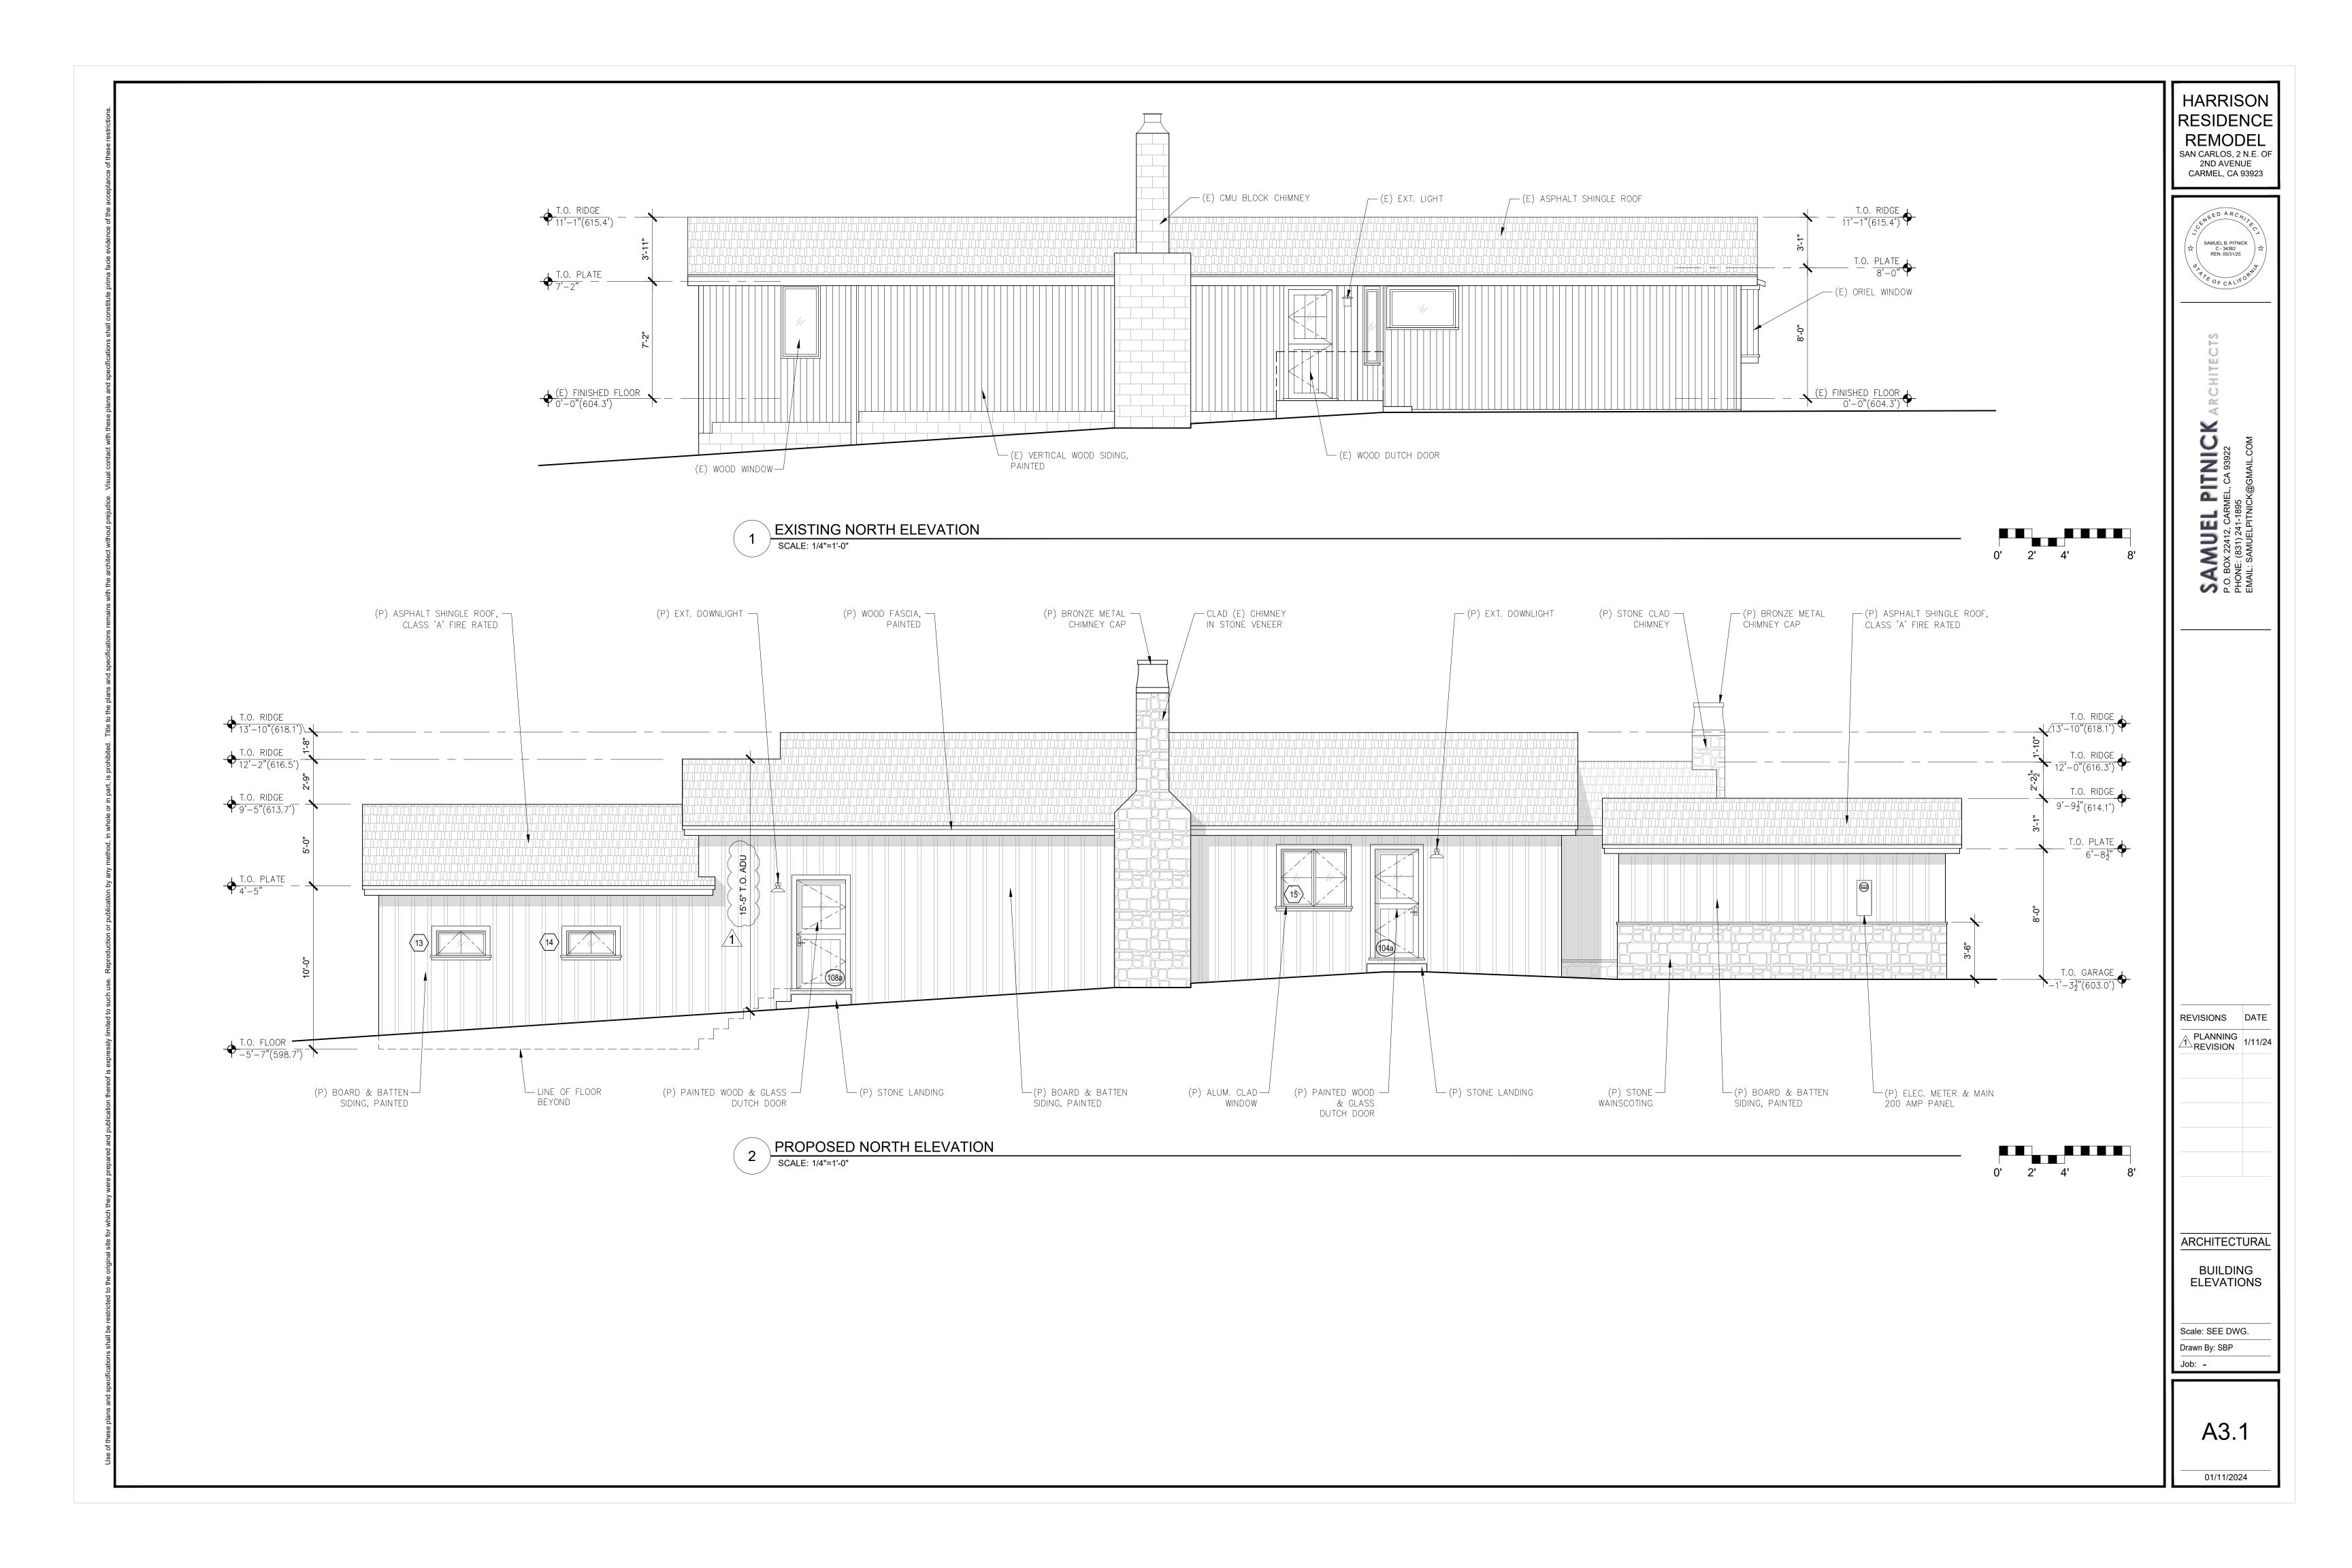

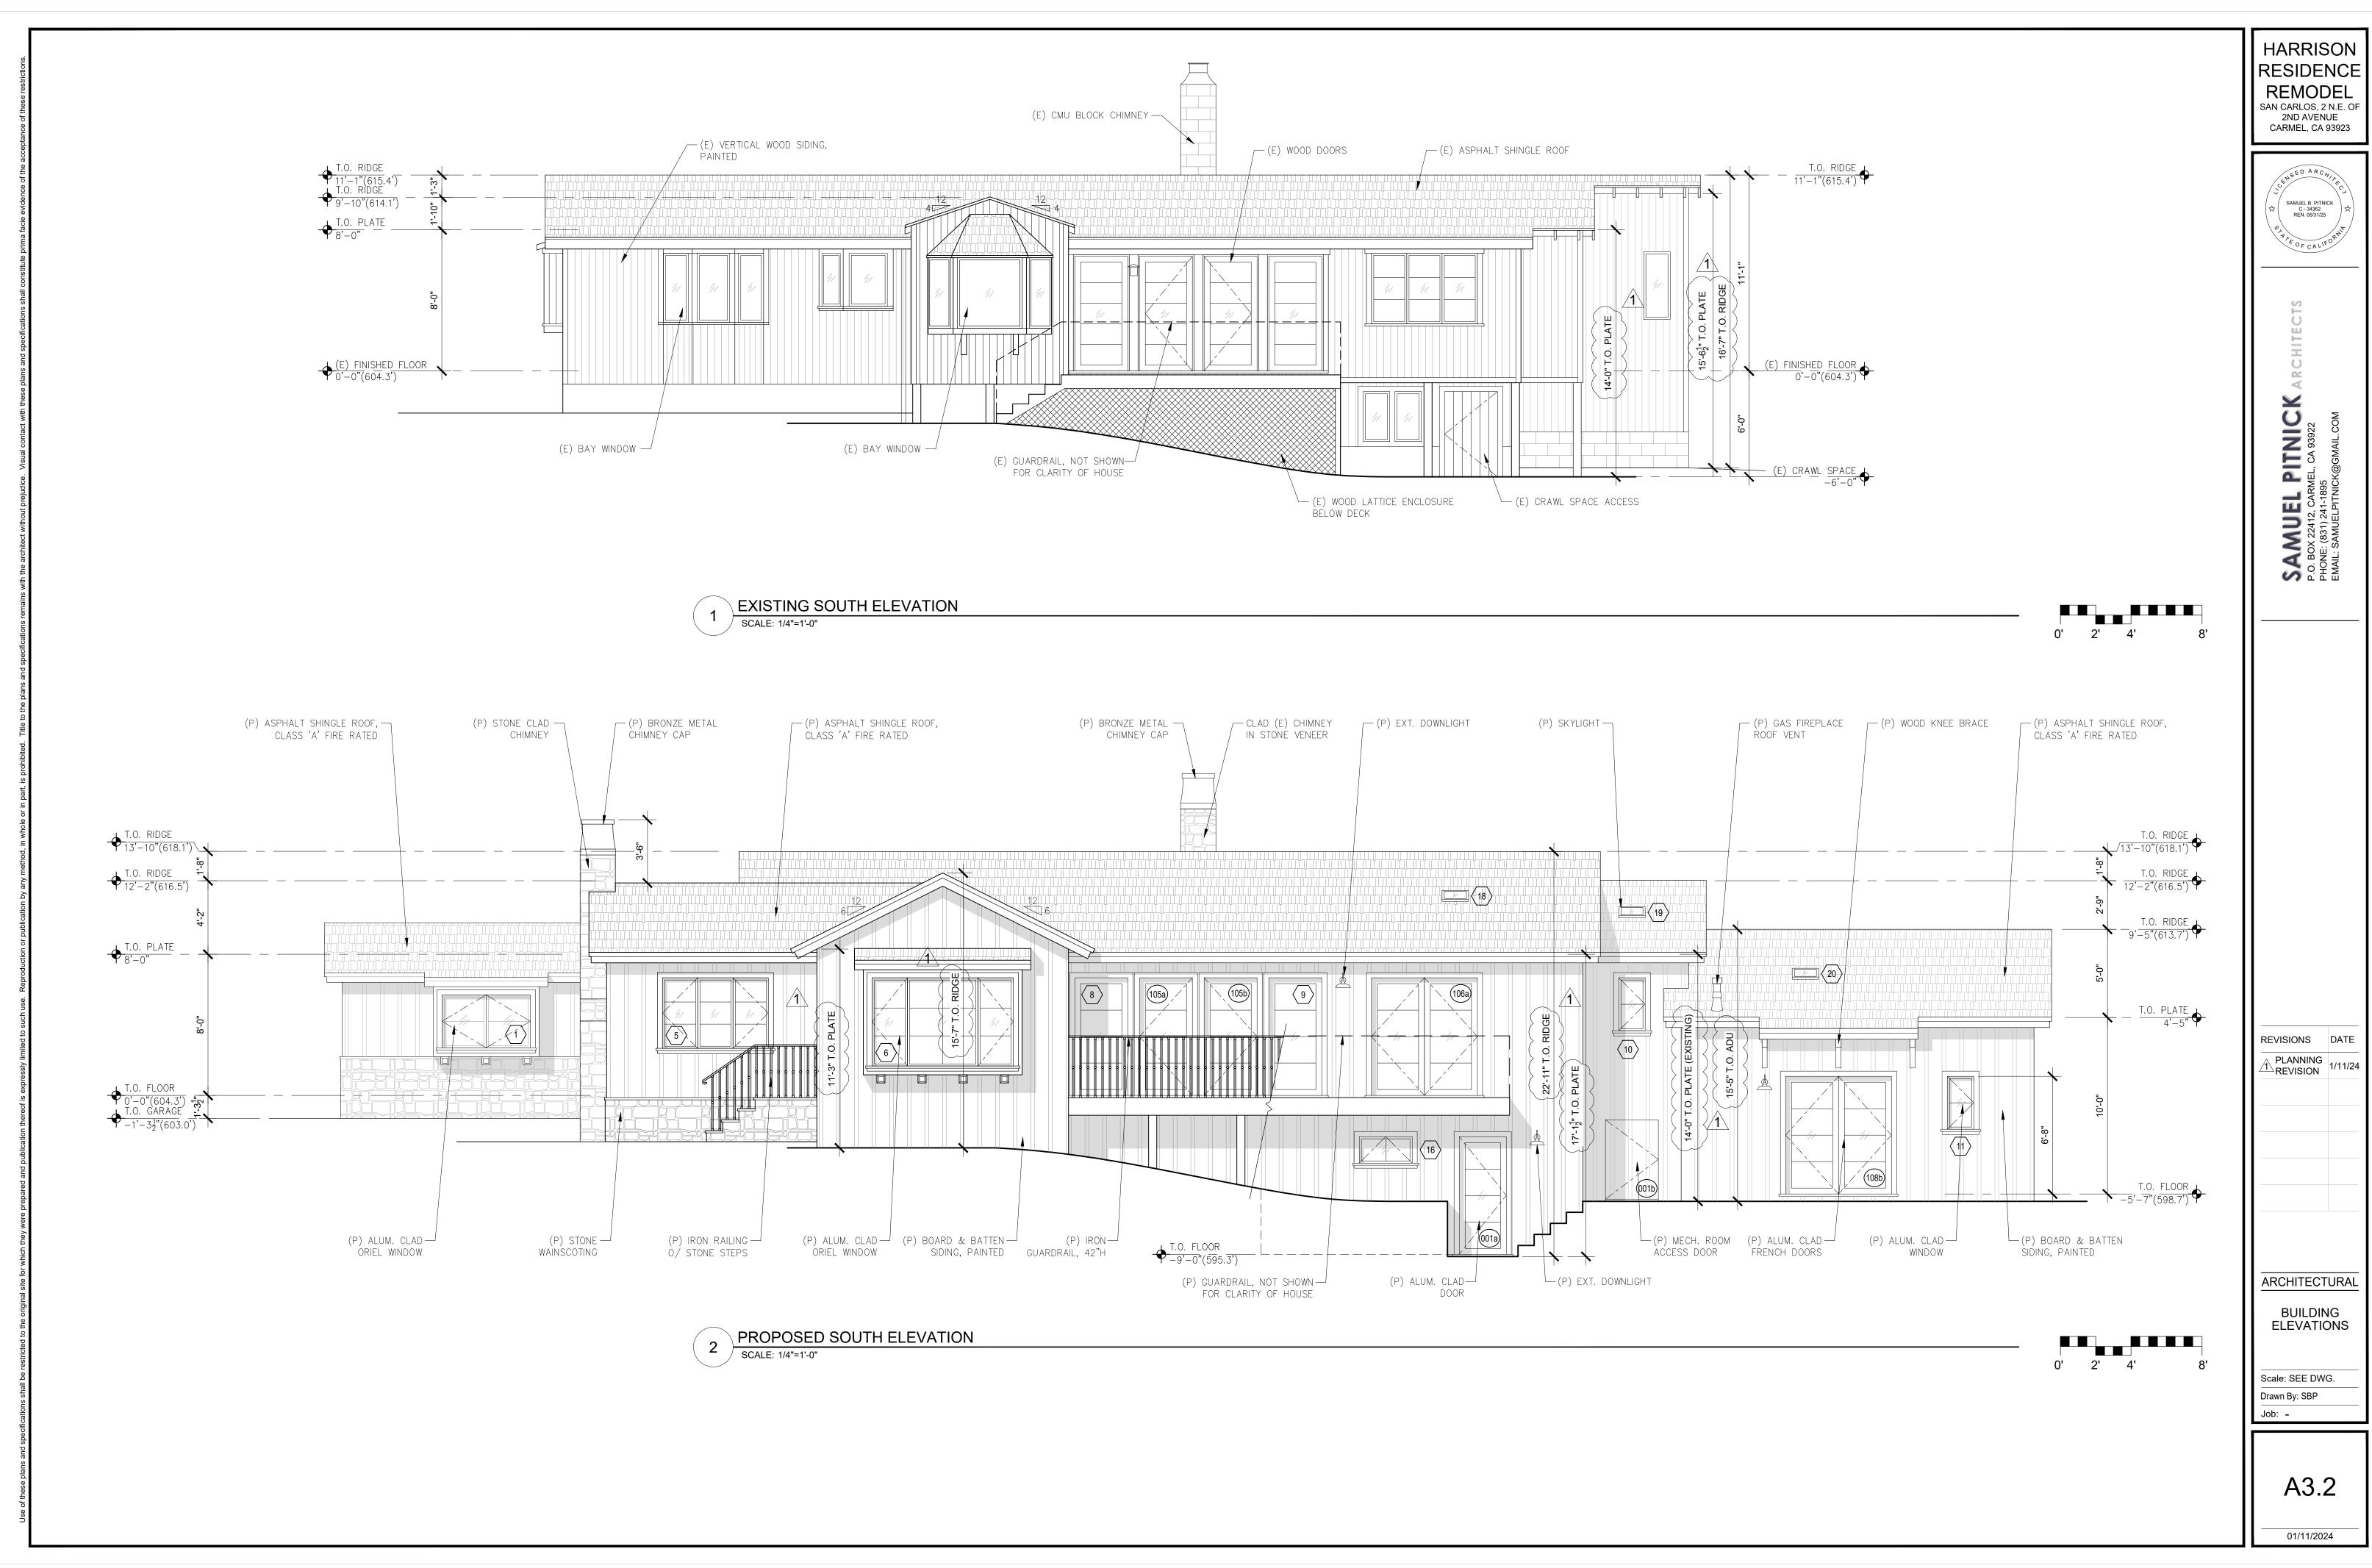

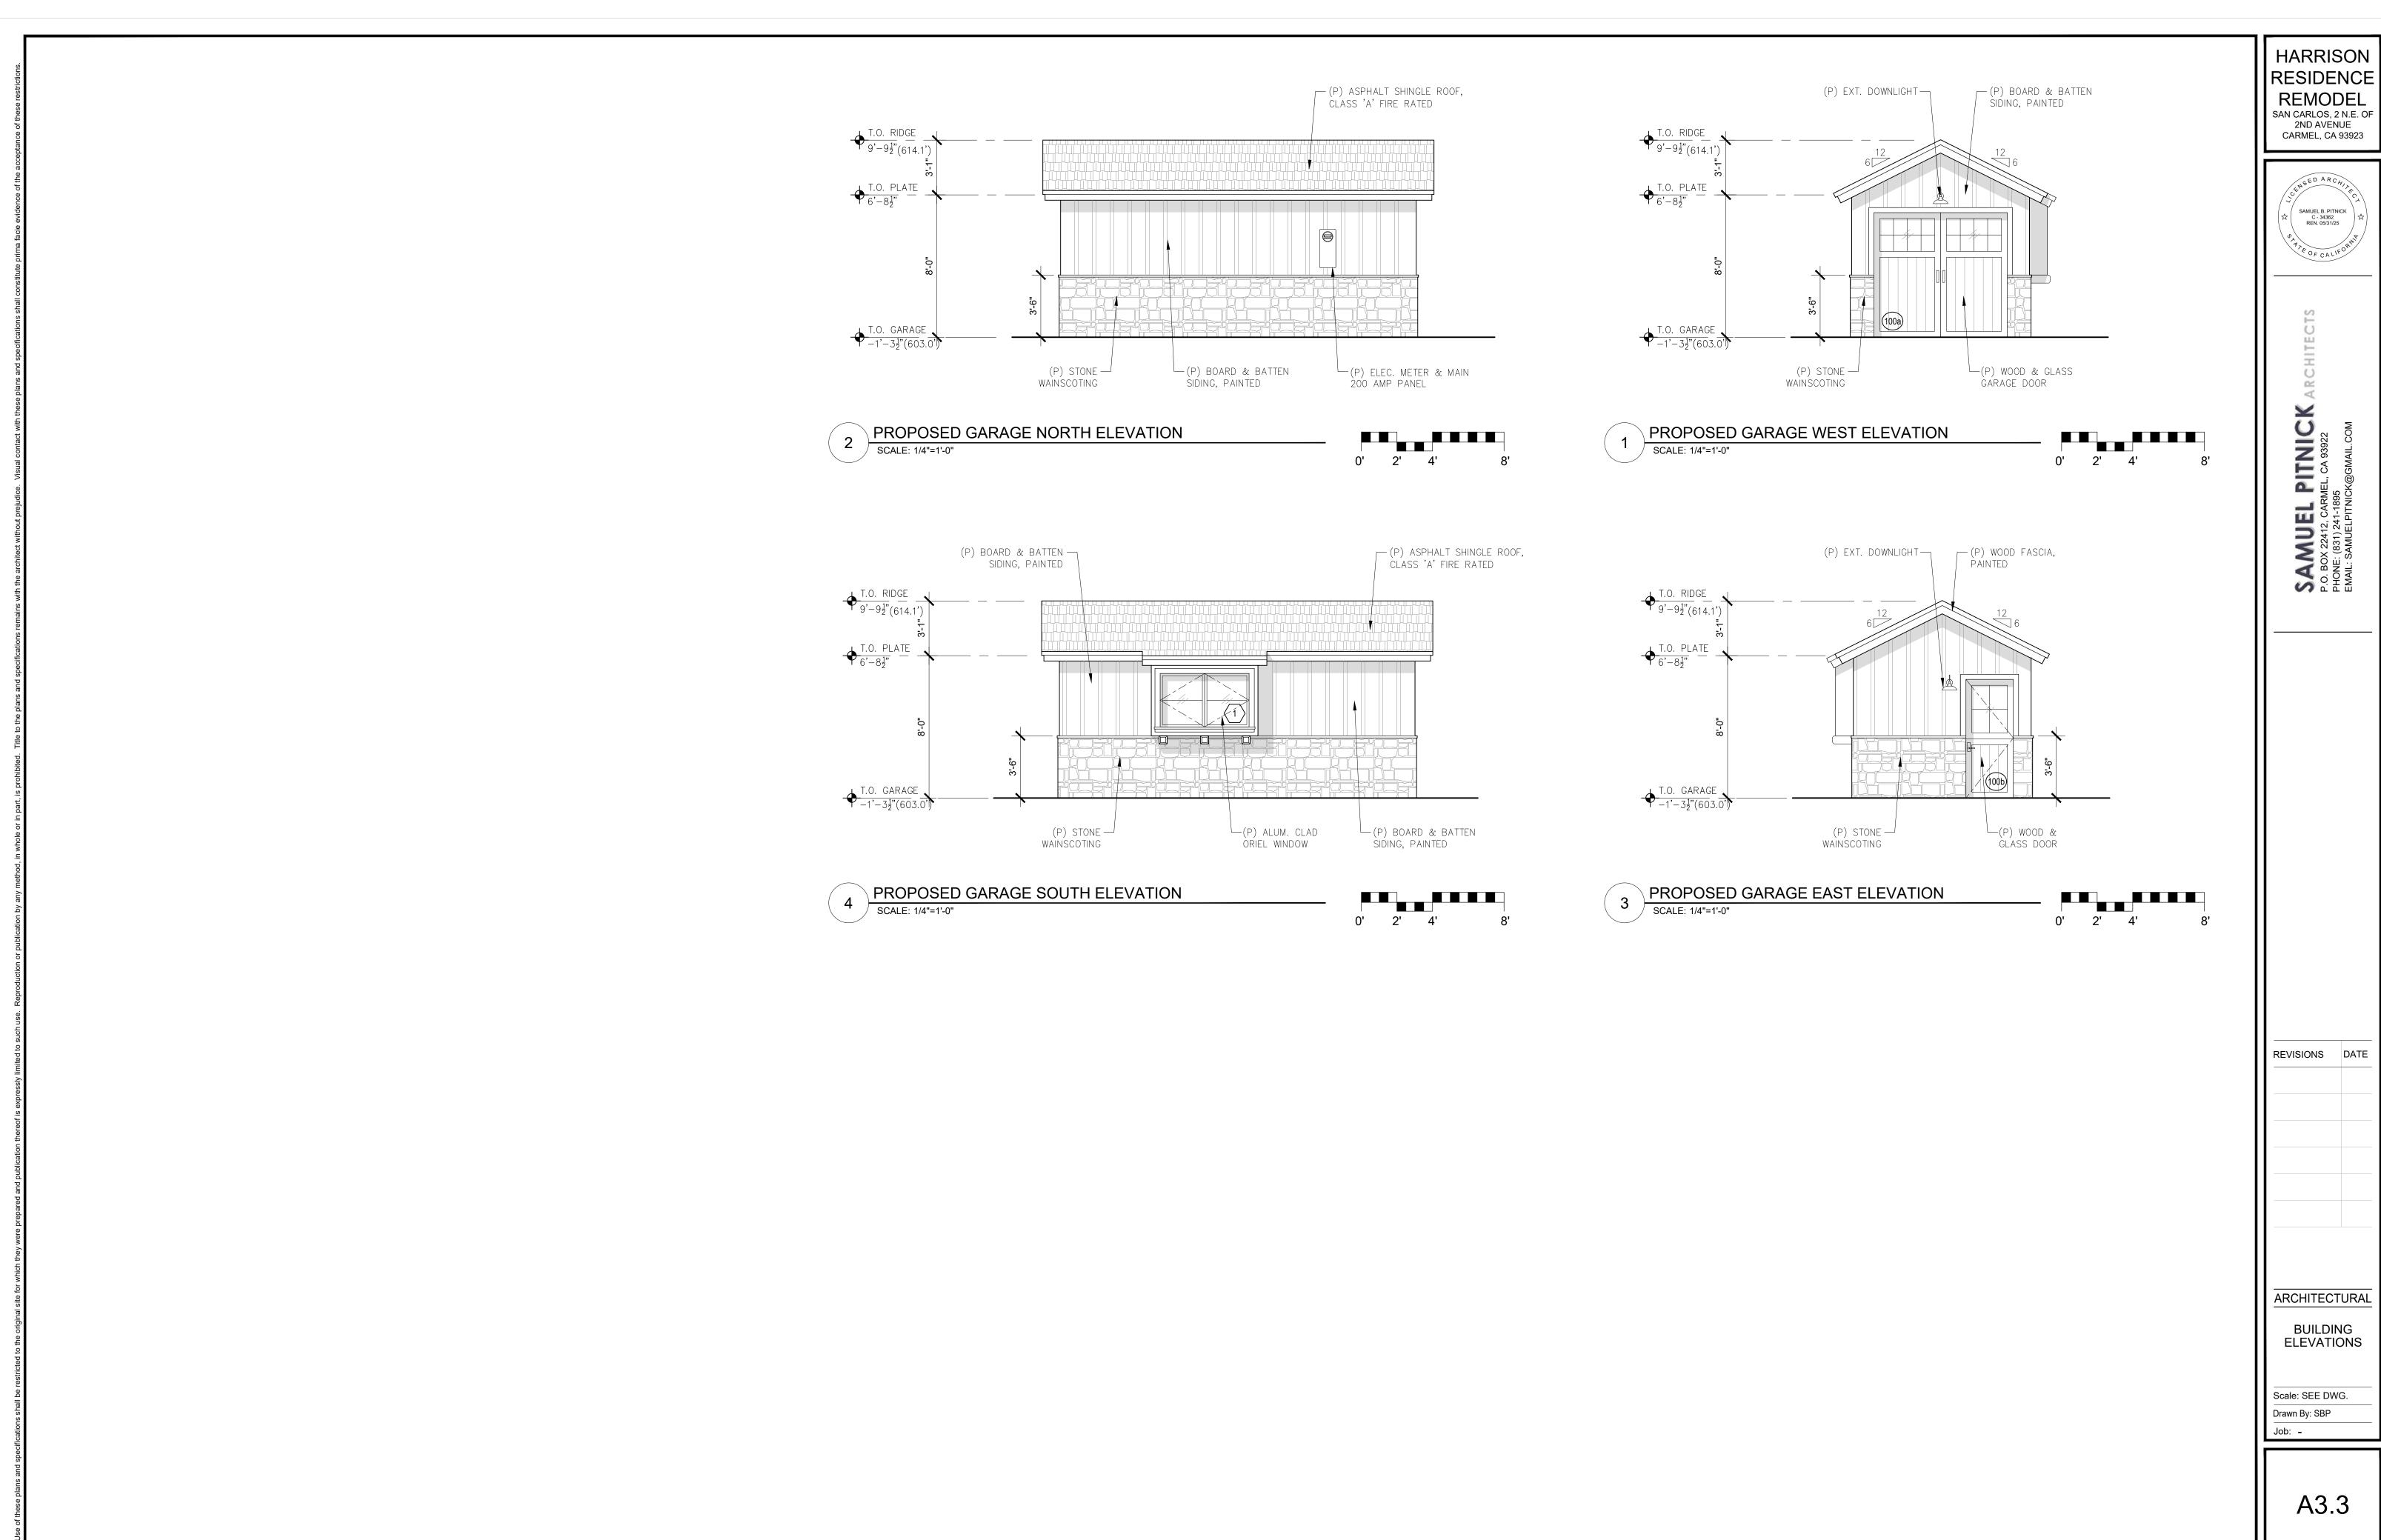

VELUX[®]

VELUX INTEGRA® Solar DSC/DSD/DSH











VELUX INTEGRA® **KLI 110**



ENGLISH: Instructions for control keypad ESPAÑOL: Instrucciones para el teclado de control FRANÇAIS: Instructions pour le bloc numérique 日本語: リモコンKLI 110の取扱説明書







				EXTERIOR	R DOOR SCHED	ULE	
TAG	WIDTH	HEIGHT	THICK	DOOR MTL.	FRAME MTL.	TYPE	COMMENTS
001a	2'-8"	6'-8"	-	ALUM. CLAD/GLASS	ALUM. CLAD	SWING	TEMPERED GLAZING
001b	3'-0"	4'-6"	-	WOOD	WOOD	SWING	TO MATCH SIDING
100a	7'-6"	7'-0"	-	WOOD/GLASS	WOOD	GARAGE, SECTIONAL	STAINED WOOD,
							TEMPERED GLAZING
100b	2'-8"	6'-8"	-	WOOD/GLASS	WOOD	SWING	TEMPERED GLAZING
101a	3'-0"	6'-8"	-	WOOD/GLASS	WOOD	DUTCH	STAINED WOOD,
							TEMPERED GLAZING
104a	2'-8"	6'-8"	-	WOOD/GLASS	WOOD	DUTCH	TEMPERED GLAZING
105a	3'-0"	6'-8"	-	ALUM. CLAD/GLASS	ALUM. CLAD	SWING	TEMPERED GLAZING
105b	3'-0"	6'-8"	-	ALUM. CLAD/GLASS	ALUM. CLAD	SWING	TEMPERED GLAZING
106a	6'-0"	6'-8"	-	ALUM. CLAD/GLASS	ALUM. CLAD	FRENCH	TEMPERED GLAZING
108a	3'-0"	6'-8"	-	WOOD/GLASS	WOOD	DUTCH	TEMPERED GLAZING
108b	6'-0"	6'-8"	-	ALUM. CLAD/GLASS	ALUM. CLAD	FRENCH	TEMPERED GLAZING
						<u> </u>	

				INTERIOR	DOOR SCHED	ULE	
TAG	WIDTH	HEIGHT	THICK	DOOR MTL.	FRAME MTL.	TYPE	COMMENTS
101b	1'-6"	6'-8"	1.75"	WOOD	WOOD	SWING	
102a	5'-0"	6'-8"	1.75"	WOOD	WOOD	POCKETING	
102b	2'-0"	6'-8"	1.75"	WOOD	WOOD	SWING	
103a	2'-4"	6'-8"	1.75"	WOOD	WOOD	SWING	
106b	2'-8"	6'-8"	1.75"	WOOD	WOOD	SWING	
106c	6'-0"	6'-8"	1.75"	WOOD	WOOD	BI-PASS	
107a	2'-4"	6'-8"	1.75"	WOOD	WOOD	SWING	
108c	2'-4"	6'-8"	1.75"	WOOD	WOOD	SWING	
109a	2'-4"	6'-8"	1.75"	WOOD	WOOD	SWING	

WINDOW SCHEDULE							
TAG	WIDTH	HEIGHT	THICK	WINDOW MTL.	FRAME MTL.	TYPE	COMMENTS
1	5'-0"	3'-0"		GLASS	ALUM. CLAD	CASEMENT	TEMPERED GLAZING
2	1'-6"	3'-0"		GLASS	ALUM. CLAD	CASEMENT	TEMPERED GLAZING
3	2'-0"	5'-0"		GLASS	ALUM. CLAD	CASEMENT	TEMPERED GLAZING
4	2'-0"	5'-0"		GLASS	ALUM. CLAD	CASEMENT	TEMPERED GLAZING
5	6'-0"	4'-0"		GLASS	ALUM. CLAD	X-O-X	TEMPERED GLAZING,
							REUSE EXISTING
6	8'-0"	5'-0"		GLASS	ALUM. CLAD	X-O-X	TEMPERED GLAZING
7	4'-0"	4'-0"		GLASS	ALUM. CLAD	CASEMENT	TEMPERED GLAZING
8	3'-0"	6'-8"		GLASS	ALUM. CLAD	FIXED	TEMPERED GLAZING
9	3'-0"	6'-8"		GLASS	ALUM. CLAD	FIXED	TEMPERED GLAZING
10	1'-6"	3'-0"		GLASS	ALUM. CLAD	CASEMENT	TEMPERED GLAZING
11	1'-6"	3'-0"		GLASS	ALUM. CLAD	CASEMENT	TEMPERED GLAZING
12	1'-6"	3'-0"		GLASS	ALUM. CLAD	CASEMENT	TEMPERED GLAZING
13	3'-0"	1'-6"		GLASS	ALUM. CLAD	AWNING	TEMPERED GLAZING
14	3'-0"	1'-6"		GLASS	ALUM. CLAD	AWNING	TEMPERED GLAZING
15	4'-0"	3'-6"		GLASS	ALUM. CLAD	CASEMENT	TEMPERED GLAZING
16	3'-0"	1'-6"		GLASS	ALUM. CLAD	AWNING	TEMPERED GLAZING
17	3'-0"	1'-6"		GLASS	ALUM. CLAD	AWNING	TEMPERED GLAZING
18	1'-6"	1'-6"		GLASS	ALUM.	SKYLIGHT	TEMPERED GLAZING
19	1'-6"	1'-6"		GLASS	ALUM.	SKYLIGHT	TEMPERED GLAZING
20	1'-6"	1'-6"		GLASS	ALUM.	SKYLIGHT	TEMPERED GLAZING



PROPOSED SKYLIGHT BY 'VELUX'

WINDOW & EXTERIOR DOOR NOTES

1. WINDOWS & DOORS ARE BY 'SIERRA PACIFIC' (OR APPV'D EQUAL) GLAZING: DUAL GLAZING, ARGON GAS, LOWE2 MTL: ALUM. CLAD EXTERIOR - GRAY

PAINT GRADE INTERIOR

2. CONTRACTOR TO VERIFY ROUGH OPENING DIMENSIONS WITH ON SITE FIELD CONDITIONS PRIOR TO ORDERING WINDOWS & DOORS.

3. ALL DIMENSIONS ARE GIVEN FOR OVERALL FRAME SIZE

ALL HEAD HEIGHTS TO ALIGN WHERE POSSIBLE ALL OPERABLE WINDOWS TO BE PROVIDED WITH SCREENS.

6. REQUIRED SAFETY GLAZING SHALL CONFIRM TO THE HUMAN IMPACT LOADS PER CRC SECTIONS R308.3 & R308.4.

7. GLAZING SHALL BE TEMPERED IN AN INDIVIDUAL FIXED OR OPERABLE PANEL THAT MEETS ALL OF THE FOLLOWING CONDITIONS: (A) THE EXPOSED AREA OF AN INDIVIDUAL PANE IS LARGER

THAN 9 SQUARE FEET; AND

(B) THE BOTTOM EDGE OF THE GLAZING IS LESS THAN 18 INCHES ABOVE THE FLOOR; AND

(C) THE TOP EDGE OF THE GLAZING IS MORE THAN 36 INCHES ABOVE THE FLOOR; AND

(D) ONE OR MORE WALKING SURFACES ARE WITHIN 36 INCHES, MEASURED HORIZONTALLY AND IN A STRAIGHT LINE OF THE

GLAZING; AND (E) GLAZING IN ENCLOSURES FOR, OR WALLS FACING BATHTUBS & SHOWERS WHERE THE BOTTOM EDGE OF THE GLAZING IS LESS THAN 60 INCHES MEASURED VERTICALLY ABOVE ANY STANDING OR WALKING SURFACE.

(F) FIXED AND OPERABLE PANELS OF SWINGING, SLIDING, AND BI-FOLD DOOR ASSEMBLIES.

- 8. GLAZING SHALL BE TEMPERED IN AN INDIVIDUAL FIXED OR OPERABLE PANEL ADJACENT TO A DOOR WHERE THE NEAREST VERTICAL EDGE IS WITHIN A 24-INCH ARC OF THE DOOR IN A CLOSED POSITION AND WHOSE BOTTOM EDGE IS LESS THAN 60 INCHES ABOVE THE FLOOR OR WALKING SURFACE.
- 9. CONTRACTOR TO PROVIDE SHOP DRAWING TO ARCHITECT FOR REVIEW PRIOR TO ORDERING DOORS AND WINDOWS.
- 10. ALL WINDOWS TO BE DUAL GLAZED ARGON FILLED WITH THERMAL SPACER
- 11. MIN. U-VALUE & SGHC = SEE TITLE 24 REPORT
- 12. EXTERIOR WINDOWS AND EXTERIOR GLAZED DOORS SHALL BE MULTIPANE GLAZING WITH A MINIMUM OF ONE TEMPERED PANE, GLASS BLOCK UNITS, HAVE A FIRE RESISTANCE RATING OF 20 MINUTES WHEN TESTED IN ACCORDANCE WITH NFPA 257, OR MEET THE REQUIREMENTS OF SFM 12-7A-2. [§R327.8.2.1]
- 13. EXTERIOR DOORS SHALL BE OF APPROVED NONCOMBUSTIBLE CONSTRUCTION OR IGNITIONRESISTANT MATERIAL, SOLID CORE WOOD HAVING STILES AND RAILS NOT LESS THAN 1-3/8 INCHES THICK WITH INTERIOR FIELD PANEL THICKNESS NO LESS THAN 1-1/4 INCHES THICK, SHALL HAVE A FIRE-RESISTANCE RATING OF NOT LESS THAN 20 MINUTES WHEN TESTED ACCORDING TO NFPA 252, OR MEET THE REQUIREMENTS OF SFM-7A-1. [§R327.8.3]


SKYLIGHT NOTES

- SKYLIGHTS ARE BY "VELUX" (OR APPV'D EQUAL)
- 2. SKYLIGHTS SHALL HAVE SOLAR SHADING DEVICES INSTALLED.
- 3. SKYLIGHTS SHALL USE NON-REFLECTIVE GLASS TO MINIMIZE THE AMOUNT OF LIGHT AND GLARE VISIBLE FROM ADJOINING PROPERTIES.
- 4. SKYLIGHTS SHALL BE FLAT IN PROFILE.
- 5. SKYLIGHT FLASHING SHALL MATCH THE ADJACENT ROOF COLOR.

INTERIOR DOOR NOTES

- 1. INTERIOR DOORS TO BE SOLID PANEL, PAINT GRADE, 1.75" THK., UNLESS NOTED OTHERWISE.
- 2. INTERIOR DOORS TO BE PAINTED WHITE UNLESS NOTED OTHERWISE.
- 3. VERIFY INTERIOR DOOR PROFILE WITH OWNER.

HARRISON RESIDENCE REMODEL SAN CARLOS, 2 N.E. OF 2ND AVENUE CARMEL, CA 93923

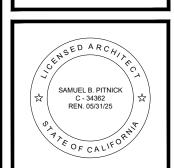

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N P E

REVISIONS DATE

ARCHITECTURAL

DOOR & WINDOW **SCHEDULES**

Scale: SEE DWG. Drawn By: SBP

A4.0