

WITT RESIDENCE

Carmelo 2 NW of 9th Street

Carmel by the Sea, California, CA 93921

| | |
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| REVISION | No. |
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| | |
| | |

CONSULTANT:



ERIC MILLER ARCHITECTS, INC.
 211 HOFFMAN AVENUE MONTEREY, CA 93940
 PHONE (831) 372-0410 • FAX (831) 372-7840 • WEB: www.ericmillerarchitects.com

ARCHITECT

COVER SHEET

JOB NAME: **Witt Residence**
 Carmelo 2NW of 9th Street
 Carmel By-The-Sea, CA
 APN: 010-269-005-000

DATE: 6/5/19
 SCALE: N.T.S.
 DRAWN: DM
 JOB NUMBER: 17.20

A-0.1
 SHEET OF

GENERAL NOTES

- CONTRACTOR LICENSE:** THE CONTRACTOR(S) PERFORMING THE WORK DESCRIBED BY THESE PLANS AND SPECIFICATIONS SHALL BE PROPERLY AND CURRENTLY LICENSED DURING THE EXECUTION OF THE PROJECT AND SHALL NOT PERFORM WORK OUTSIDE THE LEGAL SCOPE OF ANY LICENSE.
- SCOPE:** THE CONTRACTOR SHALL PROVIDE AND PAY FOR ALL LABOR, MATERIALS, TOOLS, EQUIPMENT AND MACHINERY, TRANSPORTATION, WATER, HEAT, ELECTRICAL, TELEPHONE, AND ANY OTHER RELATED ITEMS NECESSARY FOR THE PROPER EXECUTION AND TIMELY COMPLETION OF THE WORK.
- QUALITY CONTROL:** IT IS THE EXPRESS INTENTION OF THESE PLANS AND SPECIFICATIONS TO REQUIRE A HIGH STANDARD OF WORK. IF, IN THE OPINION OF THE CONTRACTOR, ANY PORTION OF THE DOCUMENTATION HEREIN IS INCONSISTENT WITH THIS, THE OWNER AND THE ARCHITECT SHALL BE NOTIFIED PRIOR TO EXECUTING THE WORK AND ALLOWED REVISION TIME IF FELT NECESSARY.
- WARRANTY:** THE CONTRACTOR WARRANTS TO THE OWNER THAT ALL MATERIALS AND EQUIPMENT FURNISHED UNDER THIS CONTRACT WILL BE NEW UNLESS OTHERWISE SPECIFIED, AND THAT ALL WORK WILL BE OF GOOD QUALITY, FREE FROM FAULTS AND DEFECTS, AND IN CONFORMANCE WITH THE CONTRACT DRAWINGS AND SPECIFICATIONS.
- PERMITS:** UNLESS OTHERWISE INSTRUCTED, THE OWNER SHALL PAY ALL PERMIT FEES INCLUDING UTILITIES. THE CONTRACTOR SHALL SECURE THE BUILDING PERMIT AND ANY OTHER PERMITS PRIOR TO STARTING THE WORK AND COMPLY WITH ALL INSPECTION REQUIREMENTS THROUGH FINAL SIGN-OFF.
- LEGAL/NOTICES/CODE COMPLIANCE:** THE CONTRACTOR SHALL GIVE ALL NOTICES AND COMPLY WITH ALL LAWS, ORDINANCES, BUILDING CODES, RULES, REGULATIONS AND OTHER LAWFUL ORDERS OF ANY PUBLIC AUTHORITY BEARING ON THE PERFORMANCE OF THE WORK. THE CONTRACTOR SHALL PROMPTLY NOTIFY THE ARCHITECT IN WRITING IF THE DRAWINGS AND/OR SPECIFICATIONS ARE AT VARIANCE WITH ANY SUCH REQUIREMENTS. (2016 C.B.C.)
- CONSTRUCTION RESPONSIBILITY:** THE CONTRACTOR SHALL BE SOLELY RESPONSIBLE FOR ALL CONSTRUCTION MEANS, METHODS, TECHNIQUES, SEQUENCES AND PROCEDURES SELECTED TO EXECUTE THE WORK. THE CONTRACTOR SHALL COORDINATE ALL PORTIONS OF WORK WITHIN THE SCOPE OF THE CONTRACT.
- JOB SITE SAFETY:** THE CONTRACTOR SHALL BE RESPONSIBLE FOR INITIATING, MAINTAINING AND PROPERLY SUPERVISING ADEQUATE INDUSTRY STANDARD SAFETY PRECAUTIONS AND PROGRAMS IN CONNECTION WITH THIS WORK.
- INSURANCE:** LIABILITY INSURANCE SHALL BE MAINTAINED BY THE CONTRACTOR TO PROTECT AGAINST ALL CLAIMS UNDER WORKMAN'S COMPENSATION ACTS, DAMAGES DUE TO BODILY INJURY INCLUDING DEATH, AND FOR ANY PROPERTY DAMAGES ARISING OUT OF OR RESULTING FROM THE CONTRACTOR'S OPERATIONS UNDER THE CONTRACT. THIS INSURANCE SHALL BE FOR LIABILITY LIMITS SATISFACTORY TO THE OWNER. THE OWNER HAS THE RIGHT TO REQUIRED CONTRACTUAL LIABILITY INSURANCE APPLICABLE TO THE CONTRACTOR'S OBLIGATIONS. CERTIFICATES OF SUCH INSURANCE SHALL BE FILED WITH THE OWNER PRIOR TO THE COMMENCEMENT OF WORK.
- INDEMNIFICATION:** THE CONTRACTOR WHO AGREES TO PERFORM THIS WORK ALSO AGREES TO INDEMNIFY AND HOLD HARMLESS THE OWNER AND THE ARCHITECT FROM AND AGAINST ALL CLAIMS, DAMAGES, LOSSES AND EXPENSES, INCLUDING ATTORNEY'S FEES AND LITIGATION COSTS, ARISING OUT OF OR RESULTING FROM THE PERFORMANCE OF THE WORK.
- CLEANING UP:** THE CONTRACTOR SHALL KEEP THE PREMISES AND SITE FREE FROM ACCUMULATION OF WASTE MATERIALS DURING CONSTRUCTION BY PERIODIC CLEAN UP AND OFF-SITE DEBRIS REMOVAL. FINAL CLEANUP AND DEBRIS DISPOSITION SHALL BE TO THE SATISFACTION OF THE OWNER.
- EXISTING CONDITION:** CONTRACTOR SHALL VISIT THE SITE AND VERIFY ALL EXISTING CONDITIONS PRIOR TO ANY WORK AND NOTIFY THE ARCHITECT OF ANY DISCREPANCIES BETWEEN THESE DRAWINGS CONDITION AND EXISTING AFFECTING THE WORK OR NATURE OF SPECIFIED MATERIALS AND/OR SCOPE OF DESIGN.
- CONSTRUCTION NOTES:** ALL NOTES, DIMENSIONS, ETC. INDICATE NEW MATERIALS OR CONSTRUCTION UNLESS OTHERWISE NOTED.
- BUILDING CODES:** THIS PROJECT SHALL COMPLY WITH THE TITLE 24 AND 2016 CALIFORNIA RESIDENTIAL CODE (CRC), CALIFORNIA BUILDING CODE (CBC), CALIFORNIA MECHANICAL CODE (CMC), CALIFORNIA PLUMBING CODE (CPC), CALIFORNIA ELECTRICAL CODE (CEC), CALIFORNIA ENERGY CODE (CEC), CALIFORNIA FIRE CODE (CFC), CALIFORNIA GREEN BUILDING CODE (CGBC) AND CALIFORNIA TITLE 24 ENERGY CODE.

PROJECT DATA

ADDRESS: CARMELO 2 NW OF 9TH STREET
CARMELO BY THE SEA, CA 93921

PROJECT DESCRIPTION: CONSTRUCTION OF A NEW SINGLE FAMILY DWELLING WITH BASEMENT & ATTACHED GARAGE. CONSIST OF: 348 S.F. BASEMENT, 320 S.F. LOWER FLOOR and 1,322 S.F. MAIN FLOOR.

LOT SIZE: 4,000.0 S.F.

ZONING: RI

A.P.N.: 010-269-005-000

TYPE OF CONSTRUCTION: (V-B)

SETBACK

FRONT 15' MAX.
 REAR 15' MAX.
 SIDE 25% OF LOT WIDTH - 10' MAX.

BUILDING HEIGHT— ONE STORY PLATE HT. - 12'
 2ND STORY PLATE HT. - 10'
 MAX ROOF HT. - 24.0'

| | |
|-------------------------|-------------------|
| LOT AREA | 4,000 S.F. |
| BASE FLOOR AREA ALLOWED | 1,800 S.F. |
| MAIN FLOOR AREA | 1,322 S.F. |
| LOWER FLOOR AREA | 320 S.F. |
| BASEMENT FLOOR AREA | 398 S.F. |
| TOTAL | 2,040 S.F. |

F.A.R. FLOOR AREA CALCULATIONS

BASEMENT = 398 S.F.
 - 100 S.F. (BASEMENT BONUS)
 = 298 S.F.
 298 S.F. / 2 = 149 SF. (BASEMENT COUNTED AS HALF)

1,800 SF. - 149 SF. = 1,651 S.F. (MAIN FLOOR MAX F.A.R.)
 398 S.F. + 1,651 SF. = 2,049 SF.

PROJECT MAX. ALLOWABLE FLOOR AREA = 2,049 SF.

PROJECT TEAM

OWNER: DYLAN & NATASHA WITT
 3636 WASHOE STREET
 DAVIS, CA 95618
 PH: 530-304-0705

ARCHITECT: ERIC MILLER ARCHITECTS, INC.
 157 GRAND AVE. SUITE 106
 PACIFIC GROVE, CA 93950
 PH: 831-312-0410
 CONTACT: LUYEN VU

SURVEYOR: LANDSET ENGINEERING
 520-B CRAZY HORSE CANYON ROAD
 SALINAS, CA 93907
 PH: 831-443-6470
 CONTACT: GUY GIRAUDO

CIVIL: LANDSET ENGINEERING
 520-B CRAZY HORSE CANYON ROAD
 SALINAS, CA 93907
 PH: 831-443-6470
 CONTACT: GUY GIRAUDO

LANDSCAPE: BFS LANDSCAPE ARCHITECTS
 425 PACIFIC STREET #201
 MONTEREY, CALIFORNIA 93940
 PH: 831-646-1383
 CONTACT: SIMON PHILLIPS

ARBORIST: FRANK ONO
 1213 MILES AVENUE
 PACIFIC GROVE, CA 93950
 PH: 831-373-7086

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OWNERSHIP NOTES

- OWNERSHIP AND USE OF THESE DRAWINGS AND SPECIFICATIONS:
- TITLE AND ALL "COPYRIGHT" PRIVILEGES TO THESE DRAWINGS AND SPECIFICATIONS IS CLAIMED BY THE ARCHITECT, ERIC MILLER. HEREINAFTER REFERRED TO AS "THE ARCHITECT" WITHOUT PREJUDICE. VISUAL CONTACT WITH THESE SUBJECT DRAWINGS AND SPECIFICATIONS SHALL CONSTITUTE PRIMA FACIE EVIDENCE OF THE ACCEPTANCE OF THESE OWNERSHIP RIGHTS AND THE FOLLOWING RELATED.
 - THE USE OF THESE DRAWINGS AND SPECIFICATIONS SHALL BE SOLELY RESTRICTED TO THE ORIGINAL SITE FOR WHICH THEY WERE PREPARED AND THE ARCHITECT HEREBY STATES THAT THEY ARE NOT INTENDED FOR NOR SUITABLY ENGINEERED FOR ANY OTHER SITE. REPRODUCTION OF THESE DOCUMENTS IF THEREFORE EXPRESSLY LIMITED TO THIS INTENDED USE.
 - THE ARCHITECT DISCLAIMS ALL RESPONSIBILITY IF THESE DRAWINGS AND SPECIFICATIONS ARE USED, IN WHOLE OR IN PART, WITHOUT PRIOR WRITTEN PERMISSION, WHETHER OR NOT MODIFIED BY OTHERS FOR ANOTHER SITE.
 - IN THE EVENT OF UNAUTHORIZED USE BY ANY THIRD PARTY OF THESE DRAWINGS AND SPECIFICATIONS THE CLIENT FOR WHICH THIS WORK WAS ORIGINALLY PREPARED HEREBY AGREES TO HOLD HARMLESS, INDEMNIFY AND DEFEND THE ARCHITECT, ERIC MILLER, HIS STAFF/EMPLOYEES FROM ANY CLAIMS ARISING FROM SUCH UNAUTHORIZED USE.

TREE REMOVAL

THREE (3) TREES TO BE REMOVED: 7", 8" & 8" DIA. HOLLY TREE.


EXTERIOR LIGHTING NOTE

ALL EXTERIOR LIGHTING ATTACHED TO THE MAIN BUILDING OR ANY ACCESSORY BUILDING SHALL BE NO HIGHER THAN 10 FEET ABOVE GROUND AND NOT EXCEED 25 WATTS (INCANDESCENT EQUIVALENT) IN POWER PER FIXTURE.


SITE COVERAGE

| | |
|------------------------------|------------|
| ALLOWED | 556.0 S.F. |
| PROPOSED IMPERVIOUS COVERAGE | |
| ENTRY PORCH LANDING | 20.0 S.F. |
| EXTERIOR STAIRS & PORCH | 64.5 S.F. |
| LIGHT WELL WALLS | 22.0 S.F. |
| GARAGE DOOR STEPS & LANDING | 18.0 S.F. |
| SITE WALLS / RETAINING WALLS | 44.0 S.F. |
| MASTER BEDROOM PATIO | 110.0 S.F. |
| TOTAL IMPERVIOUS COVERAGE | 278.0 S.F. |
| PROPOSED PERVIOUS COVERAGE | |
| LIGHT WELLS | 60.0 S.F. |
| TRASH ENCLOSURE FLOOR | 30.0 S.F. |
| DRIVEWAY | 90.0 S.F. |
| STEPPING STONES & WALKWAYS | 48.0 S.F. |
| TOTAL IMPERVIOUS COVERAGE | 278.0 S.F. |
| TOTAL PROPOSED SITE COVERAGE | 556.0 S.F. |

LOCATION MAP

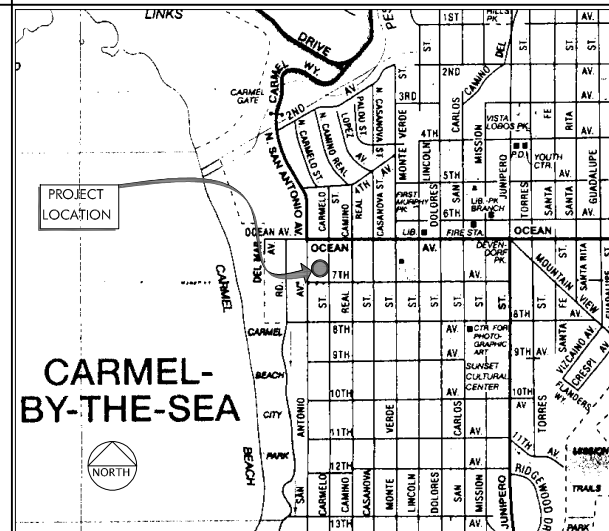

VICINITY MAP

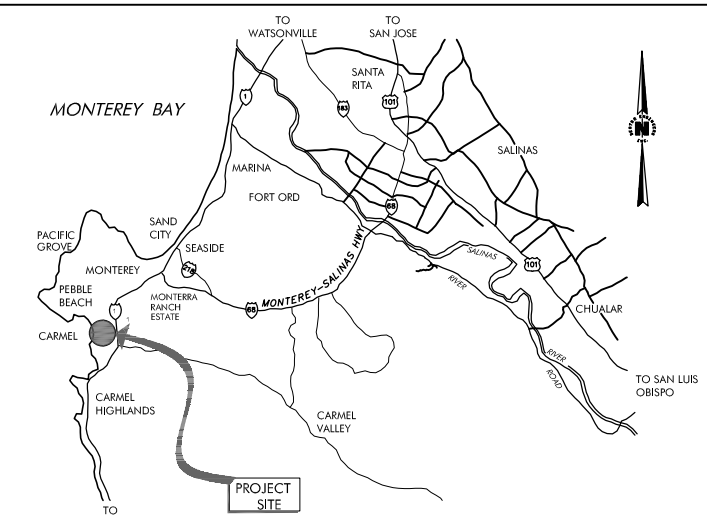



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GENERAL NOTES:

- ELEVATIONS ARE BASED ON AN ASSUMED DATUM. PROJECT BENCHMARK IS THE MOST SOUTHERLY CONTROL POINT #60 LOCATED AT THE EASTERLY EDGE OF PAVEMENT OF CARMELO STREET, ELEVATION=86.85', AS SHOWN.
- NOT ALL UNDERGROUND UTILITIES WERE LOCATED. ONLY VISIBLE FACILITIES ABOVE AND FLUSH WITH THE SURFACE ARE SHOWN. SUB-SURFACE UTILITY LINES DRAWN MAY NOT BE COMPLETE AND SHOULD BE VERIFIED BY FIELD RECONNAISSANCE. UNDERGROUND UTILITY LOCATIONS CAN BE OBTAINED FROM THE APPROPRIATE UTILITY COMPANIES, PUBLIC AGENCIES, OWNER'S AS-BUILT DRAWINGS, ETC., AND SHOULD BE THOROUGHLY COMPILED AND DEEMED COMPLETE WITHIN THE PROJECT AREA PRIOR TO ANY SITE DEVELOPMENT DESIGN AND/OR CONSTRUCTION.
- TREE TYPES ARE INDICATED WHEN KNOWN. TREE DIAMETERS ARE LABELED IN INCHES AS MEASURED AT 3" ABOVE THE GROUND. SYMBOL IS APPROXIMATE CENTER OF TREE. TREES SMALLER THAN 6" ARE NOT SHOWN. TREE CANOPIES ARE NOT SHOWN OR LOCATED.
- THIS MAP PORTRAYS THE SITE AT THE TIME OF THE SURVEY (10/10/17) AND DOES NOT SHOW SOILS OR GEOLOGY INFORMATION, UNDERGROUND CONDITIONS, EASEMENTS, ZONING OR REGULATORY INFORMATION OR ANY OTHER ITEMS NOT SPECIFICALLY REQUESTED BY THE PROPERTY OWNER AND/OR THEIR REPRESENTATIVES.
- THIS MAP DOES NOT REPRESENT A BOUNDARY SURVEY. PROPERTY LINES SHOWN HEREON WERE COMPILED FROM RECORD INFORMATION AND FROM FIELD TIES TO EXISTING BOUNDARY MONUMENTATION. THE LOCATION OF THESE LINES IS SUBJECT TO CHANGE, PENDING THE RESULTS OF A COMPLETE BOUNDARY SURVEY.
- BUILDING CORNERS SHOWN WERE LOCATED AT THE OUTERMOST FACE OF TRIM. DIMENSIONS SHOWN REPRESENT THE BUILDING AT GROUND LEVEL. SQUARE FOOTAGE WAS CALCULATED USING THE OUTERMOST BUILDING FOOTPRINT AS MEASURED. BUILDING OVERHANG(S) ARE NOT SHOWN.

LEGEND:

- PROPERTY BOUNDARY LINE
- ADJACENT PROPERTY BOUNDARY LINE
- MAJOR CONTOUR LINE (5' INTERVAL)
- MINOR CONTOUR LINE (1' INTERVAL)
- FENCE (TYPE AS MARKED)
- ASPHALT CONCRETE SURFACE
- PORTLAND CEMENT CONCRETE SURFACE
- BRICK SURFACE
- SPOT ELEVATION
- FLOWLINE
- SURVEY H&V CONTROL POINT
- FOUND MONUMENT, TYPE AS SHOWN
- FF, RL FINISH FLOOR, RIDGELINE
- TREE (TYPE AND SIZE AS MARKED) CENTER OF SYMBOL IS APPROX. CENTER OF TREE

CONTACT INFORMATION:
PRIMARY: OWNER
 MRS. NATASHA WITT
 3636 WASHOE STREET
 DAVIS, CA 95618
SECONDARY: ARCHITECT
 ERIC MILLER ARCHITECTS, INC.
 ATTN: MRS. ANITA CUESTO
 211 HOFFMAN AVENUE
 MONTEREY, CA 93940
 PH (831)372-0410
SITE LOCATION:
 CARMELO STREET 2 NW OF 9TH
 CARMELO-BY-THE-SEA, CA

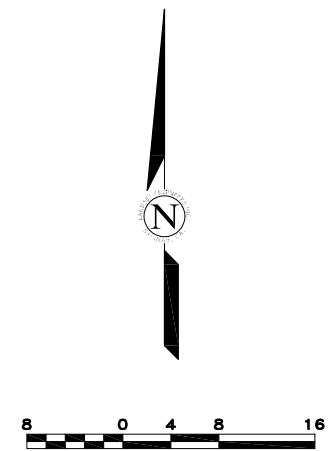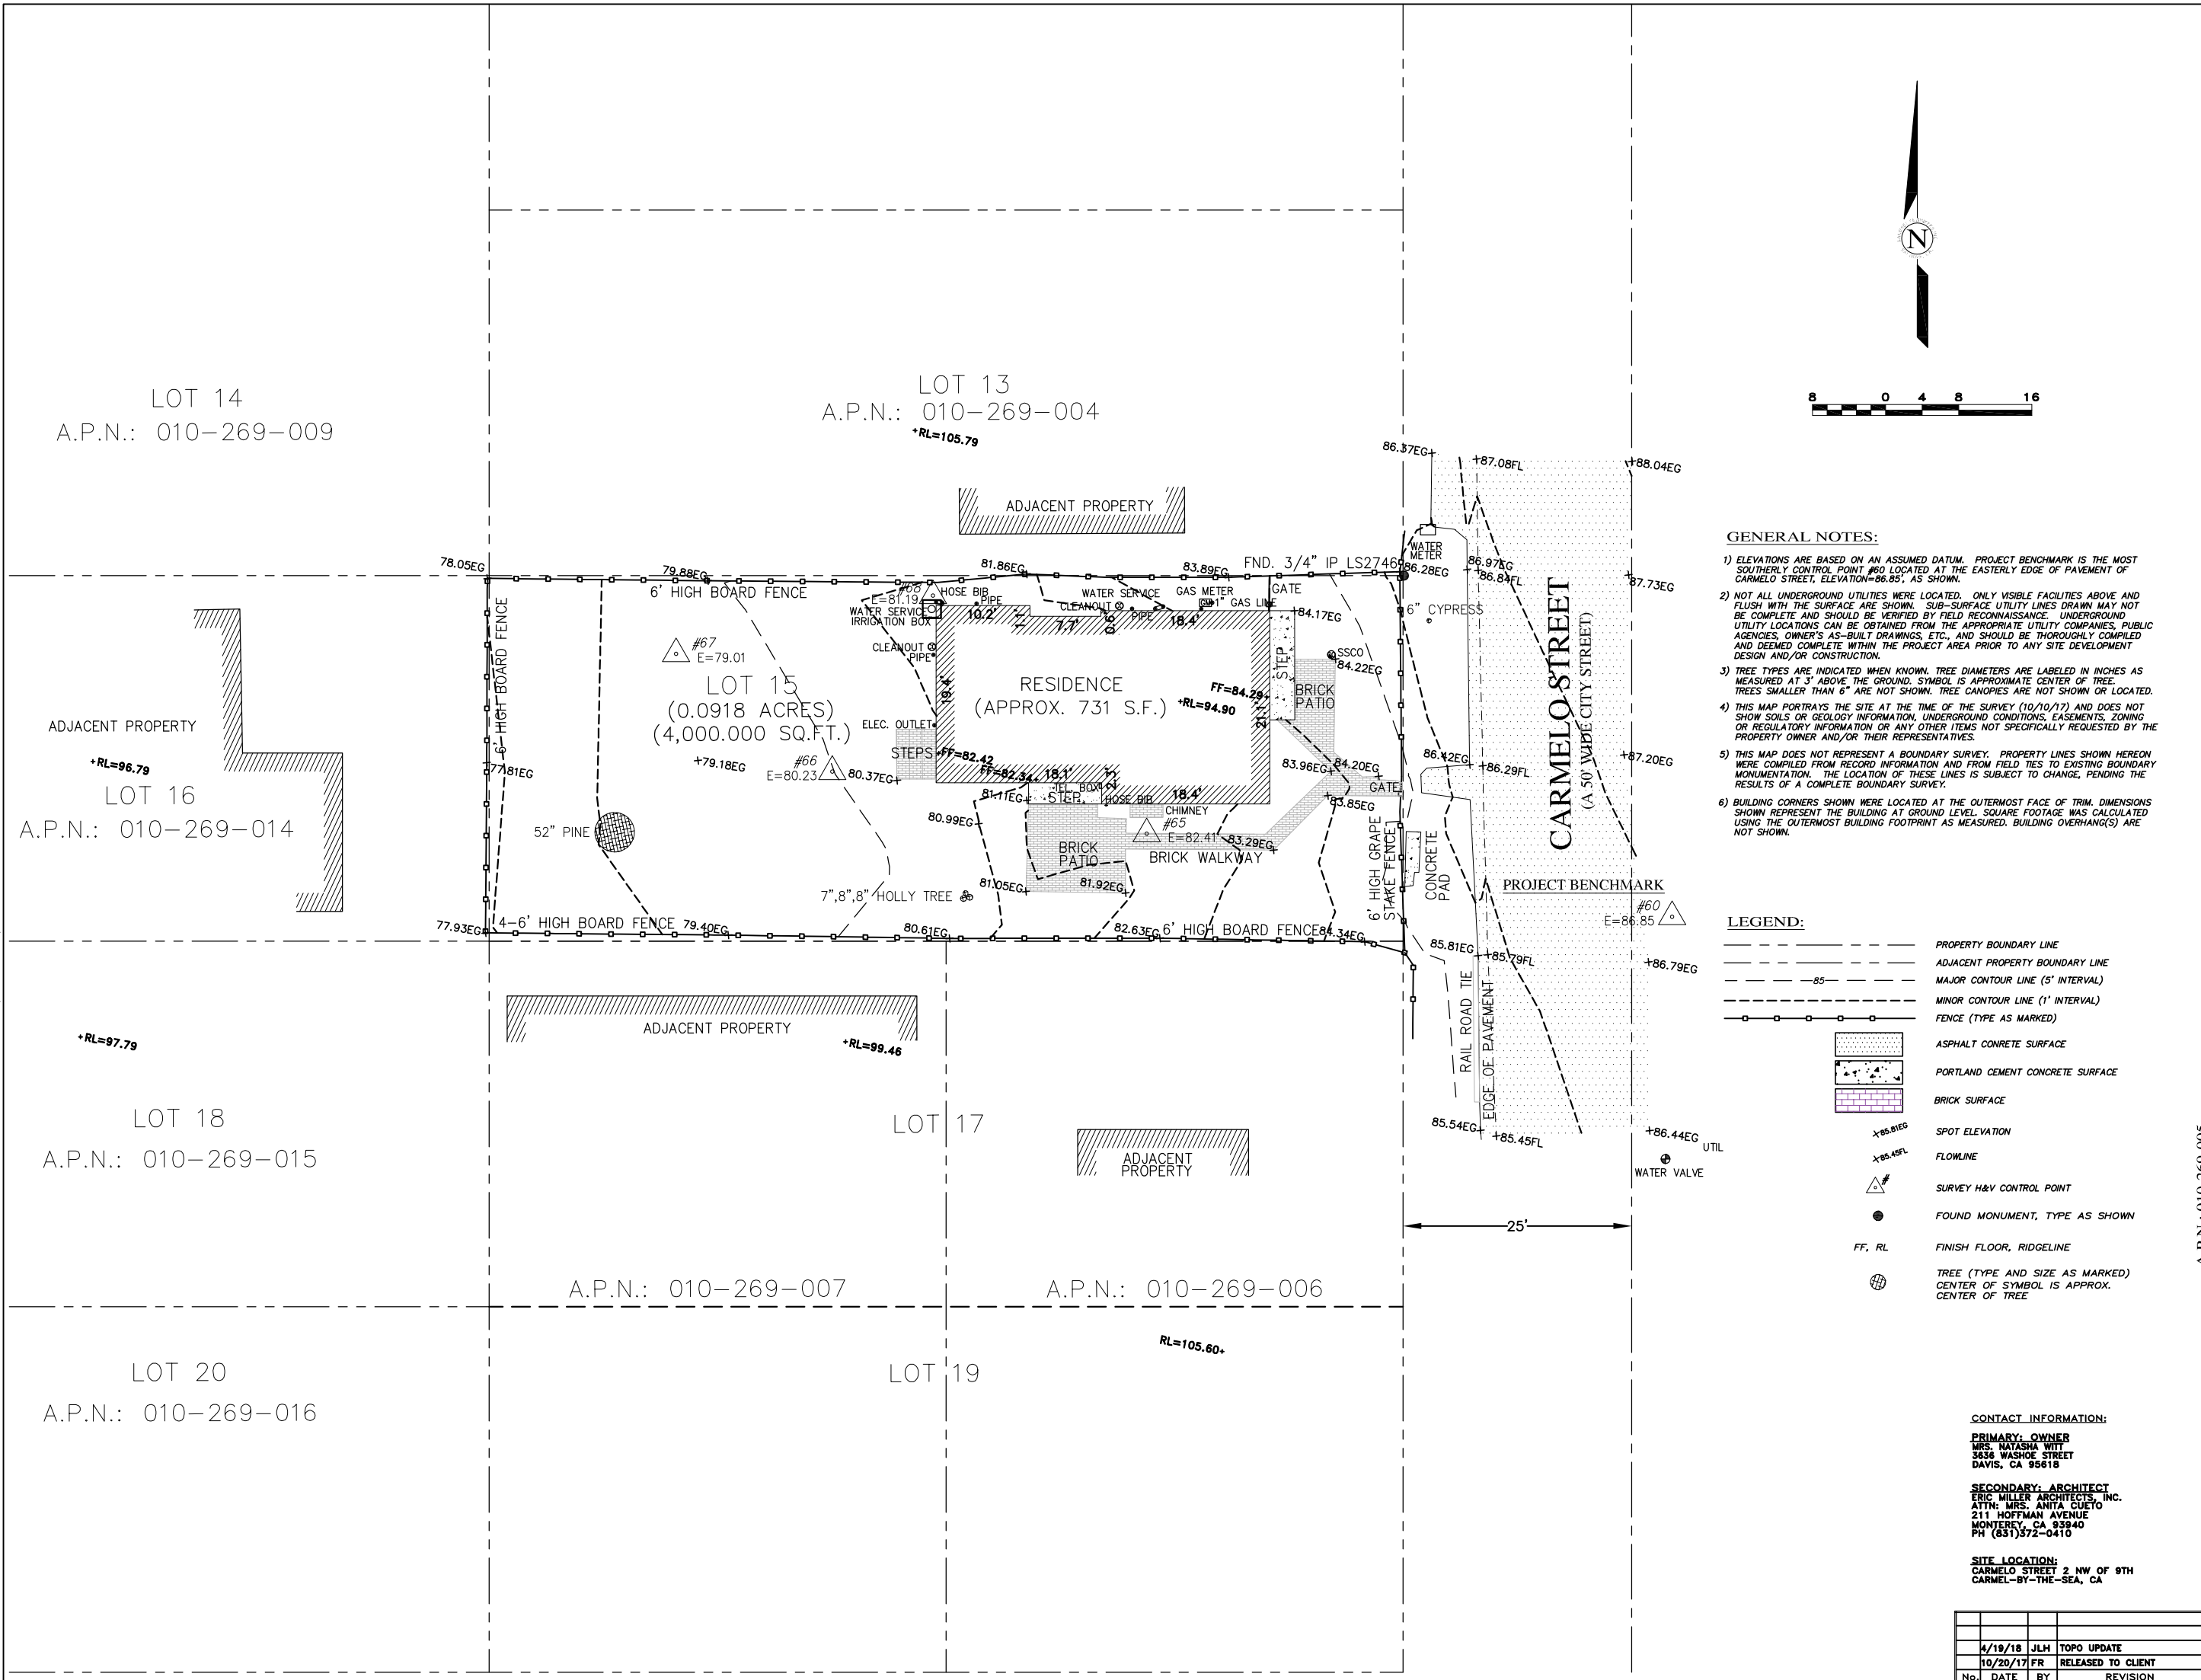TOPOGRAPHIC MAP

LOT 15, BLOCK "U", AS SHOWN IN VOLUME 1 OF CITIES & TOWNS AT PAGE 45-1/2 CARMEL-BY-THE-SEA, MONTEREY COUNTY, CALIFORNIA FOR MRS. NATASHA WITT

(E) SITE / TOPOGRAPHIC MAP

Witt Residence
 Carmelo 2NW of 9th Street
 Carmel, By-The-Sea, CA
 APN: 010-269-005-000

DATE: 6/5/19
 SCALE: 1/8" = 1'-0"
 DRAWN: CAD
 JOB NUMBER: 17.20

SCALE: 1"=8'
 DATE: OCTOBER 2017
 JOB NO. 1735-01

| No. | DATE | BY | REVISION |
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| | 4/19/18 | JLH | TOPO UPDATE |
| | 10/20/17 | FR | RELEASED TO CLIENT |

SHEET 1 OF 1 SHEETS

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APPROVED BY:

GUY R. GIRAUDO P.L.S. No. 8703




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ARCHITECT

MRS. NATASHA WITT

REVISION No.



| REVISION | No. |
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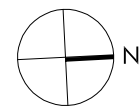
PROPOSED SITE PLAN

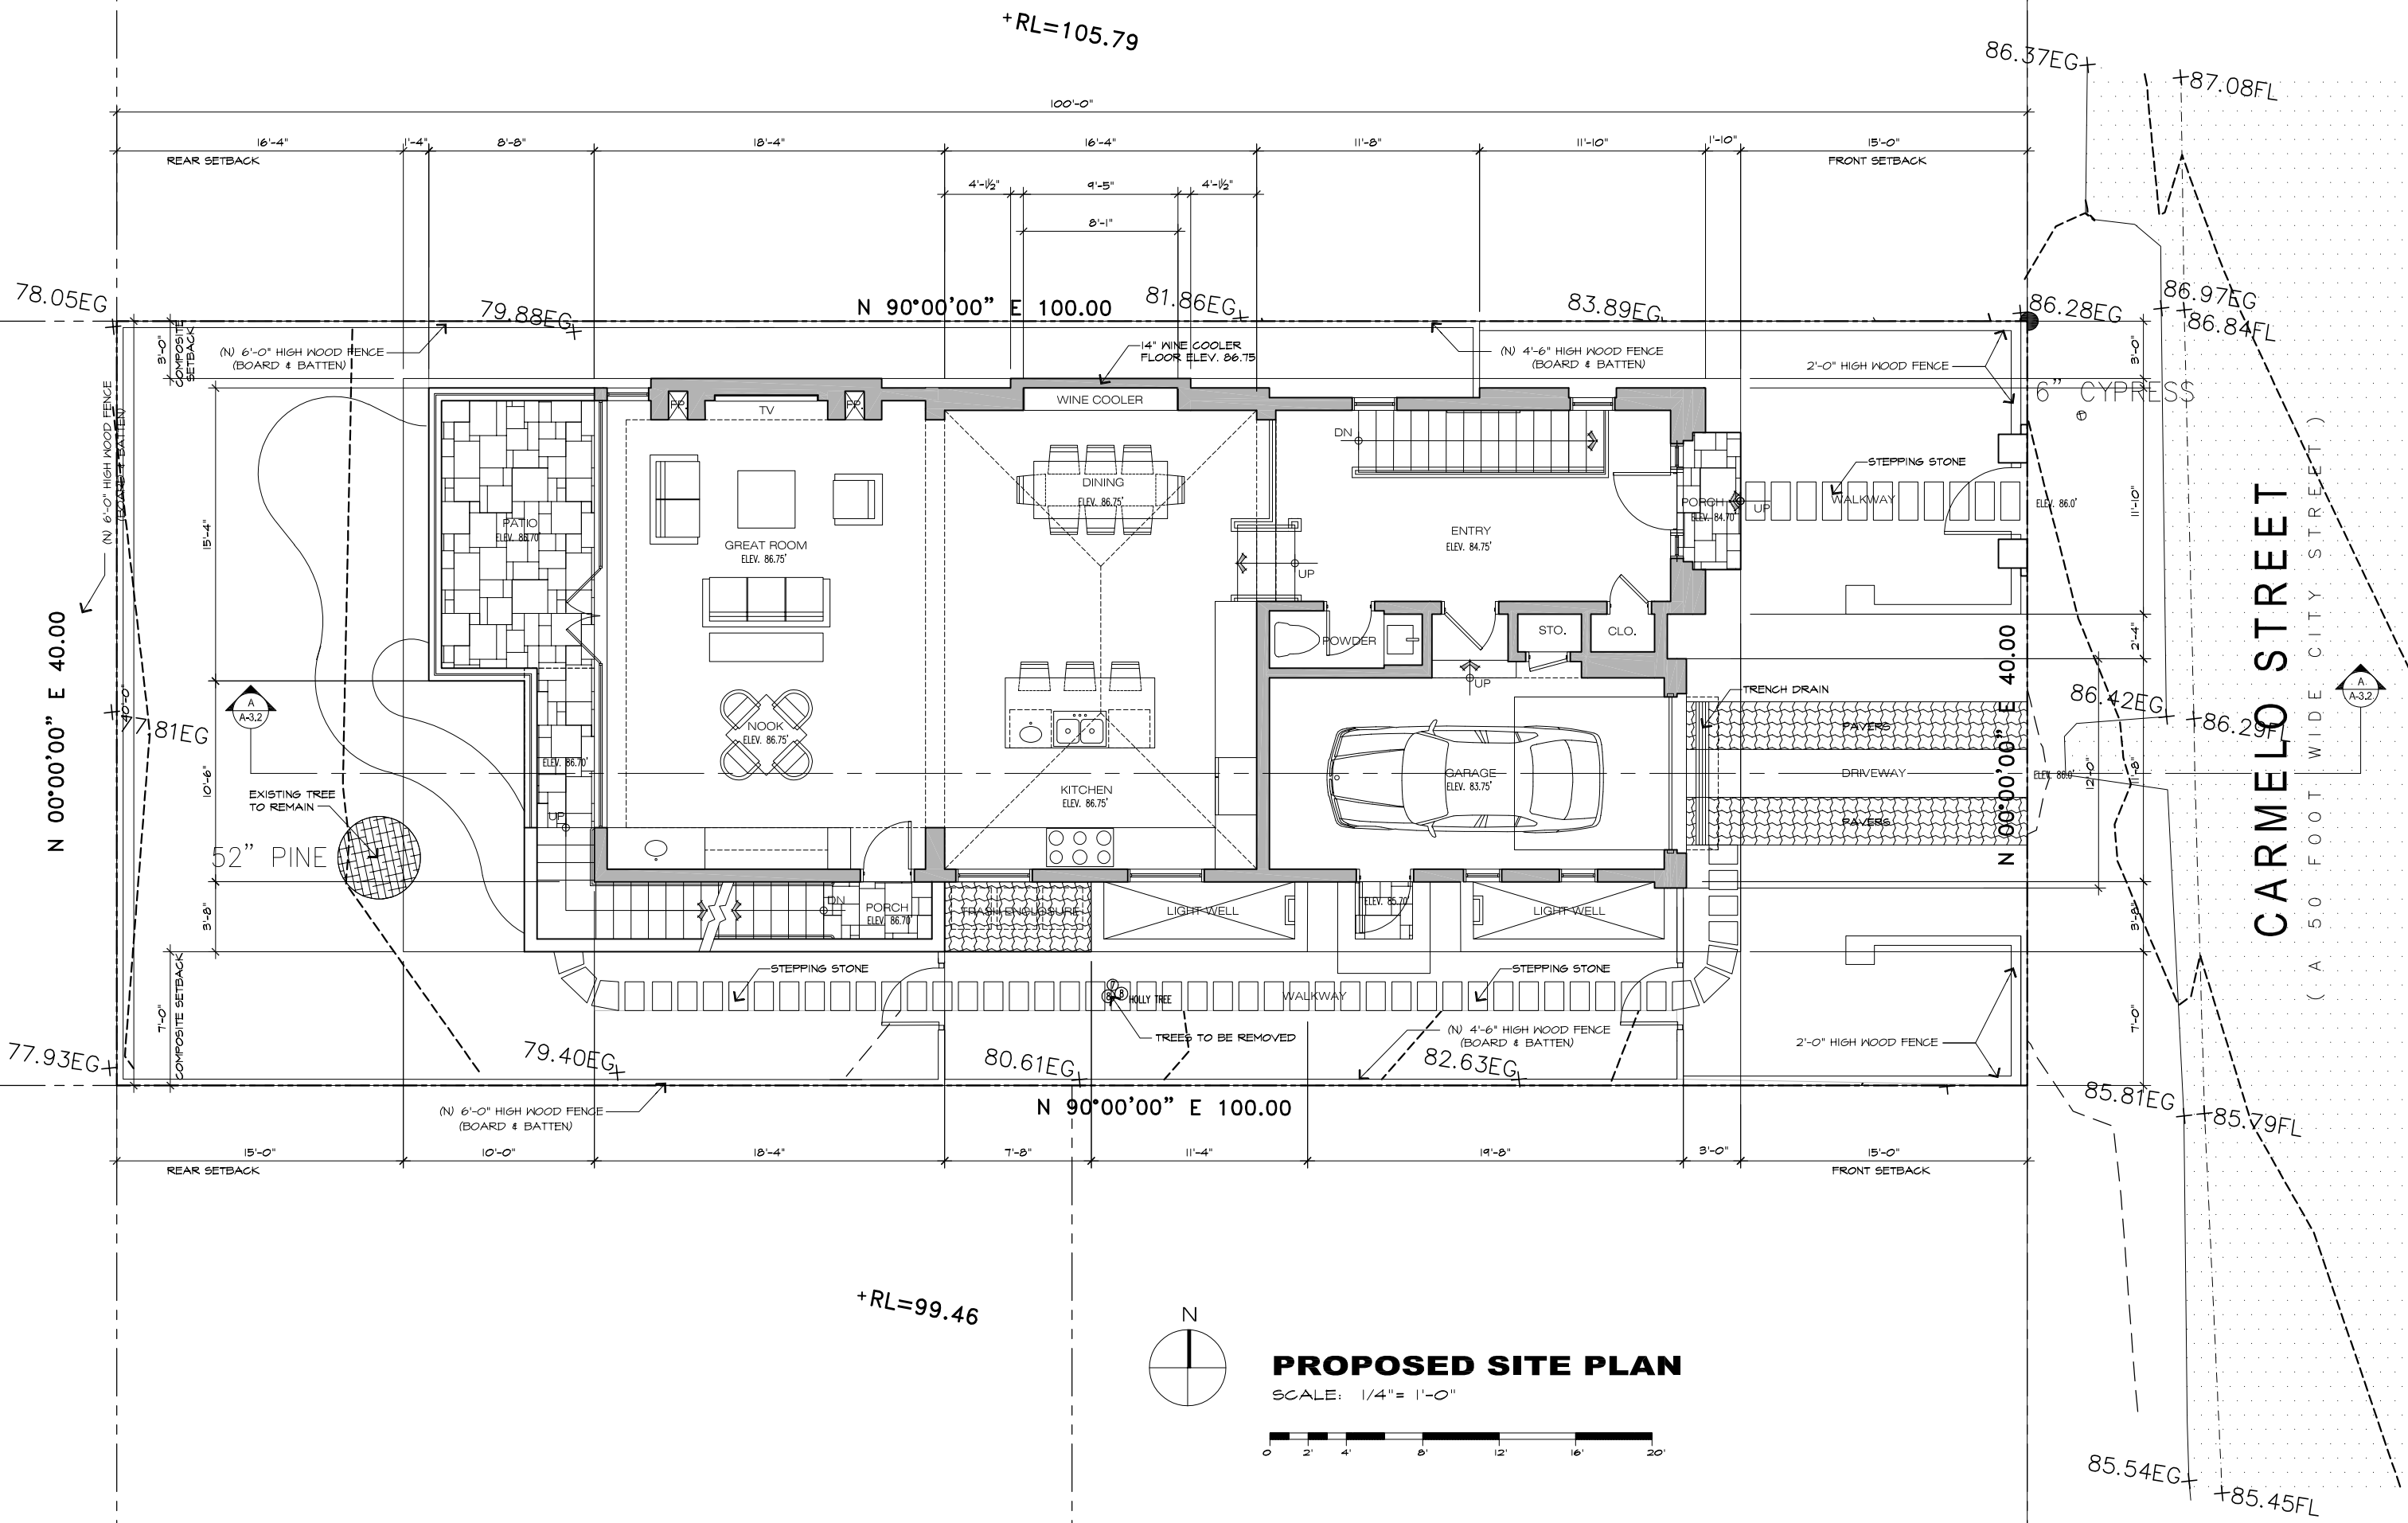JOB NAME: **Witt Residence**
 Carmelo 21W of 4th Street
 Carmel, By-The-Sea, CA
 APN: 010-269-005-000

DATE: 6/5/19
 SCALE: 1/4"=1'-0"
 DRAWN: DM
 JOB NUMBER: 17.20

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PROPOSED DEMOLITION PLAN

SCALE: 1/8" = 1'-0"



NOTE:
 ALL EXISTING BUILDING STRUCTURES, PAVEMENTS, WALKWAYS, FENCES AND RETAINING WALLS, STAIRS ARE TO BE DEMOLISHED, REMOVED AND CLEARED TO GRADE. ON SITE UTILITIES (ELECTRICAL, GAS, WATER CABLE TELEPHONE) ARE TO BE RELOCATED.

TREE REMOVAL
 THREE (3) TREES TO BE REMOVED: 7", 8" & 8" DIA. HOLLY TREE.

| REVISION | No. |
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PROPOSED DEMOLITION PLAN

JOB NAME:
Witt Residence
 Carmelo 2NW of 4th Street
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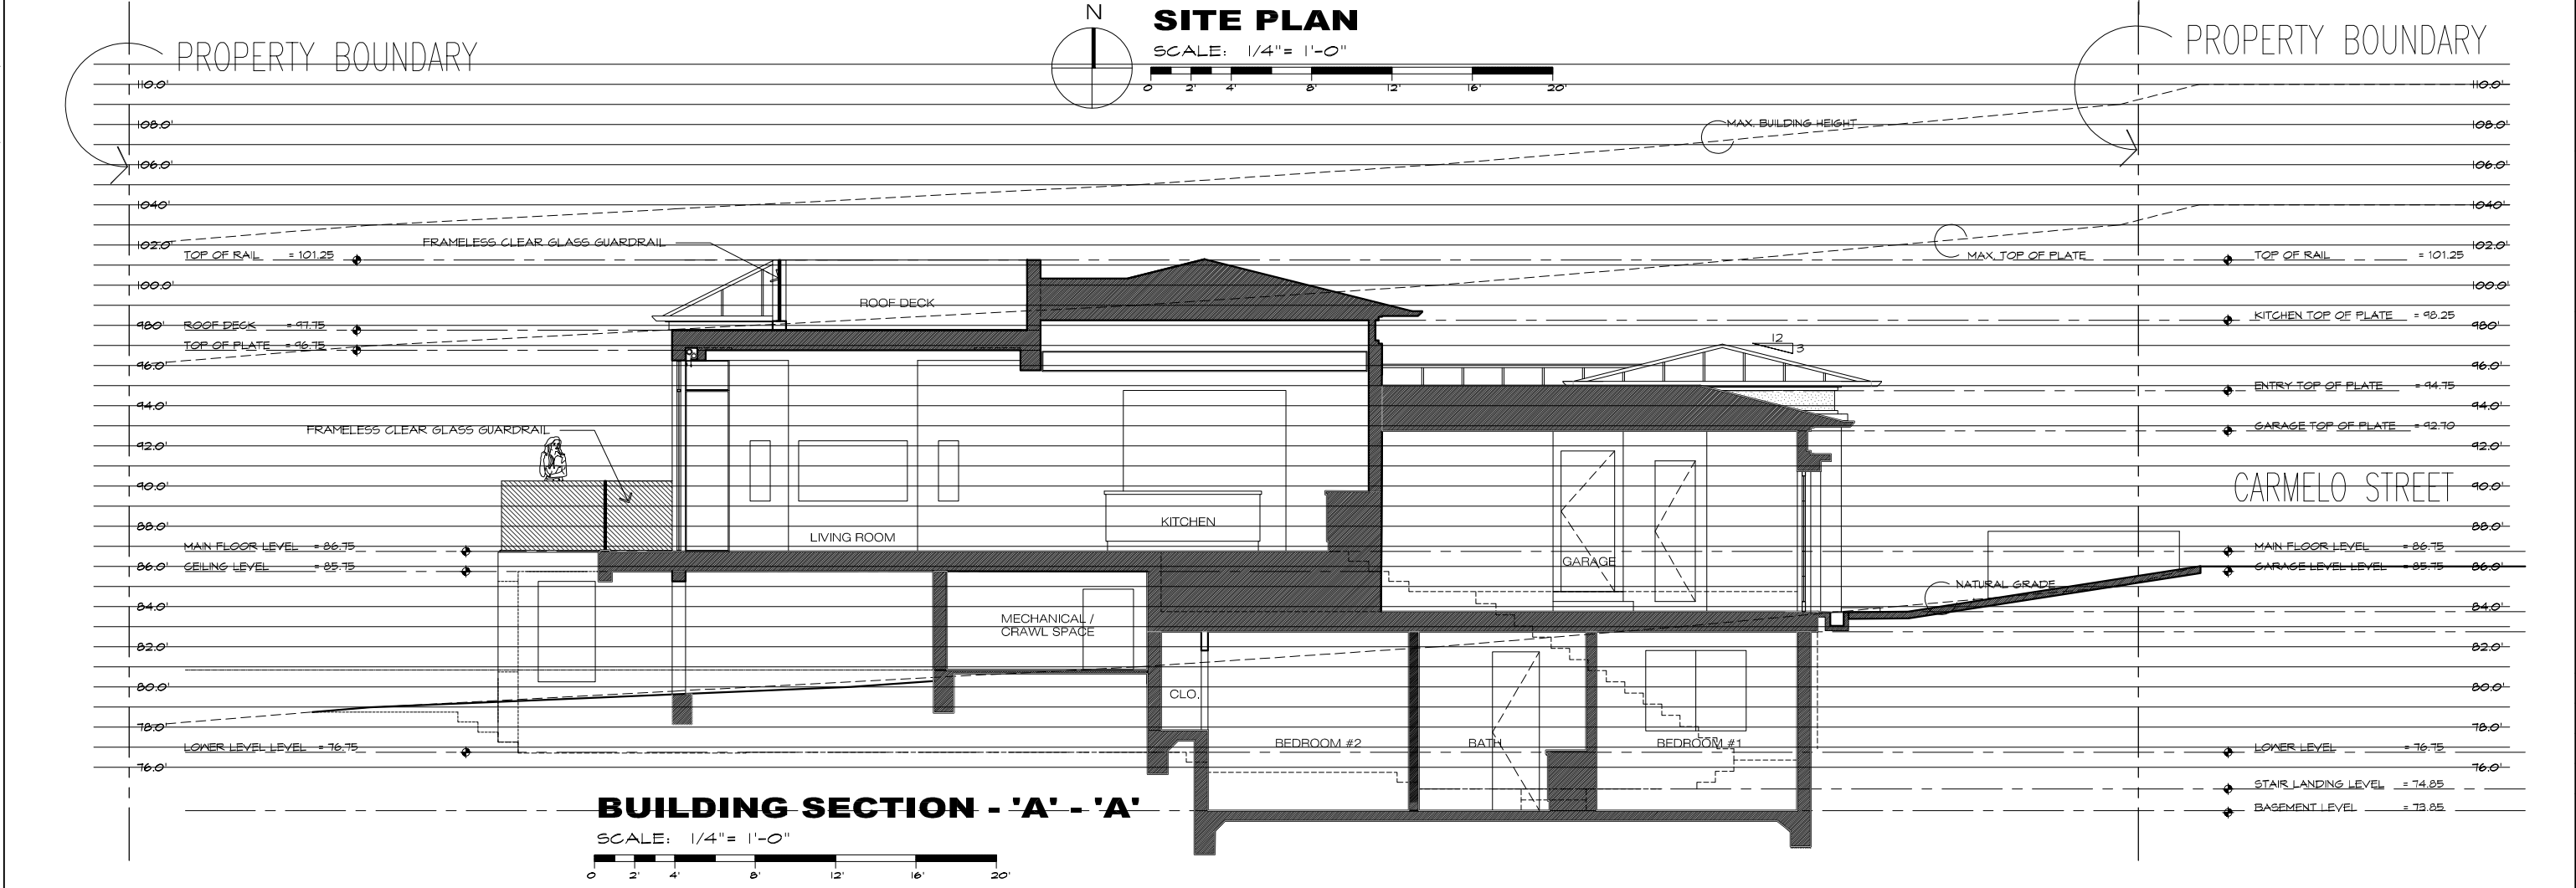
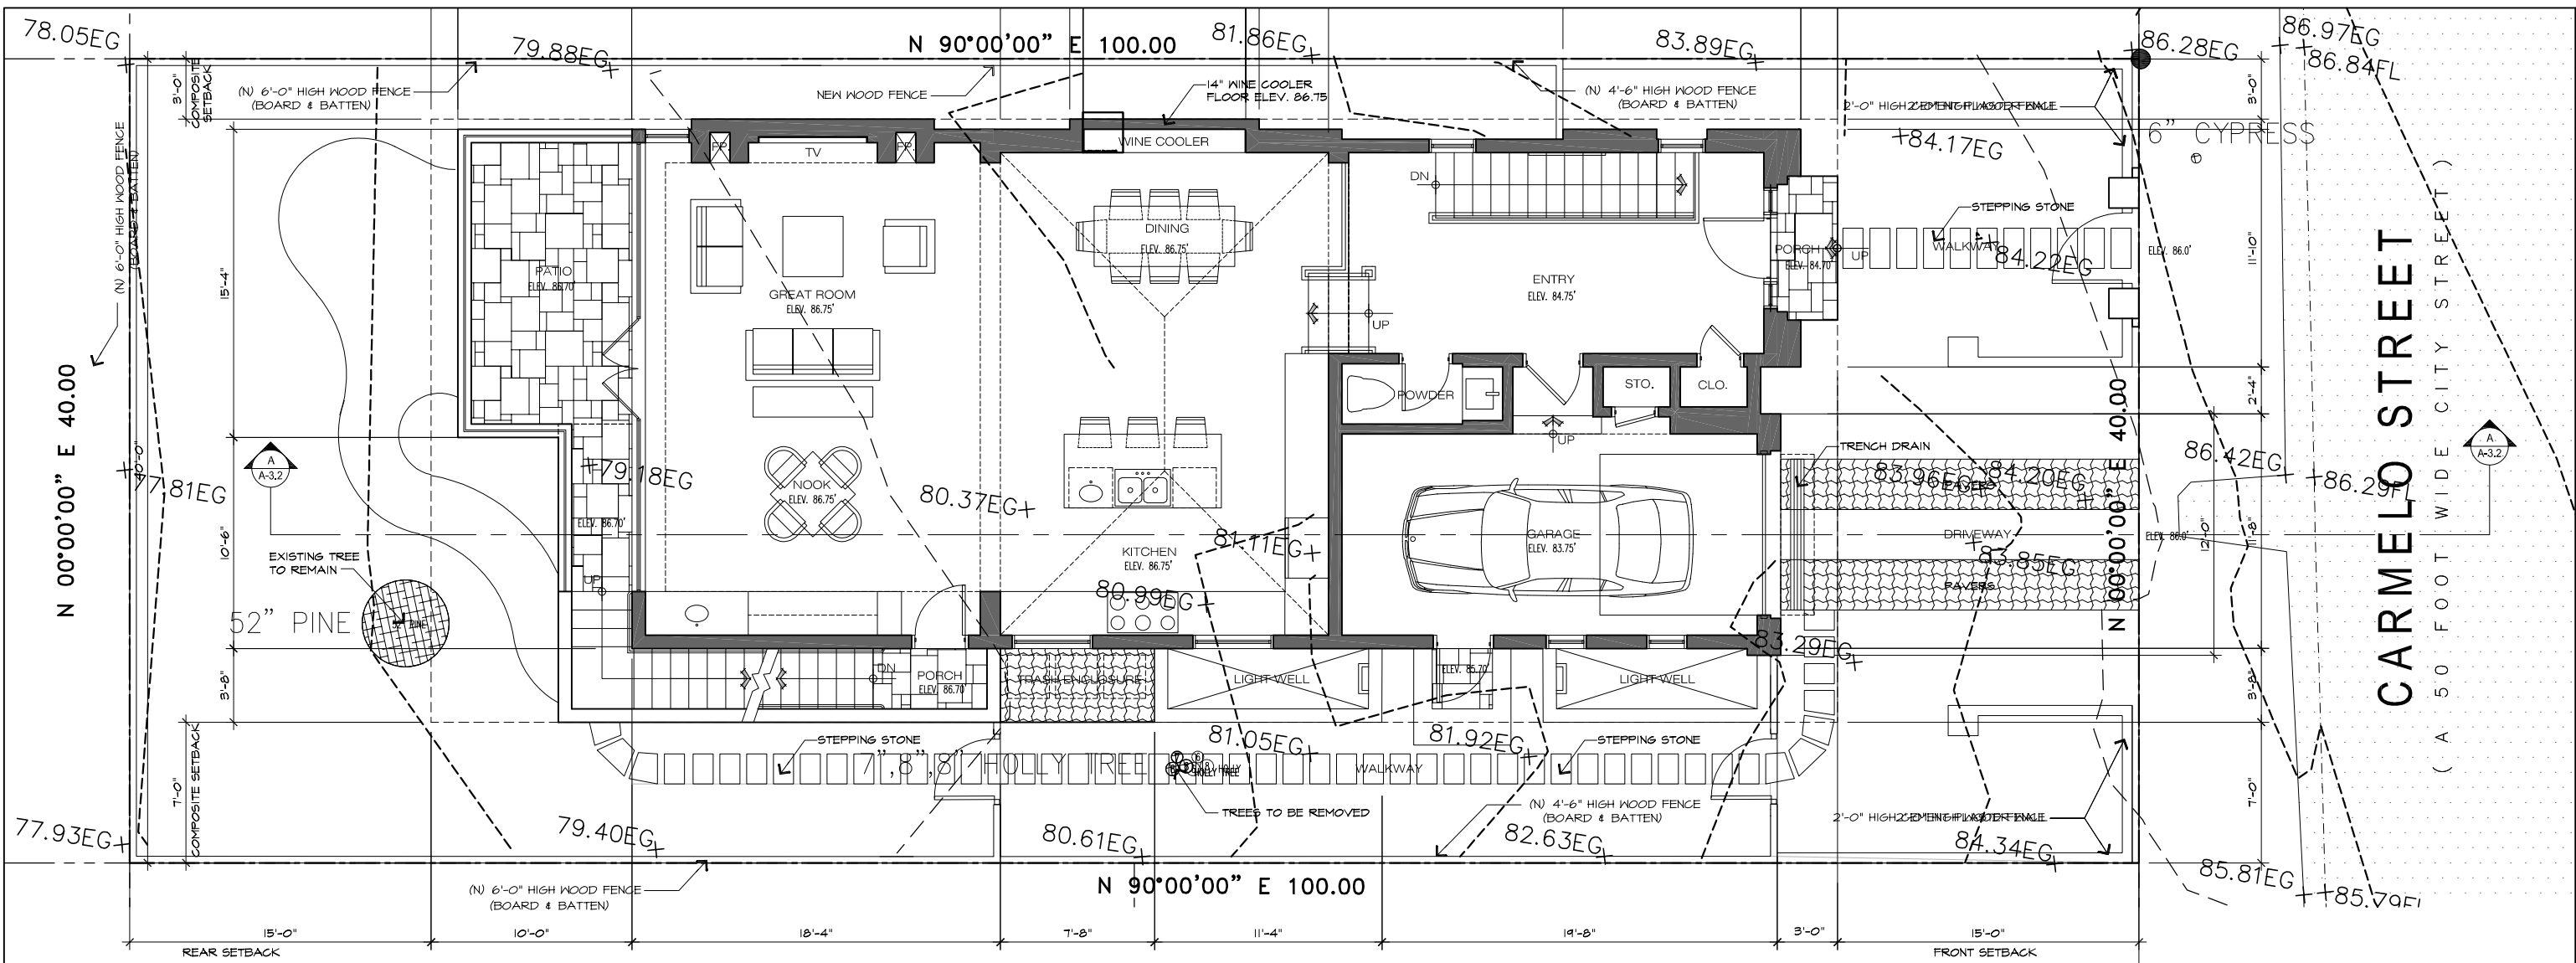
DATE: 6/5/19
 SCALE: 1/8" = 1'-0"
 DRAWN: CCR
 JOB NUMBER: 17.20

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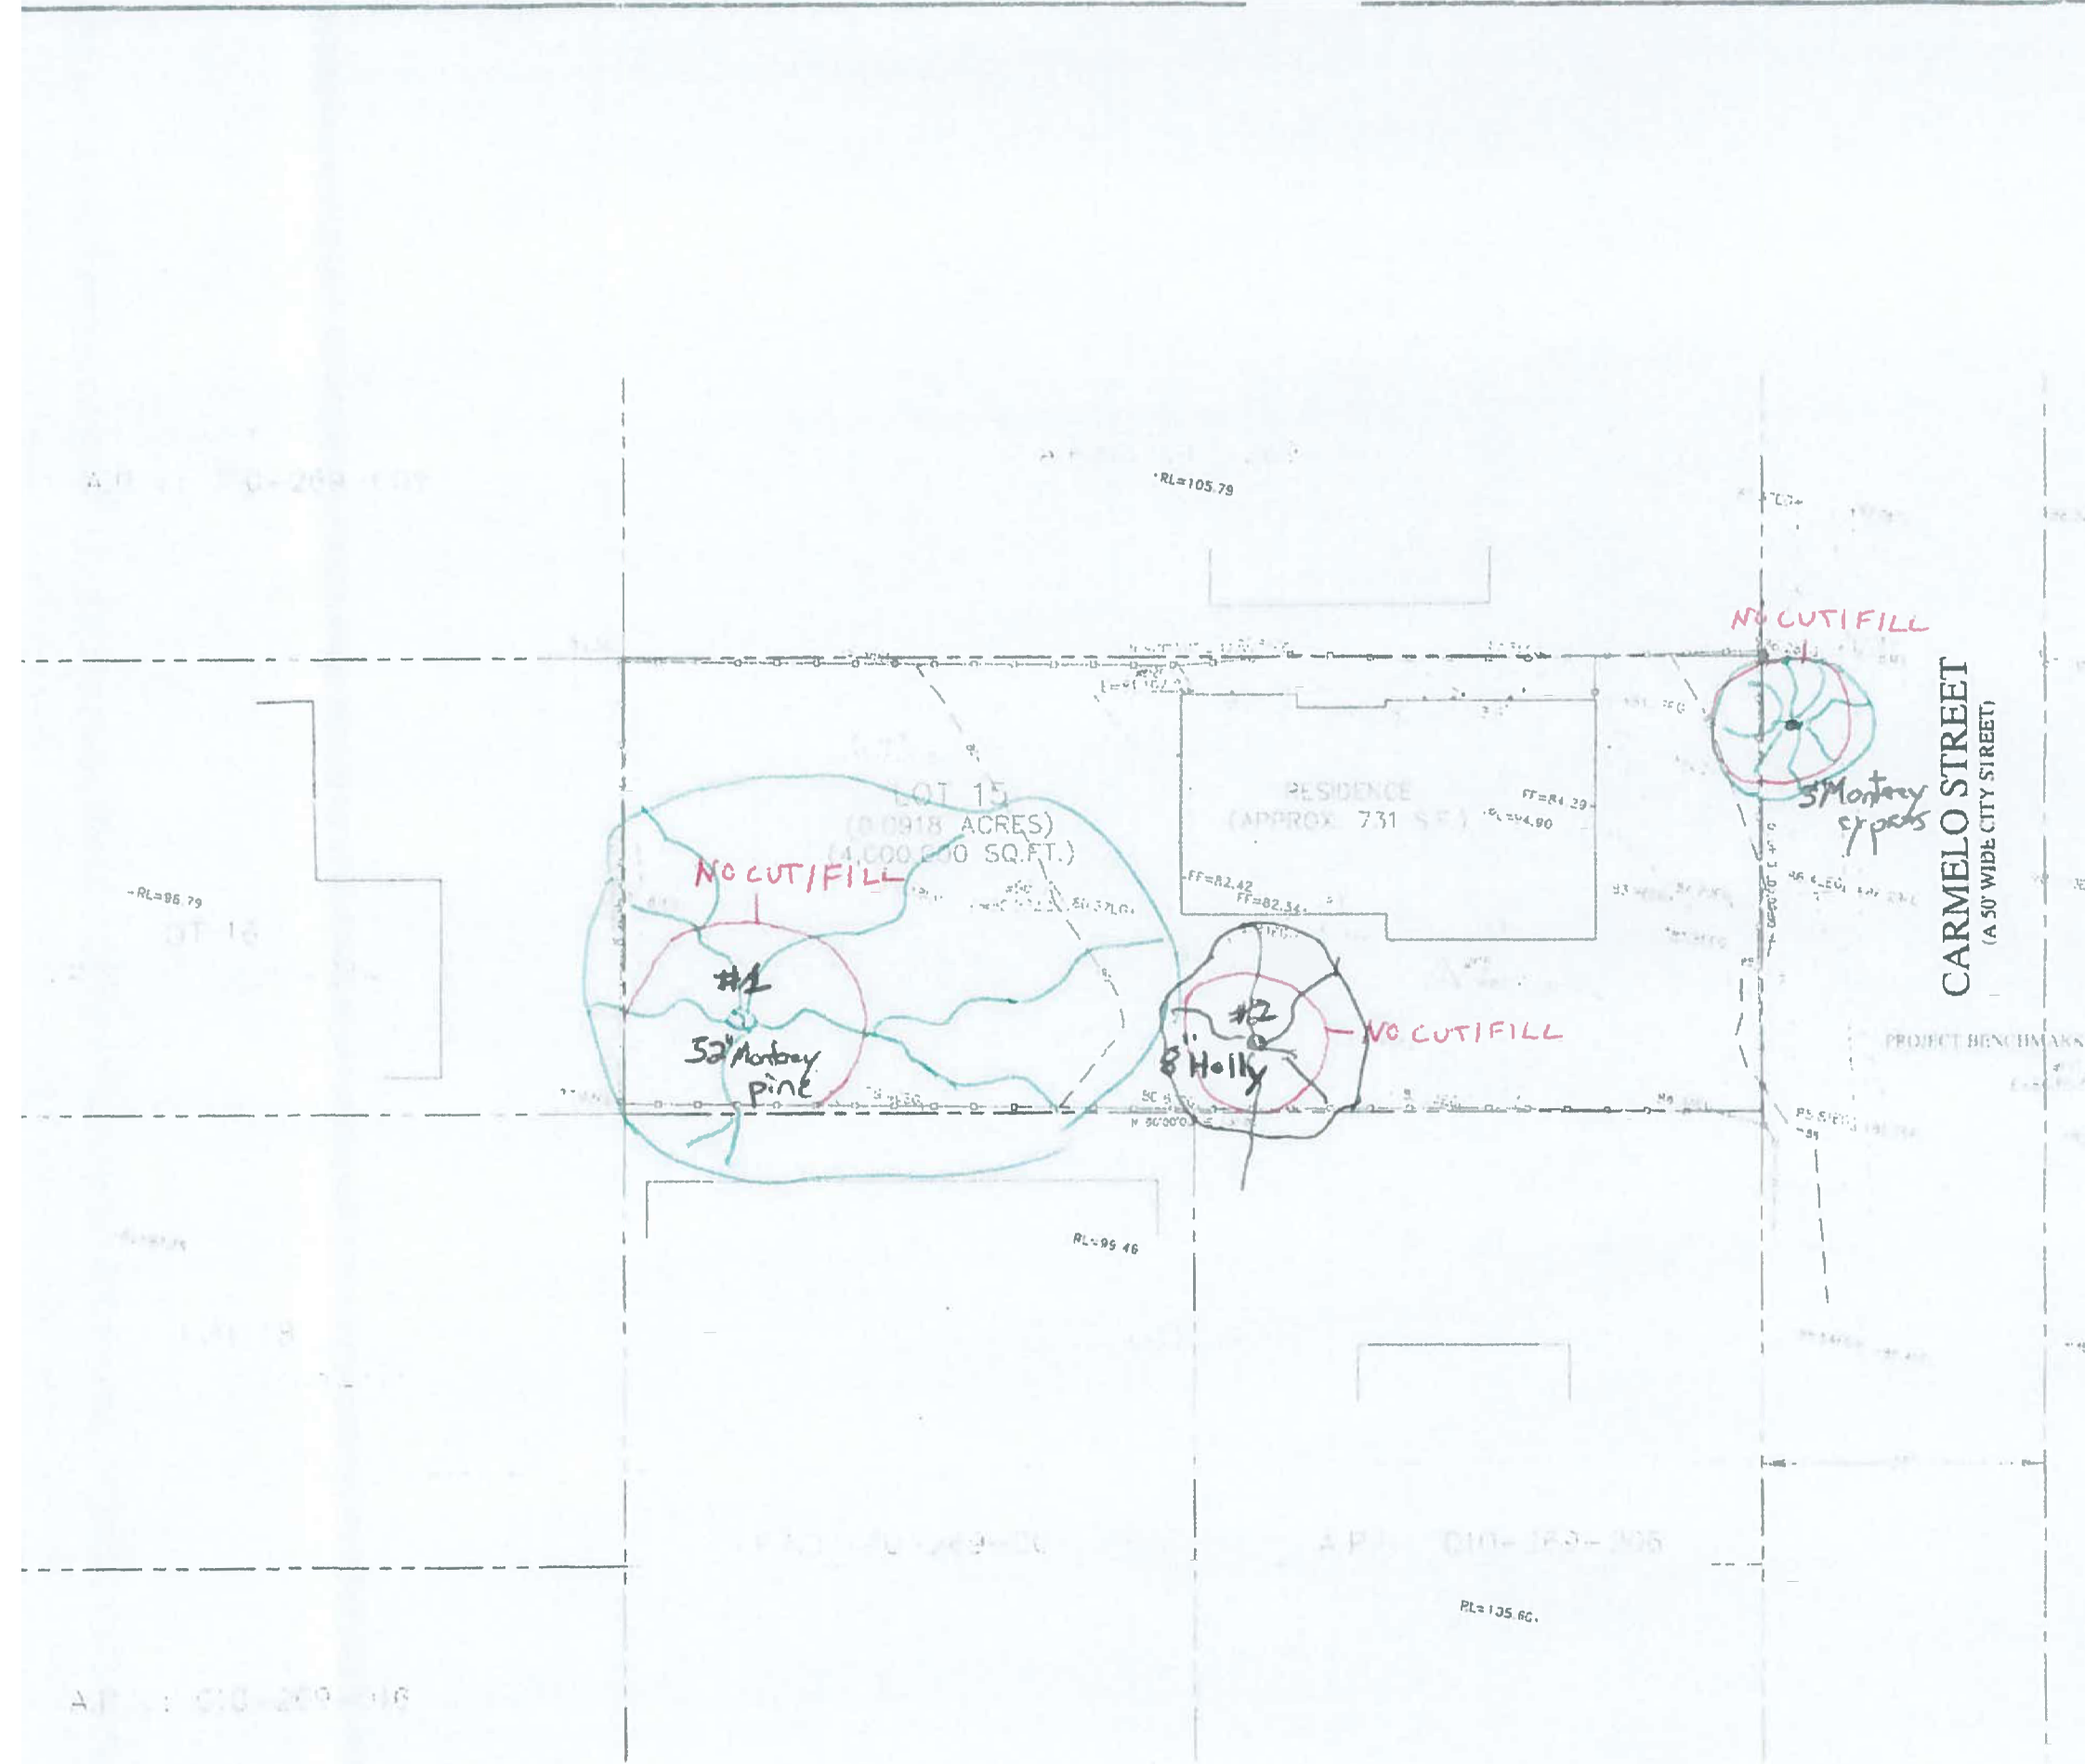
ARCHITECT

SITE SECTION

Witt Residence
 Carmelo 2NW of 4th Street
 Carmelo, By-The-Sea, CA
 APN: 010-269-005-000

DATE: 6/5/19
 SCALE: 1/4" = 1'-0"
 DRAWN: DM
 JOB NUMBER: 17.20

A-1.3
 SHEET OF



GENERAL NOTES:

1. ALL NOTES SHALL BE READ AND UNDERSTOOD IN CONJUNCTION WITH THE GENERAL NOTES OF THE CITY OF CARMEL-BY-THE-SEA, CALIFORNIA.
2. THE DESIGNER SHALL BE RESPONSIBLE FOR OBTAINING ALL NECESSARY PERMITS AND APPROVALS FROM THE CITY OF CARMEL-BY-THE-SEA, CALIFORNIA.
3. THE DESIGNER SHALL BE RESPONSIBLE FOR OBTAINING ALL NECESSARY PERMITS AND APPROVALS FROM THE COUNTY OF MONTEREY, CALIFORNIA.
4. THE DESIGNER SHALL BE RESPONSIBLE FOR OBTAINING ALL NECESSARY PERMITS AND APPROVALS FROM THE STATE OF CALIFORNIA.
5. THE DESIGNER SHALL BE RESPONSIBLE FOR OBTAINING ALL NECESSARY PERMITS AND APPROVALS FROM THE LOCAL NEIGHBORHOOD ASSOCIATION.
6. THE DESIGNER SHALL BE RESPONSIBLE FOR OBTAINING ALL NECESSARY PERMITS AND APPROVALS FROM THE LOCAL HOMEOWNERS ASSOCIATION.
7. THE DESIGNER SHALL BE RESPONSIBLE FOR OBTAINING ALL NECESSARY PERMITS AND APPROVALS FROM THE LOCAL BUSINESS ASSOCIATION.
8. THE DESIGNER SHALL BE RESPONSIBLE FOR OBTAINING ALL NECESSARY PERMITS AND APPROVALS FROM THE LOCAL PROFESSIONAL ASSOCIATION.
9. THE DESIGNER SHALL BE RESPONSIBLE FOR OBTAINING ALL NECESSARY PERMITS AND APPROVALS FROM THE LOCAL TRADING ASSOCIATION.
10. THE DESIGNER SHALL BE RESPONSIBLE FOR OBTAINING ALL NECESSARY PERMITS AND APPROVALS FROM THE LOCAL UNION.
11. THE DESIGNER SHALL BE RESPONSIBLE FOR OBTAINING ALL NECESSARY PERMITS AND APPROVALS FROM THE LOCAL VETERANS ASSOCIATION.
12. THE DESIGNER SHALL BE RESPONSIBLE FOR OBTAINING ALL NECESSARY PERMITS AND APPROVALS FROM THE LOCAL WELFARE ORGANIZATION.
13. THE DESIGNER SHALL BE RESPONSIBLE FOR OBTAINING ALL NECESSARY PERMITS AND APPROVALS FROM THE LOCAL YOUTH ORGANIZATION.
14. THE DESIGNER SHALL BE RESPONSIBLE FOR OBTAINING ALL NECESSARY PERMITS AND APPROVALS FROM THE LOCAL SENIORS ORGANIZATION.
15. THE DESIGNER SHALL BE RESPONSIBLE FOR OBTAINING ALL NECESSARY PERMITS AND APPROVALS FROM THE LOCAL LGBTQ+ ORGANIZATION.
16. THE DESIGNER SHALL BE RESPONSIBLE FOR OBTAINING ALL NECESSARY PERMITS AND APPROVALS FROM THE LOCAL RELIGIOUS ORGANIZATION.
17. THE DESIGNER SHALL BE RESPONSIBLE FOR OBTAINING ALL NECESSARY PERMITS AND APPROVALS FROM THE LOCAL POLITICAL ORGANIZATION.
18. THE DESIGNER SHALL BE RESPONSIBLE FOR OBTAINING ALL NECESSARY PERMITS AND APPROVALS FROM THE LOCAL ENVIRONMENTAL ORGANIZATION.
19. THE DESIGNER SHALL BE RESPONSIBLE FOR OBTAINING ALL NECESSARY PERMITS AND APPROVALS FROM THE LOCAL EDUCATIONAL ORGANIZATION.
20. THE DESIGNER SHALL BE RESPONSIBLE FOR OBTAINING ALL NECESSARY PERMITS AND APPROVALS FROM THE LOCAL CULTURAL ORGANIZATION.
21. THE DESIGNER SHALL BE RESPONSIBLE FOR OBTAINING ALL NECESSARY PERMITS AND APPROVALS FROM THE LOCAL ARTS ORGANIZATION.
22. THE DESIGNER SHALL BE RESPONSIBLE FOR OBTAINING ALL NECESSARY PERMITS AND APPROVALS FROM THE LOCAL MUSIC ORGANIZATION.
23. THE DESIGNER SHALL BE RESPONSIBLE FOR OBTAINING ALL NECESSARY PERMITS AND APPROVALS FROM THE LOCAL DANCE ORGANIZATION.
24. THE DESIGNER SHALL BE RESPONSIBLE FOR OBTAINING ALL NECESSARY PERMITS AND APPROVALS FROM THE LOCAL THEATER ORGANIZATION.
25. THE DESIGNER SHALL BE RESPONSIBLE FOR OBTAINING ALL NECESSARY PERMITS AND APPROVALS FROM THE LOCAL FILM ORGANIZATION.
26. THE DESIGNER SHALL BE RESPONSIBLE FOR OBTAINING ALL NECESSARY PERMITS AND APPROVALS FROM THE LOCAL TELEVISION ORGANIZATION.
27. THE DESIGNER SHALL BE RESPONSIBLE FOR OBTAINING ALL NECESSARY PERMITS AND APPROVALS FROM THE LOCAL RADIO ORGANIZATION.
28. THE DESIGNER SHALL BE RESPONSIBLE FOR OBTAINING ALL NECESSARY PERMITS AND APPROVALS FROM THE LOCAL PUBLISHING ORGANIZATION.
29. THE DESIGNER SHALL BE RESPONSIBLE FOR OBTAINING ALL NECESSARY PERMITS AND APPROVALS FROM THE LOCAL NEWS ORGANIZATION.
30. THE DESIGNER SHALL BE RESPONSIBLE FOR OBTAINING ALL NECESSARY PERMITS AND APPROVALS FROM THE LOCAL JOURNALISM ORGANIZATION.
31. THE DESIGNER SHALL BE RESPONSIBLE FOR OBTAINING ALL NECESSARY PERMITS AND APPROVALS FROM THE LOCAL WITNESS ORGANIZATION.
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34. THE DESIGNER SHALL BE RESPONSIBLE FOR OBTAINING ALL NECESSARY PERMITS AND APPROVALS FROM THE LOCAL COLUMNIST ORGANIZATION.
35. THE DESIGNER SHALL BE RESPONSIBLE FOR OBTAINING ALL NECESSARY PERMITS AND APPROVALS FROM THE LOCAL EDITOR ORGANIZATION.
36. THE DESIGNER SHALL BE RESPONSIBLE FOR OBTAINING ALL NECESSARY PERMITS AND APPROVALS FROM THE LOCAL PUBLISHER ORGANIZATION.
37. THE DESIGNER SHALL BE RESPONSIBLE FOR OBTAINING ALL NECESSARY PERMITS AND APPROVALS FROM THE LOCAL AUTHOR ORGANIZATION.
38. THE DESIGNER SHALL BE RESPONSIBLE FOR OBTAINING ALL NECESSARY PERMITS AND APPROVALS FROM THE LOCAL WRITER ORGANIZATION.
39. THE DESIGNER SHALL BE RESPONSIBLE FOR OBTAINING ALL NECESSARY PERMITS AND APPROVALS FROM THE LOCAL JOURNALIST ORGANIZATION.
40. THE DESIGNER SHALL BE RESPONSIBLE FOR OBTAINING ALL NECESSARY PERMITS AND APPROVALS FROM THE LOCAL REPORTER ORGANIZATION.
41. THE DESIGNER SHALL BE RESPONSIBLE FOR OBTAINING ALL NECESSARY PERMITS AND APPROVALS FROM THE LOCAL COLUMNIST ORGANIZATION.
42. THE DESIGNER SHALL BE RESPONSIBLE FOR OBTAINING ALL NECESSARY PERMITS AND APPROVALS FROM THE LOCAL EDITOR ORGANIZATION.
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44. THE DESIGNER SHALL BE RESPONSIBLE FOR OBTAINING ALL NECESSARY PERMITS AND APPROVALS FROM THE LOCAL AUTHOR ORGANIZATION.
45. THE DESIGNER SHALL BE RESPONSIBLE FOR OBTAINING ALL NECESSARY PERMITS AND APPROVALS FROM THE LOCAL WRITER ORGANIZATION.

- LEGEND:**
- PROPERTY BOUNDARY
 - EASEMENT BOUNDARY
 - RIGHT-OF-WAY BOUNDARY
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 - 100' CONTOUR



RECEIVED

MAY 04 2018

City of Carmel-by-the-Sea
Planning & Building Dept.


CONTACT INFORMATION:
PRIMARY OWNER
MRS. NATASHA WITT
3838 WASHOE STREET
DAVIS, CA 95618

SECONDARY ARCHITECT
ERIC MILLER ARCHITECTS, INC.
ATTN: MRS. ANITA CLYTO
211 HOFFMAN AVENUE
MONTEREY, CA 93940
PH: (831) 572-0410

SITE LOCATION:
CARMELO STREET 2 NW OF 8TH
CARMEL-BY-THE-SEA, CA



APPROVED BY:
GUY R. CIRALTO
P.L.S. No. 8703

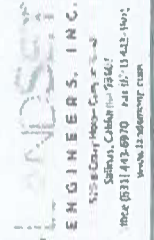

TOPOGRAPHIC MAP
LOT 15, BLOCK "U", AS SHOWN IN VOLUME 1
OF CITIES & TOWNS AT PAGE 45-1/2
CARMEL-BY-THE-SEA, MONTEREY COUNTY, CALIFORNIA



A.P.N.: 010-209-005
MRS. NATASHA WITT

A-1.4

SCALE: 1"=8'
DATE: OCTOBER 2017
JOB NO. 1735-01

| No. | DATE | BY | REVISION |
|-----|----------|-----|-------------------|
| 1 | 10/30/17 | FR | PLEASED TO CLIENT |
| 2 | 11/19/18 | JLH | IMPO UPDATE |

SHEET 1
OF 1 SHEETS

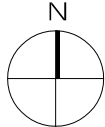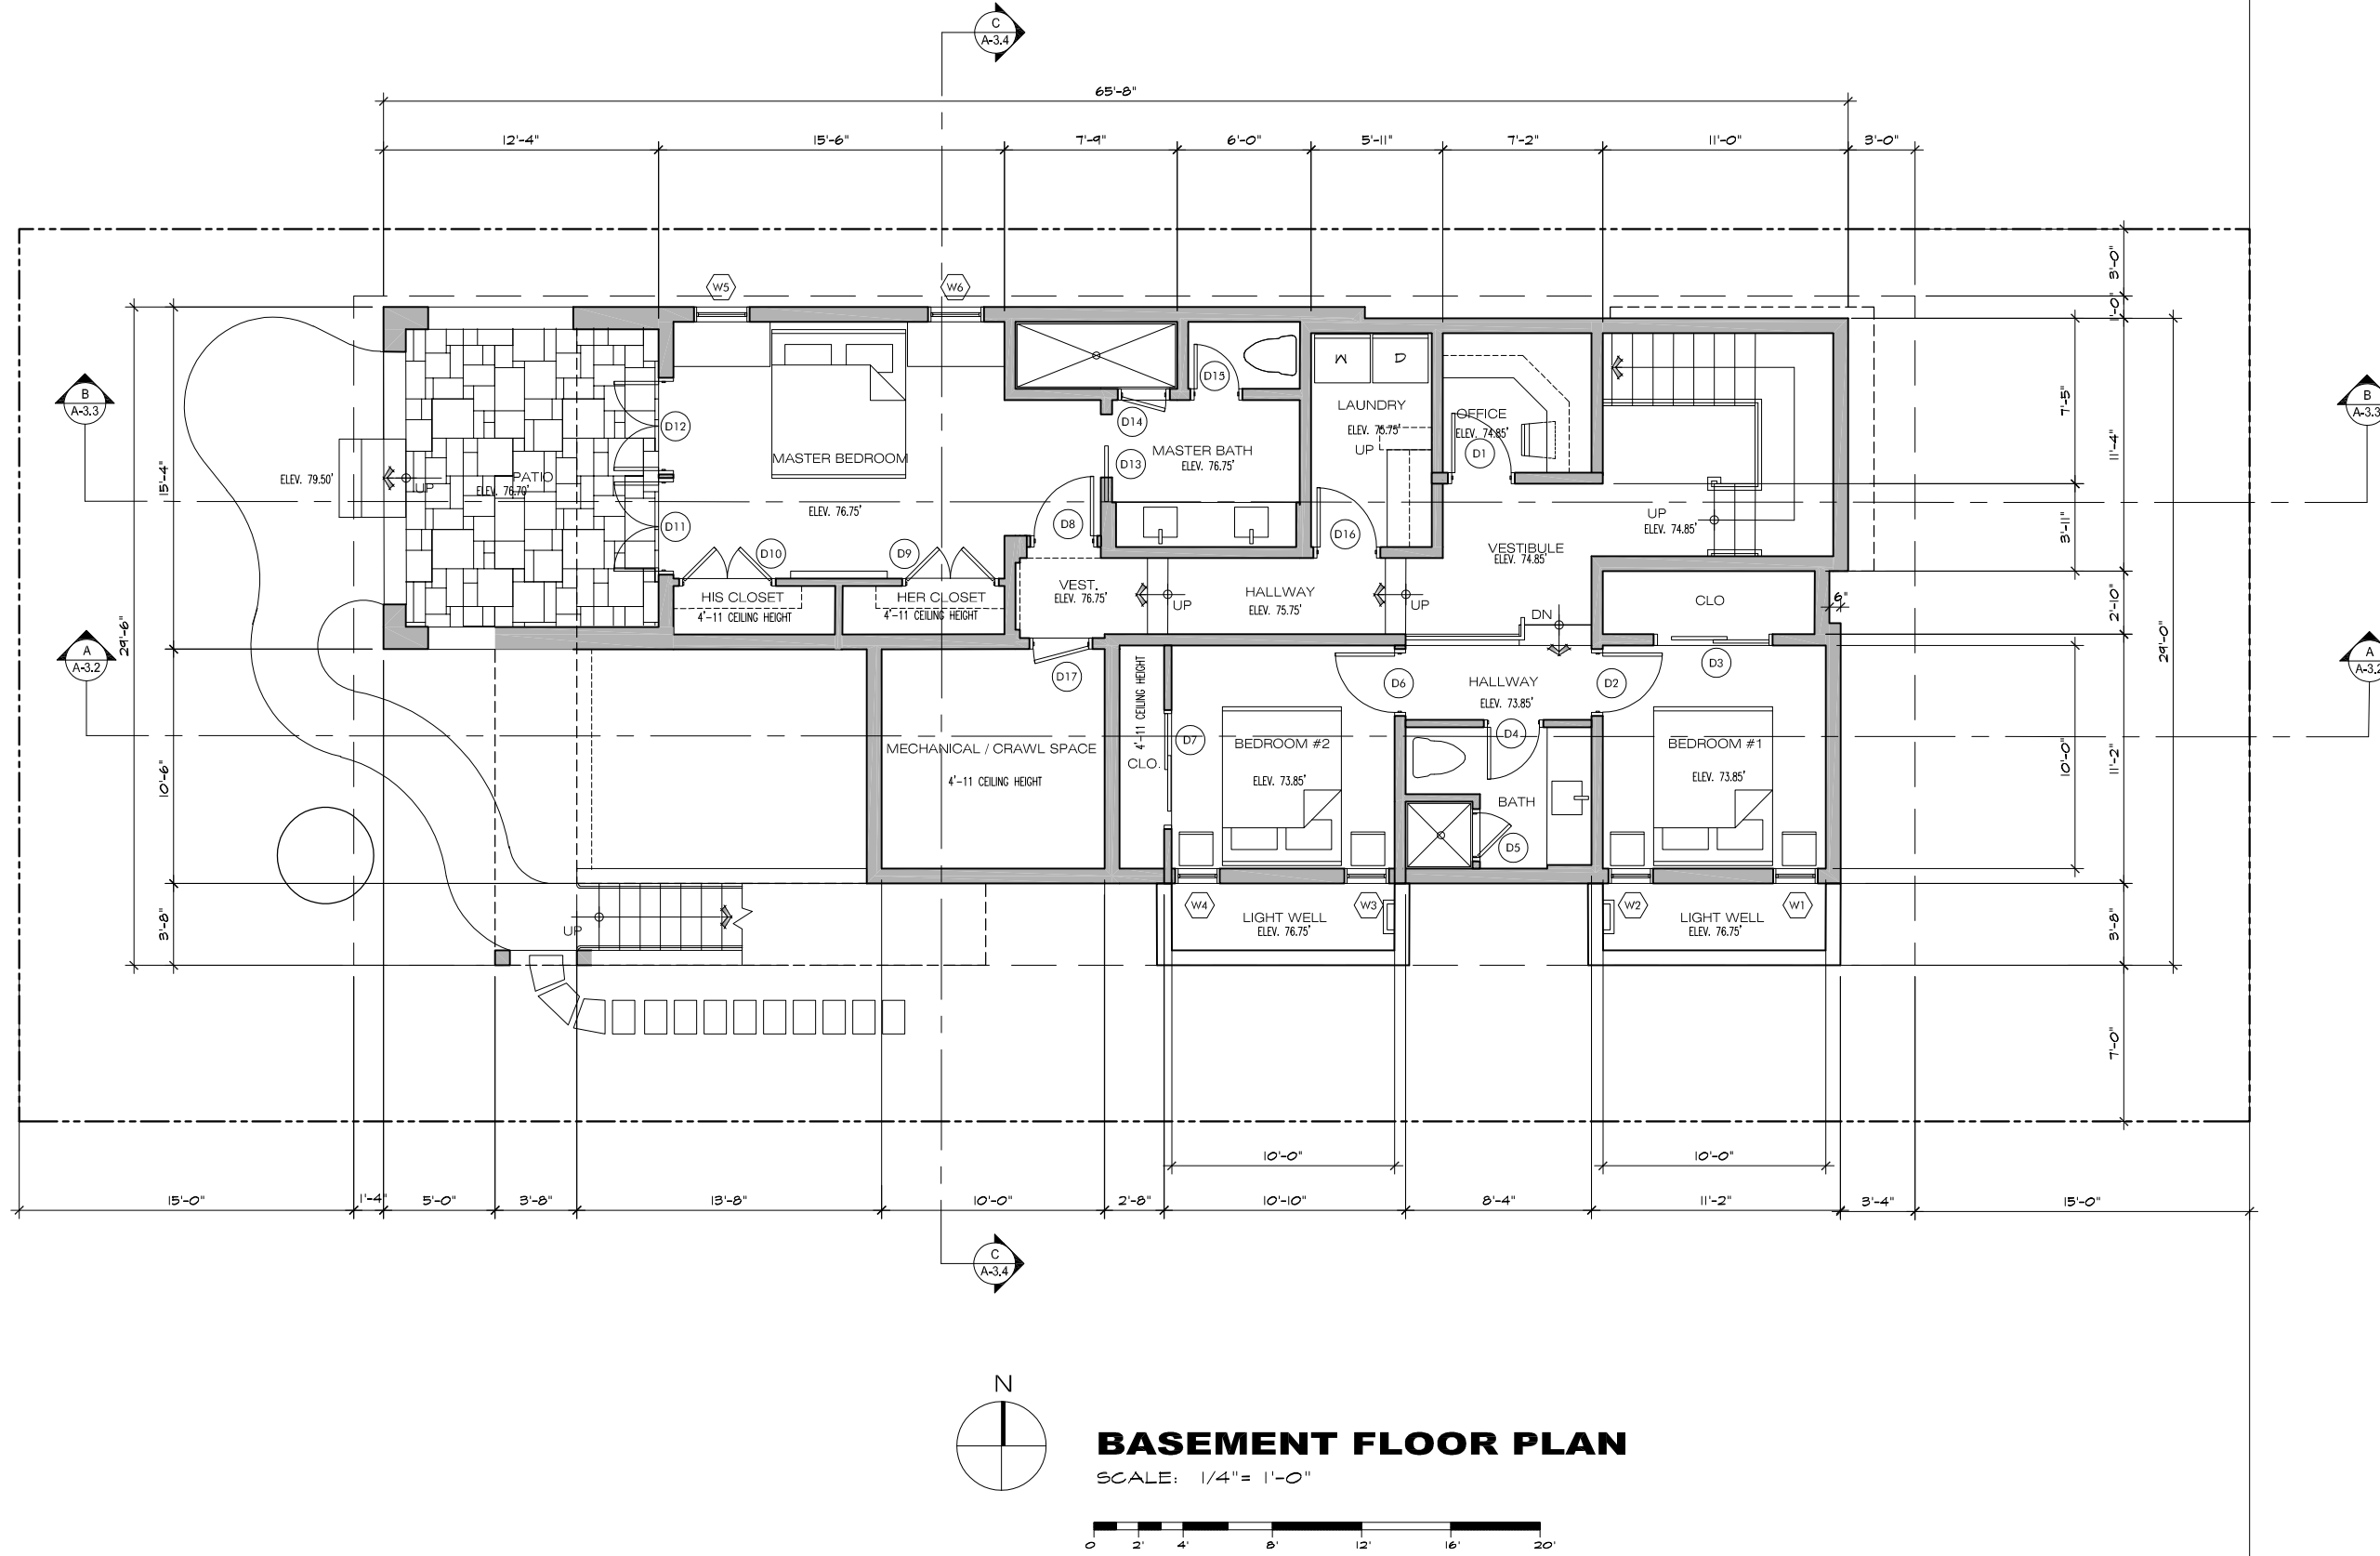

BASEMENT FLOOR PLAN

SCALE: 1/4" = 1'-0"



| REVISION | No. |
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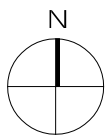
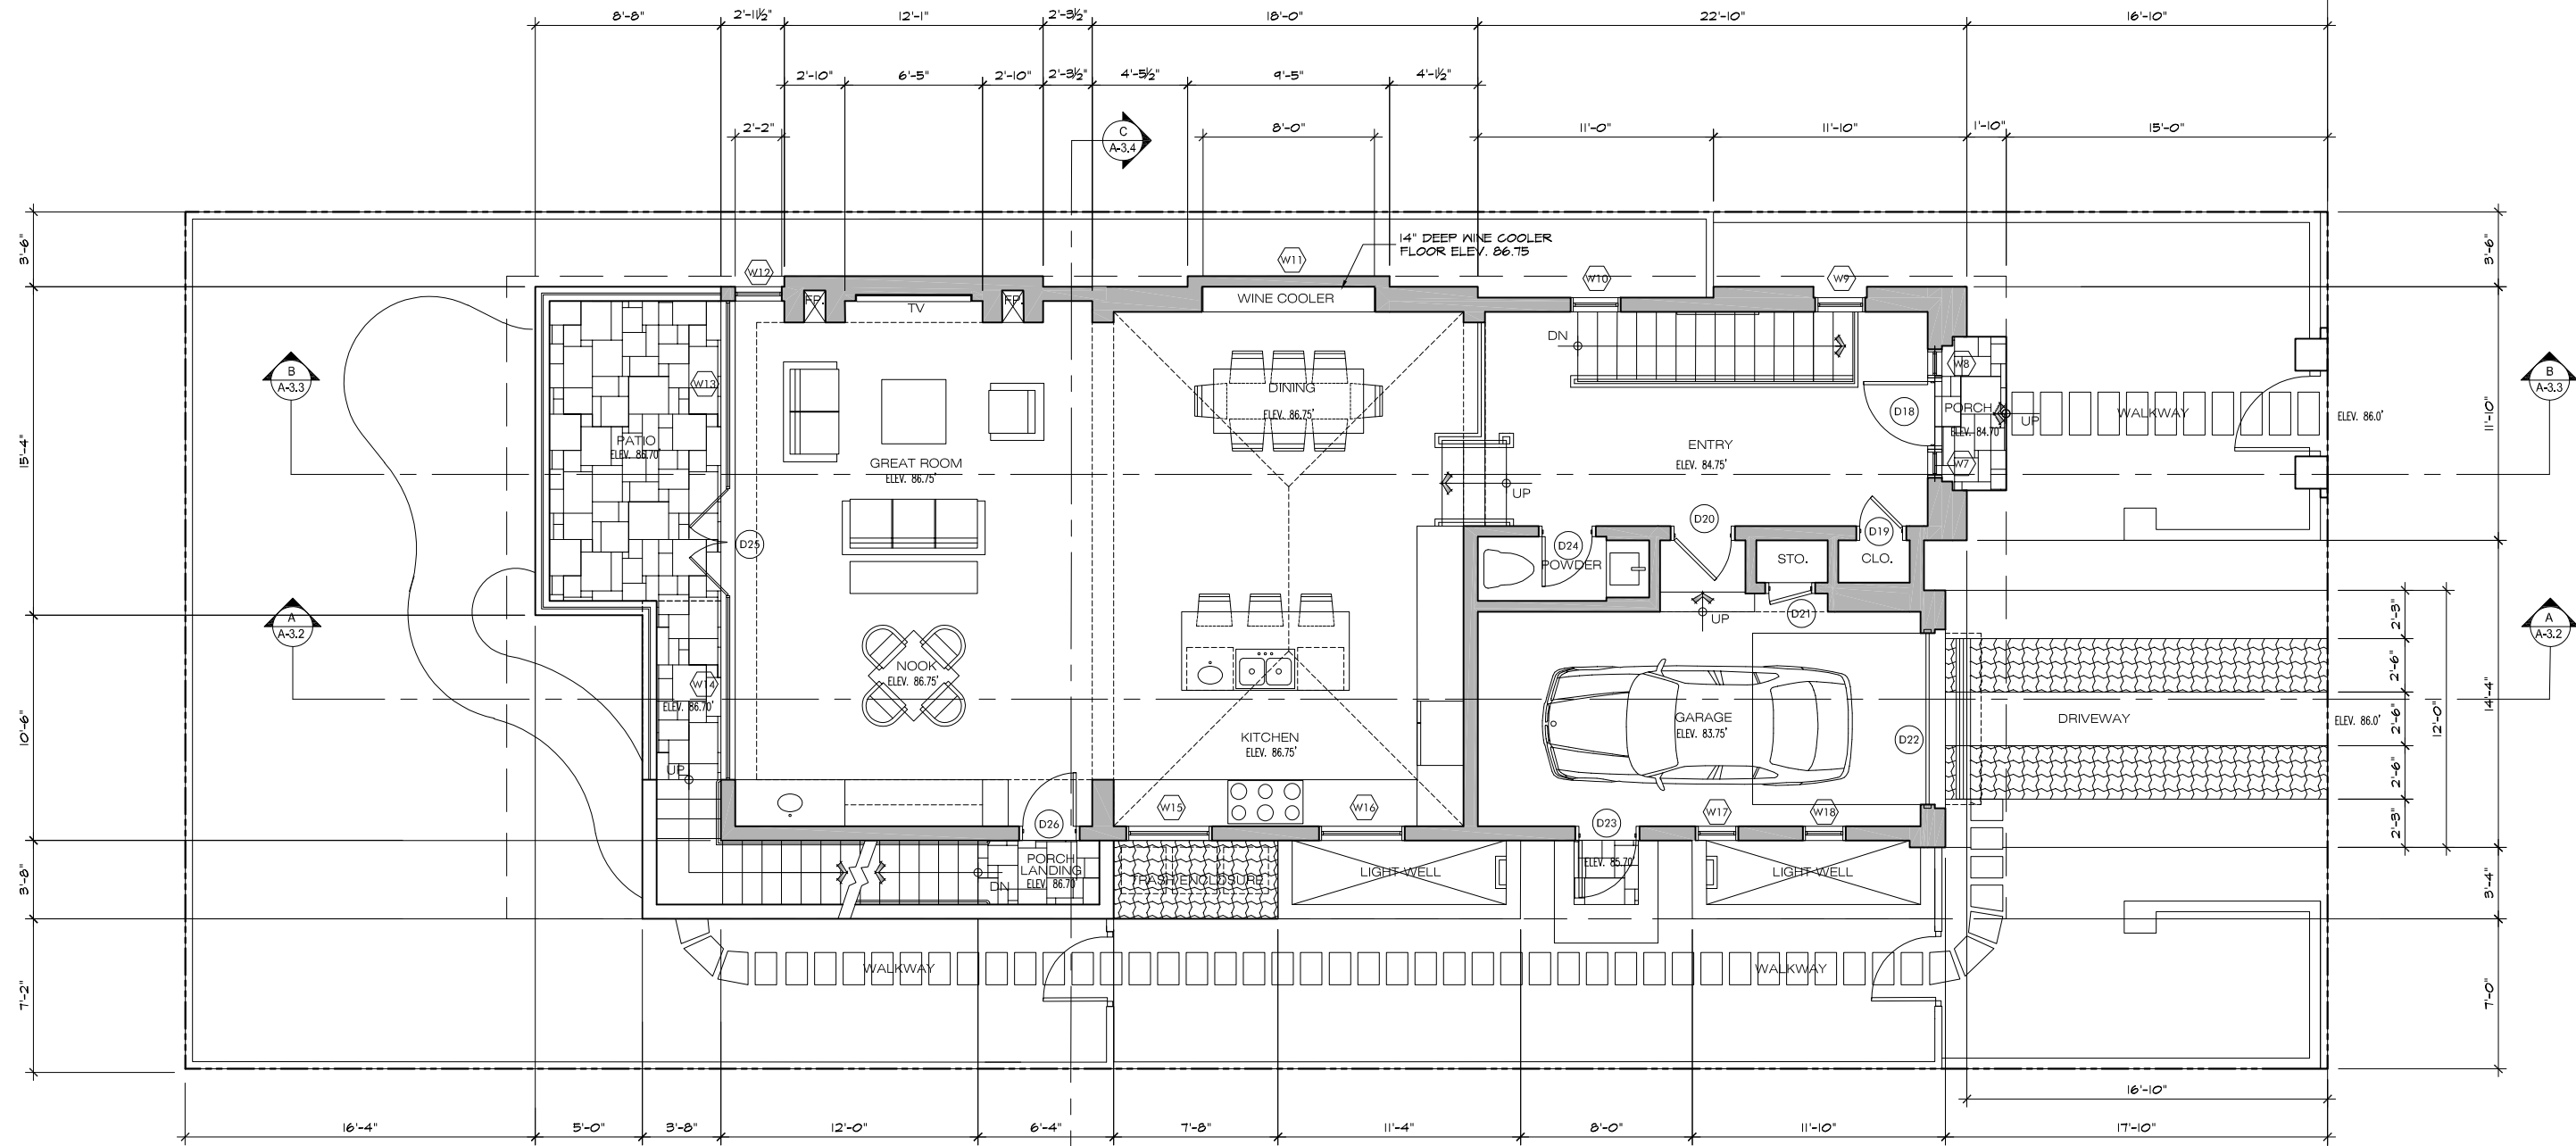
CONSULTANT:

ERIC MILLER ARCHITECTS, INC.
 211 HOFFMAN AVENUE MONTEREY, CA 93940
 PHONE (831) 372-0410 • FAX (831) 372-7840 • WEB: www.ericmillerarchitects.com

ARCHITECT

BASEMENT FLOOR PLAN
 JOB NAME: **Witt Residence**
 Carmelo 2NW of 4th Street
 Carmel, By-The-Sea, CA
 APN: 010-269-005-000

DATE: 6/5/19
 SCALE: 1/4"=1'-0"
 DRAWN: DM
 JOB NUMBER: 17.20



MAIN FLOOR PLAN

SCALE: 1/4" = 1'-0"





| REVISION | No. |
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MAIN FLOOR PLAN
 JOB NAME: **Witt Residence**
 Carmelo 2NW of 4th Street
 Carmel, By-The-Sea, CA
 APN: 010-269-005-000

DATE: 6/5/19
 SCALE: 1/4" = 1'-0"
 DRAWN: DM
 JOB NUMBER: 17.20



ROOF PLAN

SCALE: 1/4" = 1'-0"

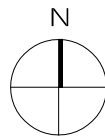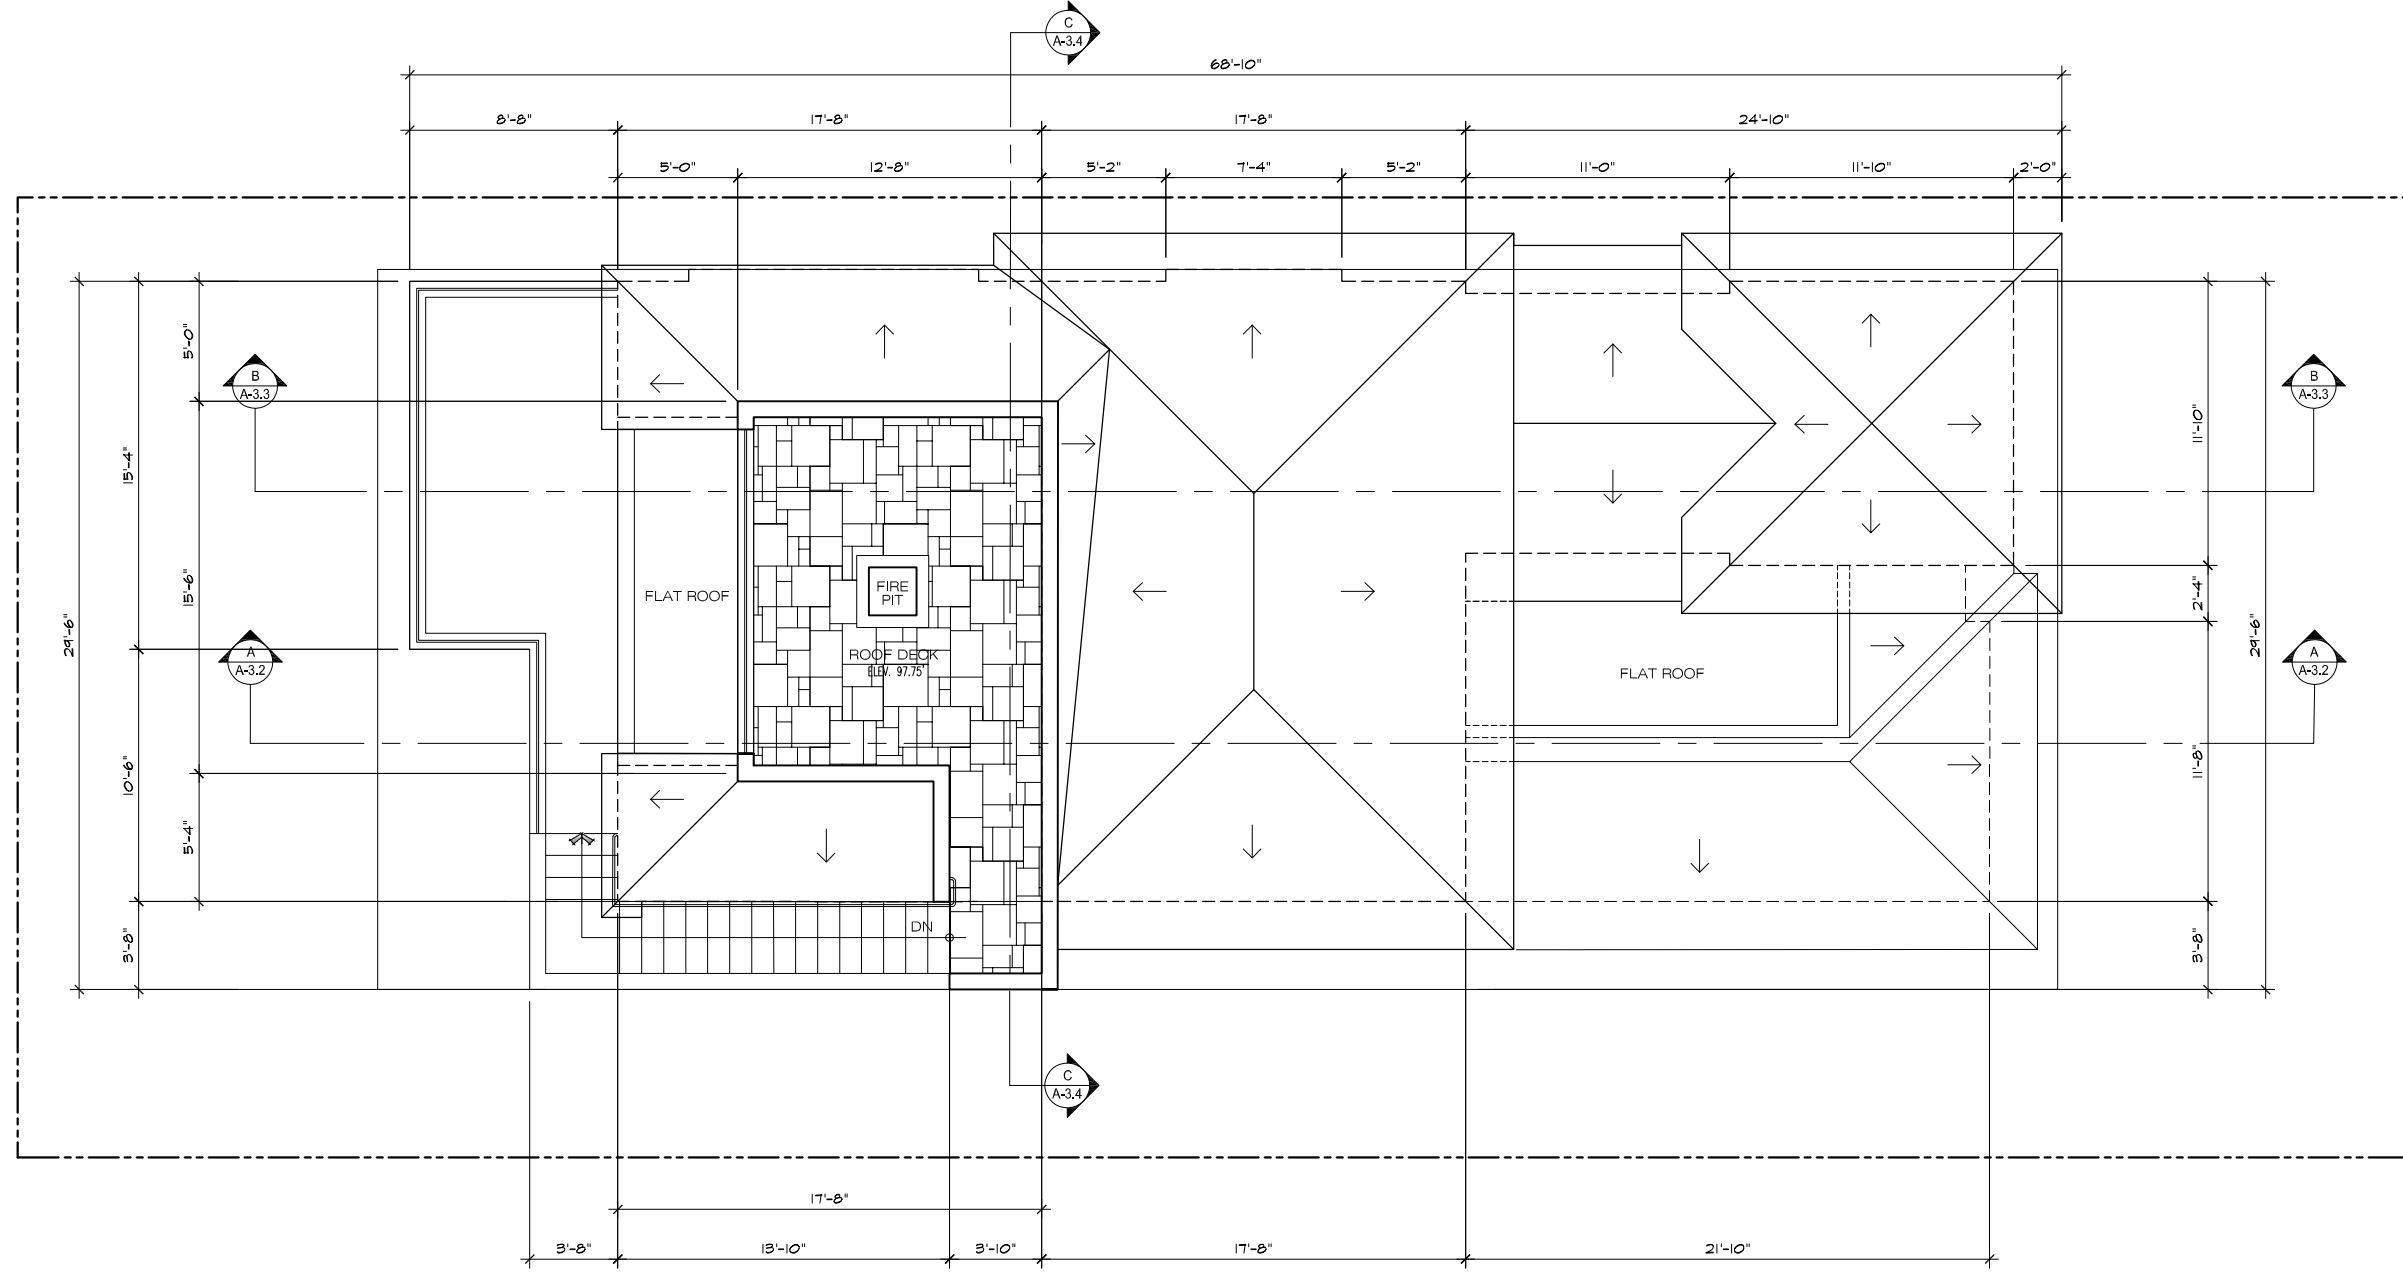

| REVISION | No. |
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ROOF PLAN

JOB NAME:
Witt Residence
 Carmelo 2NW of 4th Street
 Carmel, By-The-Sea, CA
 APN: 010-269-005-000

DATE: 6/5/19


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DRAWN: DM


JOB NUMBER: 17.20

A-2.2
 SHEET OF

THE USE OF THESE DRAWINGS AND SPECIFICATIONS IS SOLELY RESTRICTED TO THE ORIGINAL SITE FOR WHICH THEY WERE PREPARED. REPRODUCTION OR PUBLICATION IN WHOLE OR IN PART, IS STRICTLY PROHIBITED - TITLE TO THESE DRAWINGS AND SPECIFICATIONS REMAINS WITH THE ARCHITECT WITHOUT PREJUDICE. VISUAL CONTACT WITH THESE DRAWINGS & SPECIFICATIONS SHALL CONSTITUTE FORMAL NOTICE OF ACCEPTANCE OF THESE RESTRICTIONS.

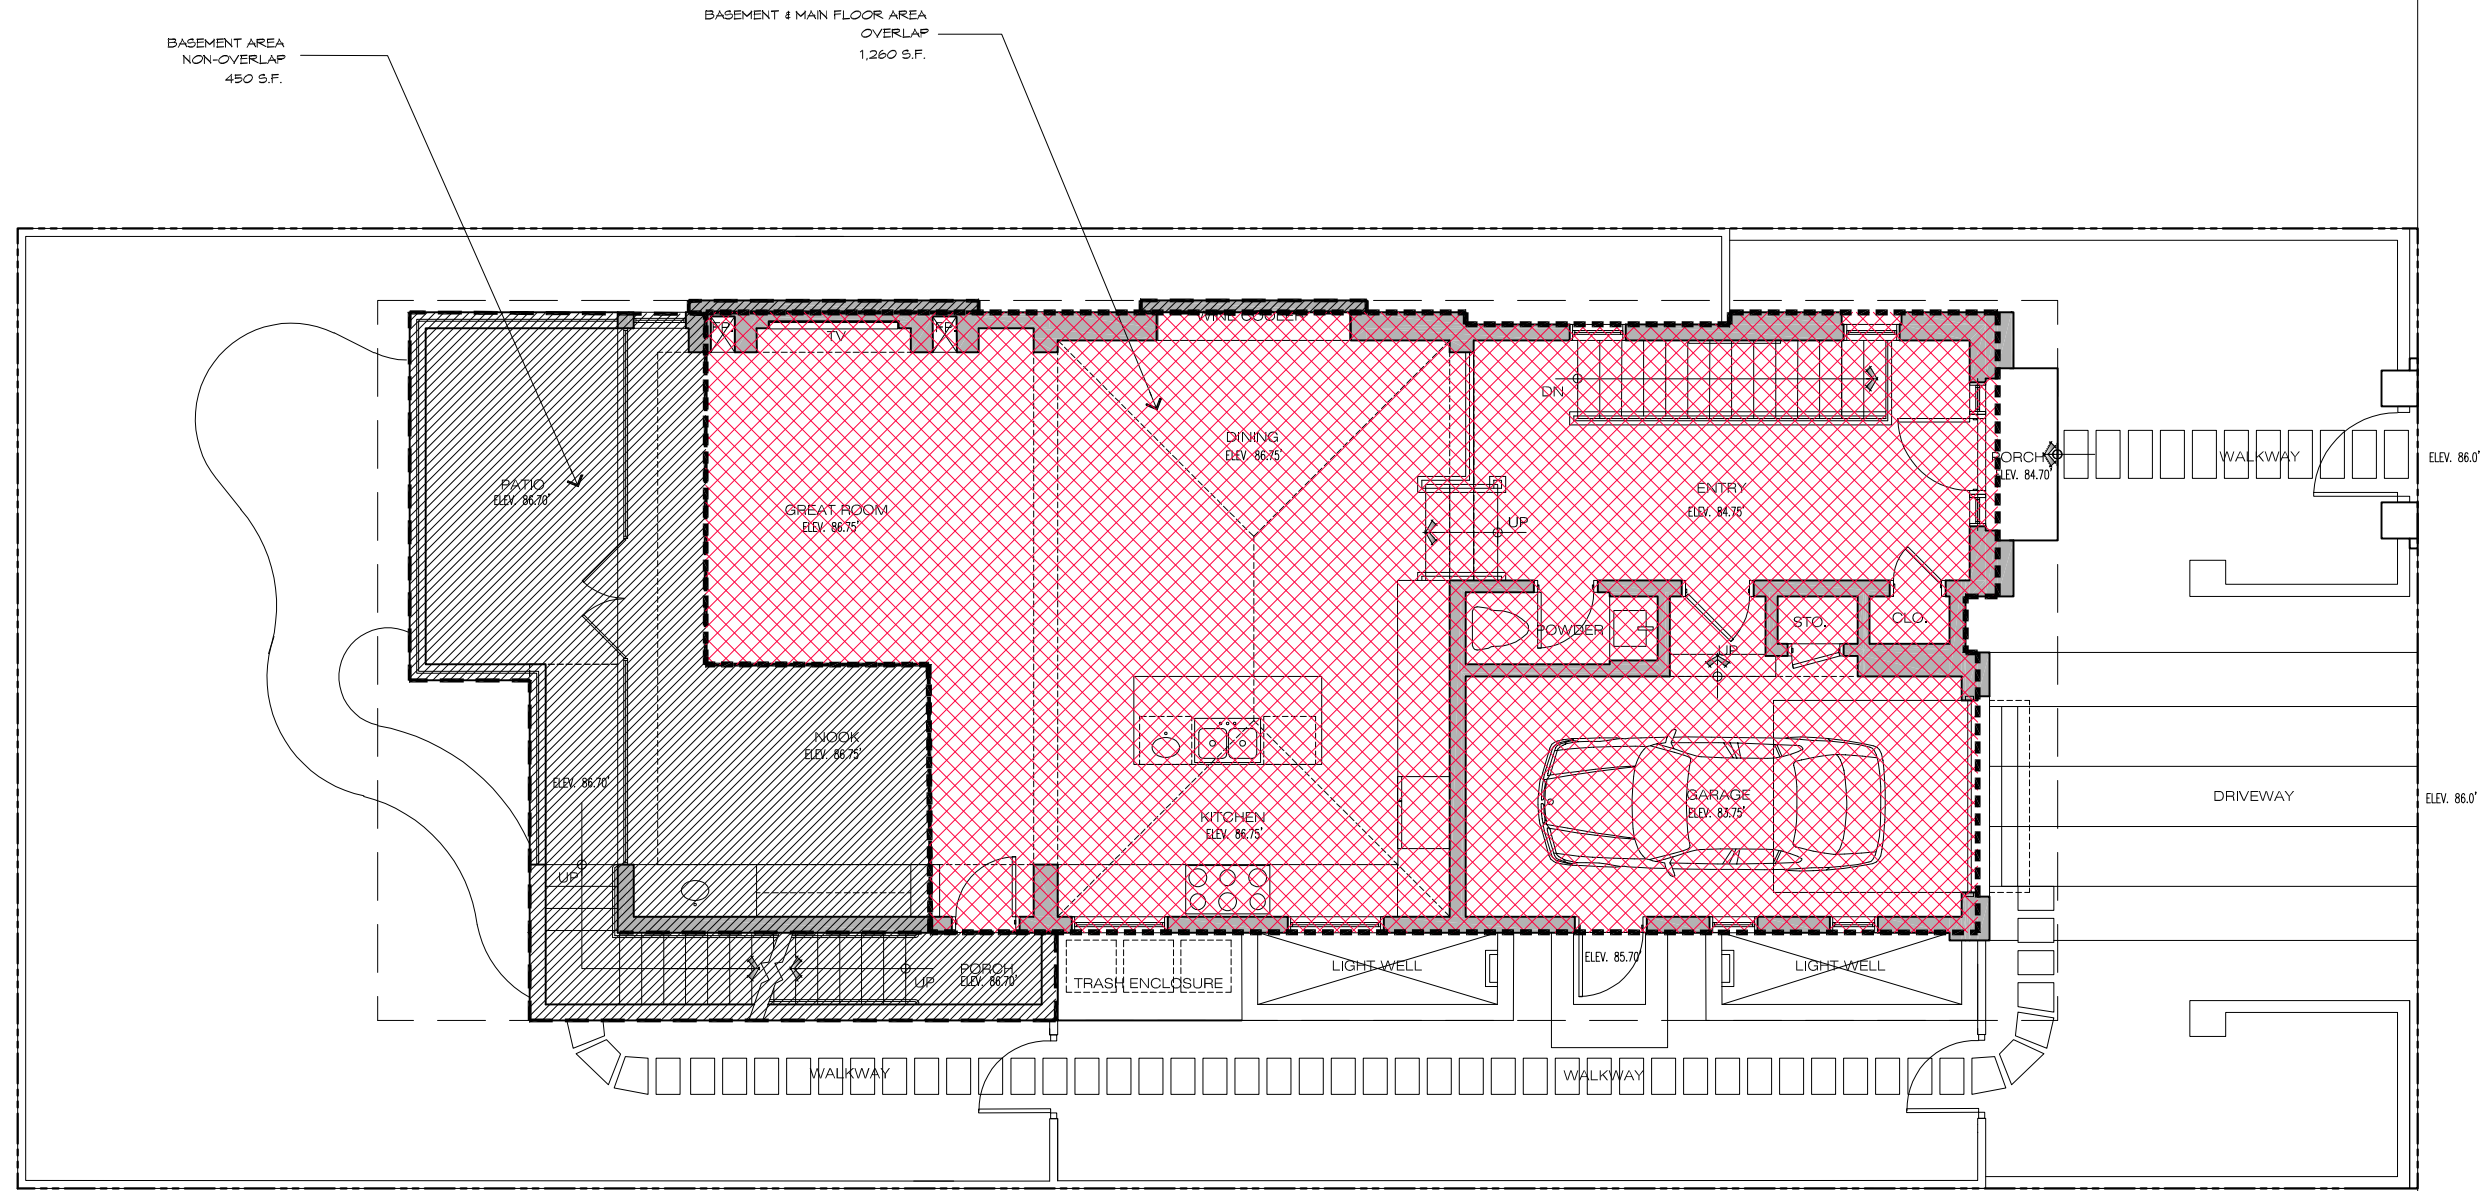

| LEGEND | |
|--------|---|
| | OVERLAPPING & NON OVERLAPING FLOOR AREA |
| | OVERLAPPING FLOOR AREA = 1,260 S.F. |
| | NON-OVERLAPPING FLOOR AREA = 450 S.F. |

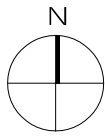

BASEMENT / LOWER & MAIN FLOOR OVERLAY

SCALE: 1/4" = 1'-0"



| REVISION | No. |
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CONSULTANT:

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 PHONE (831) 372-0410 • FAX (831) 372-7840 • WEB: www.ericmillerarchitects.com


BASEMENT/LOWER & MAIN FLOOR OVERLAY

JOB NAME:
Witt Residence
 Carmelo 210W of 4th Street
 Carmel, By-The-Sea, CA
 APN: 010-269-005-000

DATE: 6/5/19
 SCALE: 1/4"=1'-0"
 DRAWN: DM
 JOB NUMBER: 17.20


A-2.3
 SHEET OF

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FRONT / EAST ELEVATION

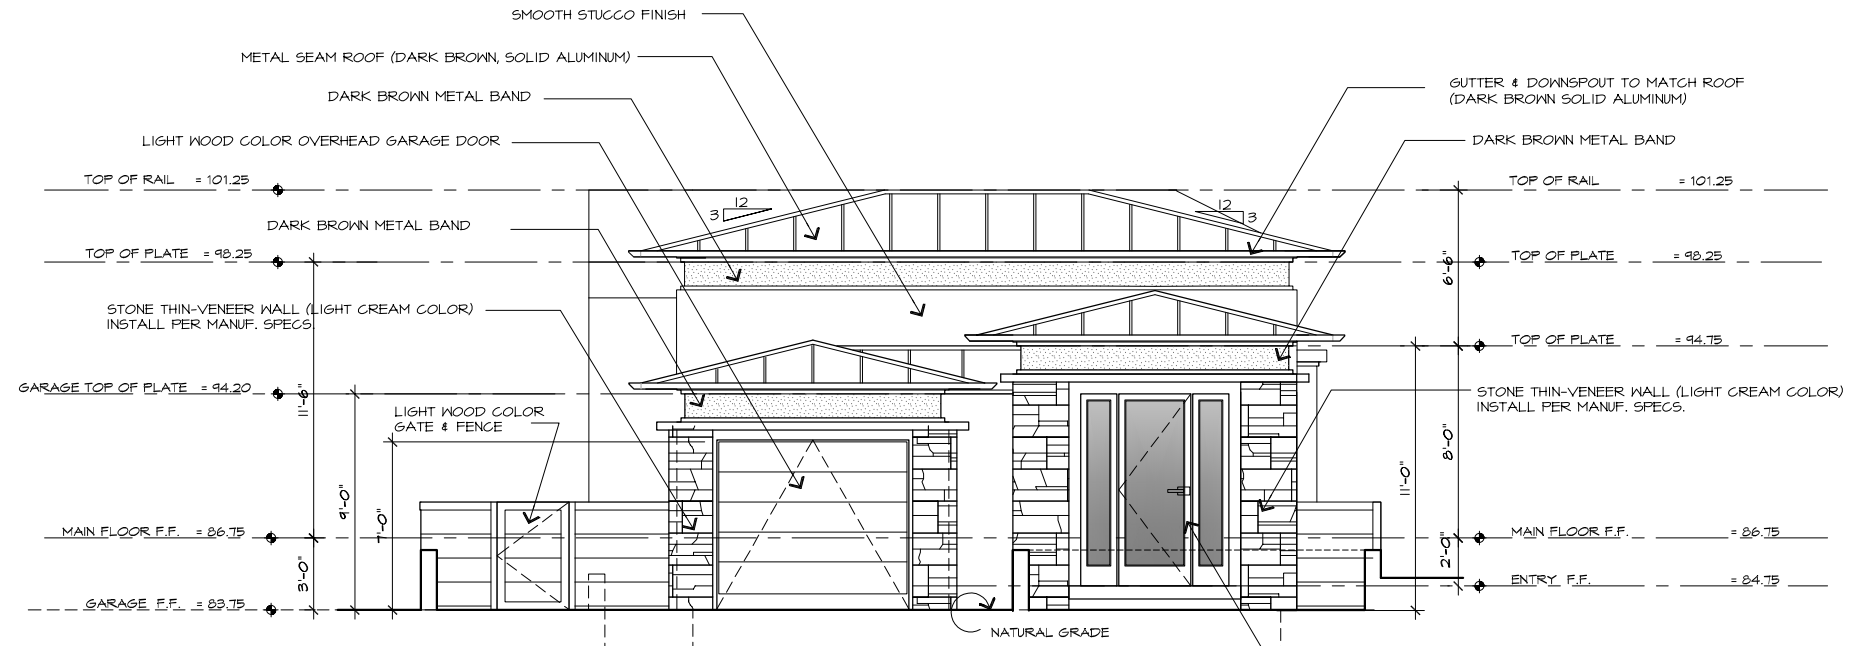SCALE: 1/4" = 1'-0"



SIDE / NORTH ELEVATION

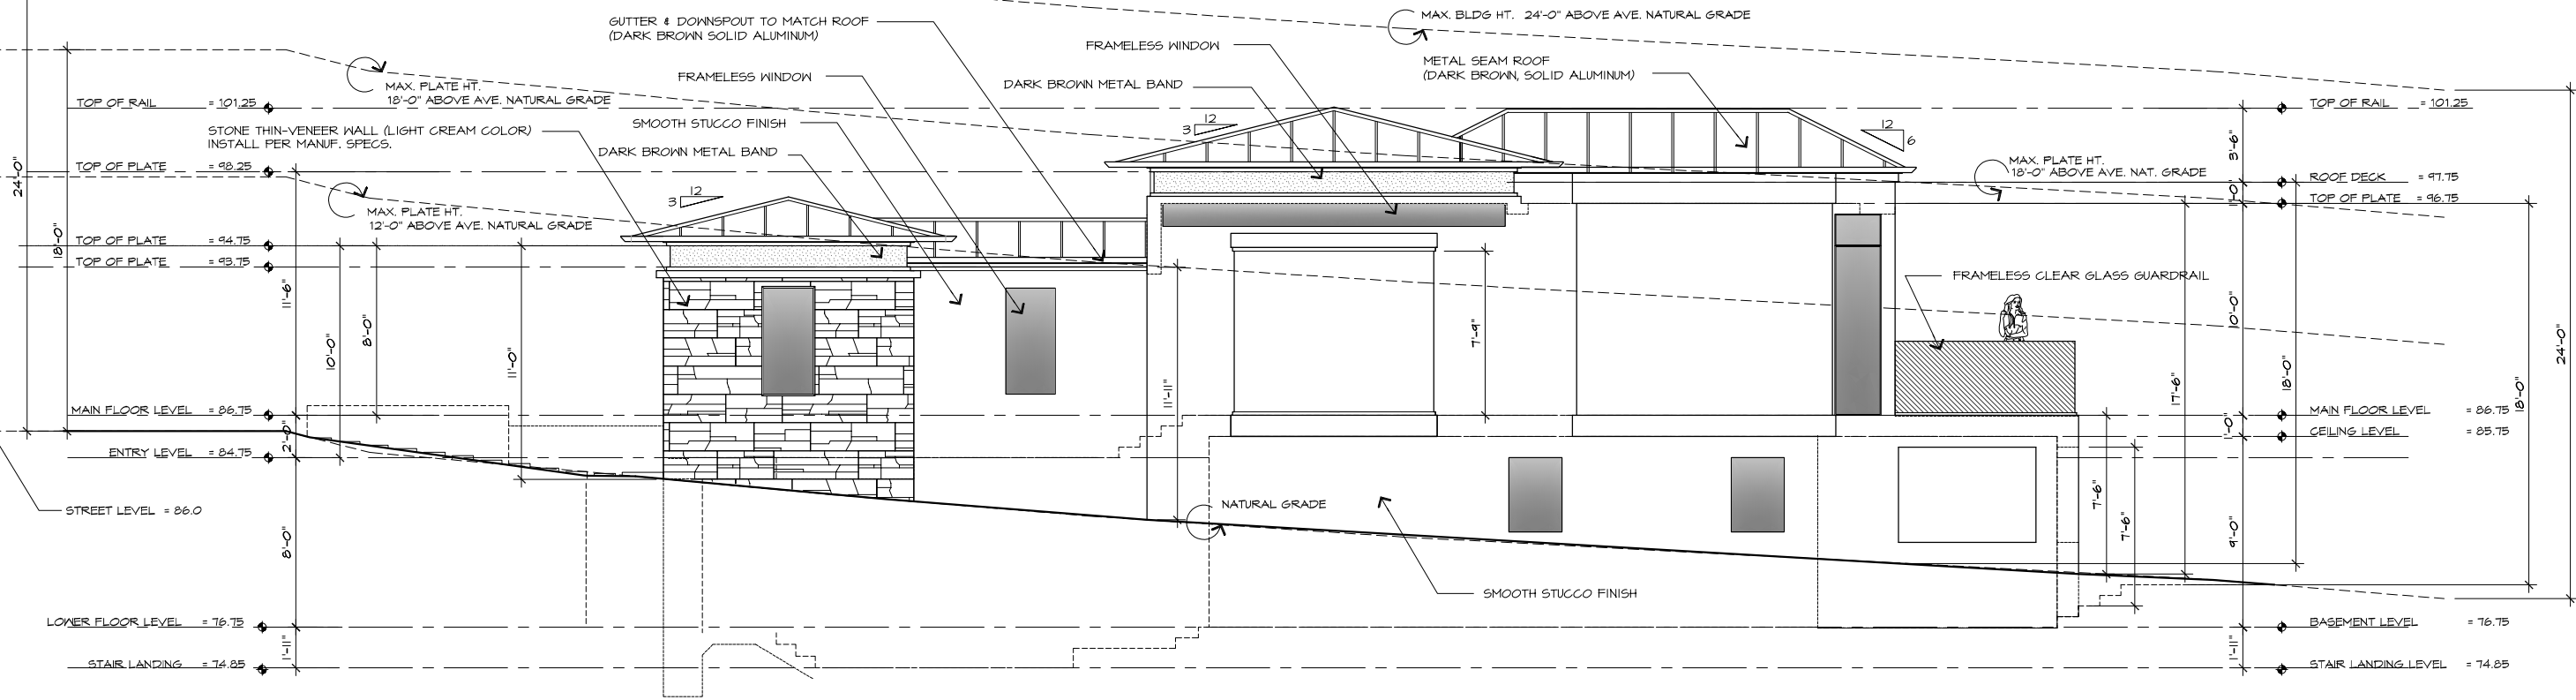SCALE: 1/4" = 1'-0"



| REVISION | No. |
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CONSULTANT:

ARCHITECT
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EXTERIOR ELEVATIONS

JOB NAME:
Witt Residence
 Carmelo 2NW of 4th Street
 Carmel, By-The-Sea, CA
 APN: 010-269-005-000

DATE: 6/5/19


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DRAWN: DM

JOB NUMBER: 17.20


A-3.0
 SHEET OF

THE USE OF THESE DRAWINGS AND SPECIFICATIONS IS SOLELY RESTRICTED TO THE ORIGINAL USER FOR WHICH THEY WERE PREPARED. PUBLICATION OR REPRODUCTION OF THESE DRAWINGS OR SPECIFICATIONS IN WHOLE OR IN PART IS STRICTLY PROHIBITED. NO PART OF THESE DRAWINGS OR SPECIFICATIONS SHALL CONSTITUTE A CONTRACT OR BE TAKEN AS AN INDICATION OF ACCEPTANCE OF THESE DRAWINGS.

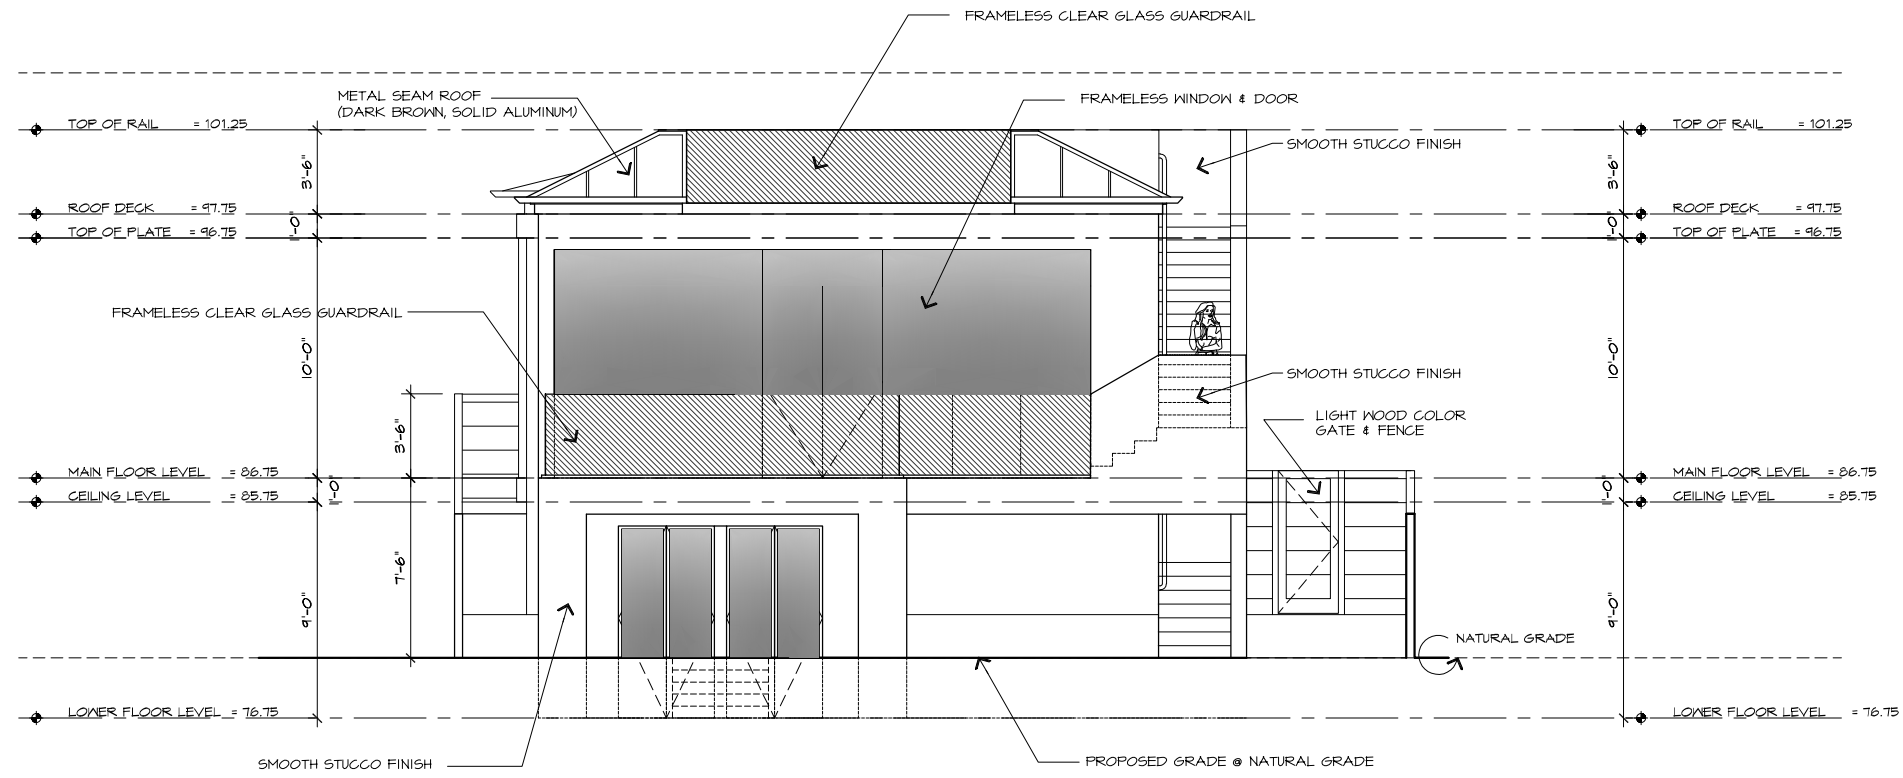

REAR / WEST ELEVATION

SCALE: 1/4" = 1'-0"

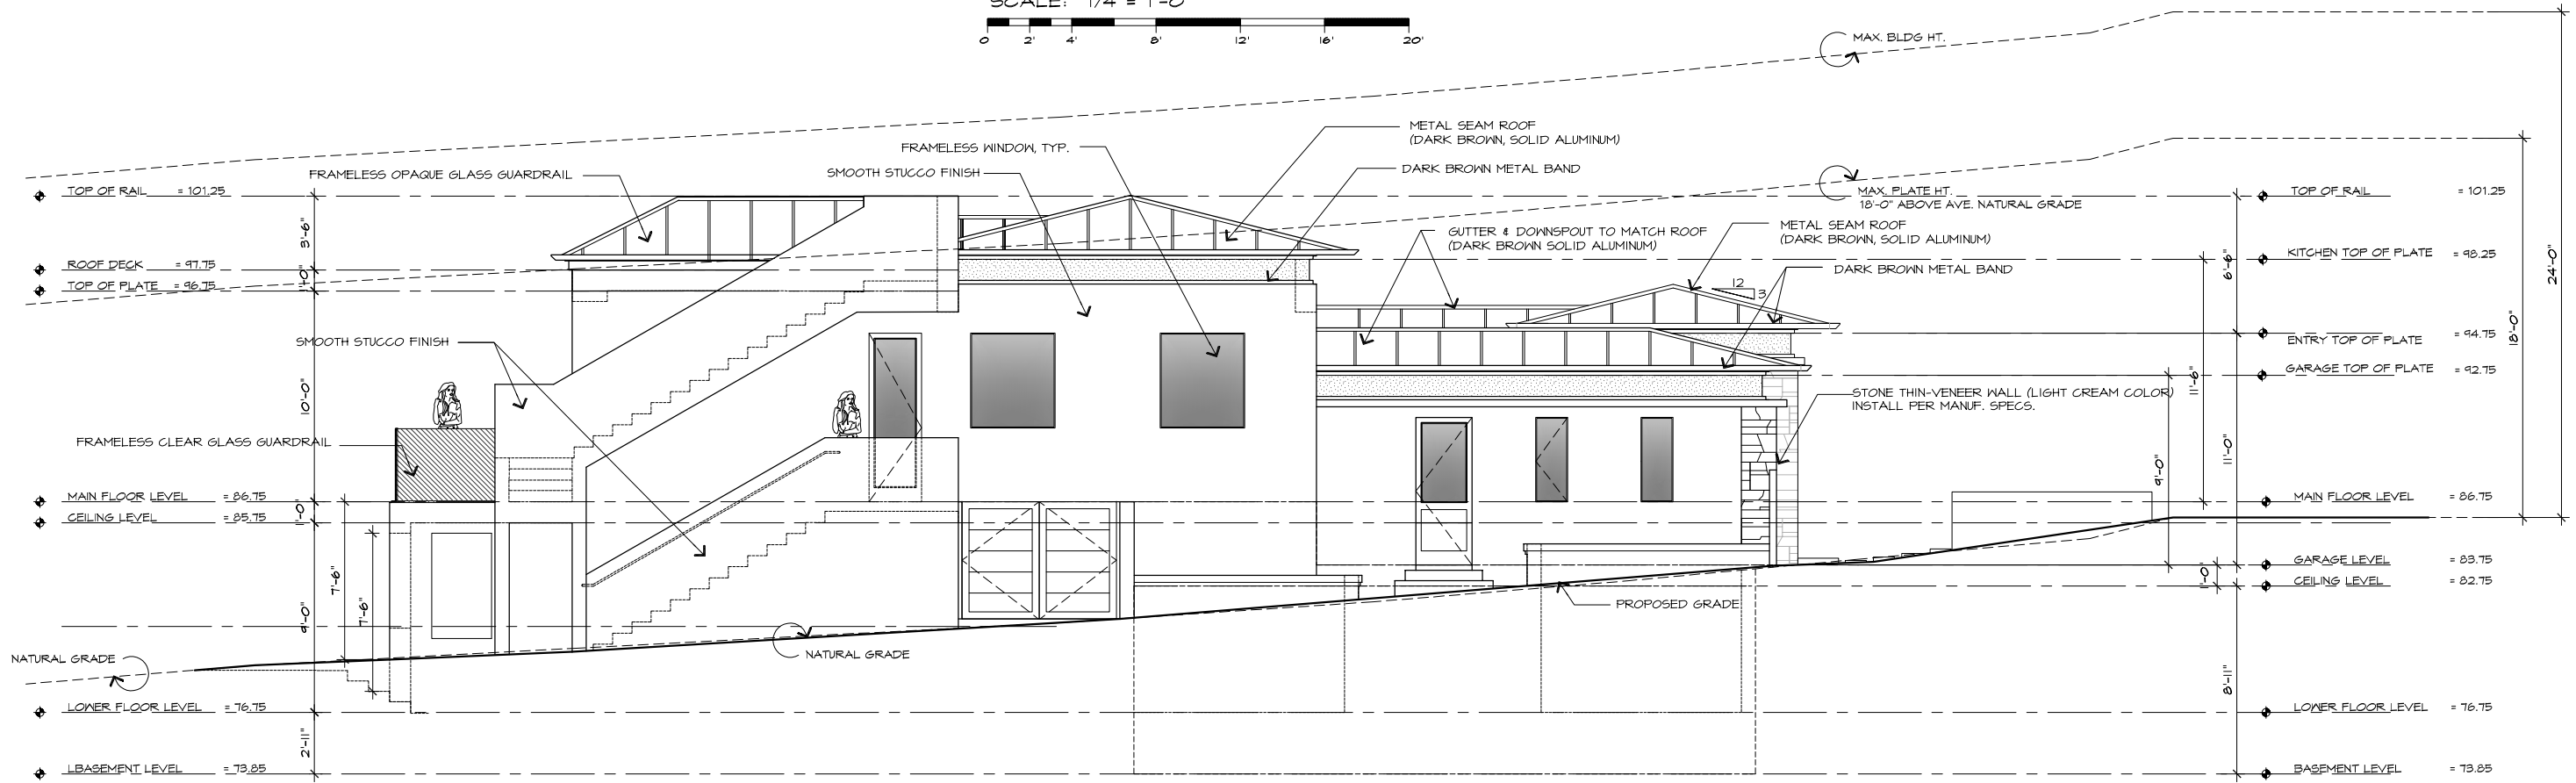

SIDE / SOUTH ELEVATION

SCALE: 1/4" = 1'-0"



| REVISION | No. |
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CONSULTANT:

ARCHITECT
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 PHONE (831) 372-0410 • FAX (831) 372-7840 • WEB: www.ericmillerarchitects.com

EXTERIOR ELEVATIONS

JOB NAME:
Witt Residence
 Carmelo 2NW of 4th Street
 Carmel, By-The-Sea, CA
 APN: 010-269-005-000

DATE: 6/5/19


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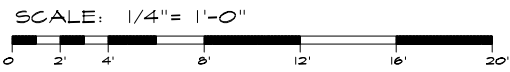
JOB NUMBER: 17.20

A-3.1
 SHEET OF

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BUILDING SECTION 'A' - 'A'



| REVISION | No. |
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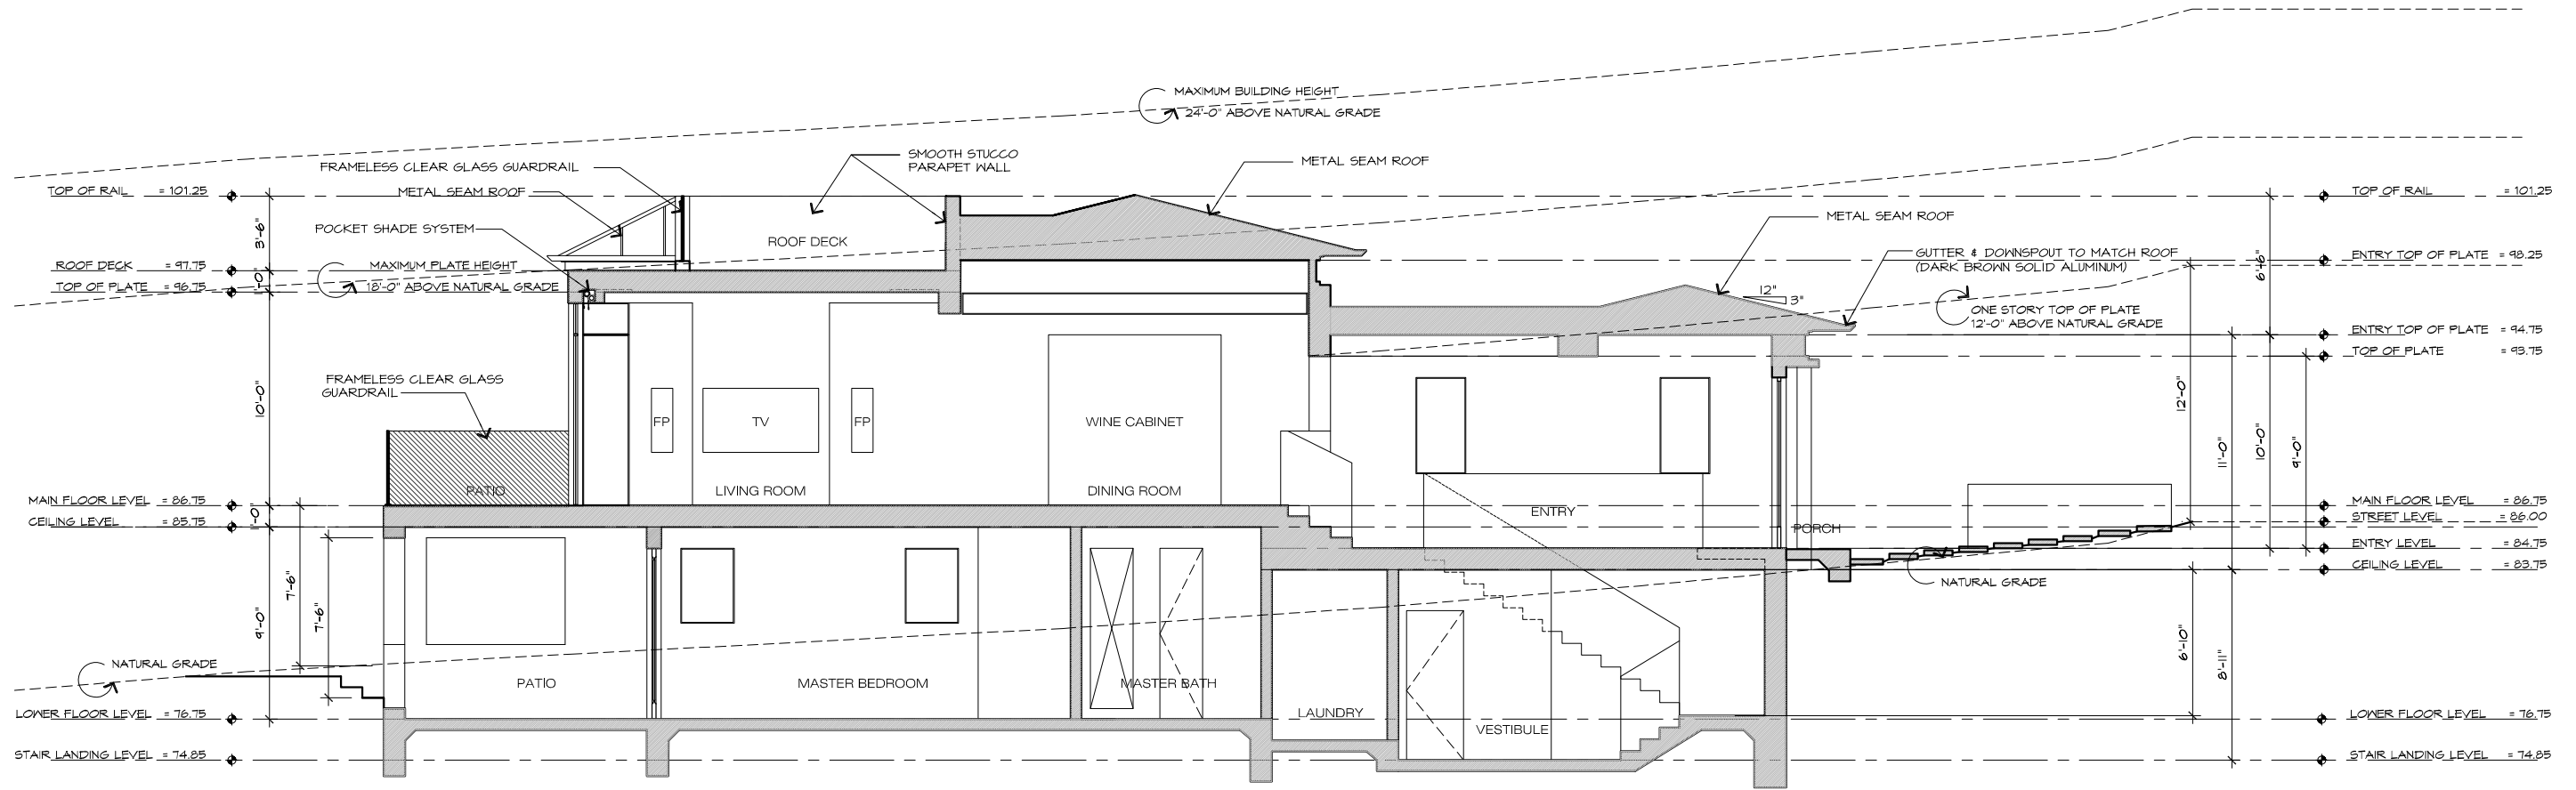
CONSULTANT:
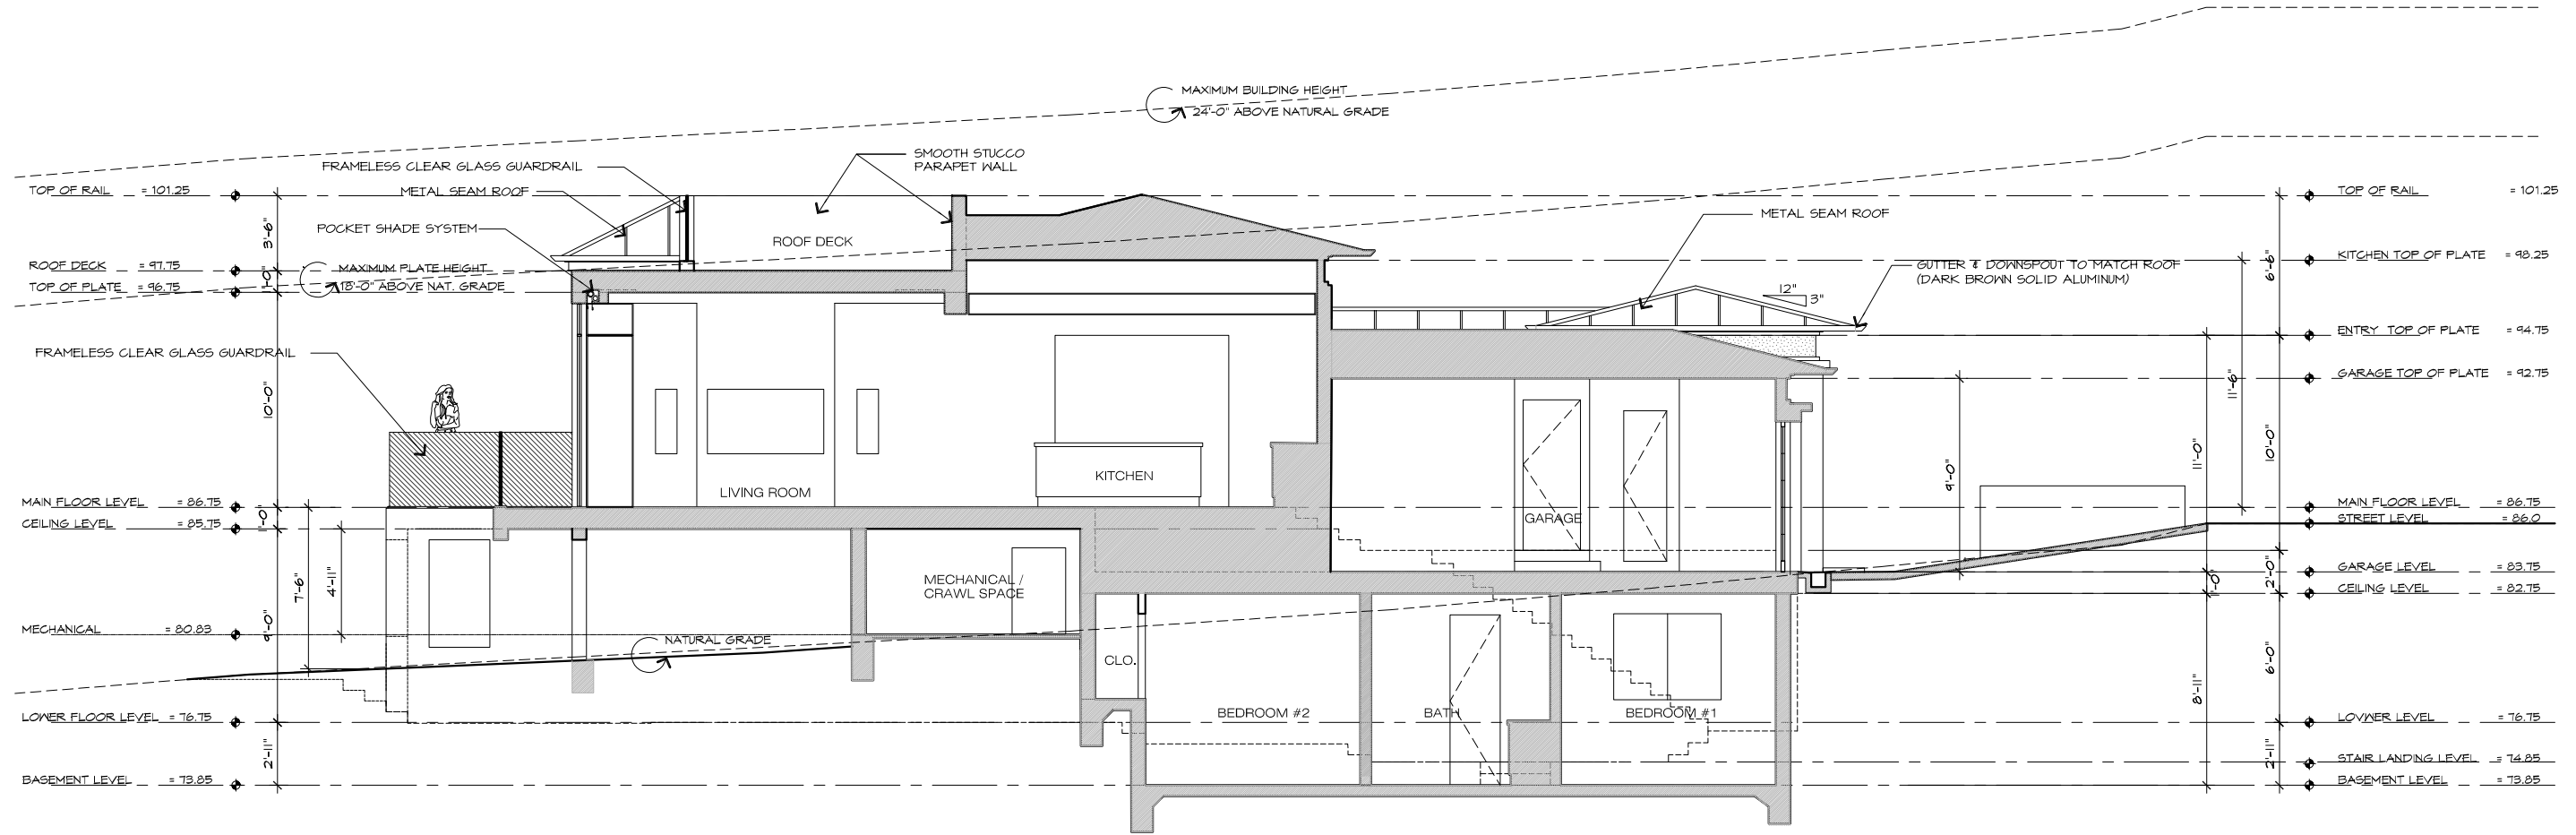
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 211 HOFFMAN AVENUE MONTEREY, CA 93940
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BUILDING SECTION 'A' - 'A'
 JOB NAME: **Witt Residence**
 Carmelo 23NW of 4th Street
 Carmel, By-The-Sea, CA
 APN: 010-269-005-000

DATE: 6/5/19
 SCALE: 1/4" = 1'-0"
 DRAWN: DM
 JOB NUMBER: 17.20

THE USE OF THESE DRAWINGS AND SPECIFICATIONS IS SOLELY RESTRICTED TO THE ORIGINAL USE FOR WHICH THEY WERE PREPARED. REPRODUCTION OR PUBLICATION IN WHOLE OR IN PART, IS STRICTLY PROHIBITED - TITLE TO THESE DRAWINGS AND SPECIFICATIONS REMAINS WITH THE ARCHITECT WITHOUT PREJUDICE. SHALL CONSENT WITH THESE DRAWINGS & SPECIFICATIONS SHALL CONSTITUTE FINAL ACCEPTANCE OF THESE DRAWINGS.



BUILDING SECTION 'B' - 'B'

SCALE: 1/4" = 1'-0"
0 2' 4' 8' 12' 16' 20'

| REVISION | No. |
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CONSULTANT:

ARCHITECT
ERIC MILLER ARCHITECTS, INC.
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 PHONE (831) 372-0410 • FAX (831) 372-7840 • WEB: www.ericmillerarchitects.com


BUILDING SECTION 'B' - 'B'

JOB NAME: **Witt Residence**
 Carmelo 21NW of 4th Street
 Carmel, By-The-Sea, CA
 APN: 010-269-005-000

DATE: 6/5/19
 SCALE: 1/4"=1'-0"
 DRAWN: DM
 JOB NUMBER: 17.20

A-3.3
SHEET OF

THE USE OF THESE DRAWINGS AND SPECIFICATIONS IS SOLELY RESTRICTED TO THE ORIGINAL SITE FOR WHICH THEY WERE PREPARED. REPRODUCTION OR PUBLICATION IN WHOLE OR IN PART IS STRICTLY PROHIBITED - TITLE TO THESE DRAWINGS AND SPECIFICATIONS REMAINS WITH THE ARCHITECT WITHOUT PREJUDICE. SHALL CONVEY WITH THESE DRAWINGS & SPECIFICATIONS SHALL CONSTITUTE FROM ANY EXERCISE OF ACCEPTANCE OF THESE RESTRICTIONS.

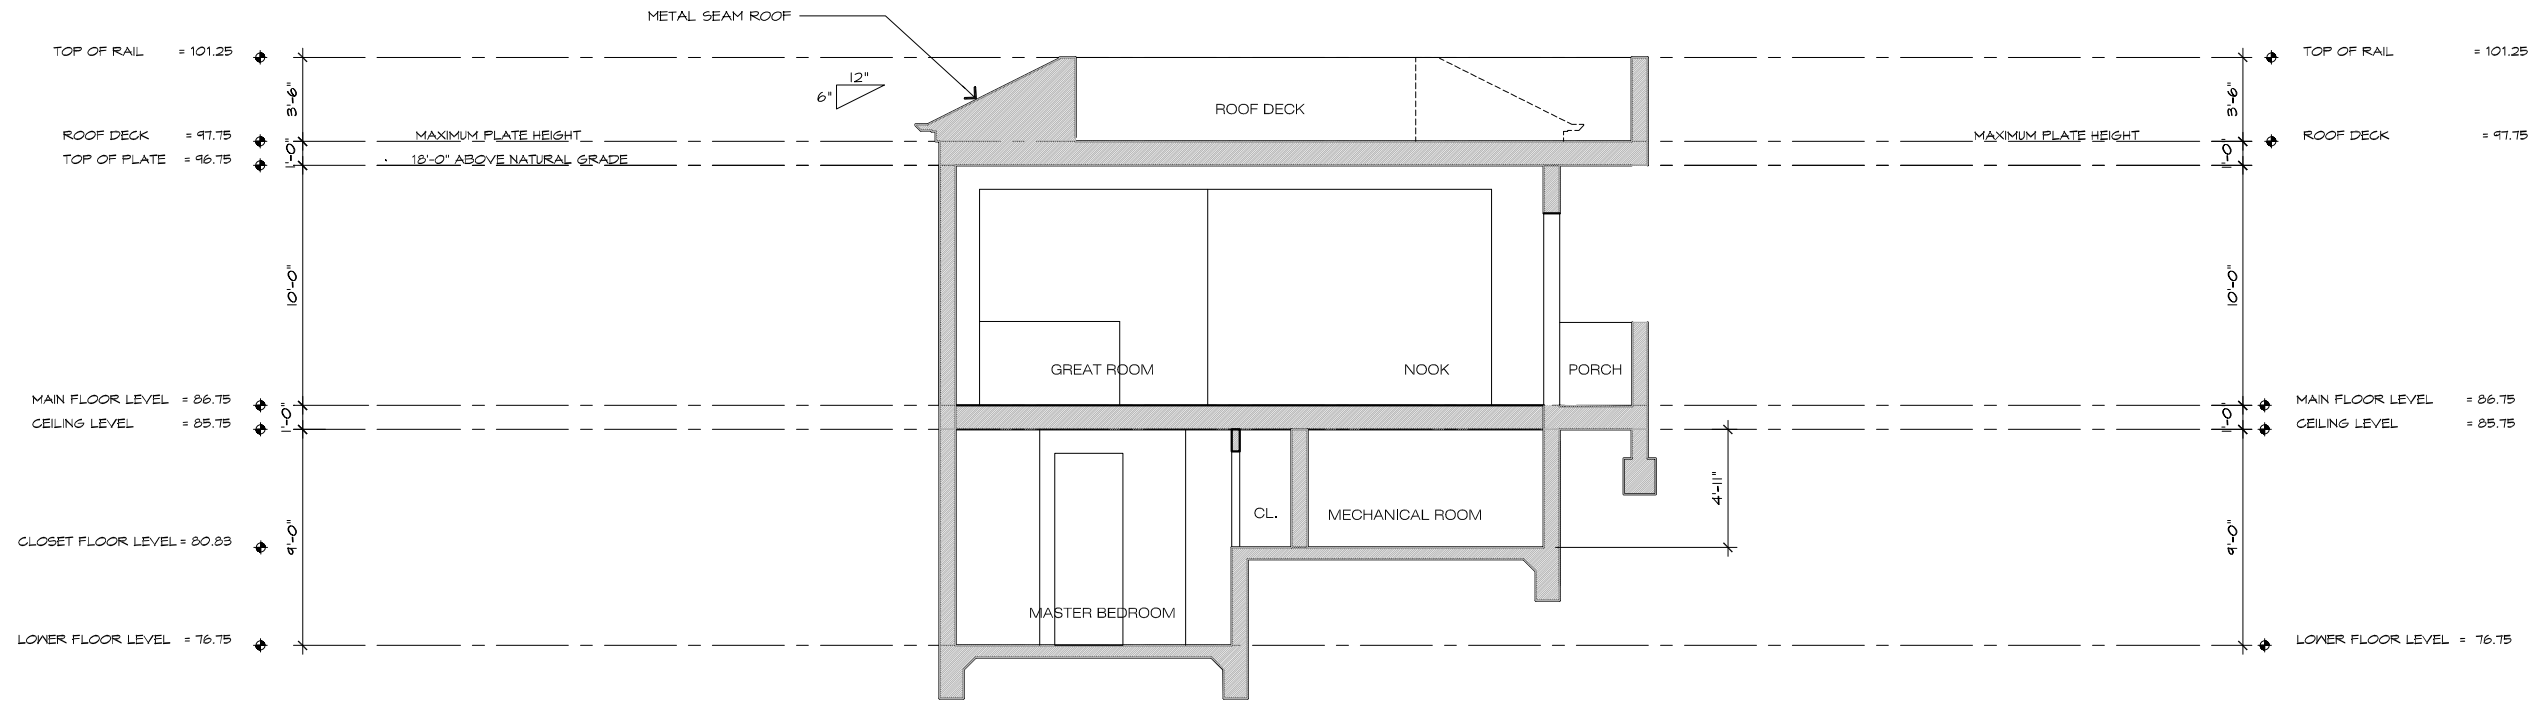

BUILDING SECTION 'C' - 'C'

SCALE: 1/4" = 1'-0"



| REVISION | No. |
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CONSULTANT:


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 211 HOFFMAN AVENUE MONTEREY, CA 93940
 PHONE (831) 372-0410 • FAX (831) 372-7840 • WEB: www.ericmillerarchitects.com

ARCHITECT

BUILDING SECTION 'C' - 'C'

JOB NAME: **Witt Residence**
 Carmelo 2NW of 4th Street
 Carmel, By-The-Sea, CA
 APN: 010-269-005-000

DATE: 6/5/19
 SCALE: 1/4"=1'-0"
 DRAWN: DM
 JOB NUMBER: 17.20

A-3.4
SHEET OF


| DOOR SCHEDULE | | | | | | | | | | | | |
|---------------|------|-----------|------------|----------|------------------|--------|-----------|------------|-------------|-------------|---------------|--|
| DOOR NO. | TYPE | DOOR SIZE | | ROOM NO. | ROOM NAME | THKNS. | DOOR MAT. | FRAME MAT. | HEAD DETAIL | JAMB DETAIL | THRSHD DETAIL | REMARKS |
| | | WIDTH "W" | HEIGHT "H" | | | | | | | | | |
| D1 | F | 2'-8" | 7'-0" | | OFFICE | 1-3/4" | WOOD | WOOD | | | | SOLID WOOD SWING DOOR |
| D2 | F | 2'-8" | 8'-0" | | BEDROOM #1 | 1-3/4" | WOOD | WOOD | | | | SOLID WOOD SWING DOOR |
| D3 | M | PR 2'-6" | 4'-6" | | CLOSET | 1-3/4" | WOOD | WOOD | | | | SOLID WOOD DOUBLE SLIDING DOOR |
| D4 | F | 2'-4" | 8'-0" | | BATH | 1-3/4" | WOOD | WOOD | | | | SOLID WOOD SWING DOOR |
| D5 | L | 2'-0" | 6'-8" | | SHOWER | | GLASS | METAL | | | | METAL FRAMED FROSTED GLASS SHOWER DOOR |
| D6 | F | 2'-8" | 8'-0" | | BEDROOM #2 | 1-3/4" | WOOD | WOOD | | | | SOLID WOOD SWING DOOR |
| D7 | M | PR 2'-6" | 4'-6" | | CLOSET | 1-3/4" | WOOD | WOOD | | | | SOLID WOOD DOUBLE SLIDING DOOR |
| D8 | F | 2'-8" | 8'-0" | | MASTER BEDROOM | 1-3/4" | WOOD | WOOD | | | | SOLID WOOD SWING DOOR |
| D9 | H | FR 2'-0" | 8'-0" | | HER CLOSET | 1-3/4" | WOOD | WOOD | | | | SOLID WOOD DOUBLE SWING DOOR |
| D10 | H | FR 2'-0" | 8'-0" | | HIS CLOSET | 1-3/4" | WOOD | WOOD | | | | SOLID WOOD DOUBLE SWING DOOR |
| D11 | C | FR 2'-0" | 8'-0" | | MASTER BEDROOM | | GLASS | METAL | | | | METAL FRAMED TEMPERED GLASS DOOR |
| D12 | C | FR 2'-0" | 8'-0" | | MASTER BEDROOM | | GLASS | METAL | | | | METAL FRAMED TEMPERED GLASS DOOR |
| D13 | G | 2'-6" | 8'-0" | | MASTER BATH | 1-3/4" | WOOD | WOOD | | | | SOLID WOOD POCKET DOOR WITH TEMPERED GLASS |
| D14 | L | 2'-0" | 6'-8" | | SHOWER | | GLASS | METAL | | | | METAL FRAMED FROSTED GLASS SHOWER DOOR |
| D15 | F | 2'-0" | 8'-0" | | WATER CLOSET | 1-3/4" | WOOD | WOOD | | | | SOLID WOOD SWING DOOR |
| D16 | G | 2'-8" | 8'-0" | | LAUNDRY | 1-3/4" | WOOD | WOOD | | | | SOLID WOOD SWING DOOR |
| D17 | N | 2'-6" | 4'-0" | | MECH/CRAWL SPACE | 1-3/4" | WOOD | WOOD | | | | SOLID WOOD SWING DOOR |
| D18 | A | 3'-0" | 8'-0" | | ENTRY | | GLASS | METAL | | | | METAL FRAMED TEMPERED GLASS DOOR |
| D19 | F | 2'-0" | 8'-0" | | CLOSET | 1-3/4" | WOOD | WOOD | | | | SOLID WOOD SWING DOOR |
| D20 | J | 2'-8" | 8'-0" | | GARAGE | 1-3/4" | WOOD | WOOD | | | | FIRE-RATED DOOR, TIGHT-FITTING, SOLID CORE, SELF-CLOSE, SELF-LATCH |
| D21 | K | 2'-6" | 7'-0" | | STORAGE | 1-3/4" | WOOD | WOOD | | | | SWING SOLID WOOD DOOR WITH FIXED WOOD LOUVERS |
| D22 | E | 8'-0" | 7'-0" | | GARAGE | 1-3/4" | WOOD | WOOD | | | | LIGHT WOOD COLOR OVERHEAD GARAGE DOOR |
| D23 | D | 2'-6" | 8'-0" | | GARAGE | 1-3/4" | WOOD | WOOD | | | | SOLID WOOD SWING DOOR WITH TEMPERED GLASS |
| D24 | F | 2'-0" | 8'-0" | | POWDER | 1-3/4" | WOOD | WOOD | | | | SOLID WOOD SWING DOOR |
| D25 | B | PR 2'-6" | 8'-0" | | GREAT ROOM | | GLASS | METAL | | | | FRAMELESS TEMPERED GLASS DOOR W/ TRANSOM |
| D26 | M | 2'-6" | 8'-0" | | NOOK | 1-3/4" | WOOD | WOOD | | | | METAL FRAMED TEMPERED GLASS DOOR |

DOOR NOTES

ALL DOORS SHALL COMPLY WITH THE FOLLOWING, UNLESS OTHERWISE NOTED, U.O.N.:

- SHALL BE 2'-0" X 6'-8" MINIMUM.
- SHALL HAVE HARDWARE MOUNTED 30" TO 44" ABOVE FINISH FLOOR.
- THRESHOLD SHALL HAVE MAXIMUM HEIGHT OF 1/2" ABOVE FINISH FLOOR.
- PROVIDE (2) PAIR- 4-1/2" X 4-1/2" BUTTS ON ALL DOORS.
- ALL HARDWARE TO BE ASHLEY NORTON HARDWARE OR BETTER.
- ALL FIRE RATED DOORS SHALL HAVE PEMKO 588D (OR EQUIVALENT) SMOKE SEALS AND SHALL BE TIGHT-FITTING, SELF-CLOSING, AND SELF-LATCHING.
- ALL EXTERIOR DOORS TO BE WEATHER STRIPPED.
- SHALL BE SOLID CORE.
- ALL DOOR GLAZING TO BE TEMPERED.
- ALL HINGED SHOWER DOORS SHALL OPEN OUTWARD PER CBC, SECTION 2407.
- EXTERIOR WINDOWS, WINDOW WALLS, GLAZED DOORS AND GLAZED OPENINGS WITHIN EXTERIOR DOORS SHALL BE INSULATING GLASS. UNITS SHALL BE INSULATING GLASS UNITS WITH A MINIMUM OF ONE TEMPERED PANE, OR GLASS BLOCK UNITS, OR HAVE A FIRE-RESISTANCE RATING NOT LESS THAN 20 MINUTES.
- REQUIRED NATURAL LIGHT FOR SPACES INTENDED FOR HUMAN OCCUPANCY SHALL HAVE GLAZED OPENINGS WITH AN AREA NOT LESS THAN 8% OF ROOM FLOOR AREA.
- REQUIRED NATURAL VENT FOR SPACES INTENDED FOR HUMAN OCCUPANCY SHALL HAVE GLAZED OPENINGS NOT LESS THAN 4% OF AREAS BEING VENTED.
- EXTERIOR DOOR ASSEMBLIES SHALL CONFORM TO THE PERFORMANCE REQUIREMENTS OF STANDARD SFM 12-7A-1 OR SHALL BE OF APPROVED NON-COMBUSTIBLE CONSTRUCTION OR SOLID CORE WOOD HAVING STILES AND RAILS NOT LESS THAN 1-3/8" THICK WITH INTERIOR FIELD PANEL THICKNESS NO LESS THAN 1-1/4" THICK OR SHALL HAVE A FIRE-RESISTANCE RATING OF NOT LESS THAN 20 MINUTES WHEN TESTED ACCORDING TO ASTM E 2014.

DOOR TYPES

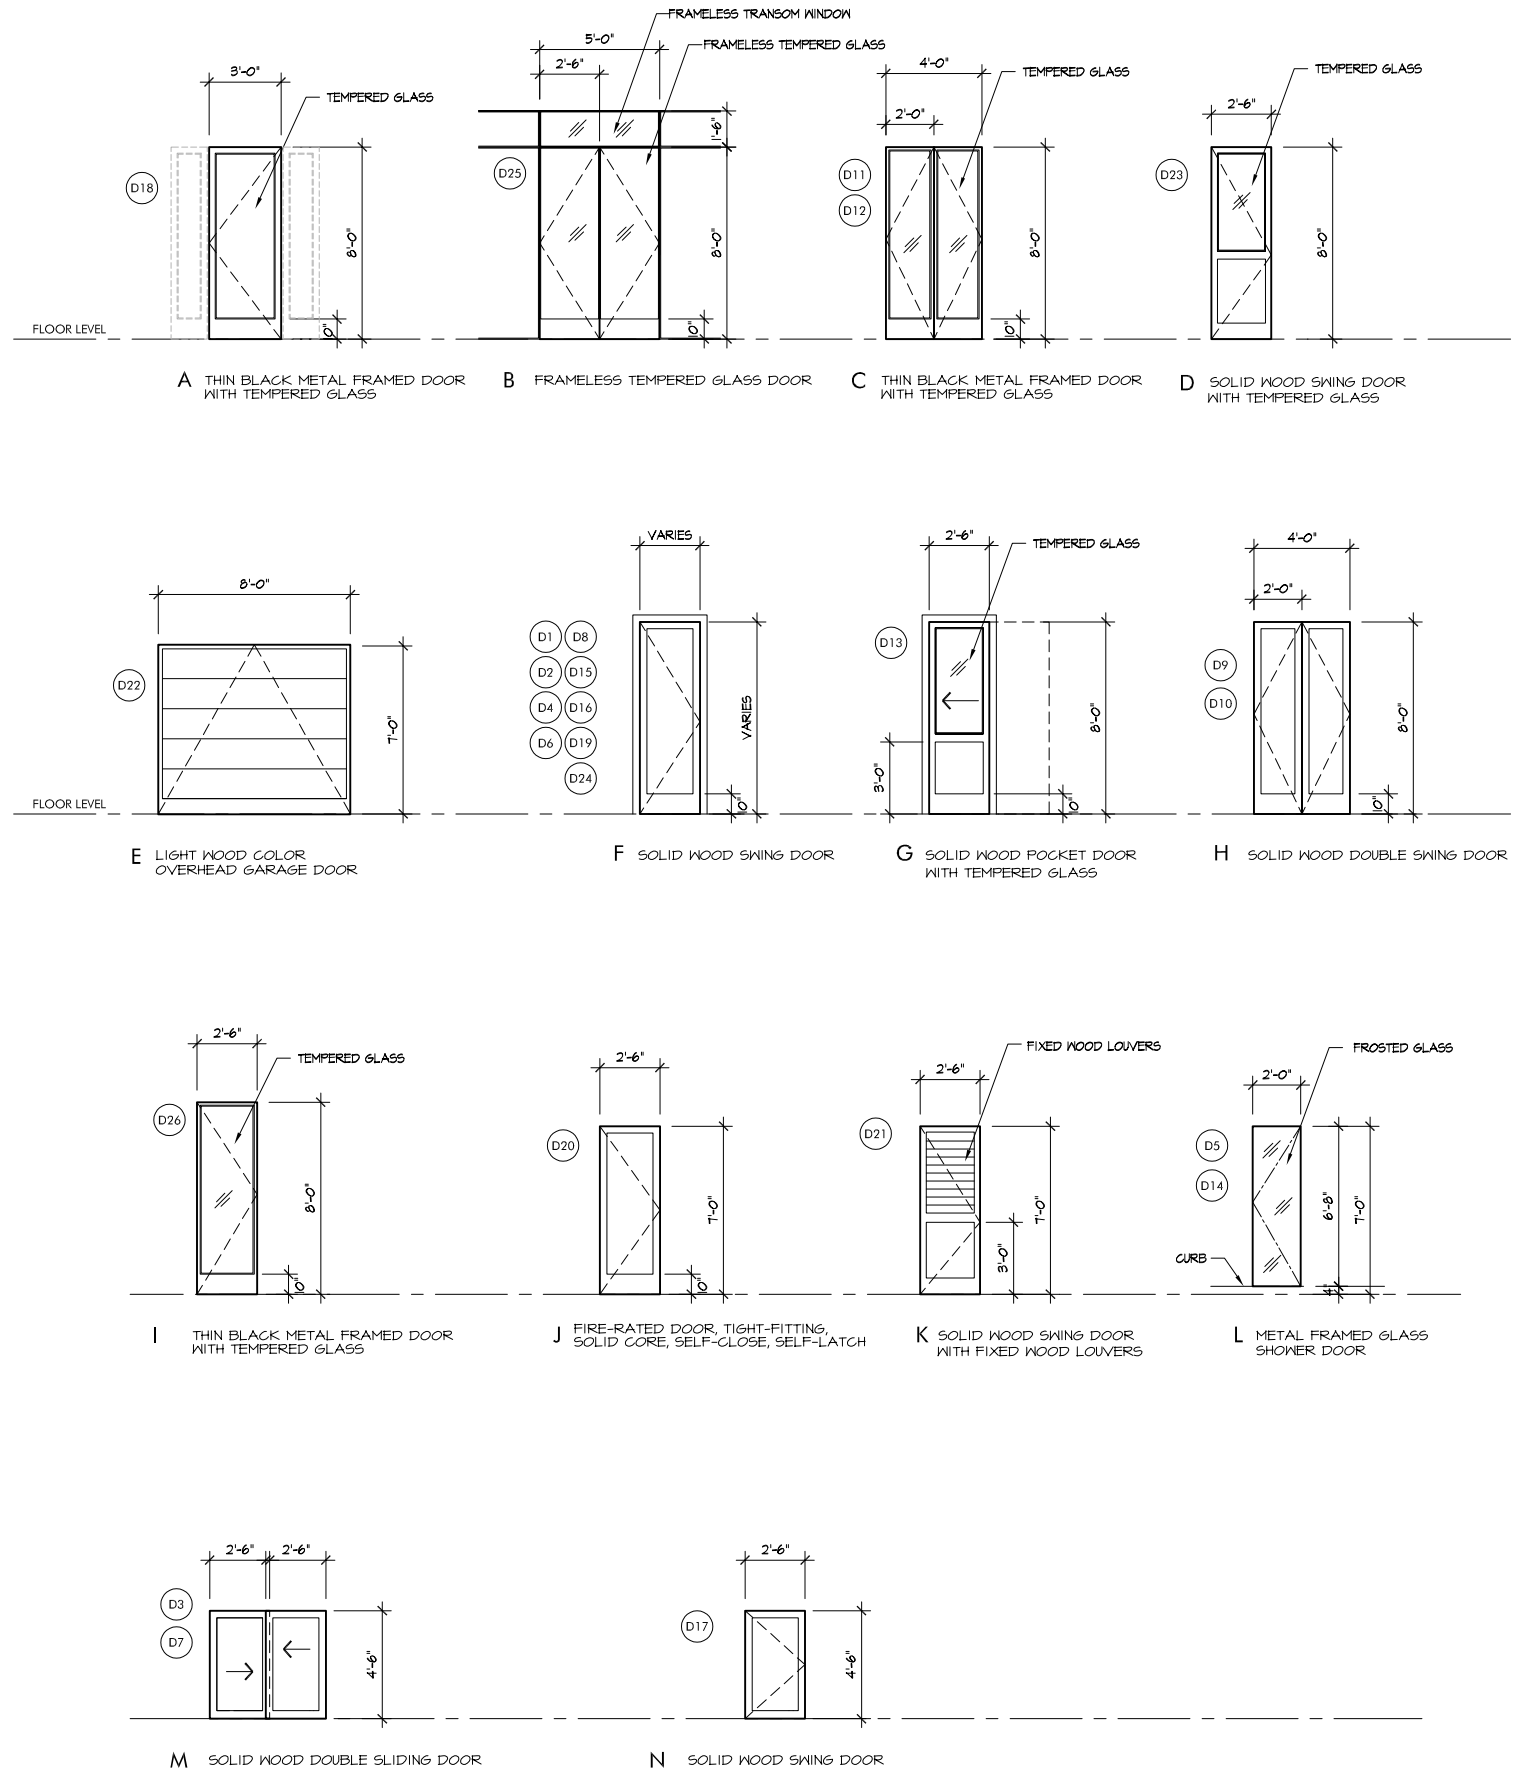

| REVISION | No. |
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CONSULTANT:

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 211 HOFFMAN AVENUE MONTEREY, CA 93940
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ARCHITECT

DOOR SCHEDULE

JOB NAME: **Witt Residence**
 Carmelo 21W of 4th Street
 Carmel, By-The-Sea, CA
 APN: 010-269-005-000

DATE: 6/5/19
 SCALE: AS NOTED
 DRAWN: DM
 JOB NUMBER: 17.20

A-4.1
 SHEET OF


WINDOW SCHEDULE

| WDW. NO. | TYPE | WINDOW SIZE | | STYLE | GLAZING | SAFETY GLAZING | FRAME MATL. | HEAD DETAIL | JAMB DETAIL | SILL DETAIL | MULLION DETAIL | HEAD HEIGHT ABOVE F.F. | SILL HEIGHT ABOVE F.F. | LOCATION | REMARKS |
|----------|------|-------------|--------|----------|--------------|----------------|-------------|-------------|-------------|-------------|----------------|------------------------|------------------------|----------------|----------------------------------|
| | | WIDTH | HEIGHT | | | | | | | | | | | | |
| W1 | B | 2'-0" | 4'-6" | CASEMENT | DOUBLE GLAZE | TEMPERED GLASS | NONE | | | | | 8'-0" | 3'-6" | BEDROOM #1 | |
| W2 | B | 2'-0" | 4'-6" | CASEMENT | DOUBLE GLAZE | TEMPERED GLASS | NONE | | | | | 8'-0" | 3'-6" | BEDROOM #1 | |
| W3 | B | 2'-0" | 4'-6" | CASEMENT | DOUBLE GLAZE | TEMPERED GLASS | NONE | | | | | 8'-0" | 3'-6" | BEDROOM #2 | |
| W4 | B | 2'-0" | 4'-6" | CASEMENT | DOUBLE GLAZE | TEMPERED GLASS | NONE | | | | | 8'-0" | 3'-6" | BEDROOM #2 | |
| W5 | B | 2'-6" | 3'-6" | CASEMENT | DOUBLE GLAZE | TEMPERED GLASS | NONE | | | | | 8'-0" | 4'-6" | MASTER BEDRM. | |
| W6 | B | 2'-6" | 3'-6" | CASEMENT | DOUBLE GLAZE | TEMPERED GLASS | NONE | | | | | 8'-0" | 4'-6" | MASTER BEDRM. | |
| W7 | D | 1'-6" | 8'-0" | FIXED | DOUBLE GLAZE | TEMPERED GLASS | NONE | | | | | 8'-0" | 0" | ENTRY | |
| W8 | D | 1'-6" | 8'-0" | FIXED | DOUBLE GLAZE | TEMPERED GLASS | NONE | | | | | 8'-0" | 0" | ENTRY | |
| W9 | C | 2'-4" | 5'-0" | FIXED | DOUBLE GLAZE | TEMPERED GLASS | NONE | | | | | 8'-0" | 3'-0" | ENTRY @ STAIRS | |
| W10 | C | 2'-4" | 5'-0" | FIXED | DOUBLE GLAZE | TEMPERED GLASS | NONE | | | | | 8'-0" | 3'-0" | ENTRY @ STAIRS | |
| W11 | G | 16'-2" | 1'-0" | FIXED | DOUBLE GLAZE | TEMPERED GLASS | NONE | | | | | 9'-11" | 8'-11" | DINING | TRANSOM WINDOW ABOVE WINE COOLER |
| W12 | E | 2'-2" | 9'-6" | FIXED | DOUBLE GLAZE | TEMPERED GLASS | NONE | | | | | 9'-6" | 0" | GREAT ROOM | WITH TRANSOM |
| W13 | F | 8'-8" | 9'-6" | FIXED | DOUBLE GLAZE | TEMPERED GLASS | NONE | | | | | 9'-6" | 0" | GREAT ROOM | WITH TRANSOM |
| W14 | F | 8'-8" | 9'-6" | FIXED | DOUBLE GLAZE | TEMPERED GLASS | NONE | | | | | 9'-6" | 0" | NOOK | WITH TRANSOM |
| W15 | A | 4'-0" | 4'-6" | FIXED | DOUBLE GLAZE | TEMPERED GLASS | NONE | | | | | 8'-0" | 3'-6" | KITCHEN | |
| W16 | A | 4'-0" | 4'-6" | FIXED | DOUBLE GLAZE | TEMPERED GLASS | NONE | | | | | 8'-0" | 3'-6" | KITCHEN | |
| W17 | B | 1'-6" | 5'-0" | CASEMENT | DOUBLE GLAZE | TEMPERED GLASS | NONE | | | | | 8'-0" | 3'-0" | GARAGE | |
| W18 | B | 1'-6" | 5'-0" | CASEMENT | DOUBLE GLAZE | TEMPERED GLASS | NONE | | | | | 8'-0" | 3'-0" | GARAGE | |

WINDOW NOTES

- ALL WINDOWS SHALL COMPLY WITH THE FOLLOWING, U.O.N.
- EGRESS WINDOWS SHALL HAVE A MINIMUM NET CLEAR OPENING OF 24" IN HEIGHT, 20" INCHES IN WIDTH, 5.7 S.F. IN AREA, AND A SILL HEIGHT NOT MORE THAN 44" A.F.F. PER CRC, SECTION R310.1.
 - PAINT GRADE WOOD WINDOWS U.O.N.
 - ALL GLAZING SUBJECT TO HUMAN IMPACT SHALL COMPLY WITH CRC, SECTION R308.3. ALL SAFETY GLAZING IN HAZARDOUS LOCATIONS SHALL COMPLY WITH CRC, SECTION R308.4.
 - ALL SLOPED GLAZING SHALL COMPLY WITH 2013 CRC, SECTION R308.6 FOR INSTALLATION AND MATERIALS.
 - SEE WINDOW TYPES, THIS PAGE FOR OPERABLE PORTIONS OF WINDOWS AND TO VERIFY NATURAL VENTILATION PER CRC SEC. R303.1 AND EGRESS PER CRC SEC. R310.
 - ALL WINDOW GLAZING SHALL BE LOW-E, DOUBLE GLAZED U.O.N.
 - ALL EXTERIOR OPENINGS SHALL PROVIDE NATURAL LIGHTING, IN HABITABLE ROOMS, WITH AN AREA OF NOT LESS THAN 8% OF ROOM FLOOR AREA PER CRC, SEC. R303.1, AND NATURAL VENTILATION WITH AN AREA OF NOT LESS THAN 4% OF ROOM FLOOR AREA PER CRC, SECTION 303.1.
 - TEMPERED SAFETY GLAZING:
 - IS REQUIRED WHERE THE NEAREST EDGE OF GLAZING IS WITHIN A 24-INCH ARC OF EITHER SIDE OF A DOOR IN A CLOSED POSITION, UNLESS THERE IS AN INTERVENING WALL BETWEEN THE DOOR AND THE GLAZING OR IF THE GLAZING IS 5' OR HIGHER ABOVE THE WALKING SURFACE.
 - GLAZING GREATER THAN 9 SQUARE FEET WITH THE BOTTOM EDGE LESS THAN 18" ABOVE THE FLOOR AND THE TOP EDGE GREATER THAN 36" ABOVE THE FLOOR (UNLESS THE GLAZING IS MORE THAN 36" HORIZONTALLY AWAY FROM THE WALKING SURFACES OR IF A COMPLYING PROTECTIVE BAR IS INSTALLED. C) GLAZING IN SHOWER AND TUB ENCLOSURES (LESS THAN 60" ABOVE STANDING SURFACE.
 - GLAZING ADJACENT TO STAIRWAYS, LANDINGS AND RAMP WITHIN 36" HORIZONTALLY OF A WALKING SURFACE WHEN THE GLAZING IS LESS THAN 60" ABOVE THE PLANE OF THE ADJACENT WALKING SURFACE.
 - EXTERIOR WINDOWS, WINDOW WALLS, GLAZED DOORS AND GLAZED OPENINGS WITHIN EXTERIOR DOORS SHALL BE INSULATING GLASS UNITS WITH A MINIMUM OF ONE TEMPERED PANE, OR GLASS BLOCK UNITS, OR HAVE A FIRE-RESISTANCE RATING OF NOT LESS THAN 20 MINUTES, WHEN TESTED ACCORDING TO ASTM E2010, OR CONFORM TO THE PERFORMANCE REQUIREMENTS OF SFM 12-TA-2.

WINDOW TYPES

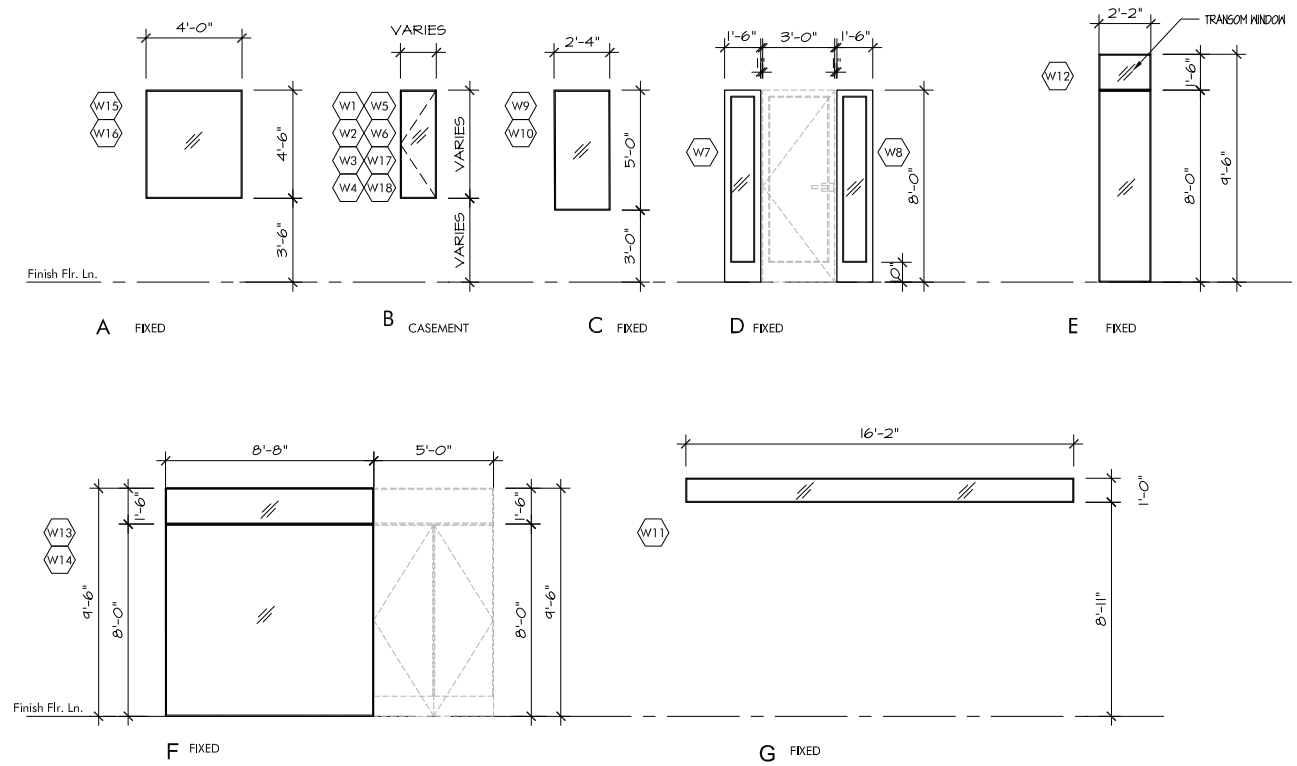

WINDOW SHADE FABRIC SPECIFICATIONS


WINDOW SHADE - TRANSLUCENT PRIVACY FABRIC

BLACKOUT - VALUE PREMIER, COLOR CANVAS
POSITION IN POCKET AT THE WINDOW SIDE



WINDOW SHADE - SOLAR FABRIC

SOLAR - BASKET WAVE 90, 10% OPEN, COLOR CHARCOAL/ CHESTNUT
POSITION IN POCKET AT THE ROOM SIDE

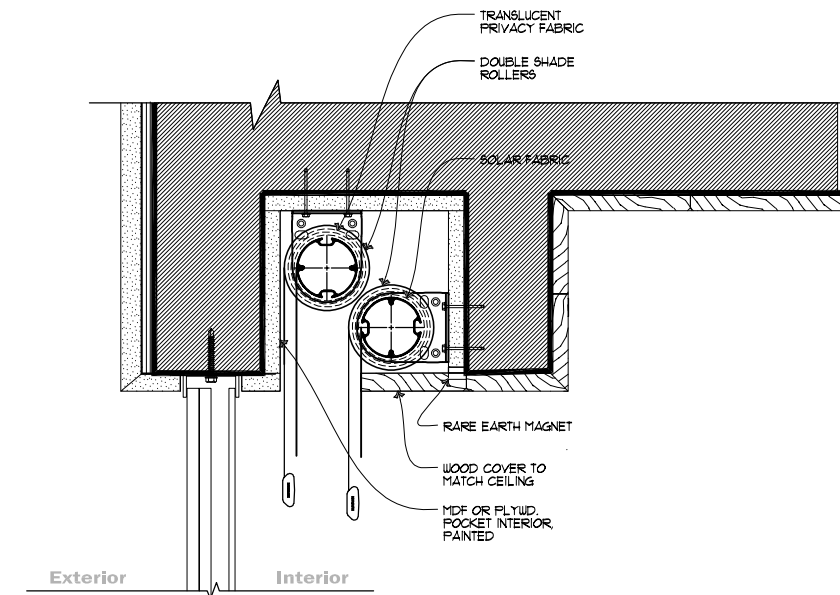

TYPICAL SHADE POCKET DETAIL
SCALE: 3" = 1'-0"

| REVISION | No. |
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ARCHITECT

WINDOW SCHEDULE

JOB NAME: **Witt Residence**
Carmelo 2NW of 4th Street
Carmel, By-The-Sea, CA
APN: 010-269-005-000

DATE: 6/5/19
SCALE: N.T.S.
DRAWN: DM
JOB NUMBER: 17.20

A-4.2
SHEET OF

THE USE OF THESE DRAWINGS AND SPECIFICATIONS IS SOLELY RESTRICTED TO THE ORIGINAL USE FOR WHICH THEY WERE PREPARED. REPRODUCTION OR PUBLICATION BY ANY MEANS, IN WHOLE OR IN PART, IS STRICTLY PROHIBITED. CONSULT WITH THESE DRAWINGS AND SPECIFICATIONS FOR ALL MATERIALS, FINISHES, AND SPECIFICATIONS. REVISIONS SHALL CONSTITUTE FINAL EVIDENCE OF ACCEPTANCE OF THESE RESTRICTIONS.



PERMEABLE PAVERS
BY: FERMALOC



WOOD ENTRY EXTERIOR DOOR



METAL GUTTER AND DOWNSPOUT
(DARK BROWN, SOLID ALUMINUM)




COLOR: DARK BROWN
BY: CUSTOM-BILT METALS

10 PAVERS SAMPLE

7 EXTERIOR DOOR

4 GUTTER and DOWNSPOUT DOWNSPOUT

1 METAL ROOFING

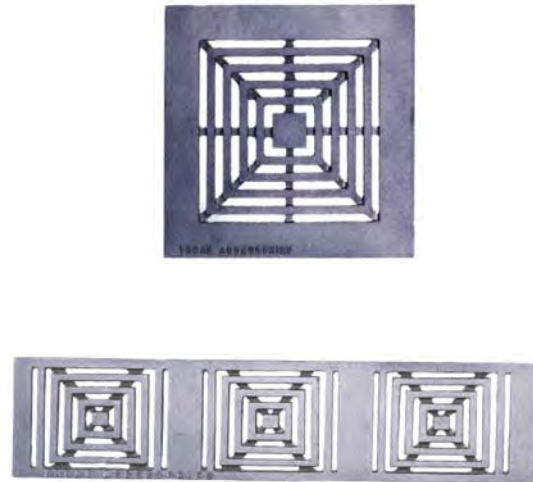

11 TRENCH GRATES DRAIN COVER



FRAMELESS EXTERIOR DOOR AND WINDOW

8 WINDOW SAMPLE



LIGHT WOOD COLOR GARAGE DOOR

5 GARAGE DOOR SAMPLE



SMOOTH FACE FONJONE STONE THIN-VENEER
(LIGHT CREAM COLOR)

2 EXTERIOR STONE WALL



12 FRAMELESS GLASS GUARDRAIL & STAINLESS STEEL HANDRAIL




9 GARDEN LIGHT



EXTERIOR FLOOR TILE SAMPLE

6 TILE FLOORING

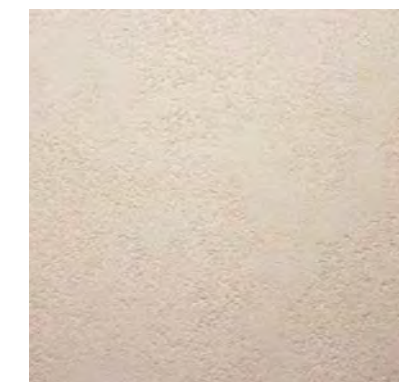

SMOOTH STUCCO WALL - LIGHT CREAM COLOR

3 STUCCO WALL FINISH

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MATERIAL SAMPLE
JOB NAME: **Witt Residence**
Carmelo 2NW of 4th Street
Carmel, By-The-Sea, CA
APN: 010-269-005-000

DATE: 6/5/19
SCALE: N.T.S.
DRAWN: DM
JOB NUMBER: 17.20



EXTERIOR PERSPECTIVE

| REVISION | No. |
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RENDERING
 JOB NAME: **Witt Residence**
 Carmelo 2NW of 4th Street
 Carmel, By-The-Sea, CA
 APN: 010-269-005-000

DATE: 6/14/19
 SCALE: N.T.S.
 DRAWN: HRM
 JOB NUMBER: 17.20

A-7.2
 SHEET OF



STREET ELEVATION

| REVISION | No. |
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STREET ELEVATION

JOB NAME:
Witt Residence
 Carmelo 2NW of 4th Street
 Carmel, By-The-Sea, CA
 APN: 010-269-005-000

DATE: 4/2/19
 SCALE: N.T.S.
 DRAWN: HRM
 JOB NUMBER: 17.20

A-7.3
 SHEET OF

GRADING, DRAINAGE & EROSION CONTROL PLAN

OF
WITT RESIDENCE
APN: 010-269-005

CARMEL-BY-THE-SEA, MONTEREY COUNTY, CALIFORNIA




VICINITY MAP
NOT TO SCALE

GENERAL NOTES:

- PROJECT DESIGN BASED ON INFORMATION PROVIDED AND SHOWN ON THE SITE PLAN FOR THE WITT RESIDENCE. SHEET A1.1 PREPARED BY ERIC MILLER ARCHITECTS, INC. THE BASE TOPOGRAPHIC INFORMATION PREPARED BY LANDSET ENGINEERS INC., JOB NO. 1735, DATED OCTOBER 2017.
- NOT ALL UNDERGROUND UTILITIES WERE LOCATED. ONLY VISIBLE FACILITIES ABOVE AND FLUSH WITH THE SURFACE ARE SHOWN. SUB-SURFACE UTILITY LINES DRAWN MAY NOT BE COMPLETE AND SHOULD BE VERIFIED BY FIELD RECONNAISSANCE. UNDERGROUND UTILITY LOCATIONS CAN BE OBTAINED FROM THE APPROPRIATE UTILITY COMPANIES, PUBLIC AGENCIES, OWNER'S AS-BUILT DRAWINGS, ETC., AND SHOULD BE THOROUGHLY COMPILED AND DEEMED COMPLETE WITH THE PROJECT AREA, PRIOR TO ANY SITE DEVELOPMENT DESIGN AND/OR CONSTRUCTION.
- THIS MAP PORTRAYS THE SITE AT THE TIME OF THE SURVEY AND DOES NOT SHOW SOILS OR GEOLOGY INFORMATION, UNDERGROUND CONDITIONS, EASEMENTS, ZONING OR REGULATORY OR ANY OTHER ITEMS NOT SPECIFICALLY REQUESTED BY THE PROPERTY OWNER.
- THIS MAP DOES NOT REPRESENT A BOUNDARY SURVEY.

GRADING & DRAINAGE NOTES:

- ALL GRADING SHALL CONFORM TO THE LATEST CITY OF CARMEL GRADING ORDINANCE AND EROSION CONTROL ORDINANCE, THE RECOMMENDATIONS FOUND IN THE PROJECT SOIL'S ENGINEERING INVESTIGATION PREPARED BY LANDSET ENGINEERS INC., DATED OCTOBER, 2018, THE LATEST VERSION OF THE CALTRANS SPECIFICATIONS, THE GOVERNING PUBLIC AGENCIES, THE LATEST REVISION OF THE CALIFORNIA BUILDING CODE (CBC) AND THESE PLANS.
- SURFACE ORGANICS SHALL BE STRIPPED AND STOCKPILED FOR LATER USE AS TOPSOIL. MATERIAL ACTUAL GRADING SHALL BEGIN WITHIN 30 DAYS OF VEGETATION REMOVAL OR THE AREA SHALL BE PLANTED TO CONTROL EROSION.
- NO ORGANIC MATERIAL SHALL BE PERMITTED IN FILLS EXCEPT AS TOPSOIL USED FOR SURFACE PLANT GROWTH ONLY AND WHICH DOES NOT EXCEED 4" IN DEPTH.
- THERE ARE APPROXIMATELY 415 C.Y. OF CUT AND 25 C.Y. OF FILL TOTAL WITH A NET EXCESS OF 390 YARDS. EXCAVATION SHALL BE USED FOR EMBANKMENT CONSTRUCTION, LANDSCAPE PURPOSES AND/OR HAULED OFF-SITE. ADDITIONAL ON-SITE SPOILS GENERATED FROM FOUNDATIONS, UTILITY TRENCHES, SEPTIC CONSTRUCTION, ETC. IS NOT INCLUDED IN THE ABOVE REFERENCED QUANTITIES. IMPORT MATERIAL SHALL MEET THE REQUIREMENTS OF SELECT STRUCTURAL FILL AS NOTED IN THE SOIL'S REPORT AND BE APPROVED BY THE SOILS ENGINEER PRIOR TO PLACEMENT.
- EMBANKMENT MATERIAL SHALL BE PLACED IN 8" LOOSE LIFTS, MOISTURE CONDITIONED, AND COMPACTED TO 90% MIN. REL. COMPACTION. ALL BASECOURSE AND THE UPPER 12" OF SUBGRADE SHALL BE COMPACTED TO 95% MIN. REL. COMPACTION.
- ALL CUT AND FILL SLOPES SHALL BE 2:1 OR FLATTER. STEEPER SLOPES MAY BE ALLOWED ONLY WITH THE PERMISSION OF THE SOILS ENGINEER.
- PAD ELEVATIONS SHALL BE CERTIFIED TO 0.10', PRIOR TO DIGGING ANY FOOTINGS OR SCHEDULING ANY INSPECTIONS.
- DUST FROM GRADING OPERATIONS MUST BE CONTROLLED. CONTRACTOR SHALL PROVIDE ADEQUATE WATER TO CONTROL DUST DURING AND FOR GRADING OPERATIONS.
- A COPY OF ALL COMPACTION TESTS AND FINAL GRADING REPORT SHALL BE SUBMITTED TO THE CITY OF CARMEL PLANNING AND BUILDING INSPECTION DEPARTMENT AT SCHEDULED INSPECTIONS.
- THE GROUND IMMEDIATELY ADJACENT TO FOUNDATIONS SHALL BE SLOPED AWAY FROM THE BUILDING AT 5% FOR A MINIMUM DISTANCE OF 10 FEET. IF PHYSICAL OBSTRUCTIONS OR LOT LINES PROHIBIT 10 FOOT OF HORIZONTAL DISTANCE, A 5% SLOPE SHALL BE PROVIDED TO AN APPROVED ALTERNATIVE METHOD OF DIVERTING WATER AWAY FROM THE FOUNDATION. SWALES USED FOR THIS PURPOSE SHALL BE SLOPED AT A MINIMUM OF 2% WHERE LOCATED WITHIN 5 FEET OF THE BUILDING FOUNDATION. IMPERVIOUS SURFACES WITHIN 10 FEET OF THE BUILDING FOUNDATION SHALL BE SLOPED AT A MINIMUM OF 2% AWAY FROM THE BUILDING.
- ROOF DRAINAGE SHALL BE CONTROLLED BY GUTTER AND DOWN SPOUTS OUTLETTING TO SPLASH BLOCKS DIRECTED TO DRAINAGE SWALES.
- STORM WATER (SURFACE RUNOFF) SHALL BE COLLECTED BY SWALES, CATCH BASINS, AND PIPES AND DIRECTED INTO AN UNDERGROUND DETENTION/INFILTRATION CHAMBER SYSTEM AS SHOWN ON THE SITE DRAINAGE PLAN. ON SITE CATCH BASINS SHALL BE CHRISTY PRODUCTS U23, V64, AND V12 - LABELED AS SHOWN. STORM DRAIN PIPE SHALL BE PVC SDR35.
- SUBSURFACE DRAINAGE FOR FOUNDATIONS & UNDERSLAB IS REQUIRED AND WILL BE COLLECTED AND PIPED TO A SUMP (CHRISTY BOX U23) LOCATED IN THE MECHANICAL ROOM AND PUMPED UP TO EXISTING STREET LEVEL (LINCOLN ST.) AND SHALL REMAIN INDEPENDENT OF THE SURFACE RUNOFF.
- THE STORM DRAIN FACILITIES SHALL BE AS SHOWN ON THE PLANS. CATCH BASINS SHALL BE CHRISTY PRODUCTS, U23 WITH GRATE AND EMERGENCY OVERFLOW PUMP FOR CB1, U23 WITH LID FOR UNDERSLAB DRAIN SUMP, V64 FOR CB2 WITH CAST IRON GRATE; V12 WITH GRATE FOR ALL REMAINING CATCH BASINS, AS LABELED, OR APPROVED EQUAL FOR ALL. THE STORM DRAIN PIPE SHALL BE P.V.C. MIN. SDR 35.
- UTILITY TRENCHES WITHIN THE BUILDING PAD OR ANY NEW PAVED AREAS SHALL BE BACKFILLED WITH CLEAN, IMPORTED SAND AND THE TRENCH BACKFILL SHALL BE COMPACTED TO 95% MIN. REL. COMPACTION. THE TOP 8" OF TRENCH SHALL BE CAPPED WITH NATIVE SOIL. IN NON-PAVED AREAS NATIVE BACKFILL SHALL BE USED AND COMPACTED TO 90% MIN. REL. COMPACTION.
- ALL WORK IS SUBJECT TO APPROVAL BY THE PUBLIC WORKS SUPERINTENDENT INSPECTION AND ACCEPTANCE.
- SPECIAL INSPECTIONS, BY A SPECIAL INSPECTOR, ARE REQUIRED DURING FILL PLACEMENT AND THAT PROPER MATERIALS AND PROCEDURES ARE USED IN ACCORDANCE WITH THE PROVISIONS OF THE APPROVED GEOTECHNICAL REPORT

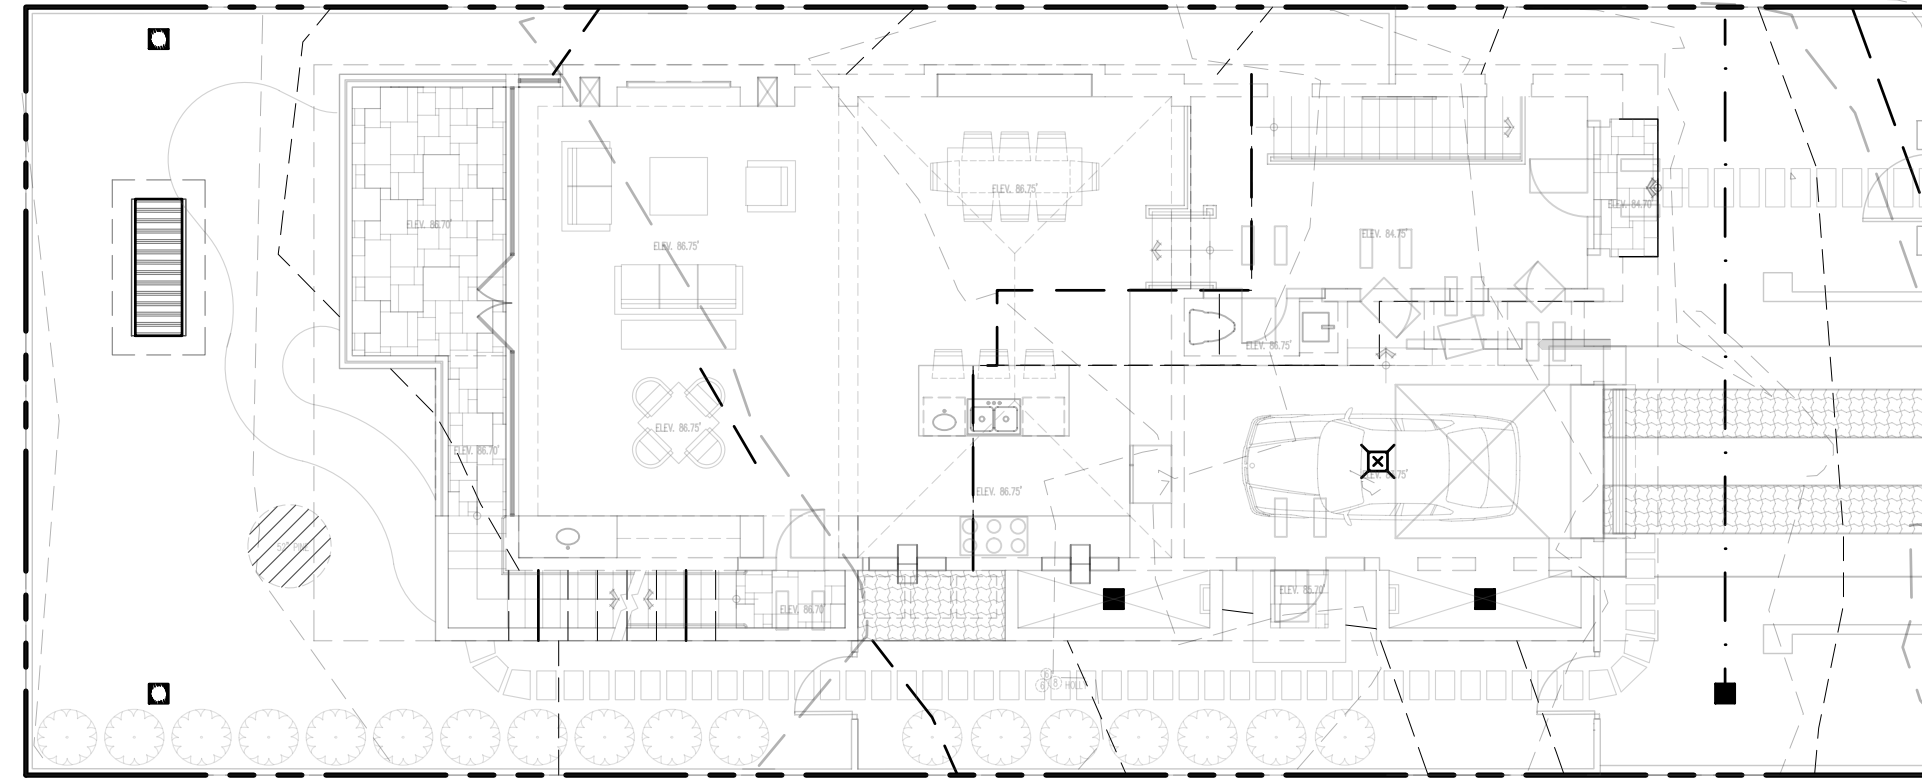

LOT OVERVIEW
SCALE: 1"=10'

| PROJECT DATA | | LOT OVERVIEW | |
|-----------------|-------------|--------------------------|-----------------|
| GRADING VOLUMES | Cut | Fill | Net |
| | 415 Cu. Yd. | 20 Cu. Yd. | 395 Cu. Yd. Cut |
| DISTURBED AREA | IMPERVIOUS | *PERVIOUS | TOTAL |
| | 1890 SQFT | 2110 SQFT | 4000 SQFT |
| | | *CREATED AND/OR REPLACED | |

- A STATE LICENSED SURVEYOR SHALL CERTIFY IN WRITING THAT THE FOOTINGS/FOUNDATION ARE LOCATED IN ACCORDANCE WITH THE APPROVED PLANS PRIOR TO THE FOOTING/FOUNDATION INSPECTION; AND SHALL CERTIFY THE ROOF HEIGHT IS IN ACCORDANCE WITH THE APPROVED PLANS PRIOR TO ROOF SHEATHING INSPECTION. CERTIFICATION LETTERS SHALL BE PROVIDED TO THE INSPECTOR AT THE TIME OF THE REFERENCED INSPECTIONS.
- TO MINIMIZE VIBRATION AND POSSIBLE DAMAGE TO ADJACENT PROPERTIES, THE CONTRACTOR SHALL UTILIZE THE SMALLEST COMPACTION EQUIPMENT FEASIBLE TO OBTAIN THE DESIRED COMPACTION. THE CONTRACTOR IS RESPONSIBLE FOR THE TIMELY REPAIR OF ALL OFF-SITE DAMAGES RESULTING FROM CONSTRUCTION OPERATIONS.
- THE CONTRACTOR SHALL OBTAIN AN 811/DIG ALERT TICKET PRIOR TO ISSUANCE OF THE BUILDING PERMIT AND SHALL MAINTAIN THE TICKET IN ACTIVE STATUS.
- STOP WORK WITHIN 50 METERS (165 FEET) OF UNCOVERED RESOURCE AND CONTACT THE CITY OF CARMEL AND A QUALIFIED ARCHAEOLOGIST IMMEDIATELY IF CULTURAL, ARCHAEOLOGICAL, HISTORICAL, OR PALEONTOLOGICAL RESOURCES ARE UNCOVERED.

NOTE: PRIOR TO DIGGING FOOTINGS OR SCHEDULING INSPECTIONS, THE OWNER/APPLICANT SHALL PROVIDE PAD ELEVATION CERTIFICATION. PRIOR TO FINAL INSPECTION, THE OWNER/APPLICANT SHALL PROVIDE CERTIFICATION FROM THE PROJECT GEOTECHNICAL ENGINEER THAT ALL DEVELOPMENT HAS BEEN CONSTRUCTED IN ACCORDANCE WITH THE RECOMMENDATIONS IN THE PROJECT SOIL ENGINEERING INVESTIGATION.

GEOTECHNICAL INSPECTION SCHEDULE

| Inspection item: | Who will conduct the inspection: | When the Inspection is to be completed: | Inspection completed by: | Date completed: |
|---|----------------------------------|---|--------------------------|-----------------|
| Site stripping and clearing | LandSet Engineers Inc. | Beginning of Project | | |
| Subexcavation, fill placement, and compaction | LandSet Engineers Inc. | Throughout grading operations | | |
| Foundation Excavations | LandSet Engineers Inc. | Prior to placement of forms and reinforcing steel | | |
| Surface and subsurface drainage improvements | LandSet Engineers Inc. | Prior to trench backfill | | |
| Utility trench compaction | LandSet Engineers Inc. | During backfill operations | | |
| Retaining wall backfill compaction | LandSet Engineers Inc. | During backfill operations | | |
| Baseroack subgrade compaction | LandSet Engineers Inc. | Prior to pavement installation | | |

INDEX TO SHEETS



- SHEET C1 COVER SHEET
- SHEET C2 TOPOGRAPHIC MAP/EXISTING CONDITIONS
- SHEET C3 GRADING & DRAINAGE PLAN
- SHEET C4 GRADING SECTIONS & DETAILS
- SHEET C5 CONSTRUCTION DETAILS
- SHEET C6 EROSION & SOURCE CONTROL PLAN
- SHEET C7 CONSTRUCTION MANAGEMENT PLAN

EROSION & SEDIMENT CONTROL NOTES:

- ALL EROSION CONTROL MEASURES SHALL CONFORM WITH THE CITY OF CARMEL EROSION CONTROL ORDINANCE.
- EROSION AND SEDIMENT CONTROL MEASURES SHALL BE IN EFFECT FOR ANY CONSTRUCTION DURING THE RAINY SEASON, APPROX. OCTOBER 15 TO APRIL 15. EROSION CONTROL PLAN SHALL BE PREPARED AND SUBMITTED FOR APPROVAL BY SEPT. 15 OF ANY OR EACH CALENDAR YEAR THAT CONSTRUCTION MAY EXTEND BEYOND OCTOBER 15.
- ALL SLOPES SHALL BE PROTECTED WITH STRAW MULCH OR SIMILAR MEASURES TO PROTECT AGAINST EROSION UNTIL SUCH SLOPES ARE PERMANENTLY STABILIZED.
- RUNOFF SHALL BE DETAINED OR FILTERED BY BERMS, VEGETATED FILTER STRIPS, AND/OR CATCH BASINS TO PREVENT THE ESCAPE OF SEDIMENT FROM THE SITE.
- EROSION AND SEDIMENT CONTROL MEASURES SHALL BE IN PLACE AT THE END OF EACH DAY'S WORK.
- EROSION CONTROL PLANTINGS AND MULCH SHALL BE CLOSELY MONITORED THROUGHOUT THE WINTER AND ANY RUNOFF PROBLEMS CORRECTED PROMPTLY. SEE LANDSCAPE ARCHITECT'S PLAN FOR PERMANENT PLANTINGS AND TREE SCHEDULES.
- DISTURBED SURFACES NOT INVOLVED IN THE IMMEDIATE GRADING OPERATIONS MUST BE PROTECTED BY MULCHING AND/OR OTHER EFFECTIVE MEANS OF SOIL PROTECTION.
- ALL ROADS AND DRIVEWAYS SHALL HAVE DRAINAGE FACILITIES SUFFICIENT TO PREVENT EROSION ON OR ADJACENT TO THE ROADWAY OR ON THE DOWNHILL PROPERTIES.
- DRAINAGE CONTROL MEASURES SHALL BE MAINTAINED AND IN PLACE AT THE END OF EACH DAY AND CONTINUOUSLY THROUGHOUT THE LIFE OF THE PROJECT DURING WINTER OPERATIONS.
- REVEGETATION SHALL CONSIST OF A MECHANICALLY APPLIED HYDROMULCH SLURRY OR HAND SEEDING WITH A STRAW MULCH COVER. MULCH SHALL BE ANCHORED BY AN APPROVED METHOD SUCH AS PUNCHING, TACKING, OR THE USE OF JUTE NETTING, AS DEEMED NECESSARY FOR THE SITE CONDITIONS TO ALLOW FOR GERMINATION AND ENABLE ADEQUATE GROWTH TO BE ESTABLISHED.
- CHECK DAMS, SILT FENCES, FIBER ROLLS OR OTHER DESIGNS SHALL BE INCORPORATED TO CATCH ANY SEDIMENT UNTIL AFTER THE NEWLY EXPOSED AREAS ARE REVEGETATED SUFFICIENTLY TO CONTROL EROSION. EROSION CONTROL PLANTINGS AND MULCH SHALL BE CLOSELY MONITORED THROUGHOUT THE WINTER AND ANY RUNOFF PROBLEMS SHALL BE CORRECTED PROMPTLY. ALL EROSION AND/OR SLIPPAGE OF THE NEWLY EXPOSED AREAS SHALL BE REPAIRED BY THE PERMITEE AT THEIR EXPENSE.
- THE GRASS SEED SHALL BE PROPERLY IRRIGATED UNTIL ADEQUATE GROWTH IS ESTABLISHED AND MAINTAINED TO PROTECT THE SITE FROM FUTURE EROSION DAMAGE. ALL NEWLY EXPOSED (DISTURBED) AREAS SHALL BE SEEDING WITH THE FOLLOWING EROSION CONTROL MIX: BROMUS CARINATUS (CALIFORNIA BROME), VULPIA MICROSTACHYS (NUTTALL'S FESCUE), ELYMUS GLAUCUS (BLUE WILD RYE), HORDEUM BRACHYANTHERUM (MEADOW BARLEY), FESTUCA RUNRA'MOLATE BLUE AND A MIXTURE OF LOCALLY NATIVE WILDFLOWERS.
- THE DIRECTOR OF BUILDING INSPECTION (BUILDING OFFICIAL) SHALL STOP OPERATIONS DURING PERIODS OF INCREMENT WEATHER IF HE OR SHE DETERMINES THAT EROSION PROBLEMS ARE NOT BEING CONTROLLED ADEQUATELY.
- GENERAL CONTRACTOR SHALL BE RESPONSIBLE FOR EROSION AND SEDIMENT CONTROL BMP INSTALLATION AND MAINTENANCE AND SHALL PROVIDE FULL PARTICULARS TO COUNTY RMA-ENVIRONMENTAL SERVICES PRIOR TO BEG. WORK.

LEGEND:

- EXISTING (N):**
- MAJOR CONTOUR LINE (5' INTERVAL)
 - MINOR CONTOUR LINE (1' INTERVAL)
 - ASPHALT PAVEMENT SURFACE
 - WOOD SURFACE
- NEW (N):**
- MAJOR CONTOUR LINE (5' INTERVAL)
 - MINOR CONTOUR LINE (1' INTERVAL)
 - RETAINING WALL - TYPE AS SHOWN
 - STORM DRAIN LINE
 - SUB DRAIN LINE
 - TREE TO BE REMOVED
 - ROOT DOWNSPOUT WITH SPLASHBLOCK
 - MAIN FLOOR HOUSE FOOTPRINT
 - ASPHALT PAVEMENT SURFACE

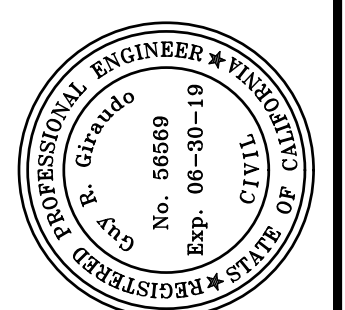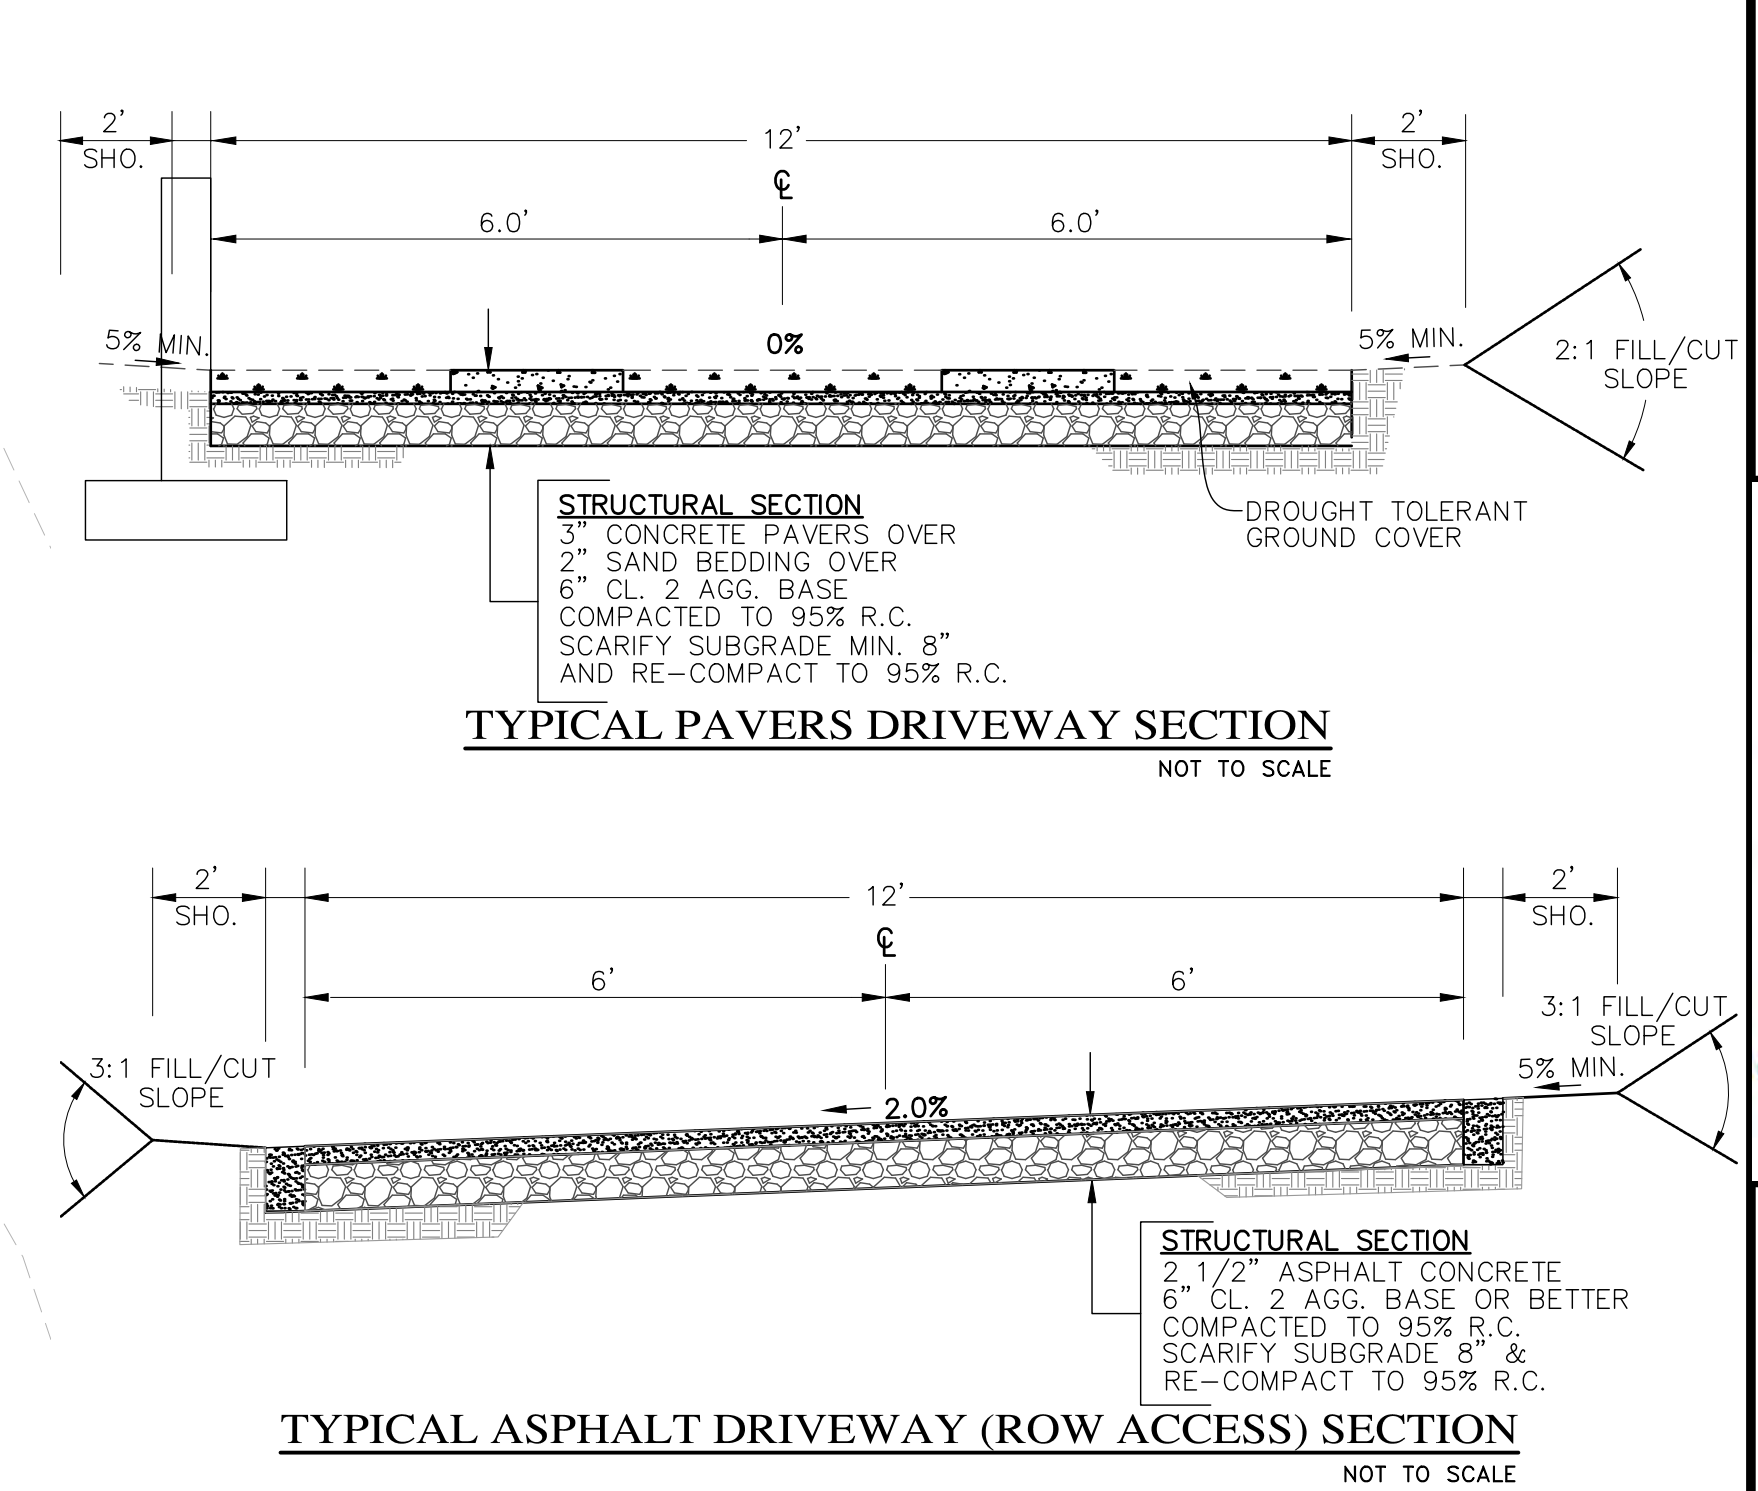

APPROVED BY:
Guy R. Ciraud
GUY R. CIRAUD
6619





GRADING, DRAINAGE & EROSION CONTROL PLAN
OF
LOT 15, BLOCK "U", AS SHOWN IN VOLUME 1 OF CITIES AND TOWNS AT PAGE 45-1/2 CARMEL-BY-THE-SEA, MONTEREY COUNTY, CALIFORNIA
MR AND MRS. DYLAN & NATASHA WITT

SCALE: AS SHOWN
DATE: JUN 2019
JOB NO. 1735-02

SHEET **C1**
OF 7 SHEETS

| No. | DATE | BY | REVISION |
|-----|----------|-----|-----------------------------------|
| 1 | 06/04/19 | JAN | ARCHITECTURAL SITE PLAN REVISIONS |
| 2 | 03/29/19 | JK | RELEASED TO CLIENT |

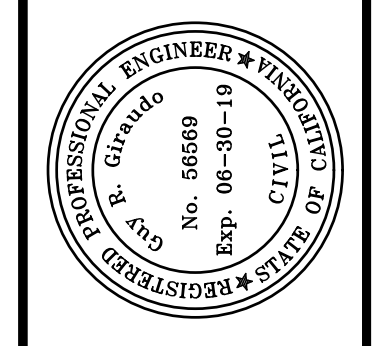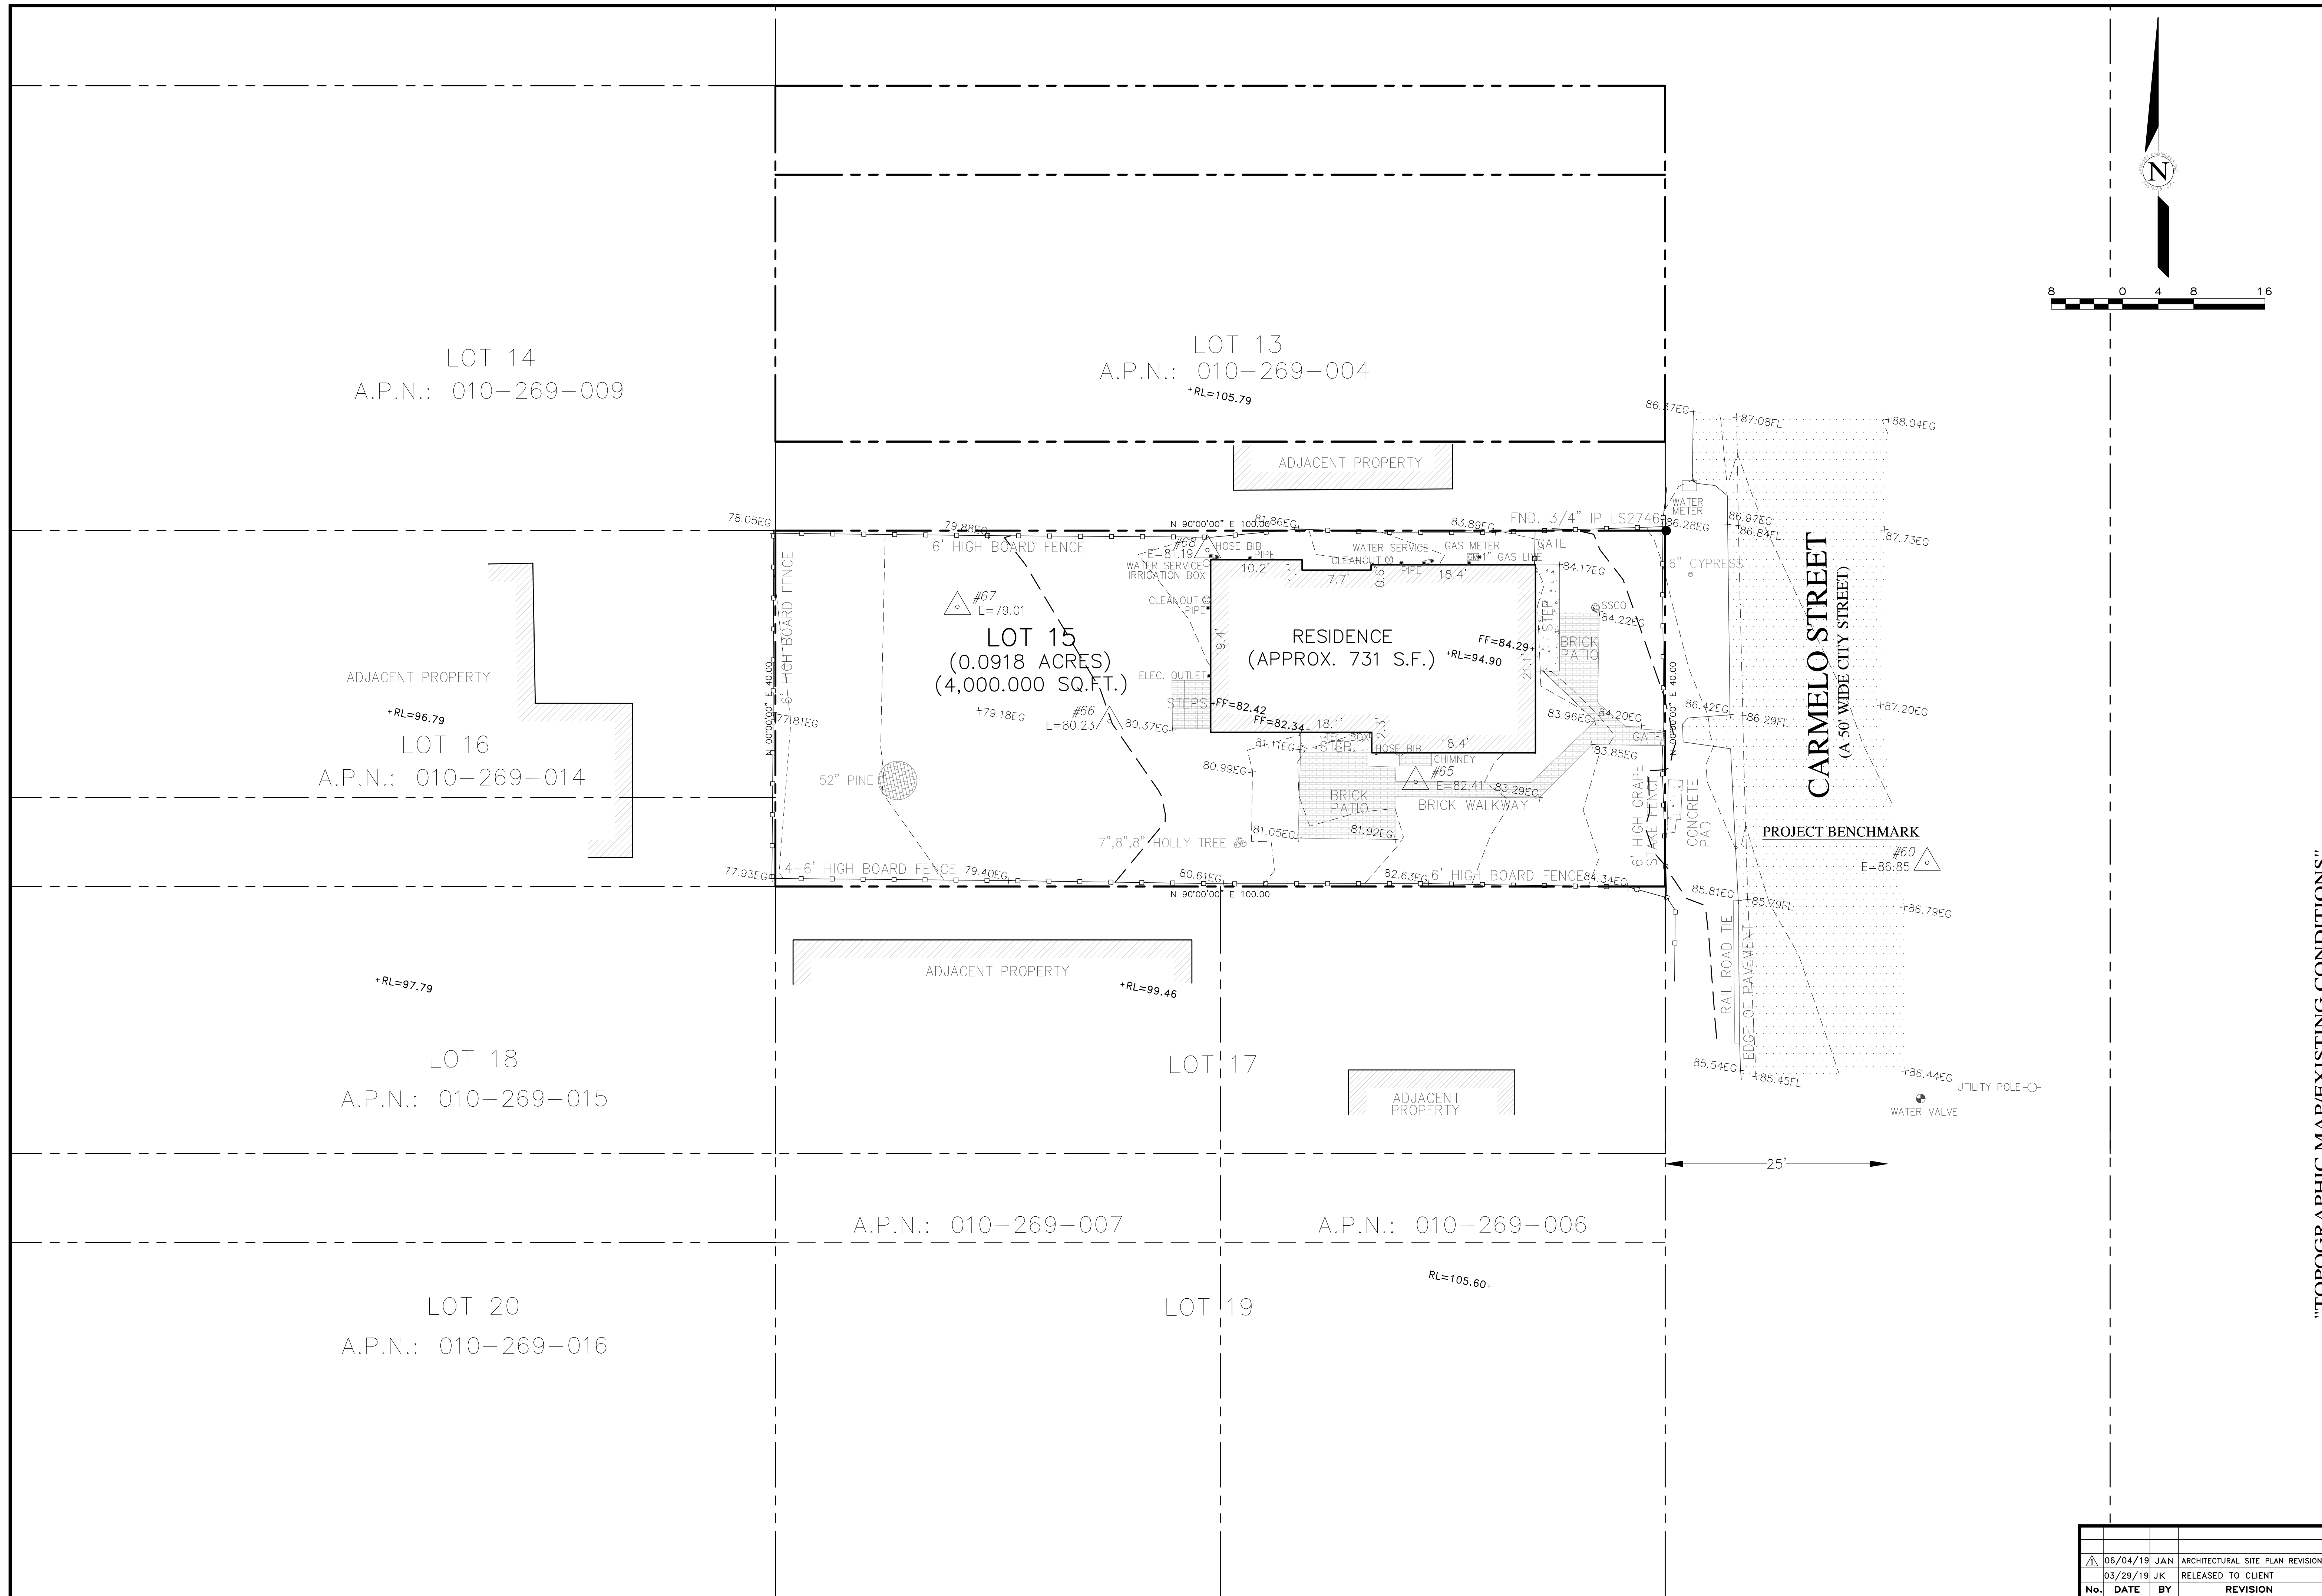

APPROVED BY:
 GUY R. GIRARDO
 06/19




"TOPOGRAPHIC MAP/EXISTING CONDITIONS"
GRADING, DRAINAGE & EROSION CONTROL PLAN
 OF
LOT 15, BLOCK "U", AS SHOWN IN VOLUME 1
OF CITIES AND TOWNS AT PAGE 45-1/2
CARMEL-BY-THE-SEA, MONTEREY COUNTY, CALIFORNIA
 MR AND MRS. DYLAN & NATASHA WITT

SCALE: 1" = 8'
 DATE: JUN 2019
 JOB NO. 1735-02

| No. | DATE | BY | REVISION |
|-----|----------|-----|-----------------------------------|
| △ | 06/04/19 | JAN | ARCHITECTURAL SITE PLAN REVISIONS |
| | 03/29/19 | JK | RELEASED TO CLIENT |

SHEET **C2**
 OF 7 SHEETS

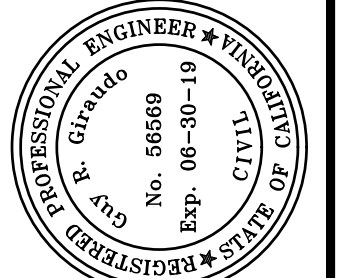



APPROVED BY:
 GUY R. GIRARD
 06/19



"GRADING & DRAINAGE PLAN"
GRADING, DRAINAGE & EROSION CONTROL PLAN
 OF
LOT 15, BLOCK "U", AS SHOWN IN VOLUME 1
OF CITIES AND TOWNS AT PAGE 45-1/2
CARMEL-BY-THE-SEA, MONTEREY COUNTY, CALIFORNIA
 MR AND MRS. DYLAN & NATASHA WITT

SCALE: 1" = 4'
 DATE: JUN 2019
 JOB NO. 1735-02


SHEET **C3**
 OF 7 SHEETS

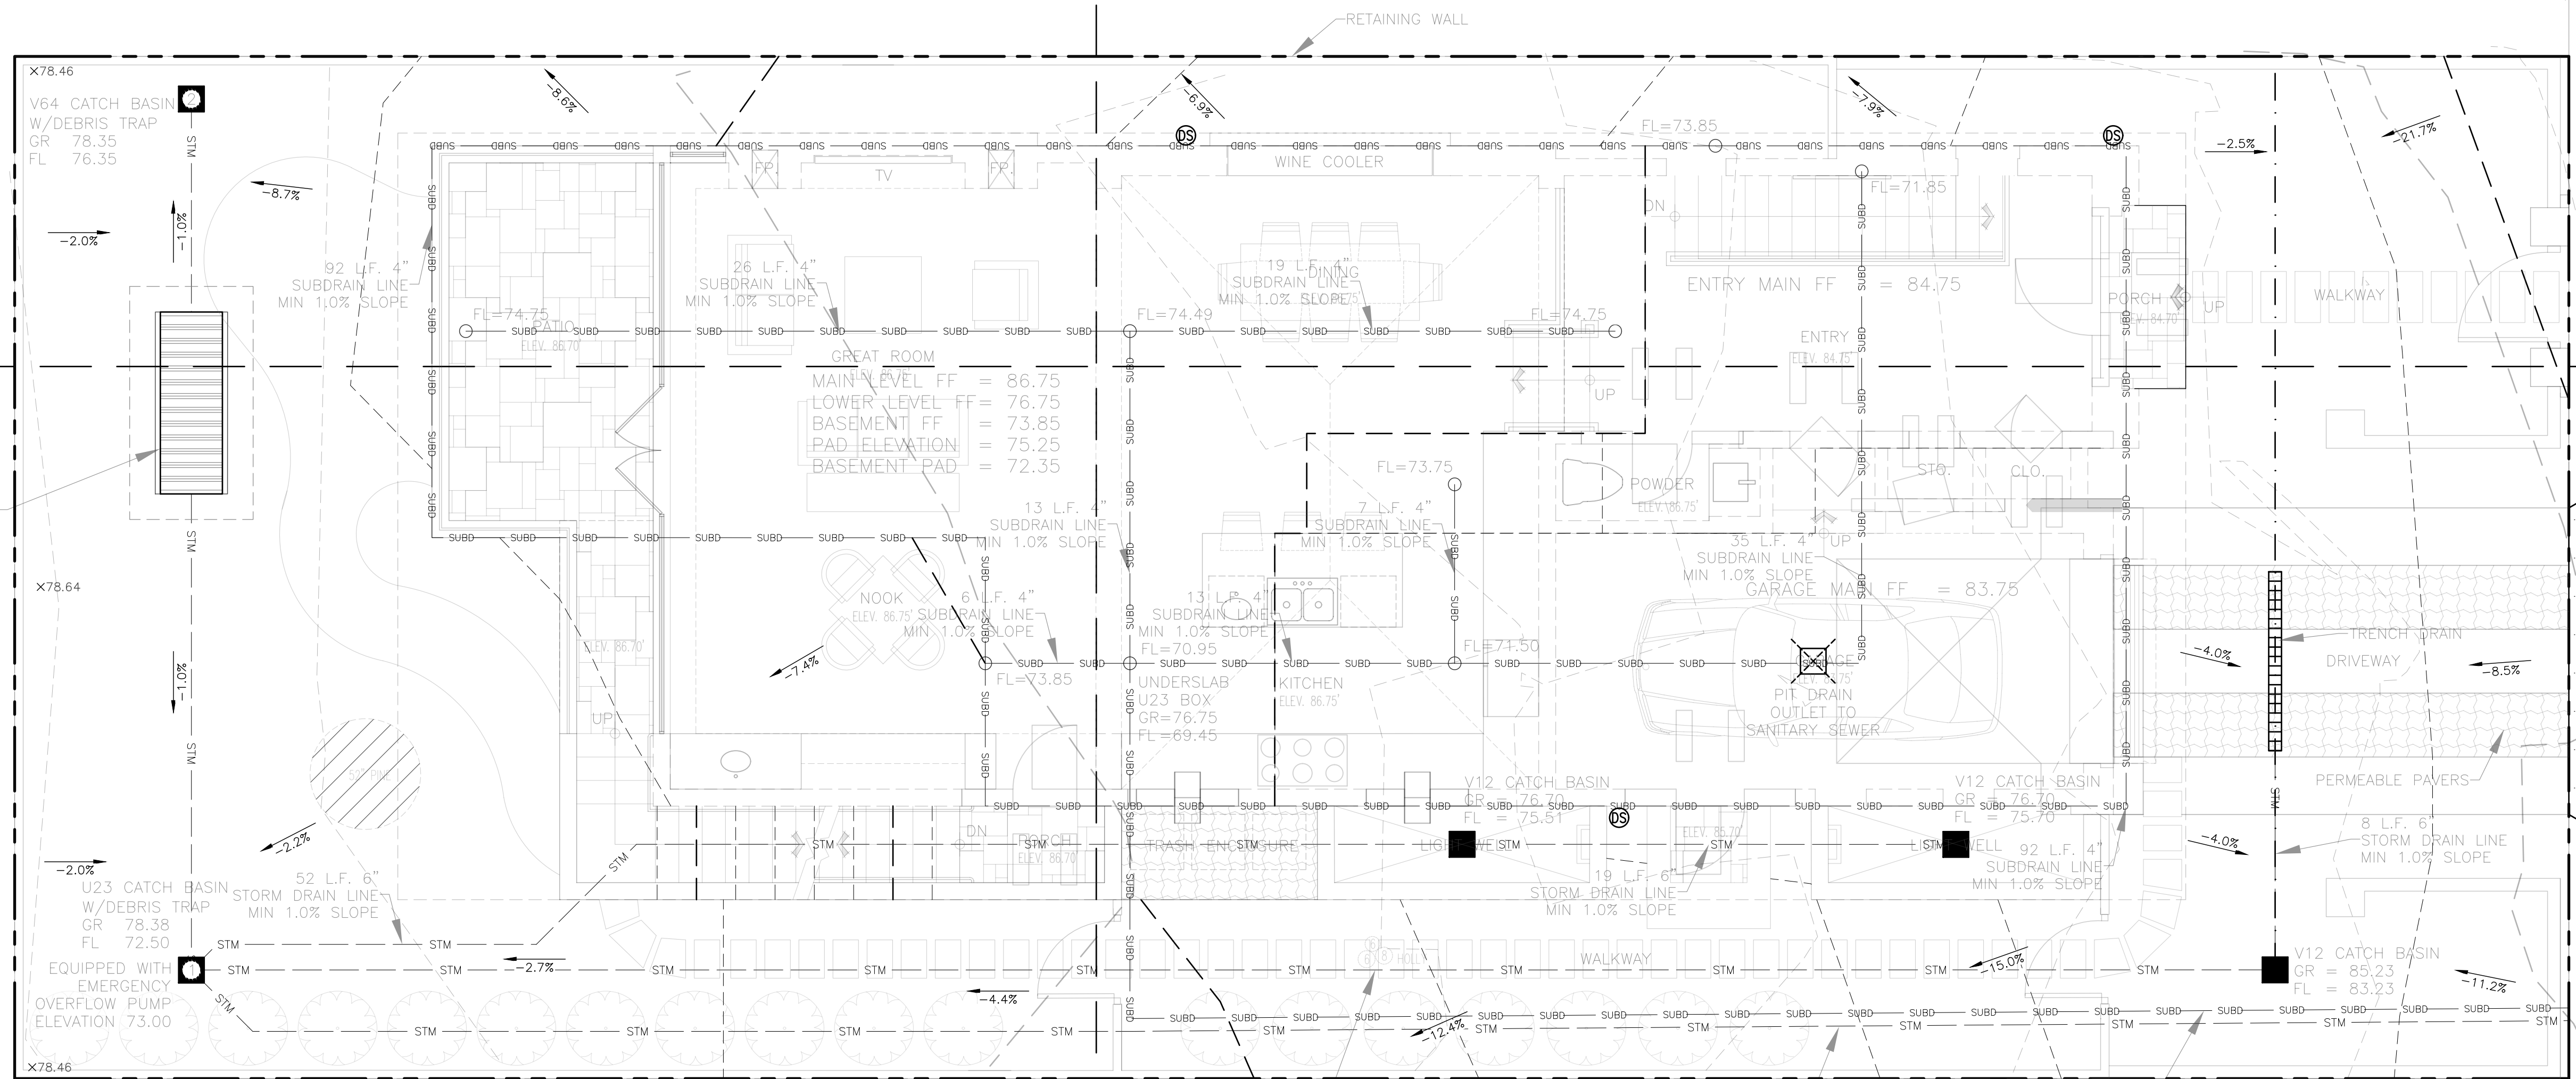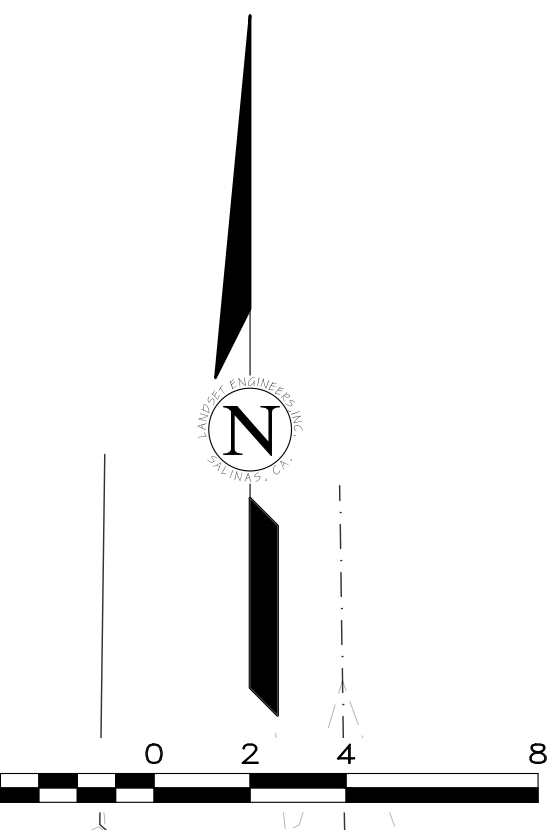

UNDERGROUND INFILTRATION CHAMBERS
 SIZED TO HOLD 85TH PERCENTILE RUNOFF
 VOLUME REQUIRED: 18 C.F.
 VOLUME PROVIDED: 31 C.F.
 1 CHAMBER SC-310
 FL: 71.50


CONSTRUCT NEW DRIVEWAY APPROACH
 PER CITY OF CARMEL STANDARDS FOR
 PUBLIC WAY DESIGN
 CONFORM TO EXISTING
 EDGE OF PAVEMENT

| No. | DATE | BY | REVISION |
|-----|----------|-----|-----------------------------------|
| Δ | 06/04/19 | JAN | ARCHITECTURAL SITE PLAN REVISIONS |
| | 03/29/19 | JK | RELEASED TO CLIENT |

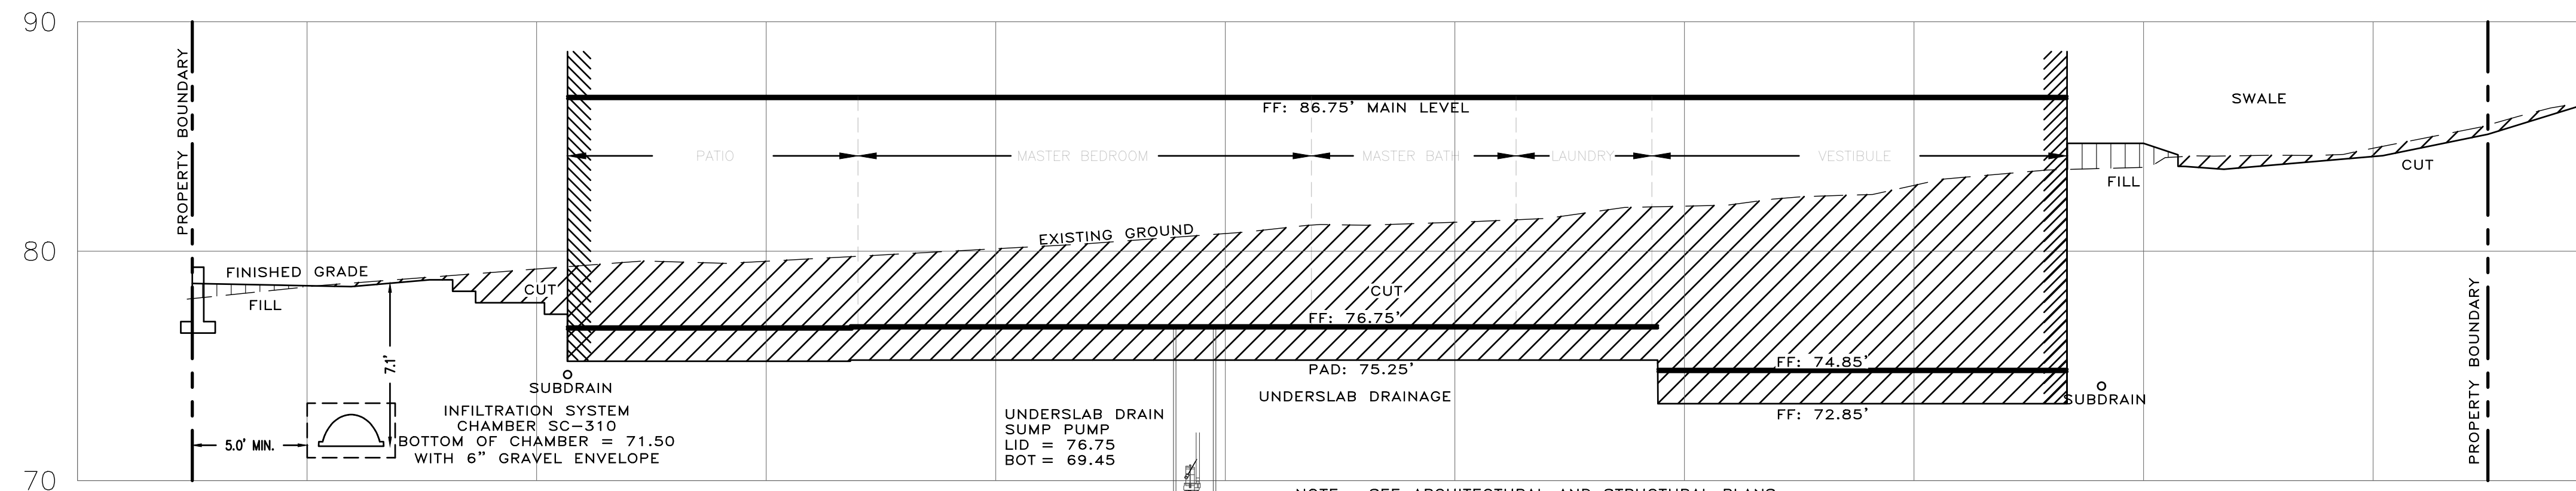


NOTE: SEE ARCHITECTURAL AND STRUCTURAL PLANS FOR LAYOUT OF FOUNDATION COMPONENTS.

SECTION A-A
SCALE: 1:5 H&V

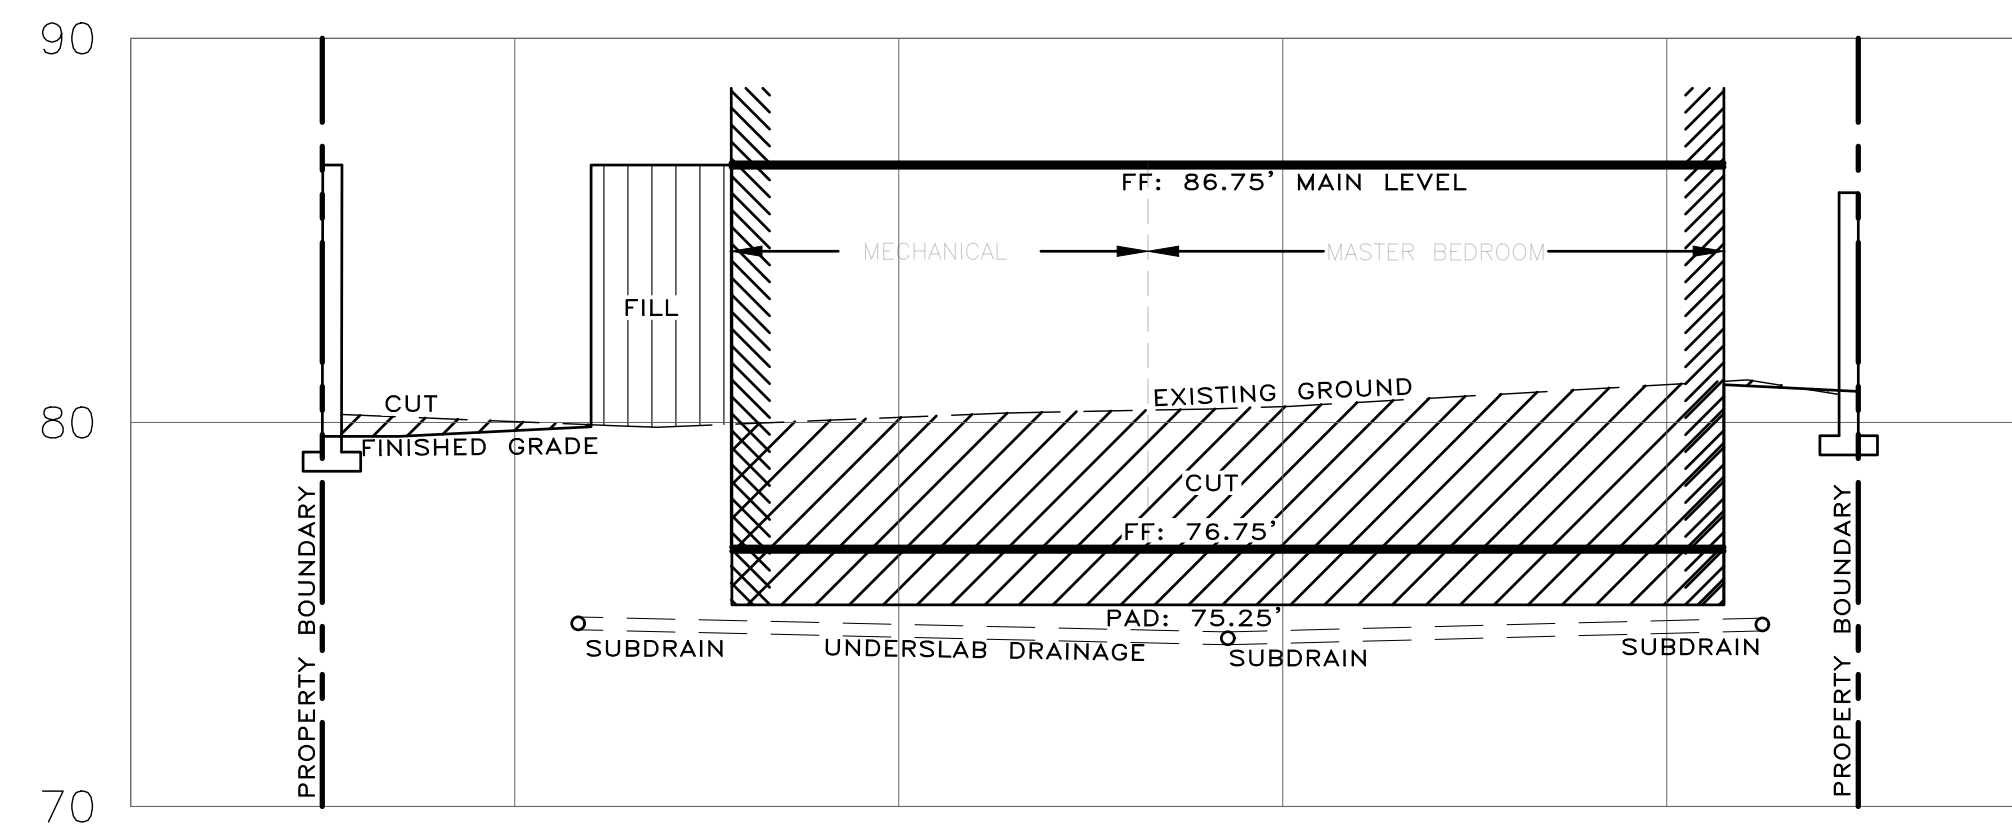

SECTION B-B
SCALE: 1:5 H&V

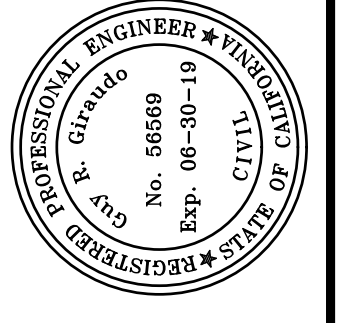

APPROVED BY:
Guy R. Ciraudo
GUY R. CIRAUDO
06/19



"GRADING SECTIONS"
OF
GRADING, DRAINAGE & EROSION CONTROL PLAN
OF
LOT 15, BLOCK "U", AS SHOWN IN VOLUME 1
OF CITIES AND TOWNS AT PAGE 45-1/2
CARMEL-BY-THE-SEA, MONTEREY COUNTY, CALIFORNIA
MR AND MRS. DYLAN & NATASHA WITT



SCALE: AS SHOWN
DATE: JUN 2019
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| No. | DATE | BY | REVISION |
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| Δ | 06/04/19 | JAN | ARCHITECTURAL SITE PLAN REVISIONS |
| | 03/29/19 | JK | RELEASED TO CLIENT |

SHEET **C4**
OF 7 SHEETS

| MATERIAL LOCATION | DESCRIPTION | AASHTO M43 DESIGNATION | AASHTO M145 DESIGNATION | COMPACTION/DENSITY REQUIREMENT |
|--|--|---|-------------------------|--|
| FILL MATERIAL FROM 18" TO GRADE ABOVE CHAMBERS | ANY SOIL/ROCK MATERIALS, NATIVE SOILS OR PER ENGINEER'S PLANS. CHECK PLANS FOR PAVEMENT SUBGRADE REQUIREMENTS. | N/A | N/A | PREPARE PER ENGINEER'S PLANS. PAVED INSTALLATIONS MAY HAVE STRINGENT MATERIAL AND PREPARATION REQUIREMENTS. |
| FILL MATERIAL FOR 6" TO 18" ELEVATION ABOVE CHAMBERS (24" FOR UNPAVED INSTALLATIONS) | GRANULAR WELL-GRADED SOIL/AGGREGATE MIXTURES, <35% FINES. | 3, 357, 4, 467, 5, 56, 57, 6, 67, 68, 7, 78, 8, 89, 9, 10 | A-1, A-2, A-3 | COMPACT IN 6" LIFTS TO A MINIMUM 95% STANDARD PROCTOR DENSITY. ROLLER GROSS VEHICLE WEIGHT NOT TO EXCEED 12,000 LBS. DYNAMIC FORCE NOT TO EXCEED 20,000 LBS. |
| EMBEDMENT STONE SURROUNDING AND TO A 6" ELEVATION ABOVE CHAMBERS | WASHED ANGULAR STONE WITH THE MAJORITY OF PARTICLES BETWEEN 3/4 - 2 INCH | 3, 357, 4, 467, 5, 56, 57 | N/A | NO COMPACTION REQUIRED |
| FOUNDATION STONE BELOW CHAMBERS | WASHED ANGULAR STONE WITH THE MAJORITY OF PARTICLES BETWEEN 3/4 - 2 INCH | 3, 357, 4, 467, 5, 56, 57 | N/A | PLATE COMPACT OR ROLL TO ACHIEVE A 95% STANDARD PROCTOR DENSITY |



PLEASE NOTE: THE LISTED AASHTO DESIGNATIONS ARE FOR GRADATIONS ONLY. THE STONE MUST ALSO BE WASHED CRUSHED ANGULAR. FOR EXAMPLE, THE STONE MUST BE SPECIFIED AS WASHED, CRUSHED, ANGULAR NO. 4 STONE.

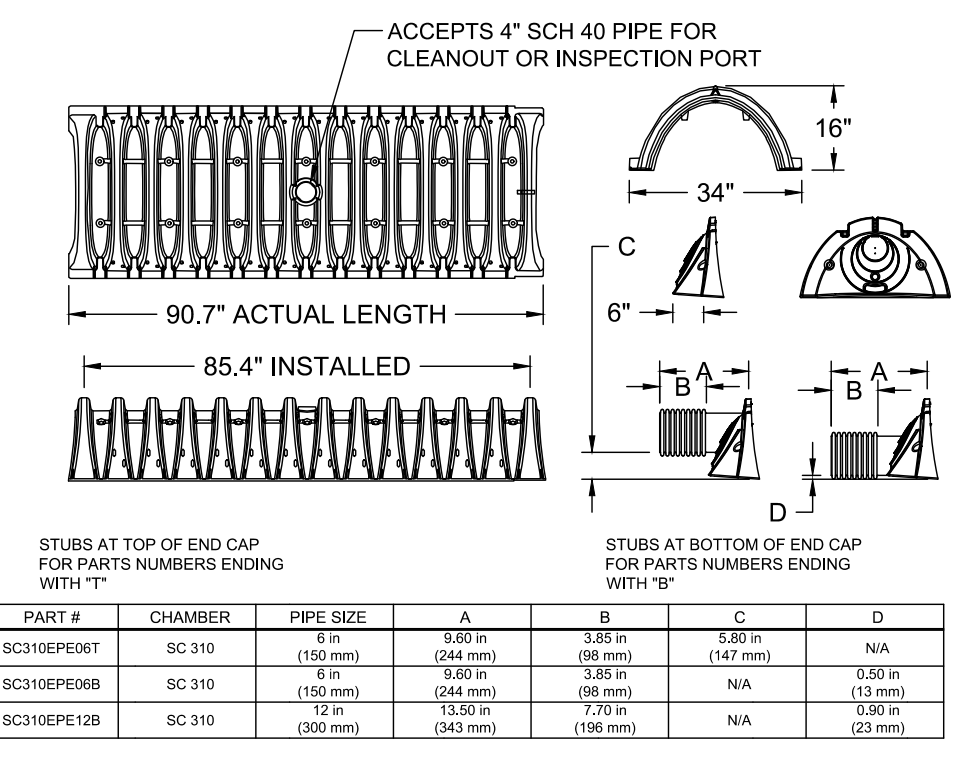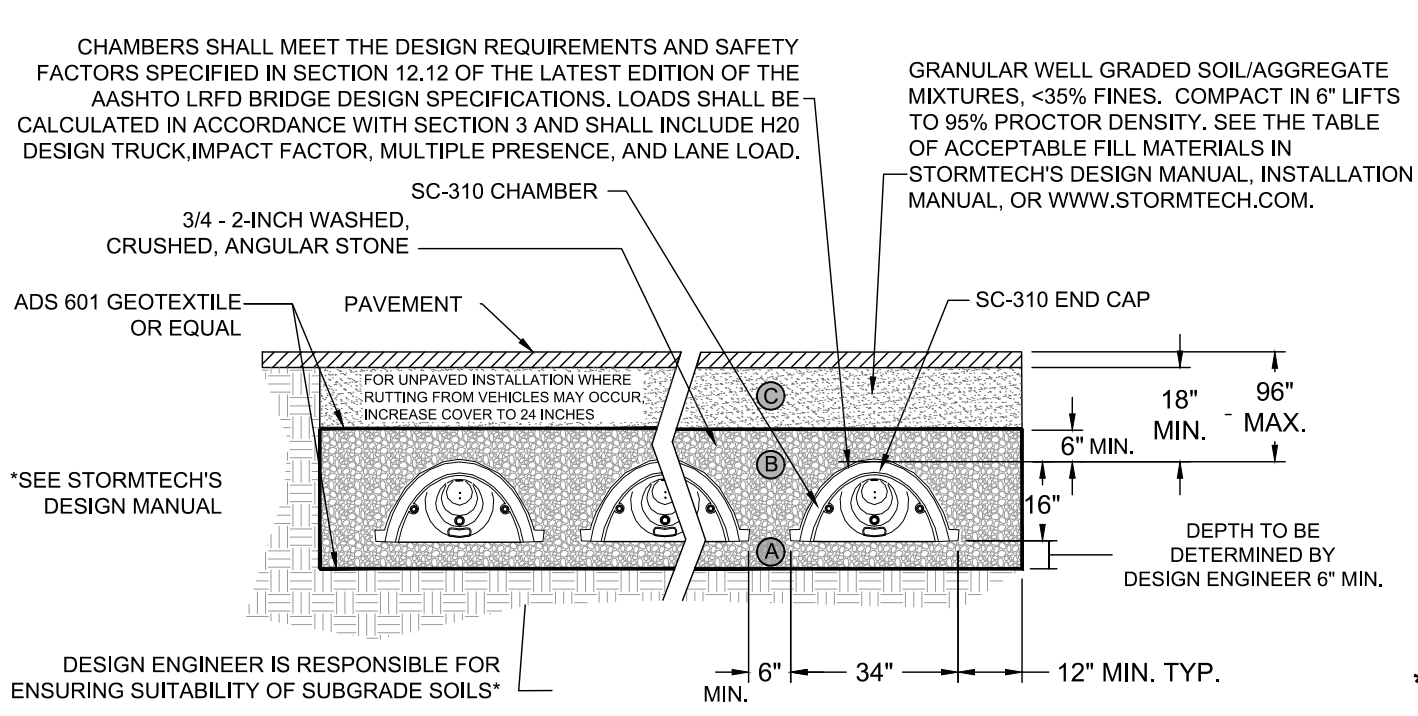

| PART # | CHAMBER | PIPE SIZE | A | B | C | D |
|------------|---------|-----------|-----------------|----------------|----------------|-----------------|
| SC310PE00T | SC 310 | (150 mm) | 8.68" (221 mm) | 3.38" (86 mm) | 5.68" (144 mm) | N/A |
| SC310PE00B | SC 310 | (150 mm) | 8.68" (221 mm) | 3.38" (86 mm) | N/A | 13.50" (343 mm) |
| SC310PE12B | SC 310 | (150 mm) | 13.50" (343 mm) | 7.35" (188 mm) | N/A | 13.50" (343 mm) |

NOTE: ALL DIMENSIONS ARE NOMINAL

STORAGE SIZING:
SQUARE FOOTAGE OF NEW IMPERVIOUS:
TOTAL AREA = 1820 SF
COEFFICIENT 'C':
C=1.0
INTENSITY:
85TH PERCENTILE = 0.8 IN = 0.067 FT
TOTAL RUNOFF VOLUME:
Q1=CIA
Q1=(1.0)(0.067FT)(1,820 SF) = 121 CF
SOIL INFILTRATION RATE:
R = 3 IN/H = 0.25 FT/H
SINGLE CHAMBER AREA 'K':
K=17.31 SF
SOIL INFILTRATION ALLOWANCE (24 HOUR):
Q2=RKT
Q2=(0.25 FT/H)(17.31 SF)(24 H) = 104 CF
VOLUME REQ'D:
Q=Q1+Q2
Q=121 CF + 104 CF = 17 CF
INFILTRATION SYSTEM VOLUME PROVIDED:
STORMTECH SC-310
31 C.F. PER CHAMBER
USING 1 CHAMBERS W/6" BASE = 31 C.F.

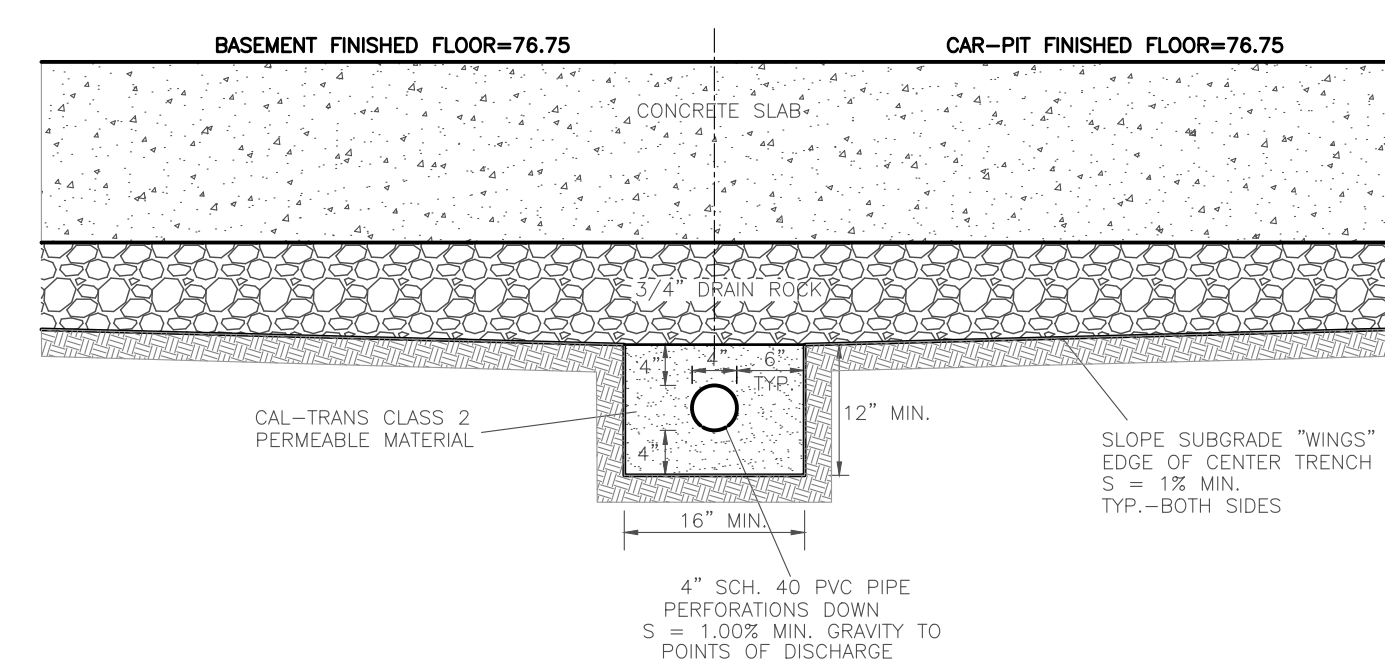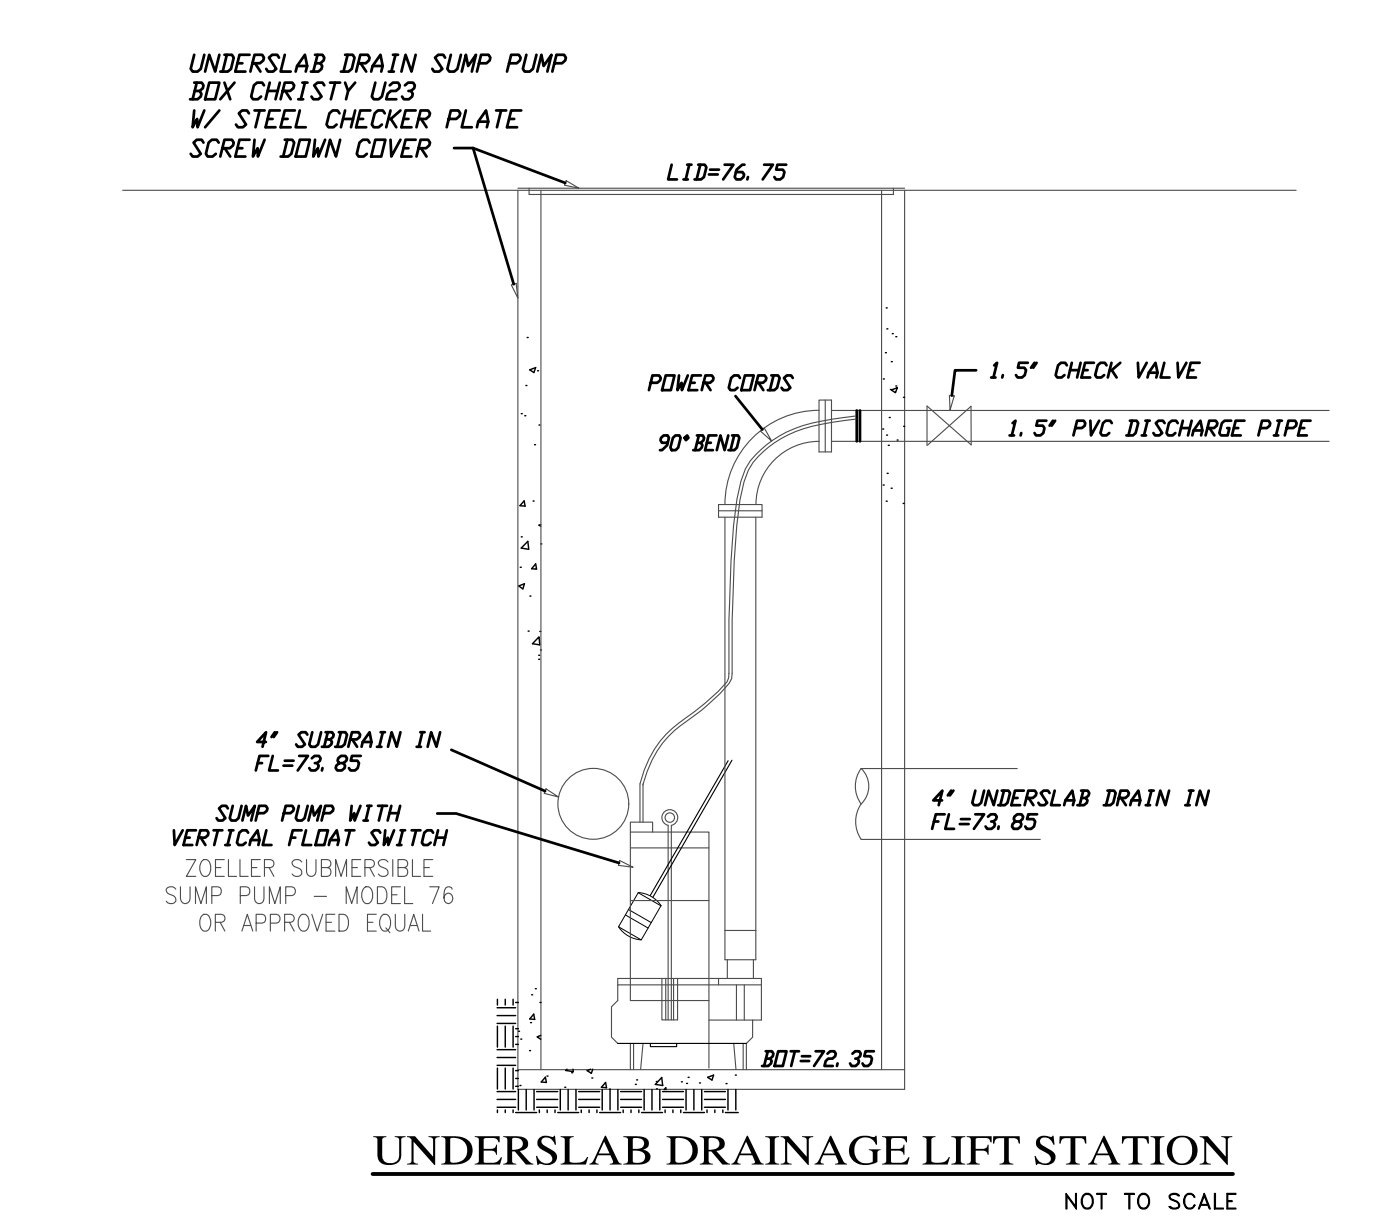

2398 Applications







- 1. 1/2" to 1" (12.7 to 25.4 mm) for 1/2" to 1" (12.7 to 25.4 mm) diameter pipes
- 2. 1/2" to 1" (12.7 to 25.4 mm) for 1/2" to 1" (12.7 to 25.4 mm) diameter pipes
- 3. 1/2" to 1" (12.7 to 25.4 mm) for 1/2" to 1" (12.7 to 25.4 mm) diameter pipes
- 4. 1/2" to 1" (12.7 to 25.4 mm) for 1/2" to 1" (12.7 to 25.4 mm) diameter pipes
- 5. 1/2" to 1" (12.7 to 25.4 mm) for 1/2" to 1" (12.7 to 25.4 mm) diameter pipes
- 6. 1/2" to 1" (12.7 to 25.4 mm) for 1/2" to 1" (12.7 to 25.4 mm) diameter pipes
- 7. 1/2" to 1" (12.7 to 25.4 mm) for 1/2" to 1" (12.7 to 25.4 mm) diameter pipes
- 8. 1/2" to 1" (12.7 to 25.4 mm) for 1/2" to 1" (12.7 to 25.4 mm) diameter pipes
- 9. 1/2" to 1" (12.7 to 25.4 mm) for 1/2" to 1" (12.7 to 25.4 mm) diameter pipes
- 10. 1/2" to 1" (12.7 to 25.4 mm) for 1/2" to 1" (12.7 to 25.4 mm) diameter pipes

Features and Benefits

- 100% Recycled Content
- 25% Recycled Content
- 100% Recycled Content
- 25% Recycled Content
- 100% Recycled Content
- 25% Recycled Content
- 100% Recycled Content
- 25% Recycled Content
- 100% Recycled Content
- 25% Recycled Content

2398 System Details

2398 System Details

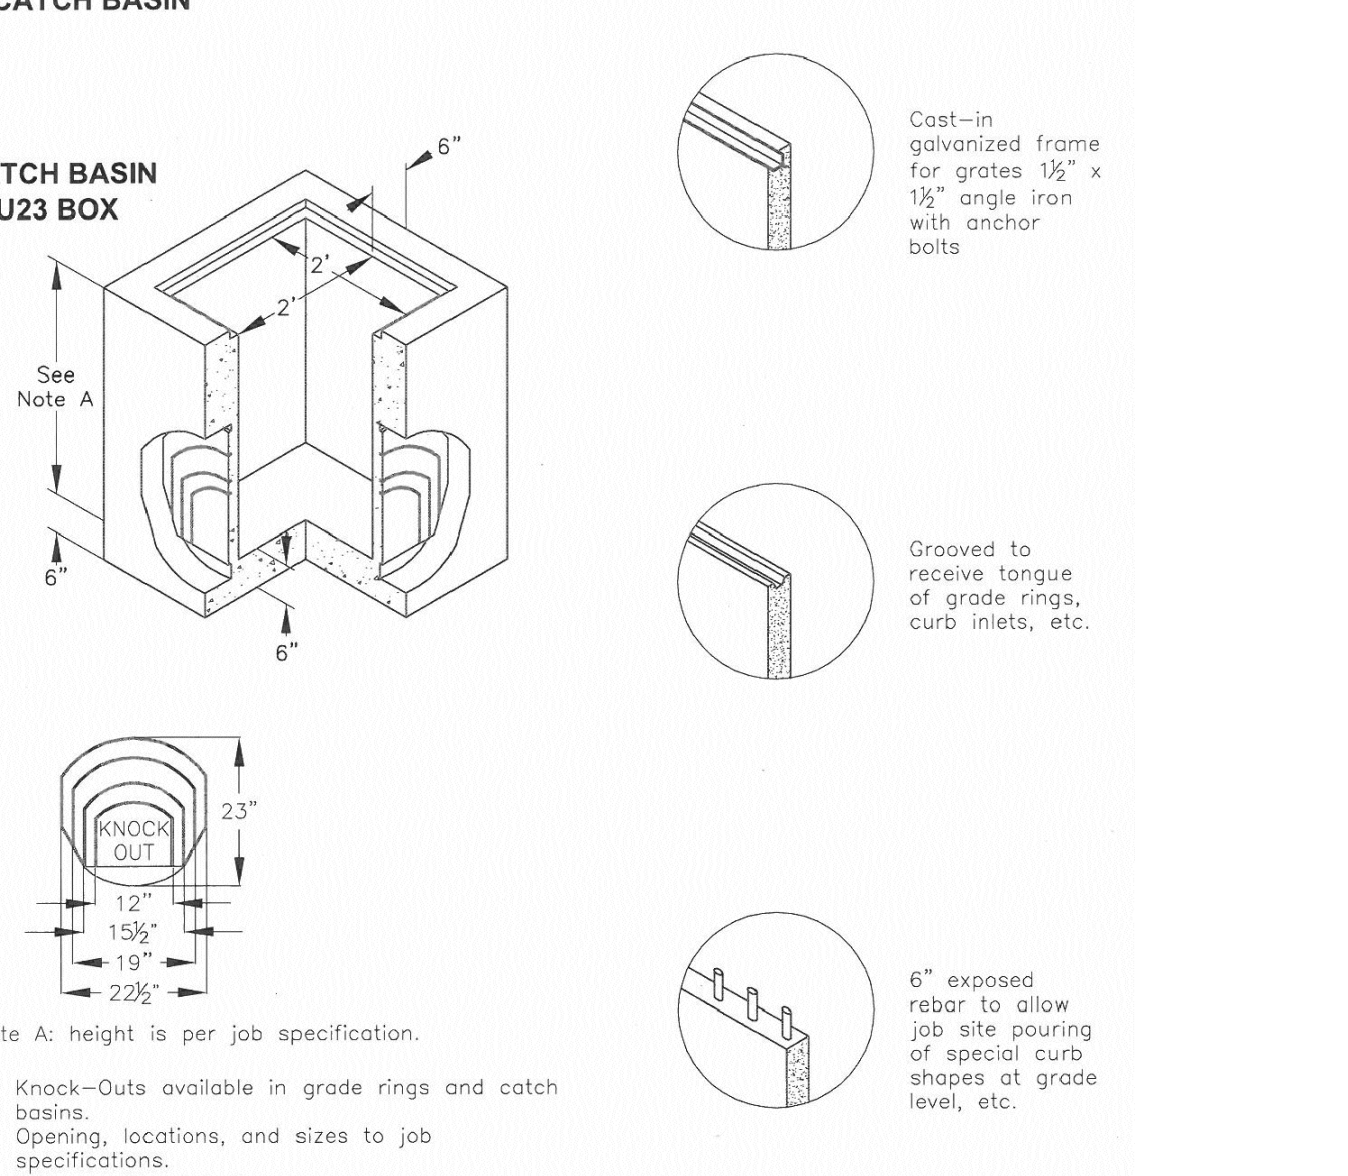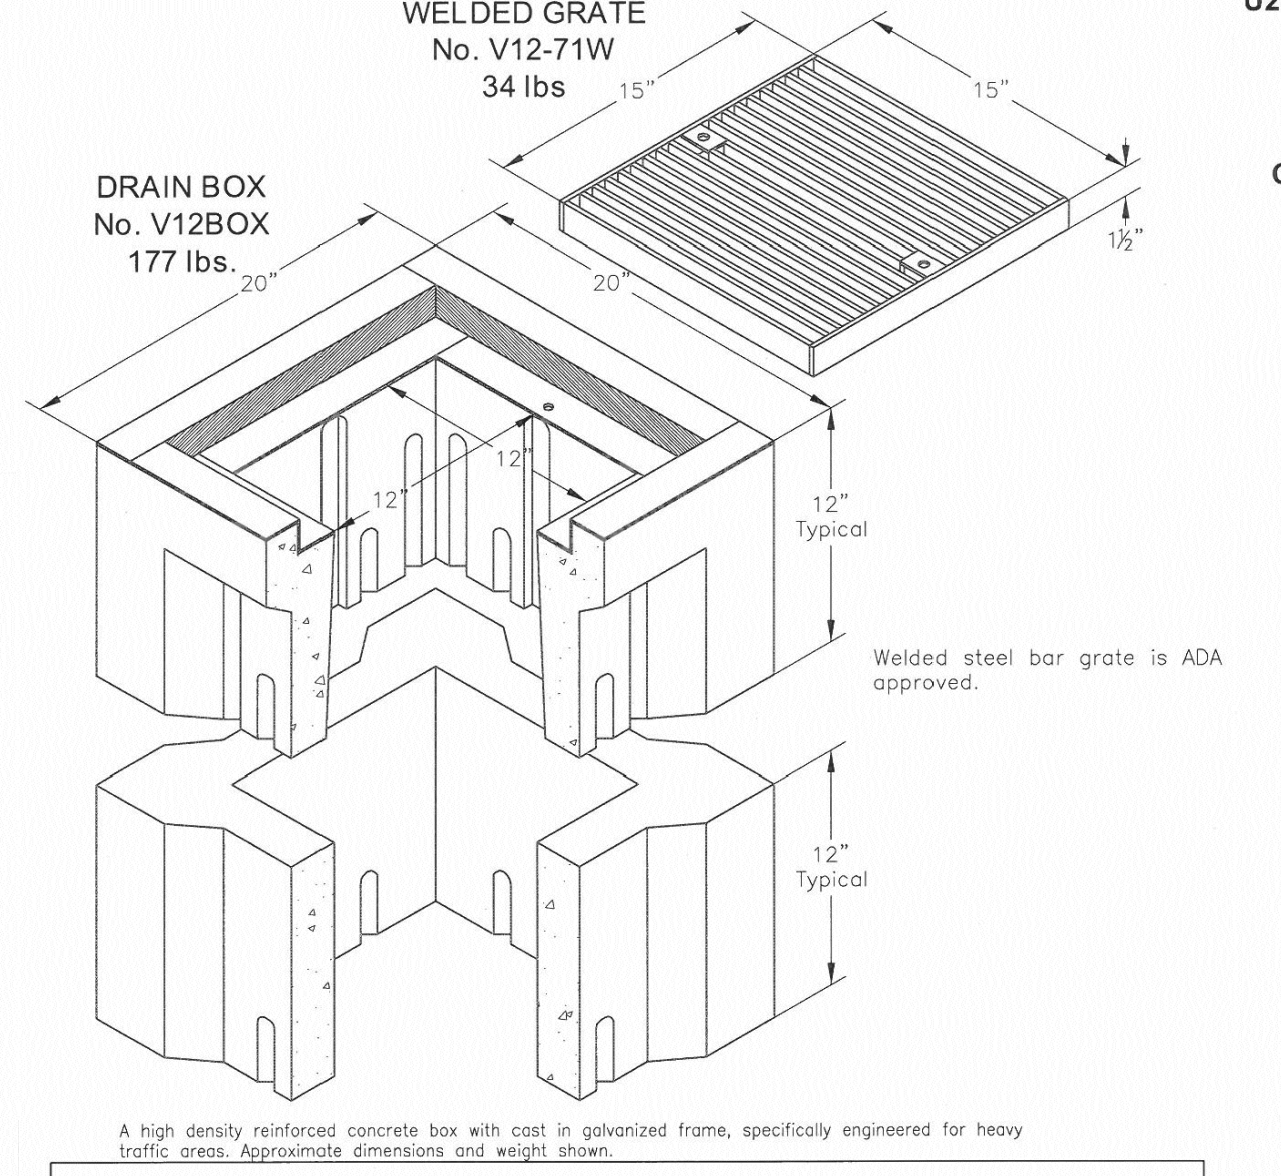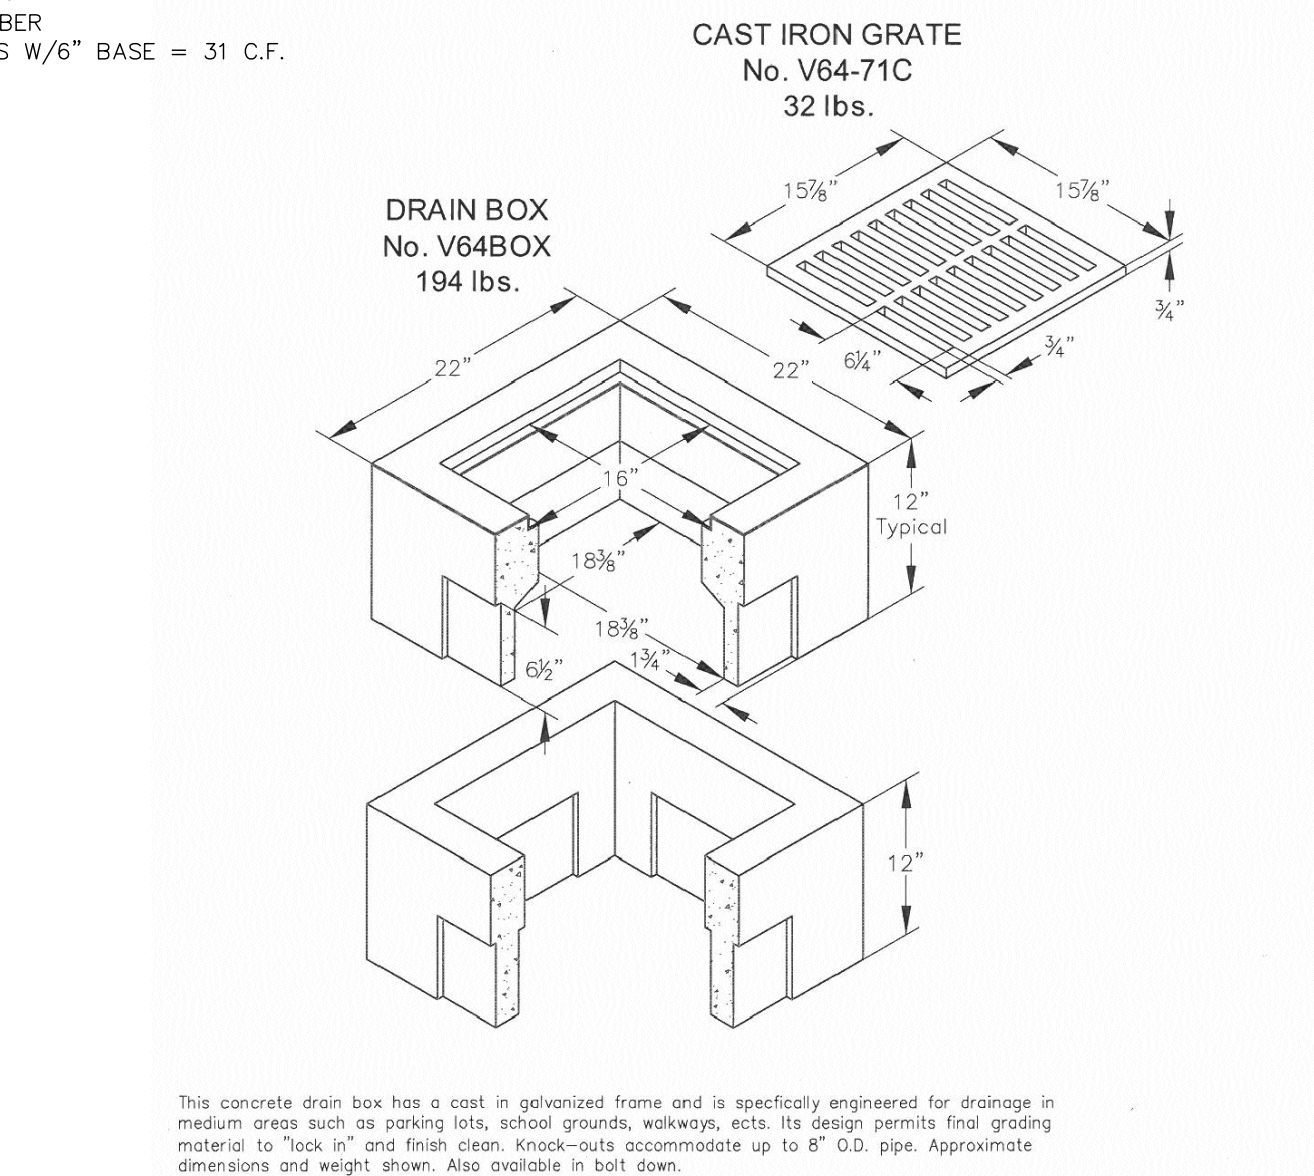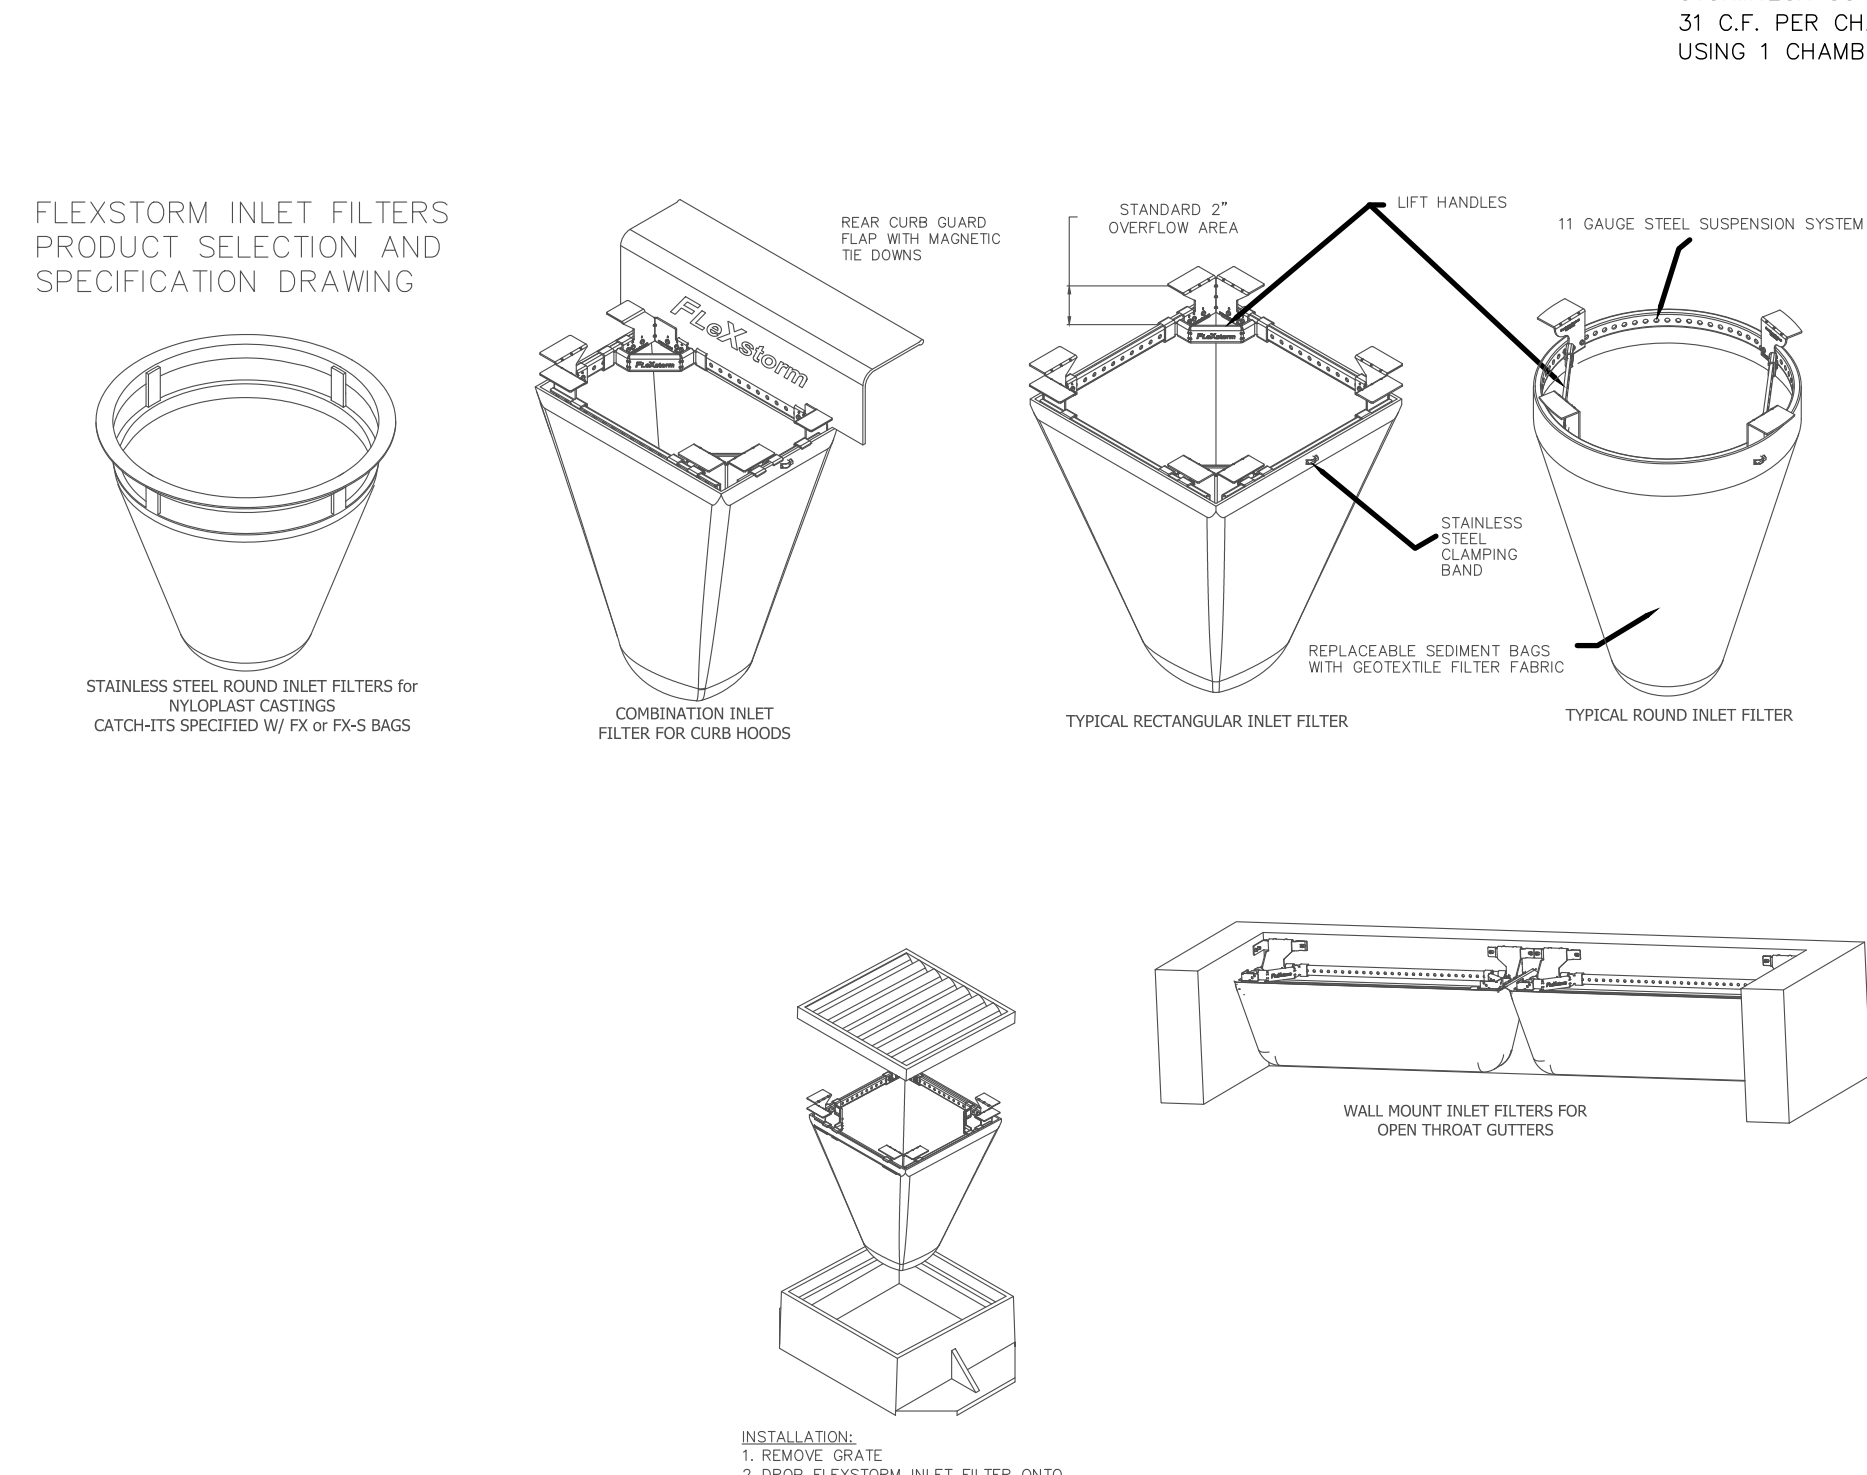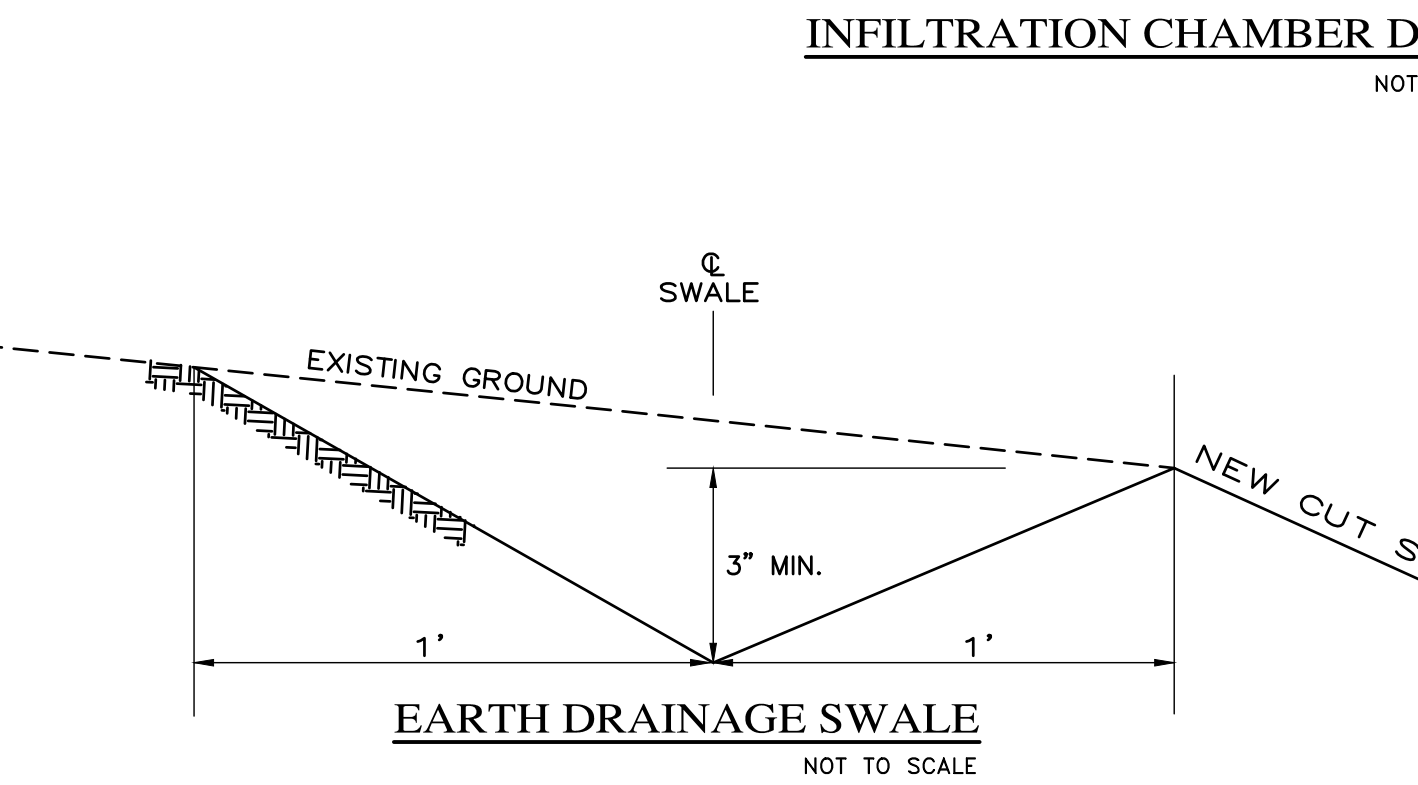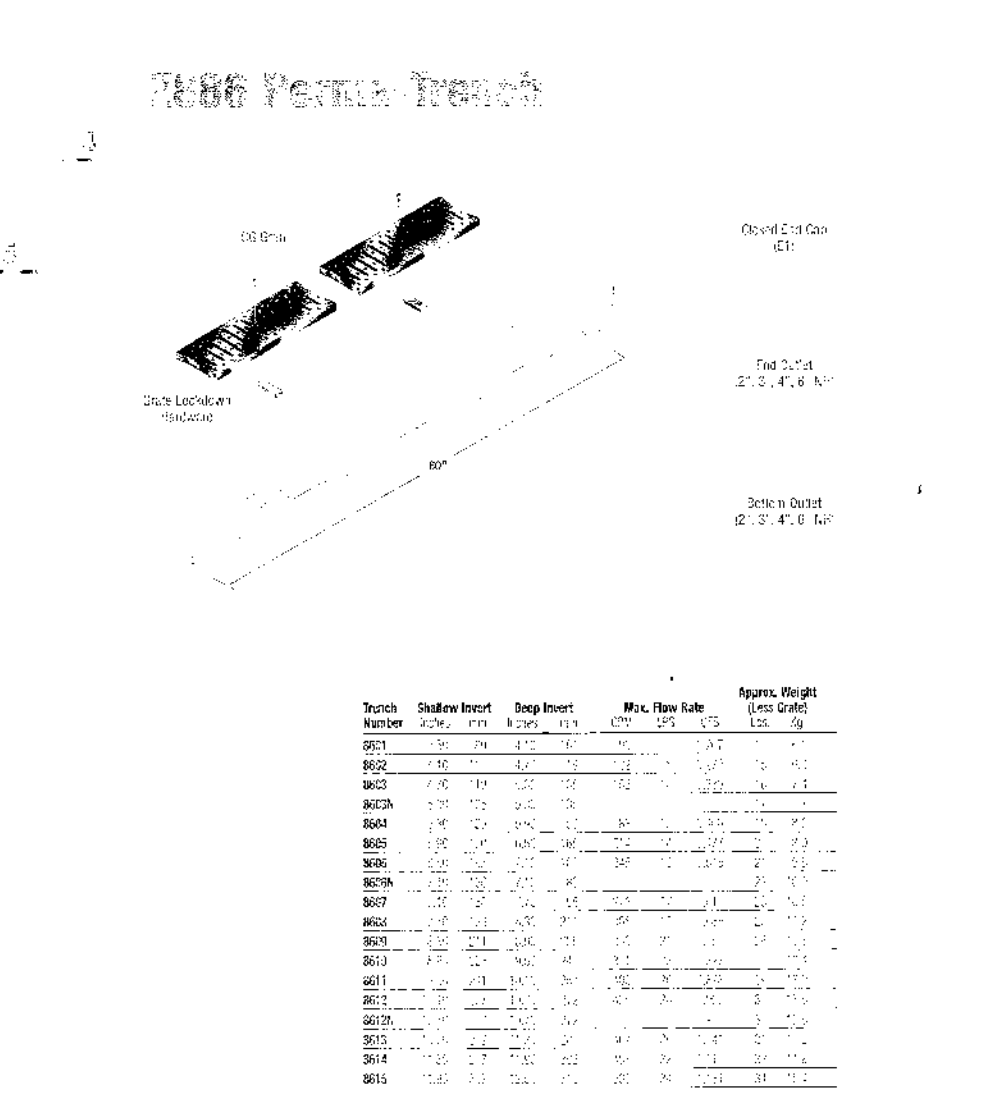

| Ordering Code | Item | Approx. Shipping Weight | Description |
|---------------|-----------|-------------------------|---|
| V64BOX | DRAIN BOX | 194 | V64 Drain Box (18" x 18") - 12 per pallet |
| V64-71C | GRATE | 32 | Cast Iron |
| V64X12 | EXTENSION | 152 | 12" Reinforced concrete - 12 per pallet |

| Ordering Code | Item | Approx. Shipping Weight | Description |
|---------------|-----------|-------------------------|--|
| V12BOX | BOX | 177 | V12 Drain Box (12 x 12") H/20 Loading, bolt down interchangeable with Brooks #1212 Box - 12 per pallet |
| V12-71W | GRATE | 34 | Welded, steel cross bars, H/20 loading, galvanized |
| V12X12 | EXTENSION | 120 | 12" Reinforced concrete - 12 per pallet |

| Ordering Code | Item | Approx. Shipping Weight | Description |
|---------------|-----------|-------------------------|--|
| U23BOX | BOX | 177 | U23 Drain Box (12 x 12") H/20 Loading, bolt down interchangeable with Brooks #1212 Box - 12 per pallet |
| U23-71W | GRATE | 34 | Welded, steel cross bars, H/20 loading, galvanized |
| U23X12 | EXTENSION | 120 | 12" Reinforced concrete - 12 per pallet |

62SSQ,62MSQ FX-S

INSTALLATION:
1. REMOVE GRATE
2. DROP FLEXSTORM INLET FILTER INTO LOAD BEARING LIP OF CASTING OR CONCRETE STRUCTURE
3. REPLACE GRATE

ALL PRODUCTS MANUFACTURED BY INLET & PIPE PROTECTION, INC. DISTRIBUTED BY ADS WWW.INLETFILTERS.COM (866) 287-8655 PH (630) 355-1477 FX INFO@INLETFILTERS.COM

Oldcastle Precast® Enclosure Solutions
MADISON/FRANKLIN/PHOENIX
Phone: (800) 486-7079 Fax: (800) 486-6804
www.oldcastleprecast.com

V64 DRAIN BOX
FILE NAME: V64_ISO
ISSUE DATE: January, 2009

V64 DRAIN BOX 18-3/8" x 18-3/8"
Christy

Oldcastle Precast® Enclosure Solutions
MADISON/FRANKLIN/PHOENIX
Phone: (800) 486-7079 Fax: (800) 486-6804
www.oldcastleprecast.com

V12 DRAIN BOX
FILE NAME: V12_ISO
ISSUE DATE: January, 2009

V12 DRAIN BOX 12" x 12"
Christy

Oldcastle Precast® Enclosure Solutions
MADISON/FRANKLIN/PHOENIX
Phone: (800) 486-7079 Fax: (800) 486-6804
www.oldcastleprecast.com

U23 CATCH BASIN
FILE NAME: U23_ISO
ISSUE DATE: January, 2009


U23 CATCH BASIN 2' x 2' W/ 6" WALLS
Christy

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U23 CATCH BASIN
FILE NAME: U23_ISO
ISSUE DATE: January, 2009

U23 CATCH BASIN 2' x 2' W/ 6" WALLS
Christy

| No. | DATE | BY | REVISION |
|-----|----------|-----|-----------------------------------|
| 1 | 06/04/19 | JAN | ARCHITECTURAL SITE PLAN REVISIONS |
| 2 | 03/29/19 | JK | RELEASED TO CLIENT |

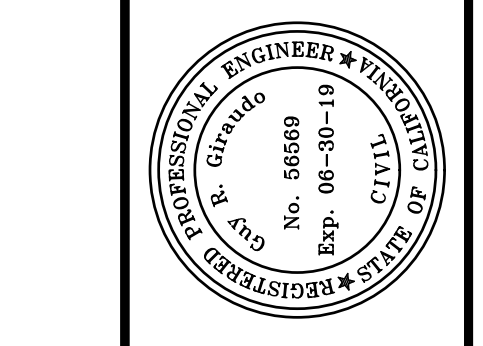




APPROVED BY:
GUY R. CIRAJDO



"CONSTRUCTION DETAILS"
GRADING, DRAINAGE & EROSION CONTROL PLAN
OF
LOT 15, BLOCK "U", AS SHOWN IN VOLUME 1
OF CITIES AND TOWNS AT PAGE 45-1/2
CARMEL-BY-THE-SEA, MONTEREY COUNTY, CALIFORNIA
MR AND MRS. DYLAN & NATASHA WITT

SCALE: AS SHOWN
DATE: JUN 2019
JOB NO. 1735-02

SHEET C5
OF 7 SHEETS

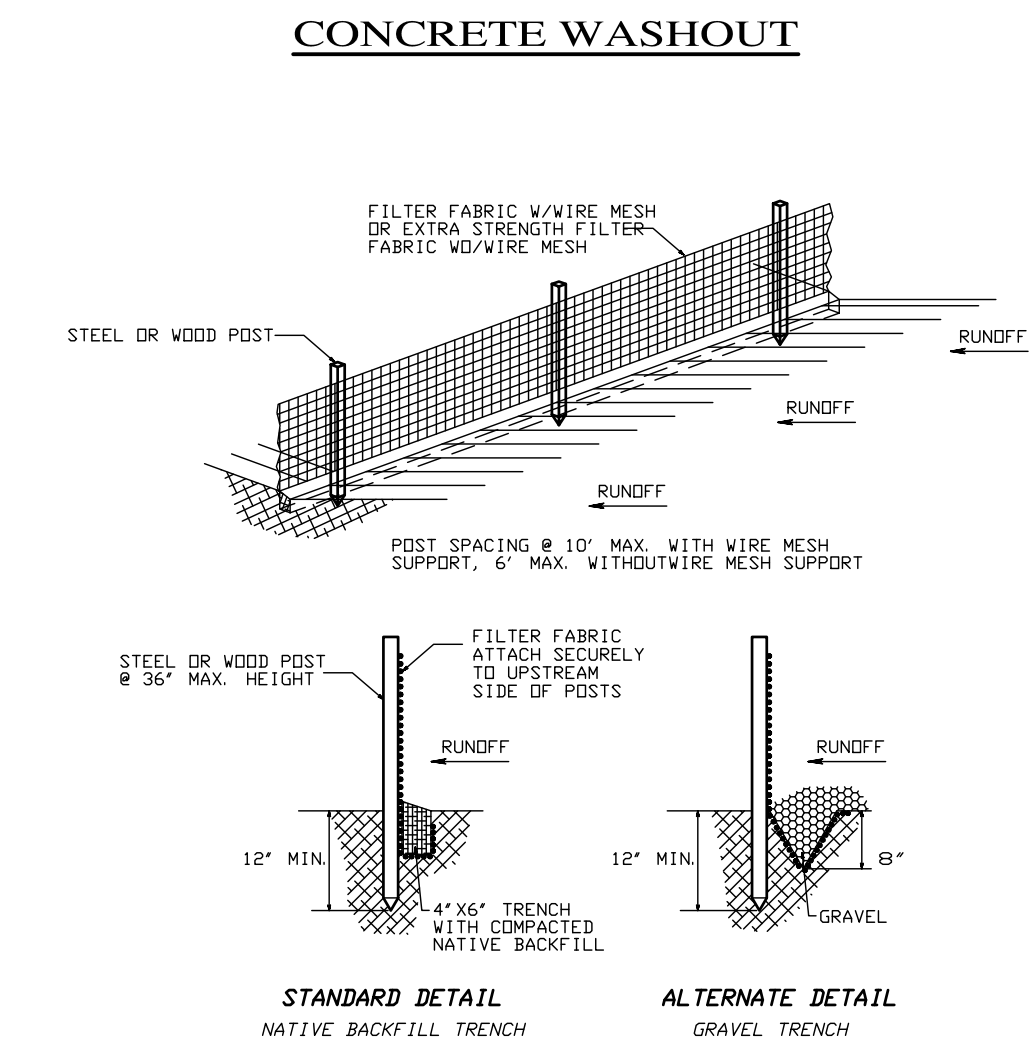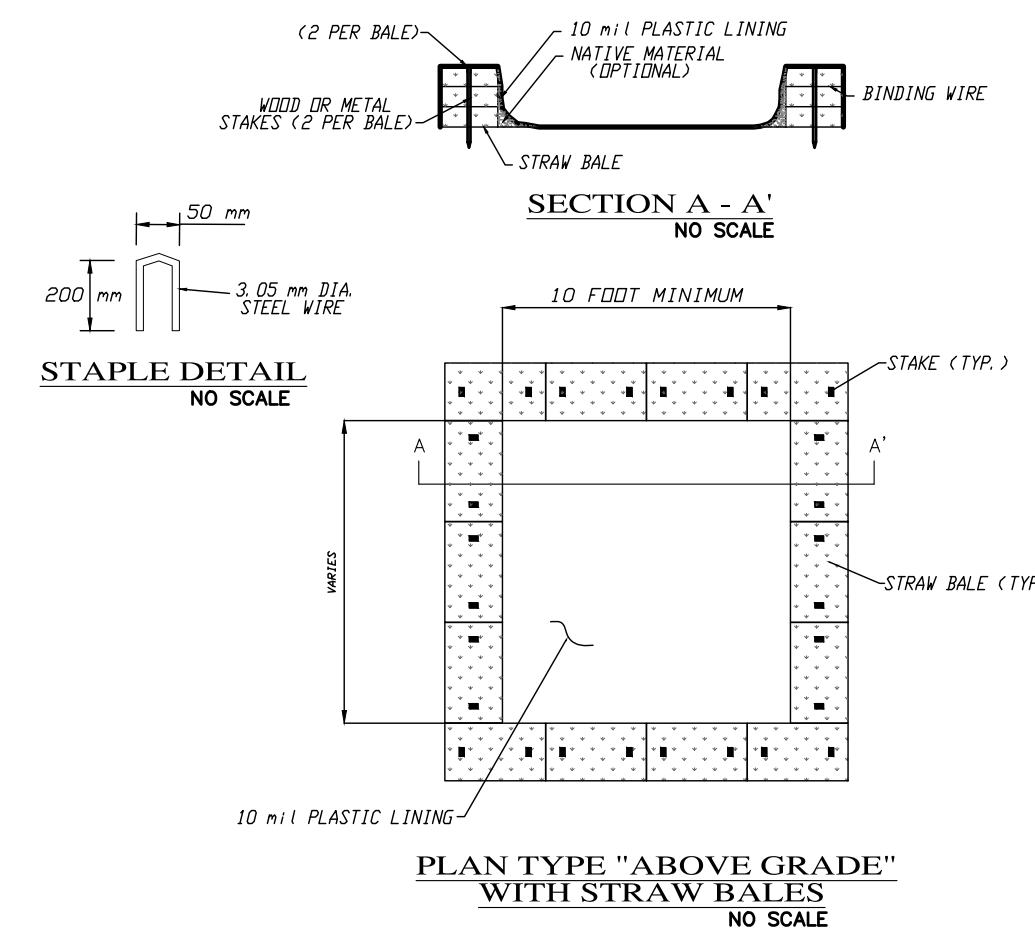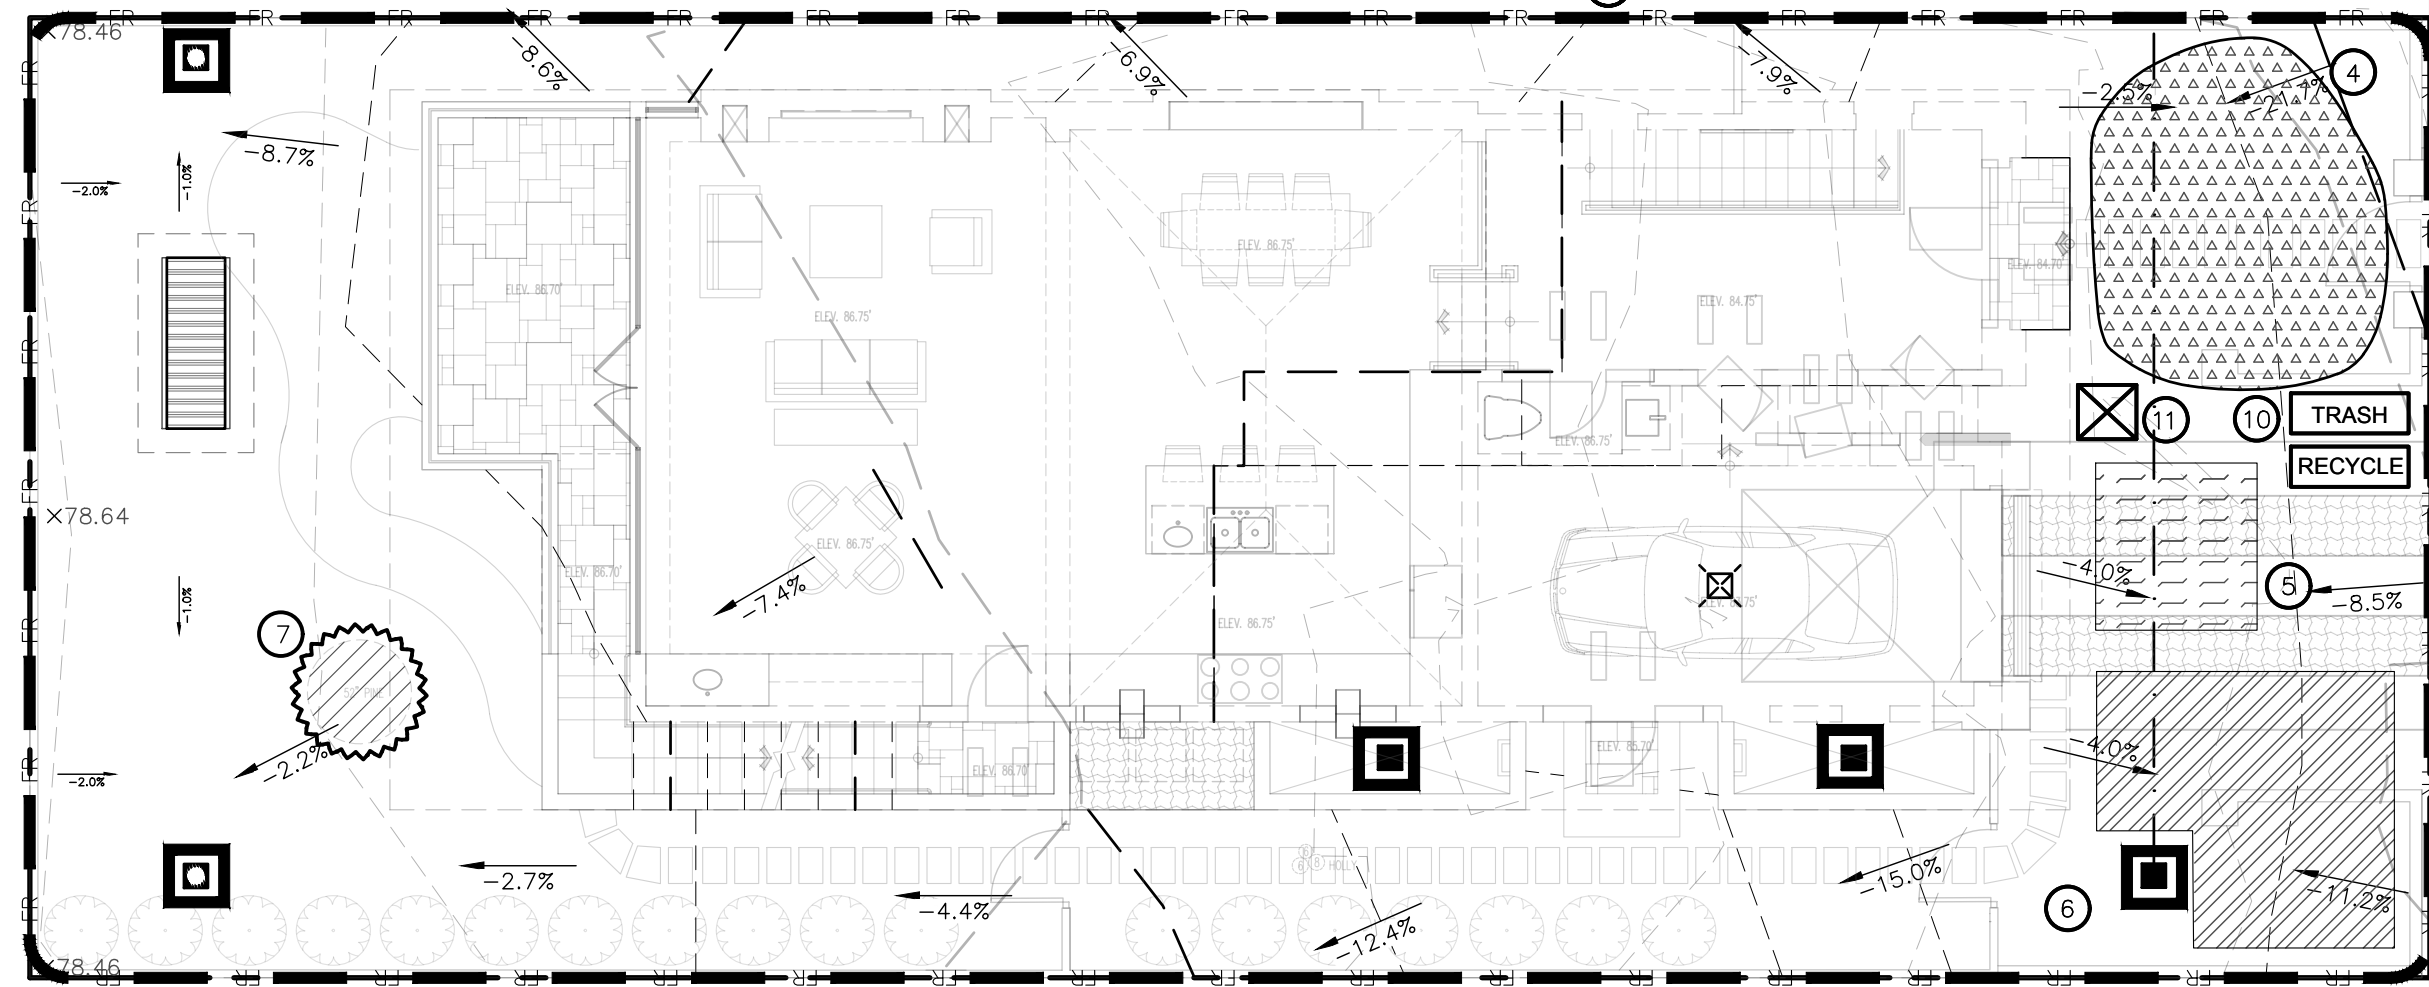

EROSION & SEDIMENT CONTROL NOTES:

- 1) ALL EROSION CONTROL MEASURES SHALL CONFORM WITH THE COUNTY OF MONTEREY EROSION CONTROL ORDINANCE.
- 2) ALL SLOPES SHALL BE PROTECTED WITH STRAW MULCH OR SIMILAR MEASURES TO PROTECT AGAINST EROSION UNTIL SUCH SLOPES ARE PERMANENTLY STABILIZED.
- 3) RUNOFF SHALL BE DETAINED OR FILTERED BY BERMS, VEGETATED FILTER STRIPS, AND/OR CATCH BASINS TO PREVENT THE ESCAPE OF SEDIMENT FROM THE SITE.
- 4) EROSION AND SEDIMENT CONTROL MEASURES SHALL BE IN PLACE AT THE END OF EACH DAY'S WORK. ACCESS ROADS SHALL BE CLEANED DAILY (IF NECESSARY) AND PRIOR TO ANY RAIN EVENT.
- 5) ALL ROADS AND DRIVEWAYS SHALL HAVE DRAINAGE FACILITIES SUFFICIENT TO PREVENT EROSION ON OR ADJACENT TO THE ROADWAY OR ON THE DOWNHILL PROPERTIES.
- 6) CONTRACTOR SHALL PROVIDE WATERING FOR DUST CONTROL DURING ALL GROUND DISTURBANCE OPERATIONS.
- 7) REVEGETATION SHALL CONSIST OF A MECHANICALLY APPLIED HYDROMULCH SLURRY OR HAND SEEDING WITH A STRAW MULCH COVER. MULCH SHALL BE ANCHORED BY AN APPROVED METHOD SUCH AS PUNCHING, TACKING, OR THE USE OF JUTE NETTING, AS DEEMED NECESSARY FOR THE SITE CONDITIONS TO ALLOW FOR GERMINATION AND ENABLE ADEQUATE GROWTH TO BE ESTABLISHED.
- 8) CHECK DAMS, SILT FENCES, FIBER ROLLS OR OTHER DESIGNS SHALL BE INCORPORATED TO CATCH ANY SEDIMENT UNTIL AFTER THE NEWLY EXPOSED AREAS ARE REVEGETATED SUFFICIENTLY TO CONTROL EROSION. EROSION CONTROL PLANTINGS AND MULCH SHALL BE CLOSELY MONITORED THROUGHOUT THE WINTER AND ANY RUNOFF PROBLEMS SHALL BE CORRECTED PROMPTLY. ALL EROSION AND/OR SLIPPAGE OF THE NEWLY EXPOSED AREAS SHALL BE REPAIRED BY THE PERMITTEE AT THEIR EXPENSE.
- 9) THE GRASS SEED SHALL BE PROPERLY IRRIGATED UNTIL ADEQUATE GROWTH IS ESTABLISHED AND MAINTAINED TO PROTECT THE SITE FROM FUTURE EROSION DAMAGE. ALL NEWLY EXPOSED (DISTURBED) AREAS SHALL BE SEEDING WITH THE FOLLOWING EROSION CONTROL MIX: BRONJUS CARINATUS (CALIFORNIA BROME), VULPIA MICROSTACHYS (NUTTALL'S FESCUE), ELYMUS GLAUCUS (BLUE WILD RYE), HORDEUM BRACHYANTHERUM (MEADOW BARLEY), FESTUCA RUNR'AMOLATE BLUE AND A MIXTURE OF LOCALLY NATIVE WILDFLOWERS.
- 10) SEEDING AREAS SHALL BE RETAINED ON-SITE AND SHALL BE PREVENTED FROM FLOWING INTO THE STORM DRAINAGE SYSTEM. SEDIMENT CATCHMENT BARRIERS SHALL BE INSPECTED BY THE APPLICANT IMMEDIATELY AFTER ANY SIGNIFICANT RAINFALL AND AT LEAST DAILY DURING ANY PERIOD OF PROLONGED RAINFALL.
- 11) PRIOR TO COMMENCEMENT OF ANY LAND DISTURBANCE, THE OWNER/APPLICANT SHALL SCHEDULE AN INSPECTION WITH RMA-ENVIRONMENTAL SERVICES TO ENSURE ALL NECESSARY SEDIMENT CONTROLS ARE IN PLACE AND THE PROJECT IS COMPLIANT WITH MONTEREY COUNTY GRADING AND EROSION CONTROL REGULATIONS.
- 12) DURING CONSTRUCTION THE OWNER/APPLICANT SHALL SCHEDULE AN INSPECTION WITH RMA-ENVIRONMENTAL SERVICES TO UPDATE COMPACTION TEST RECORDS, INSPECT DRAINAGE DEVICE INSTALLATION, REVIEW THE MAINTENANCE AND EFFECTIVENESS OF BMPs INSTALLED, AS WELL AS, TO VERIFY THAT POLLUTANTS OF CONCERN ARE NOT DISCHARGED FROM THE SITE.
- 13) PRIOR TO FINAL INSPECTION, THE OWNER/APPLICANT SHALL SCHEDULE AN INSPECTION WITH RMA-ENVIRONMENTAL SERVICES TO CONDUCT A FINAL GRADING INSPECTION, COLLECT FINAL GEOTECHNICAL LETTER OF CONFIRMATION AND CAPTURED AREAS HAVE BEEN STABILIZED AND THAT ALL TEMPORARY EROSION AND SEDIMENT CONTROL MEASURES THAT ARE NO LONGER NEEDED HAVE BEEN REMOVED.
- 14) THE APPLICANT SHALL SCHEDULE WEEKLY INSPECTIONS WITH RMA-ENVIRONMENTAL SERVICES DURING THE RAINY SEASON, OCTOBER 15th TO APRIL 15th, TO ENSURE CONTAMINANTS ARE NOT DISCHARGED INTO THE AREAS OF SPECIAL BIOLOGICAL SIGNIFICANCE.

BMP LEGEND:

- 1 FR
- 2 N/A FOR INFORMATION ONLY
- 3
- 4
- 5
- 6
- 7
- 8 SF
- 9 N/A FOR INFORMATION ONLY
- 10 TRASH
- 11 RECYCLE

FIBER ROLLS: THE CONTRACTOR SHALL MAINTAIN A STOCKPILE OF FIBER ROLLS ONSITE, AS THEY CAN BE USED ALONG ERODIBLE SLOPES, ALONG STOCKPILE PERIMETERS, DOWNSLOPE OF EXPOSED SOIL AREAS, AND TO STORE DELIVERED MATERIALS. FIBER ROLLS MUST BE TRENCHED INTO THE SOIL AND STAKED (STAKES SPACED MAX. 4' ON CENTER). SEE DETAIL. INSTALL FIBER ROLLS ALONG LEVEL CONTOURS, AND TURN THE ENDS UPHILL. INSPECT WEEKLY AND REMOVE ACCUMULATED SEDIMENT REGULARLY.

DRAIN INLET PROTECTION: PLACE GEOTEXTILE FILTER FABRIC BENEATH INLET GRATE AND SURROUND ENTIRE INLET WITH GRAVEL BAGS (OVERLAP THE BAGS AND PACK THEM TIGHTLY TOGETHER - SEE DETAIL). INSPECT ALL INLET PROTECTION WEEKLY. REMOVE ACCUMULATED SEDIMENT REGULARLY.

STABILIZED CONSTRUCTION ACCESS: INSTALL STABILIZED CONSTRUCTION ACCESS PRIOR TO COMMENCEMENT OF EARTH MOVING OPERATIONS (IF NECESSARY FOR THIS APPLICATION, SEE DETAIL). INSPECT ENTRANCE DAILY, AND ADD ADDITIONAL STONE AS TOP-DRESSING WHEN REQUIRED. USE FENCING OR BARRICADES TO PREVENT VEHICLE TRAFFIC FROM DRIVING AROUND THE STABILIZED ACCESS.

STOCKPILE MANAGEMENT: SOIL STOCKPILES MUST BE COVERED OR STABILIZED (I.E. WITH SOIL BINDERS) IMMEDIATELY IF THEY ARE NOT SCHEDULED TO BE USED WITHIN 14 DAYS. ACTIVE SOIL STOCKPILES SHALL BE WATERED TWICE DAILY TO AVOID WIND EROSION. SURROUND ALL STOCKPILES WITH FIBER ROLLS OR SILT FENCE. STOCKPILES OF "COLD MIX", TREATED WOOD, AND BASIC CONSTRUCTION MATERIALS SHOULD BE PLACED ON AND COVERED WITH PLASTIC SHEETING OR COMPARABLE MATERIAL AND SURROUNDED BY A BERM.

CONCRETE WASHOUT: WASHOUT MUST BE LOCATED A MINIMUM OF 50 FEET FROM STORM DRAINS, OPEN DITCHES, OR WATER BODIES. DISCONTINUE USE WHEN WASHOUT WASTES REACH 75% OF THE WASHOUT CAPACITY. ALLOW WASHOUT WASTES TO HARDEN, BE BROKEN UP, AND THEN DISPOSED OF PROPERLY.

CONTRACTOR'S STAGING AREA: THE CONTRACTOR'S STAGING AREA SHALL BE SURROUNDED BY FIBER ROLLS. THE STAGING AREA WILL BE USED TO STORE DELIVERED MATERIALS, AND FOR OVERNIGHT EQUIPMENT PARKING/FUELING. STORED CONSTRUCTION MATERIALS SHALL BE MAINTAINED IN THEIR ORIGINAL CONTAINERS, AND COVERED AT ALL TIMES. PETROLEUM PRODUCTS AND HAZARDOUS MATERIALS SHALL BE STORED WITHIN SECONDARY CONTAINMENT STRUCTURES OR A STORAGE SHED. EQUIPMENT FUELING AND MAINTENANCE WILL ONLY OCCUR WITHIN THE DESIGNATED STAGING AREA. DRIP PANS OR ABSORBENT PADS MUST BE USED DURING ALL FUELING OR MAINTENANCE ACTIVITIES. AN AMPLE SUPPLY OF SPILL CLEANUP MATERIALS SHALL BE MAINTAINED IN THE STAGING AREA AT ALL TIMES.

TREE PROTECTION: TREE PROTECTION SHALL CONSIST OF ORANGE PLASTIC MESH FENCING, AND SHALL BE INSTALLED PRIOR TO COMMENCEMENT OF EARTH-MOVING OPERATIONS (SEE DETAIL). INSTALL FENCING ALONG THE DRIP LINE OF TREES, AND INSTRUCT EMPLOYEES AND SUBCONTRACTORS TO HONOR PROTECTIVE DEVICES. TREE INJURIES SHALL BE ATTENDED TO BY A LICENSED AND CERTIFIED ARBORIST.

SILT FENCE: SILT FENCE SHALL CONSIST OF WOVEN GEOTEXTILE FABRIC WITH A MINIMUM WIDTH OF 36 INCHES. WOOD STAKES SHALL BE COMMERCIAL QUALITY LUMBER, SPACED A MAXIMUM OF 6' APART AND DRIVEN SECURELY INTO THE GROUND (SEE DETAIL). FENCING FABRIC SHALL BE KEVLEK INTO THE SOIL AS PER MANUFACTURER'S RECOMMENDATION. INSTALL SILT FENCE ALONG LEVEL CONTOURS. TURN THE ENDS OF THE SILT FENCE UPHILL TO PREVENT WATER FROM FLOWING AROUND THE FENCE. INSPECT SILT FENCE DAILY, AND MAKE REPAIRS IMMEDIATELY.

GRAVEL BAG CHECK DAM: GRAVEL BAGS SHALL CONSIST OF WOVEN POLYPROPYLENE, POLYETHYLENE OR POLYAMIDE FABRIC, MIN. UNIT WEIGHT OF 40Z/SY. BAGS SHALL BE A MINIMUM OF 18" LONG X 12" WIDE X 3" THICK, FILLED WITH 0.5" - 1" CRUSHED ROCK. TIGHTLY ABUT BAGS AND CONSTRUCT CHECK DAM AT LEAST 3 BAGS WIDE X 2 BAGS HIGH. INSPECT CHECK DAM REGULARLY AND REMOVE ACCUMULATED SEDIMENT.

WASTE MANAGEMENT: SOLID WASTES WILL BE LOADED DIRECTLY ONTO TRUCKS FOR OFF-SITE DISPOSAL. WHEN ON-SITE STORAGE IS NECESSARY, SOLID WASTES WILL BE STORED IN WATER-TIGHT DUMPSTERS IN THE GENERAL STORAGE AREA OF THE CONTRACTOR'S YARD. DUMPSTERS AND/OR TRASH BINS SHALL BE COVERED AT THE END OF EACH WORK DAY. HAZARDOUS WASTES SHALL NOT BE STORED ONSITE. CONSTRUCTION DEBRIS AND GENERAL LITTER WILL BE COLLECTED DAILY AND WILL NOT BE ALLOWED NEAR DRAINAGE INLETS OR DRAINAGE SYSTEMS.

SANITARY/SEPTIC WASTE MANAGEMENT: PORTABLE TOILETS WILL BE PROVIDED AND MAINTAINED ONSITE FOR THE DURATION OF THE PROJECT. ALL PORTABLE TOILETS WILL BE EQUIPPED WITH A SECONDARY CONTAINMENT TRAY, AND SHALL BE LOCATED A MINIMUM OF 50' FROM ALL OPERATIONAL STORM DRAIN INLETS. WEEKLY MAINTENANCE SHALL BE PROVIDED AND WASTES LEGALLY DISPOSED OF OFF-SITE.

Solid Waste Management WM-5

Description and Purpose
Solid waste management procedures and practices are designed to prevent or reduce the discharge of pollutants to stormwater from solid or construction waste by providing designated waste collection areas and containers, arranging the regular disposal, and training employees and subcontractors.

Categories
EC Erosion Control
SE Sediment Control
TC Tracking Control
WE Wind Erosion Control
NS Non-Stormwater Management Control
WM Waste Management and Materials Pollution Control

Legend:
☑ Primary Objective
☐ Secondary Objective

Targeted Constituents
Sediment ☑
Nutrients ☑
Trash ☑
Metals ☑
Bacteria ☑
Oil and Grease ☑
Organics ☑

Potential Alternatives
None

Material Delivery and Storage WM-1

Description and Purpose
Prevent, reduce, or eliminate the discharge of pollutants from material delivery and storage to the stormwater system or watercourses by minimizing the storage of hazardous materials onsite, storing materials in watertight containers and/or a completely enclosed designated area, installing secondary containment, conducting regular inspections, and training employees and subcontractors.

Categories
EC Erosion Control
SE Sediment Control
TC Tracking Control
WE Wind Erosion Control
NS Non-Stormwater Management Control
WM Waste Management and Materials Pollution Control

Legend:
☑ Primary Category
☐ Secondary Category

Targeted Constituents
Sediment ☑
Nutrients ☑
Trash ☑
Metals ☑
Bacteria ☑
Oil and Grease ☑
Organics ☑

Potential Alternatives
None

Hazardous Waste Management WM-6

Description and Purpose
Prevent or reduce the discharge of pollutants to stormwater from hazardous waste through proper material use, waste disposal, and training of employees and subcontractors.

Categories
EC Erosion Control
SE Sediment Control
TC Tracking Control
WE Wind Erosion Control
NS Non-Stormwater Management Control
WM Waste Management and Materials Pollution Control

Legend:
☑ Primary Objective
☐ Secondary Objective

Targeted Constituents
Sediment ☑
Nutrients ☑
Trash ☑
Metals ☑
Bacteria ☑
Oil and Grease ☑
Organics ☑

Potential Alternatives
None

Sanitary/Septic Waste Management WM-9

Description and Purpose
Proper sanitary and septic waste management prevent the discharge of pollutants to stormwater from sanitary and septic waste by providing convenient, well-maintained facilities, and arranging for regular service and disposal.


Categories
EC Erosion Control
SE Sediment Control
TC Tracking Control
WE Wind Erosion Control
NS Non-Stormwater Management Control
WM Waste Management and Materials Pollution Control

Legend:
☑ Primary Objective
☐ Secondary Objective


Targeted Constituents
Sediment ☑
Nutrients ☑
Trash ☑
Metals ☑
Bacteria ☑
Oil and Grease ☑
Organics ☑

Potential Alternatives
None

STABILIZED CONSTRUCTION ENTRANCE

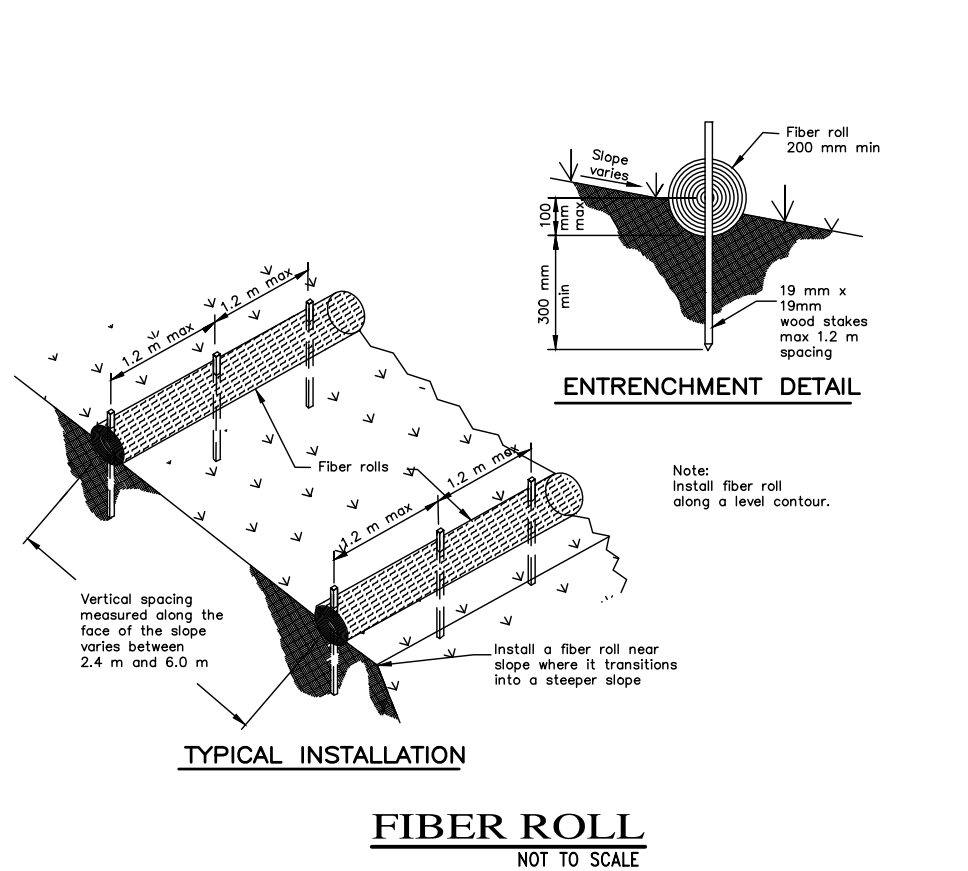

DETAILS
NOT TO SCALE

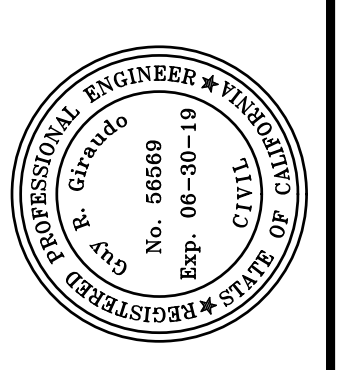

APPROVED BY:
GUY R. CIRAUDINO
6619







"EROSION CONTROL PLAN"
 GRADING, DRAINAGE & EROSION CONTROL PLAN
 OF
 LOT 15, BLOCK "U", AS SHOWN IN VOLUME 1
 OF CITIES AND TOWNS AT PAGE 45-1/2
 CARMEL-BY-THE-SEA, MONTEREY COUNTY, CALIFORNIA
 MR AND MRS. DYLAN & NATASHA WITT


SCALE: 1" = 8'
DATE: JUN 2019
JOB NO. 1735-02

| No. | DATE | BY | REVISION |
|----------|------|----|-----------------------------------|
| 06/04/19 | JAN | | ARCHITECTURAL SITE PLAN REVISIONS |
| 03/29/19 | JK | | RELEASED TO CLIENT |

SHEET **C6**
OF 7 SHEETS

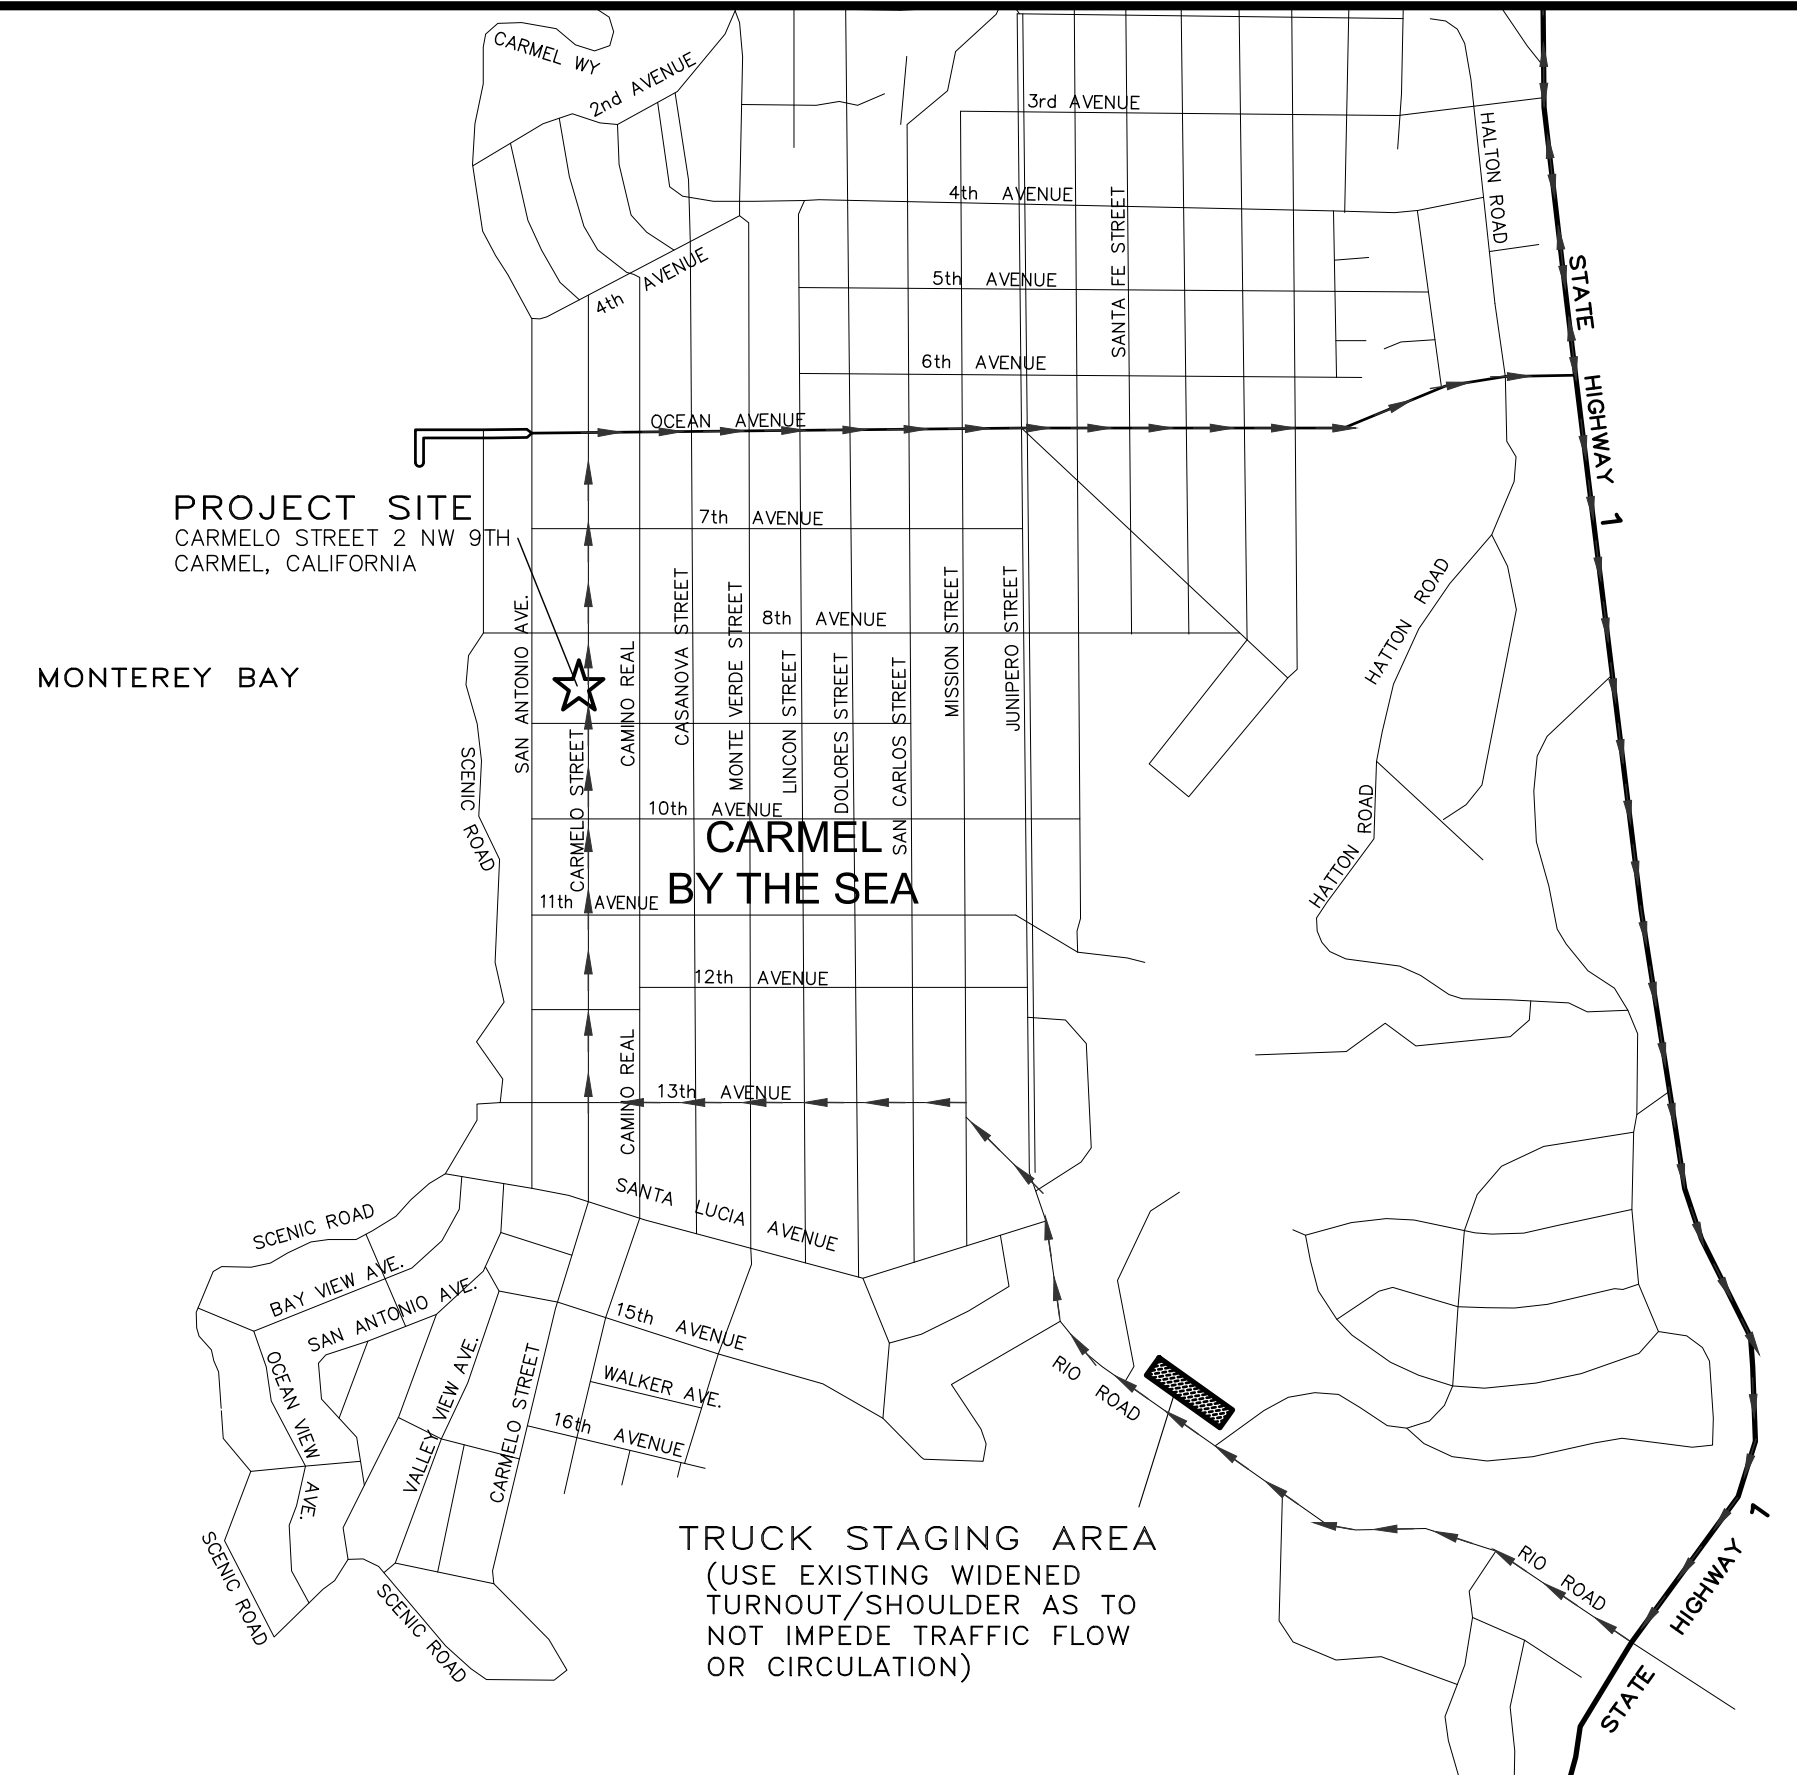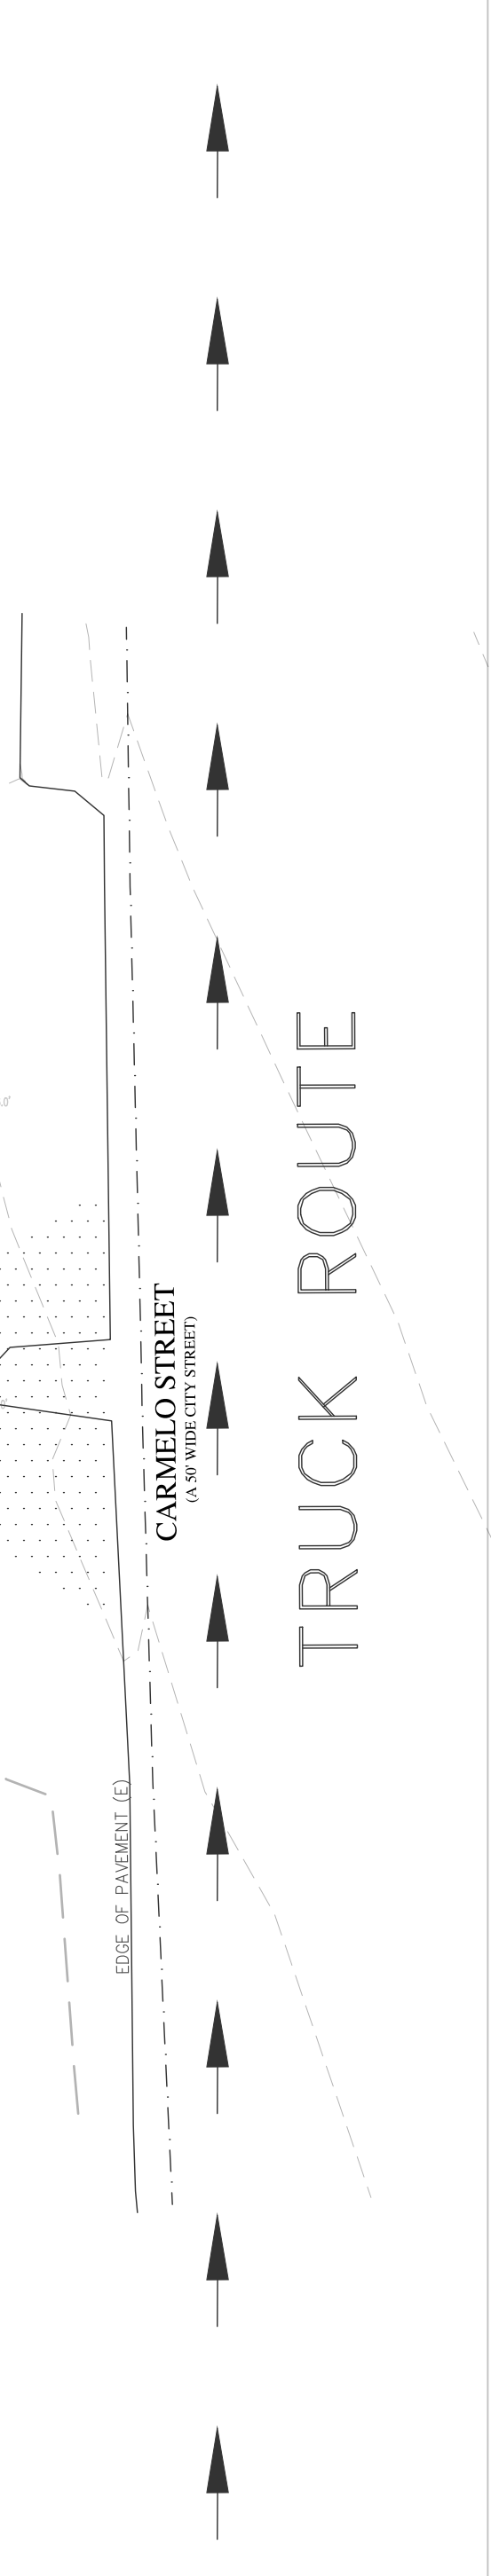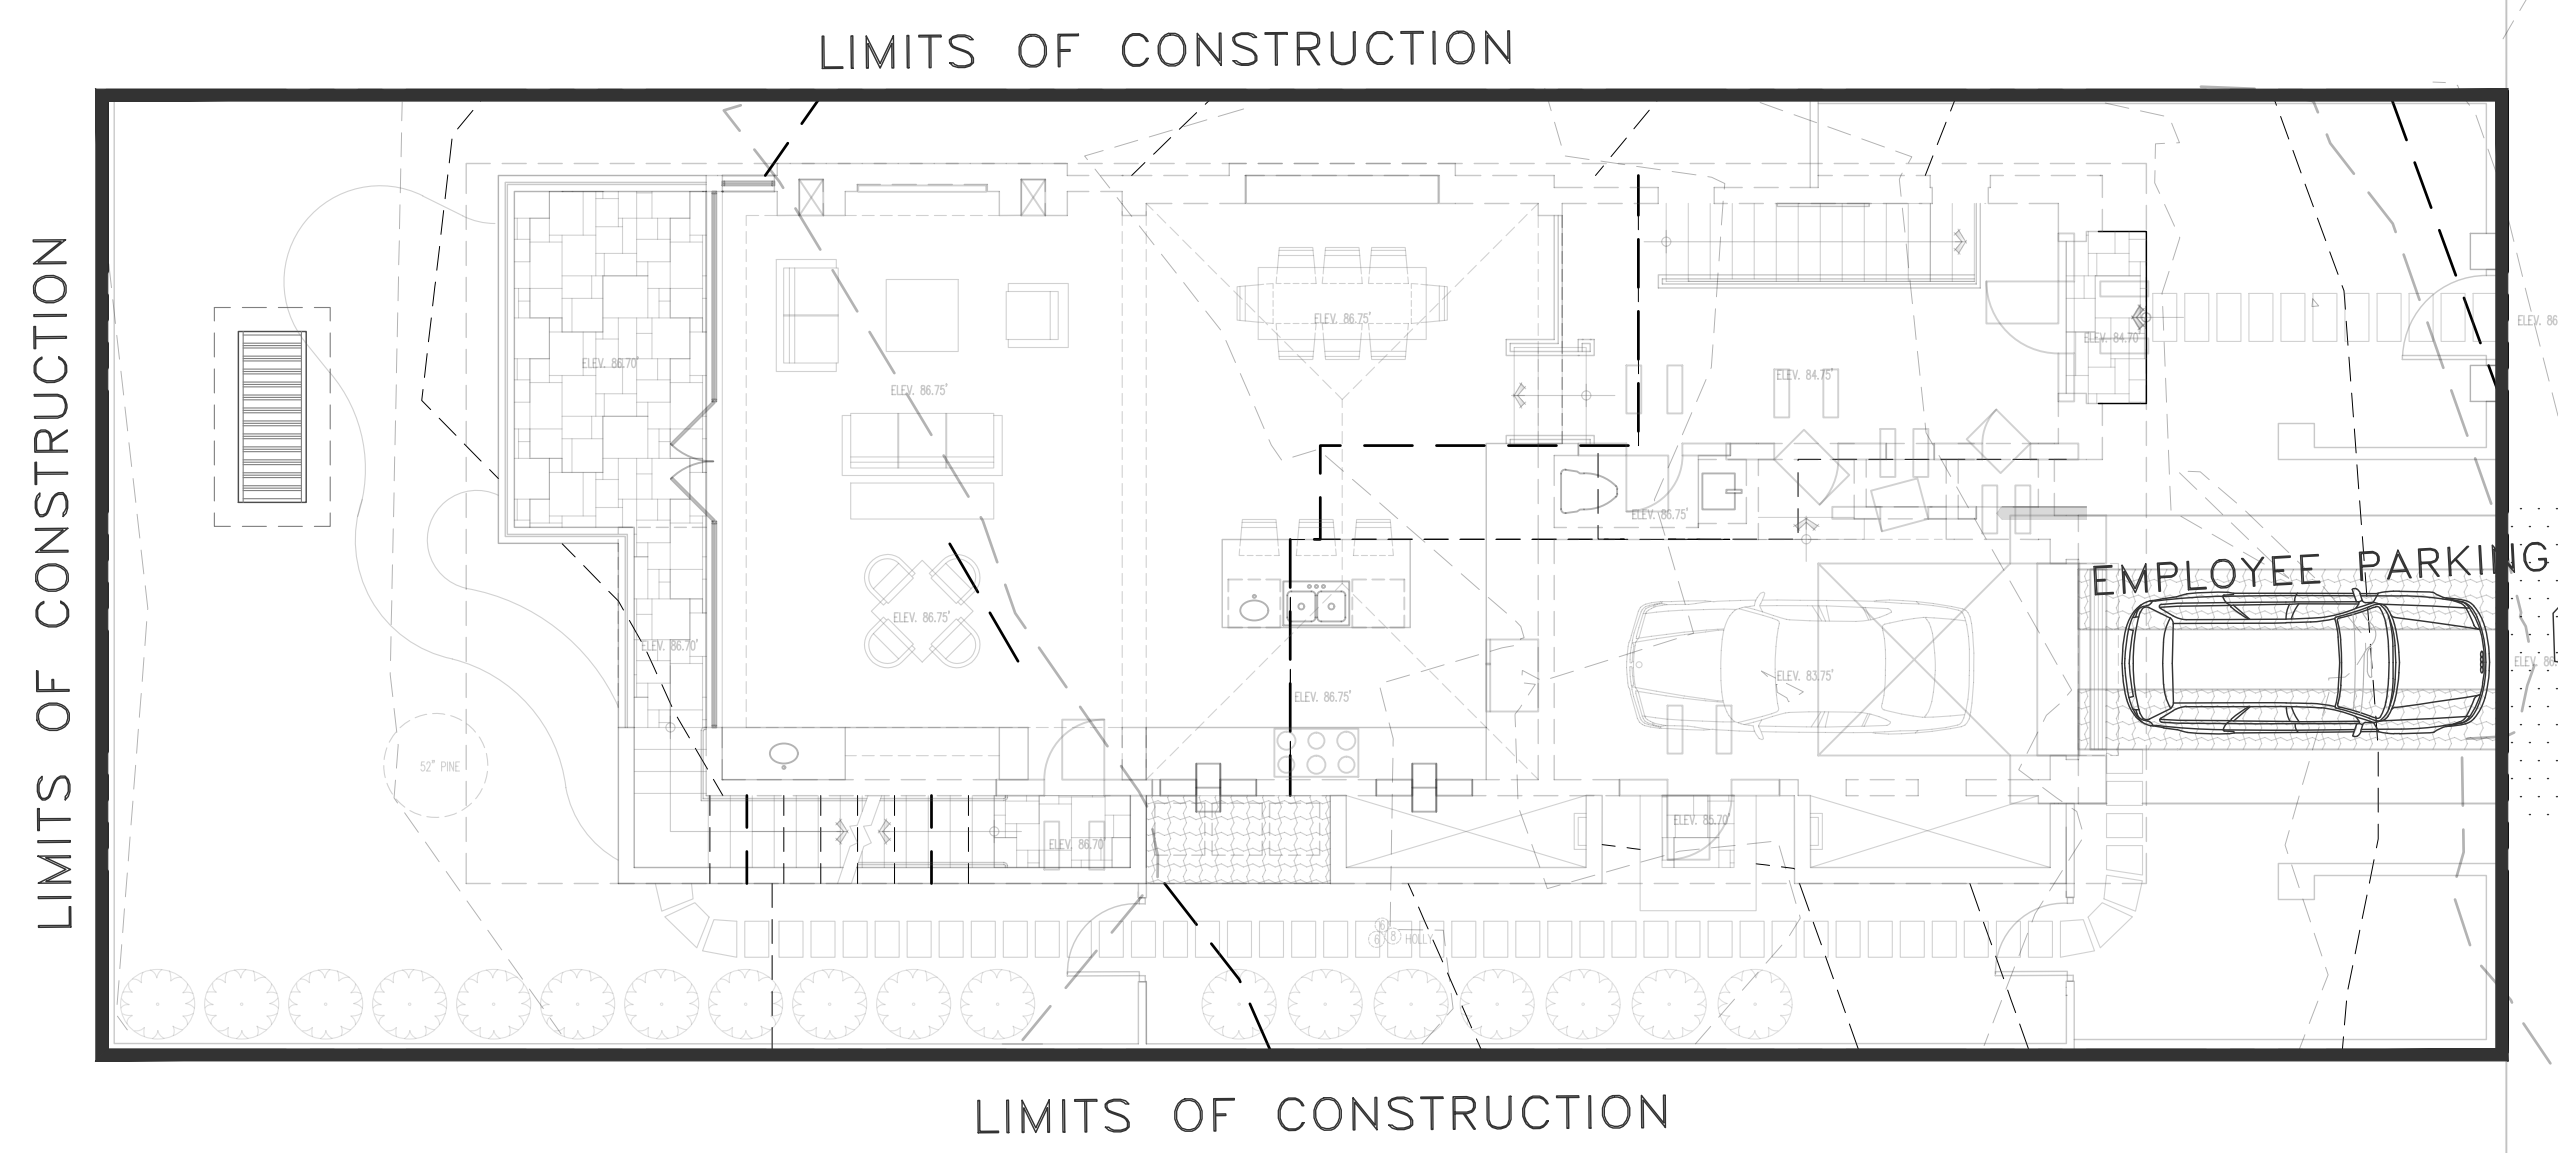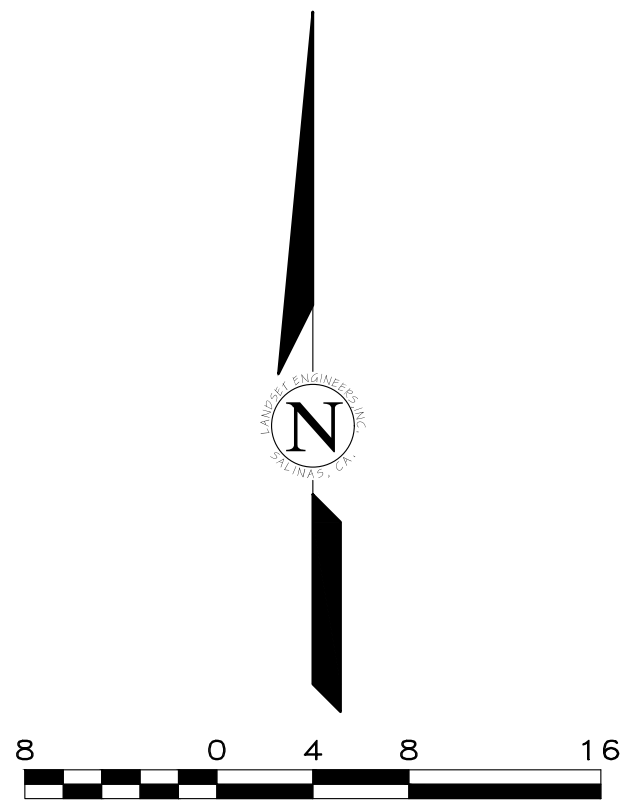

(B) NEIGHBORHOOD TRUCK ROUTING PLAN

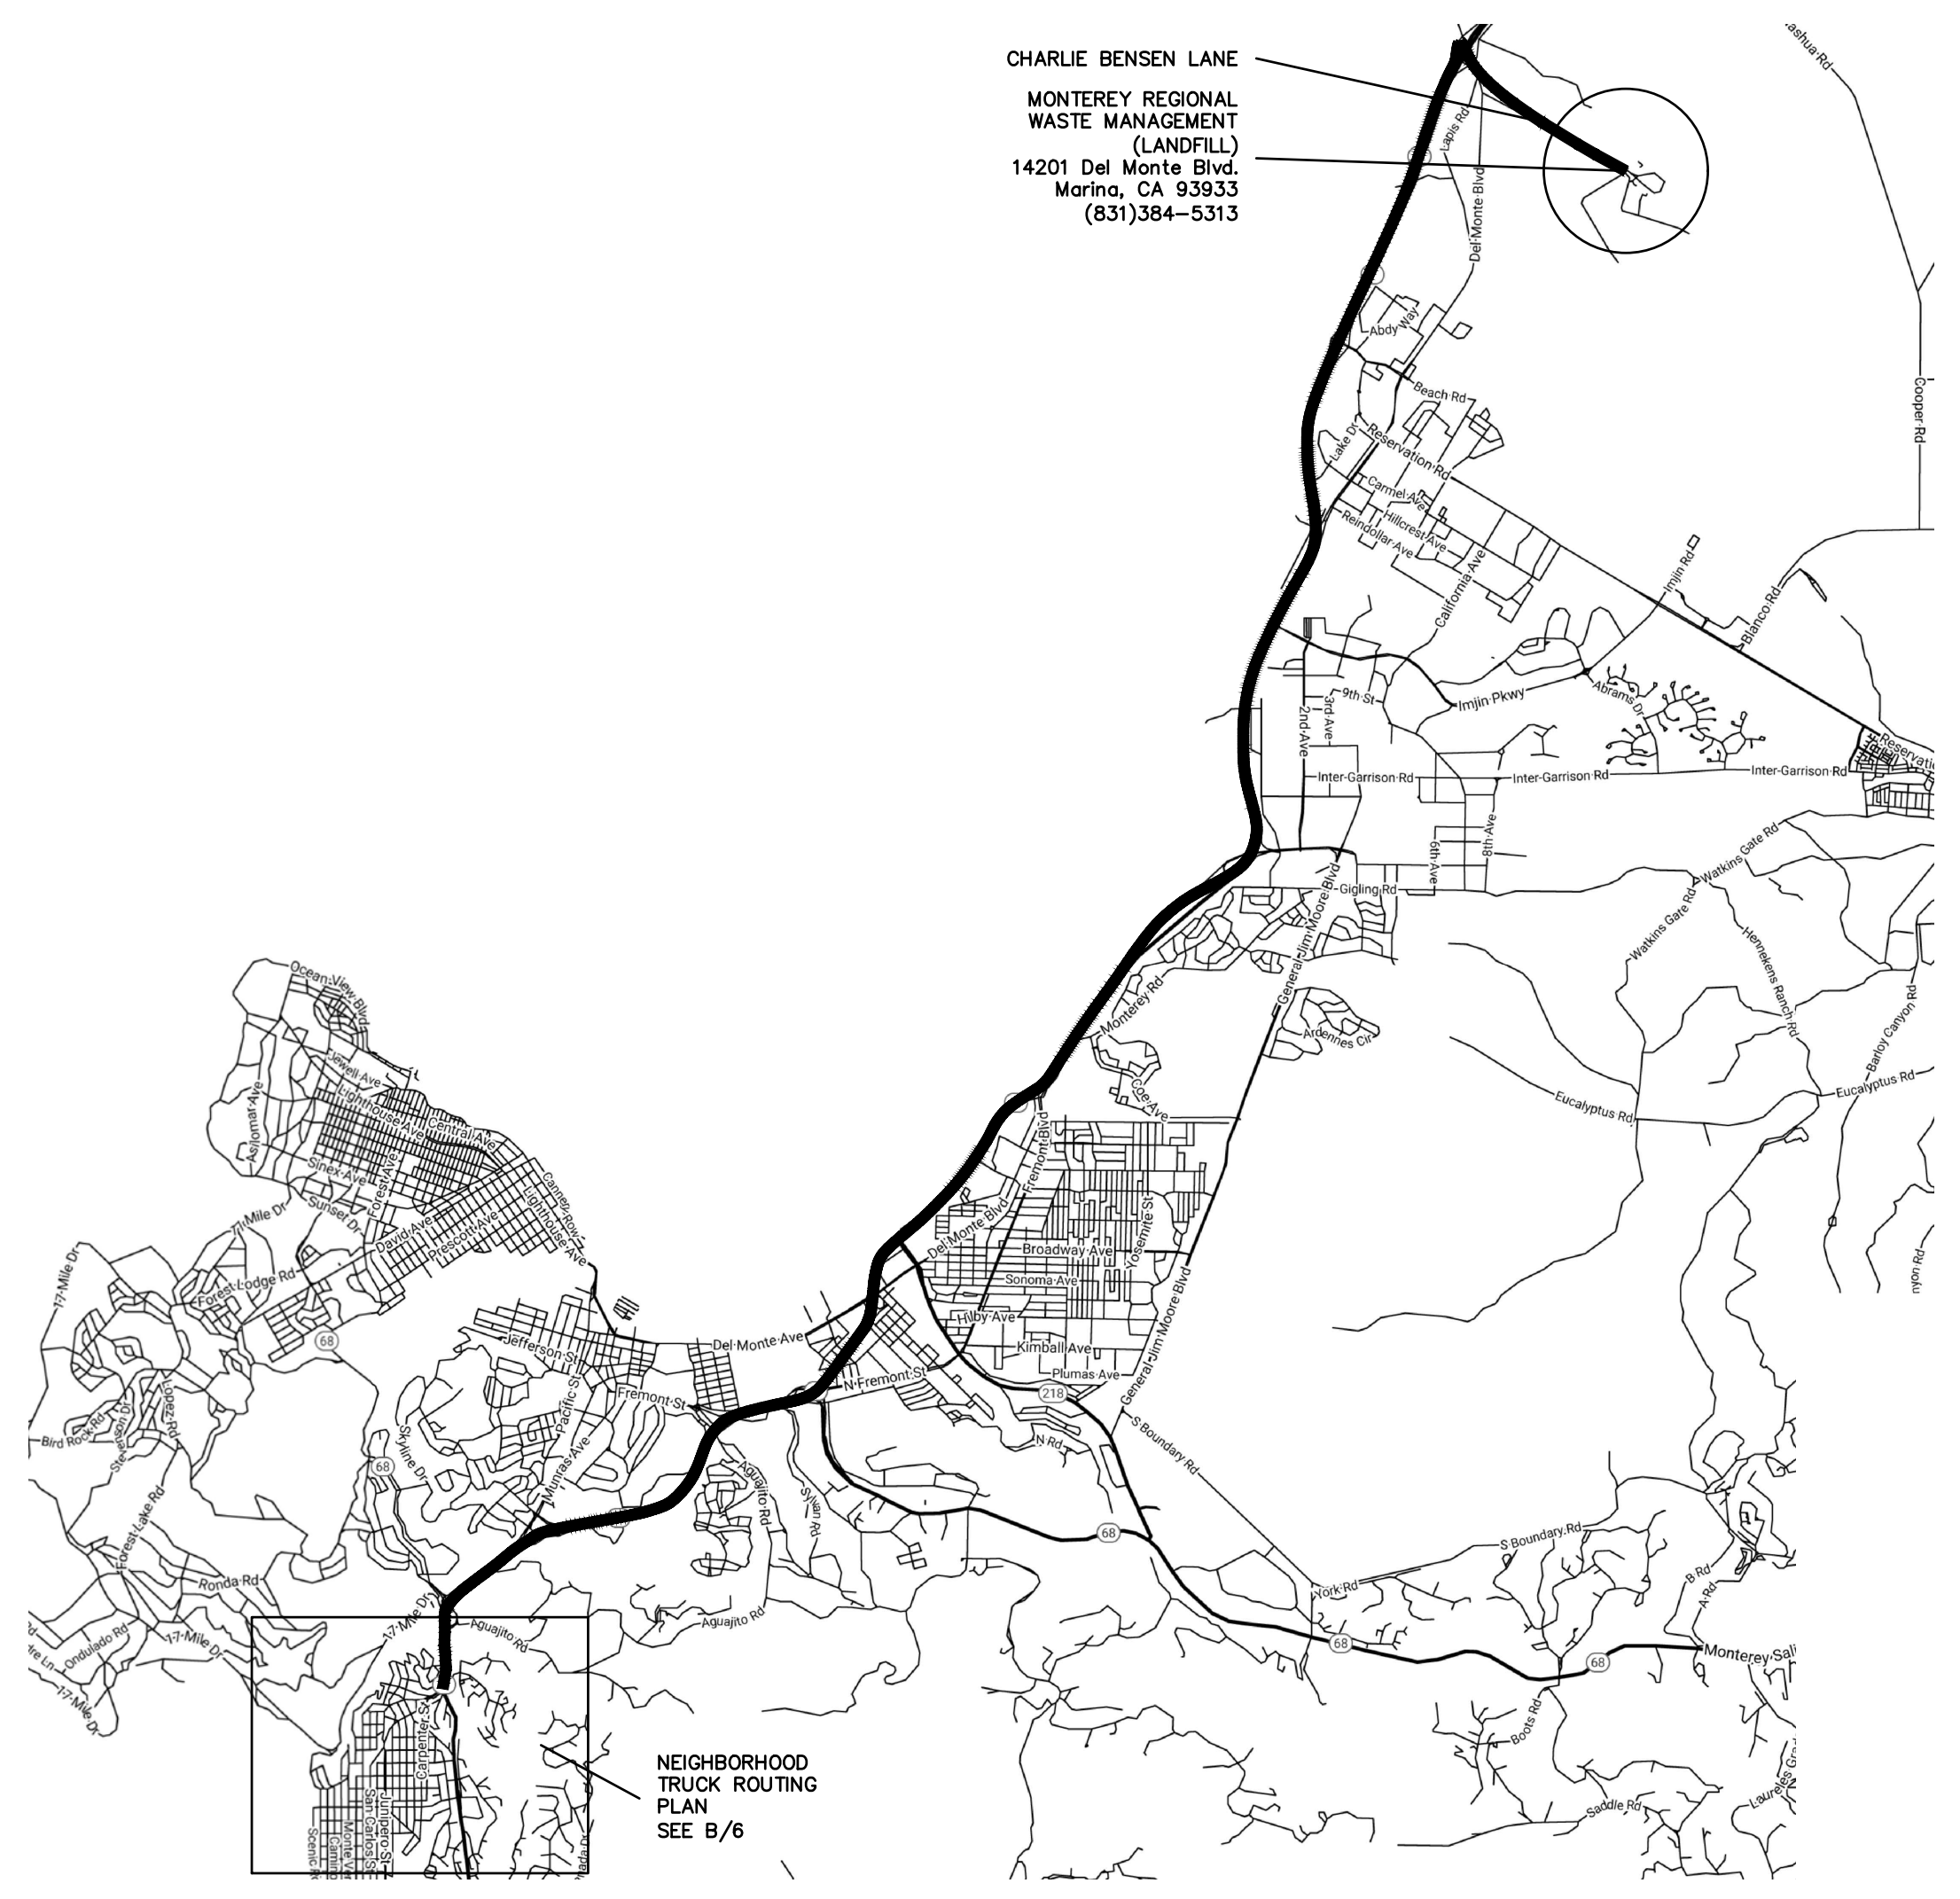

(C) OVERALL TRUCK ROUTING PLAN
NOT TO SCALE

SITE GRADING:
THE PROPOSED GRADING INCLUDES APPROXIMATELY 415 CY OF CUT & 25 CY OF FILL.

- CONSTRUCTION STAGING:**
- A. MOBILIZE, CLEAR AND GRUB
 - B. SITE GRADING
 - C. UTILITY INSTALLATION
 - D. CONSTRUCT STRUCTURE
 - E. INSTALL PAVERS AND LANDSCAPING
 - F. SITE CLEANING, PUNCH LIST

MATERIAL DELIVERIES SHALL BE SCHEDULED SUCH THAT THEY ARE USED PROMPTLY, AND MATERIAL STORAGE IS MINIMIZED. ALL CONSTRUCTION EQUIPMENT AND MATERIALS SHALL BE STORED IN A DESIGNATED AREA ON THE SUBJECT PROPERTY. SEE ARCHITECTURAL AND CIVIL PLANS FOR EROSION CONTROL AND DEMOLITION NOTES.

HAUL ROUTES:
HAUL TRUCKS SHALL BACK INTO THE SITE FROM CARMELO STREET. HAUL TRUCKS WILL EXIT THE SITE, TURNING NORTH ONTO CARMELO STREET AND THEN EAST ONTO OCEAN AVENUE. FROM THERE, THE HAUL TRUCKS WILL TURN NORTH ONTO CALIFORNIA HIGHWAY 1. (REFERENCE NEIGHBORHOOD TRUCK ROUTING PLAN, DETAIL B, THIS SHEET). FLAGGERS SHALL BE STATIONED ON CARMELO STREET AS TRUCKS BACK FROM THE PUBLIC RIGHT OF WAY ONTO THE SITE. CONTRACTOR TO ENSURE THAT HEIGHT RESTRICTIONS WITHIN THE EASEMENT/DRIVEWAY AREA SHALL BE ADDRESSED BEFORE CONSTRUCTION VEHICLES ENTER THE SITE. SEE DETAILS B AND D, TRUCK ROUTING PLANS.

TRUCK STAGING AREA:
VEHICLES OR TRUCKS SHALL NOT QUEUE ON CARMELO STREET. TRUCKS SHALL QUEUE ON RIO ROAD (SEE DETAIL B, THIS SHEET), AND WILL BE DIRECTED TO APPROACH THE SITE BY ONSITE PERSONNEL VIA RADIO OR PHONE.

EMPLOYEE PARKING:
EMPLOYEES SHALL PARK ON-SITE WHENEVER POSSIBLE. EMPLOYEES SHALL USE PUBLIC PARKING ALONG CARMELO STREET AS NECESSARY. OBEYING ALL PARKING LAWS. EMPLOYEES SHALL CARPOOL WHENEVER POSSIBLE. SEE DETAIL C. PARKING IS PROHIBITED IN ALL NATURAL AREAS WHICH ARE NOT CURRENTLY PAVED OR GRAVEL.

LIMITS OF CONSTRUCTION: ALL CONSTRUCTION SHALL TAKE PLACE WITHIN THE BORDER AS SHOWN. EXISTING CYPRESS, PINE, AND OAK TREES LOCATED WITHIN THE LIMITS SHOWN SHALL BE SURROUNDED BY ORANGE PROTECTIVE FENCING (SEE DETAIL).

NUMBER OF EMPLOYEES ONSITE PER DAY: APPROXIMATELY 5-10

NUMBER OF TRUCK TRIPS/DAY: 8

AMOUNT OF GRADING/DAY: 100 C.Y.

HOURS OF OPERATION/DAY: WORK SHALL OCCUR MONDAY THROUGH FRIDAY. HOURS OF OPERATION SHALL BE 7AM TO 5PM. NO WORK SHALL OCCUR ON SATURDAYS OR SUNDAYS.

PROJECT SCHEDULING: PROJECTED START DATE IS 1 FEBRUARY 2019. TOTAL PROJECT DURATION IS APPROXIMATELY 12 MONTHS.

PLAN
SCALE: 1"=8'

TRUCK TRIP GENERATION CHART:


| CATEGORY | NO. OF TRUCK TRIPS | TOTAL DAYS |
|---------------------------------|--------------------|------------|
| DEMOLITION | 10 | 3 |
| GRADING & SOIL REMOVAL (EXPORT) | 33 | 6 |
| ENGINEERING MATERIALS (IMPORT) | 0 | 2 |
| TOTALS | 43 | 11 |

TRUCK TRIP GENERATION NOTES:

1. TRUCK TRIPS FOR THE GRADING/SOIL IMPORT IS BASED UPON 12 CUBIC YARDS PER TRUCKLOAD WITH AN AVERAGE OF 8 TRUCK LOADS PER DAY.
2. THERE ARE APPROXIMATELY 390 CUBIC YARDS OF SOIL MATERIAL TO BE EXPORTED FROM THE SITE.
3. GRADING OPERATIONS SHALL TAKE APPROXIMATELY 8 WORKING DAYS TO COMPLETE.
3. THE AMOUNT OF GRADING PER DAY WILL VARY, THE AVERAGE BETWEEN 80 & 100 CUBIC YARDS.

HOURS OF OPERATION/DAY: 8
DAYS OF OPERATION: MONDAY THRU FRIDAY
TIME OF OPERATION: 8:00 A.M. - 4:30 P.M.

PROJECT SCHEDULING: PROJECTED START DATE IS 1 FEBRUARY 2019. TOTAL PROJECT DURATION IS APPROXIMATELY 12 MONTHS.

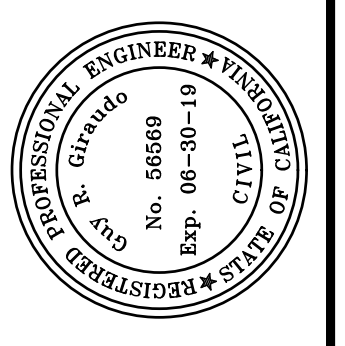

APPROVED BY:
Guy R. Girardo
GUY R. GIRARDO
06/19





"CONSTRUCTION MANAGEMENT PLAN"
GRADING, DRAINAGE & EROSION CONTROL PLAN
OF
LOT 15, BLOCK "U", AS SHOWN IN VOLUME 1
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CARMEL-BY-THE-SEA, MONTEREY COUNTY, CALIFORNIA
MR AND MRS. DYLAN & NATASHA WITT

SCALE: AS SHOWN
DATE: JUN 2019
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| No. | DATE | BY | REVISION |
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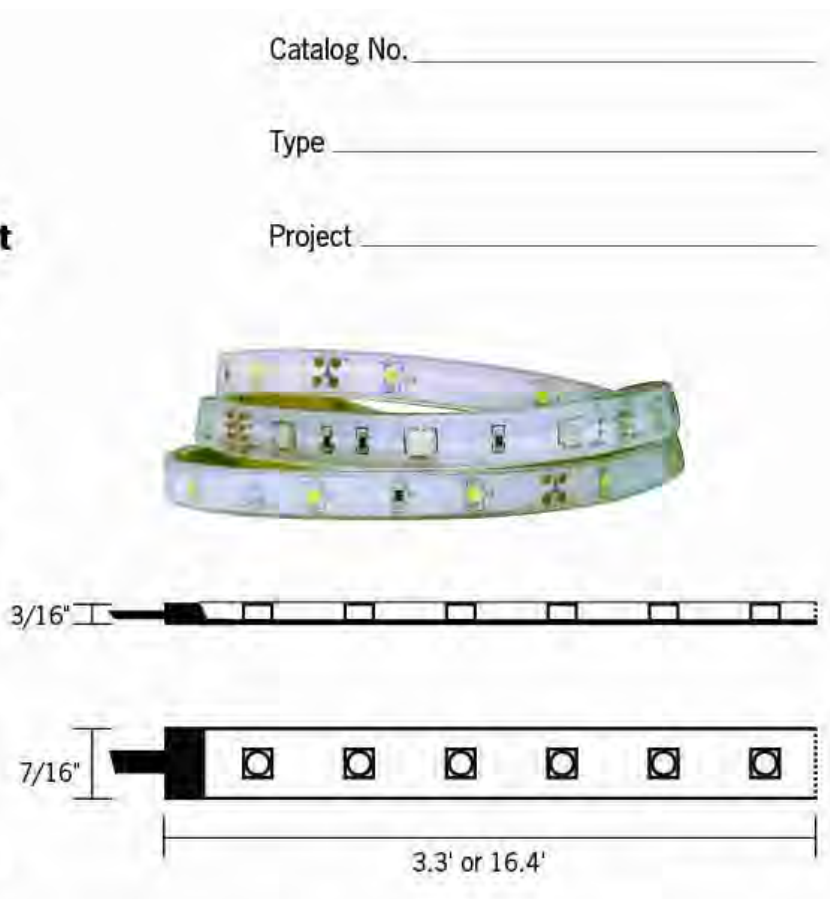
SHEET **C7**
OF 7 SHEETS

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CONTECH LIGHTING a LEVITON company
TLTO Tapelight Series
 12VDC Wet Location High Output Outdoor Tapelight Kit

Specifications/Features
Tape Light Kit
 Flexible, low voltage, wet location, linear LED accent lighting system provides energy-efficient illumination for outdoor applications including coves, architectural enhancements, outdoor steps or changes in elevation, etc.
 Kits consist of (1) 3.3' or 16.4' reel, (1) tube silicone sealant, (2) endcaps, (10) clear acrylic mounting clips with (20) screws.
 1.8W/9 LEDs/109 lumens per foot of tapelight (delivered lumens based on 1ft. of warm white tapelight).
 Available in three color temperatures: Warm White (2700K), Neutral White (4000K), Cool White (5000K), as well as single colors: blue, green, red, and amber.
 Cutoff every 4" or (3) LEDs, at cut lines only. **One cut per reel only.** Once cut, use enclosed silicone sealant and end cap to create a water-tight seal.
Cutting the tape terminates conductivity of the tape on the non-powered end.
 5' input power connector with water tight plug is attached to the tape and connects into the wet rated, plug-and-play power supply or 2-way splitter. For applications requiring lengths longer than 5', the connector can be field modified. Must use appropriate components that comply with local codes (weather-proof connectors, cord covers, enclosures, etc. if outdoors).
 36W and 60W plug-and-play power supplies are available, as well as a 2-way power lead splitter. Power supply and splitter sold separately.
 14° - 140°F Operating temperature.

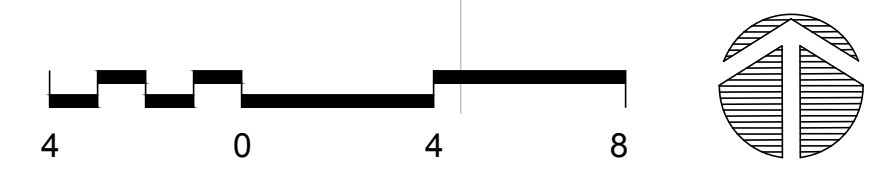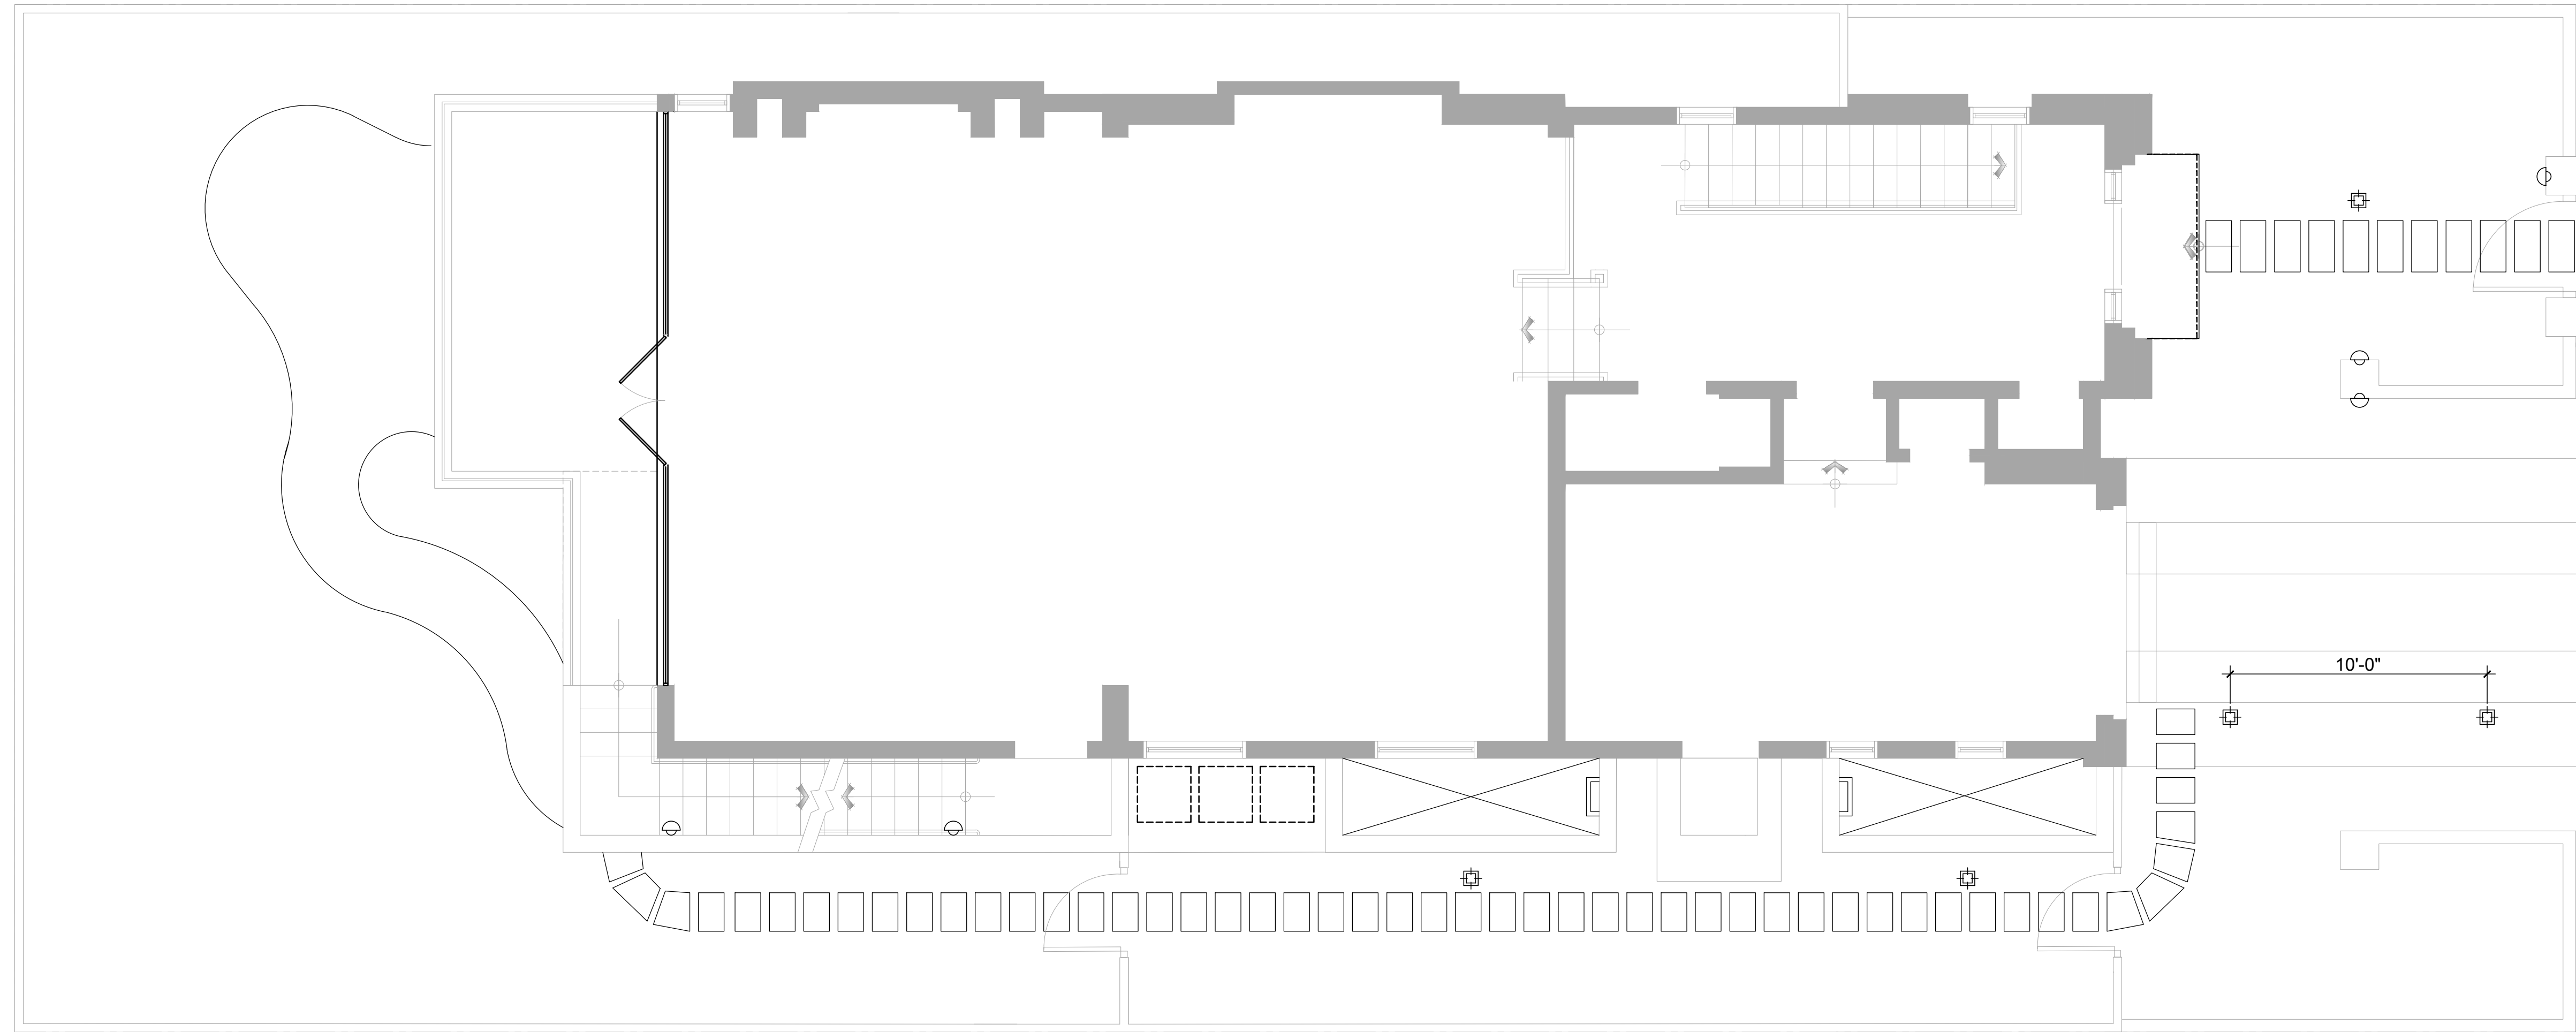

TLTO12V2 Series High Output Outdoor Tapelight Driver Sizing
 Watts per foot: 1.8W/ft.; Max Run: 16.4 ft.

| Model No. | Type | Input Voltage | Wattage | Max Load |
|------------|---------|---------------|---------|-----------|
| TLPO12VP36 | Plug-In | 12V DC | 36W | 20 ft.* |
| TLPO12VP60 | Plug-In | 12V DC | 60W | 32.8 ft.* |

*If the max load exceeds the max run length, multiple runs from power supply may be employed as long as maximum load run is not exceeded.

Dimming
 TLTO Series tapelight is dimmable utilizing our 0-10V or wall plate TL dimming modules. To hardwire tapelight, the input power connector and wires will need to be cut/stripped and connected to a hardware power supply and should be placed in a weather-proof, code approved enclosure supplied by others.


Mounting
 The TLTO tapelight can be mounted using the self-stick adhesive backing, the enclosed acrylic mounting clips with screws, or the tape can be adhered to the aluminum mounting channels and installed with the appropriate mounting clips. Channels and channel mounting clips sold separately.

Warranty
 This product is covered by ConTech's full three (3) year replacement guarantee after date of purchase.

Listing
 ETL listed
 IP65
 Suitable for wet locations. Not submersible.

MD-S SURFACE MOUNT MINI DRIVESTAR™

"I love this fixture because it is a great, inconspicuous light for garden pathways. Ron (the boss) hates using bollards in our landscape designs... they are far too commercial and distracting. The Mini DriveStar™ lights the pathway while letting the plants shine."
 Kimberly Stuart, Ron Rule Consultants Ltd., BKU Fall 2011

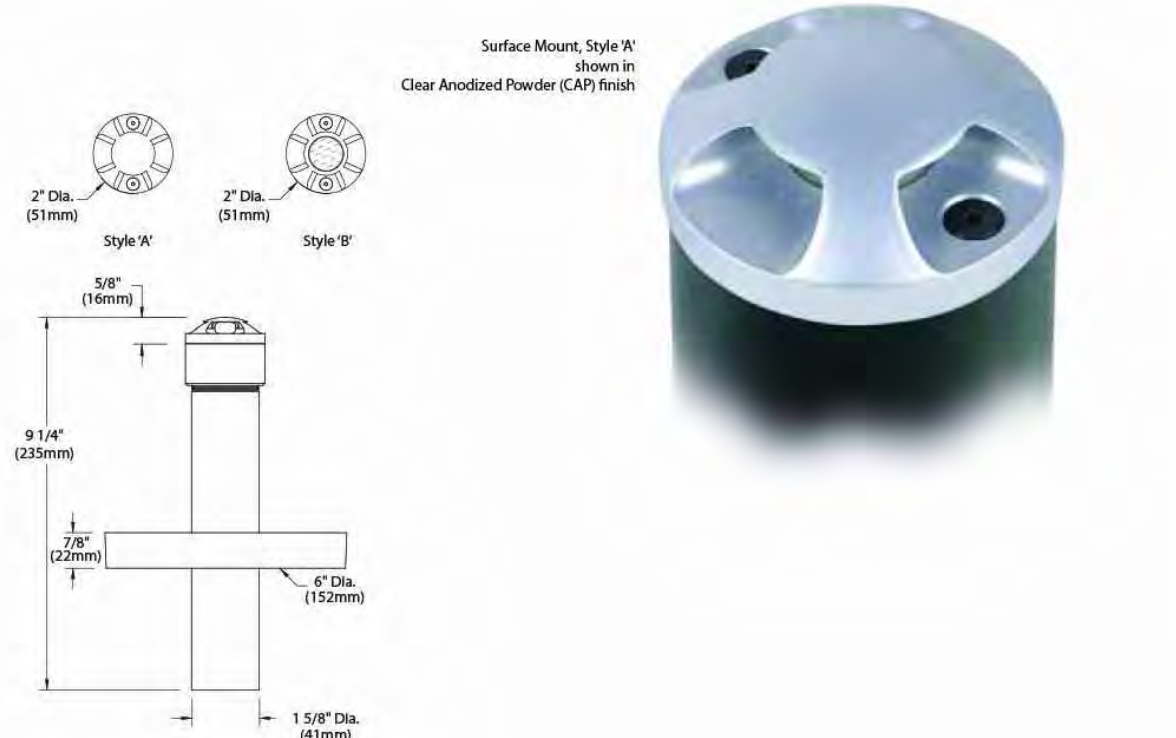

FXLuminaire.
 LED Wall Lights



PO: Wall Lights

| | |
|--|----------------|
| NUMBER OF LEDs: | 1 |
| HALOGEN LUMEN OUTPUT EQUIVALENT: | 10 Watt |
| USEFUL LED LIFE (L70): | 50,000 hrs avg |
| INPUT VOLTAGE: | 10 to 15V |
| VA TOTAL: (Use this number to size the transformer): | 2.4 |
| WATTS USED: | 2.0 |
| LUMENS PER WATT (EFFICIENCY) (based on PO-ST): | 20 |
| MAX LUMENS: (based on PO-ST): | 39 |
| CCT (Ra) (based on PO-ST): | 80.2 |

FIXTURE LEGEND

| SYM | FIXTURE TYPE | NUMBER | WATTAGE/ LUMINAIRE TYPE / NOTES |
|------|--------------------------------|--|--|
| ---- | Exterior Dimmable Linear Light | TLTO-12V-2-WW-16CR | 1.8W / ft LED. Fasten to TLACS6 with wet listed tape light mounting clip |
| ⊕ | In-grade Fixture | BK Mini Drivestar MD-LED-e72-F-MIT-1-A | 3W LED |
| ⊖ | Wall Light | FX-PO | 2.7K LED |

GENERAL NOTES

- System shown schematically for graphic clarity. Verify all light locations and cable runs in field with Landscape Architect. Cabling to be sized to provide a minimum 10.5 volts and a maximum of 11.5 volts to all fixtures. Minimum cable size is 12 gauge multi strand direct burial cable.
- Allow 30% of transformer capacity for future additional site lighting.
- Coordinate switching zones for site lighting with Owner.
- Run additional 2" sleeves under all paving areas for possible future site lighting-Review locations in field with Landscape Architect
- 8" depth minimum cable burial.
- All wire connections shall be water-proofed using fully encapsulated, direct burial waterproof connectors.
- Space lights evenly.
- Transformer locations to be determined.
- Create a single switch run for instances of multiple callouts of the same number.
- See Architectural Drawings for all wall-mounted light fixtures.

| REVISION | No. |
|----------|-----|
| | |
| | |
| | |
| | |

CONSULTANT:
bfs
BFS LANDSCAPE ARCHITECTS
 455 PACIFIC STREET #201
 SAN FRANCISCO, CA 94107
 TEL: (415) 398-1888 • BFS@BFS.COM


ARCHITECT
ERIC MILLER ARCHITECTS, INC.
 211 HOFFMAN AVENUE MONTEREY, CA 93940
 PHONE: (831) 372-0410 • FAX: (831) 372-7840 • WEB: www.ericmillerarchitects.com

PROPOSED LIGHTING PLAN
 JOB NAME: **Witt Residence**
 Carmelo 2NW of 9th Street
 Carmel, By-The-Sea, CA
 APN: 010-269-005-000

DATE: 01/14/19
 SCALE: AS SHOWN
 DRAWN: JDL
 JOB NUMBER: 18104

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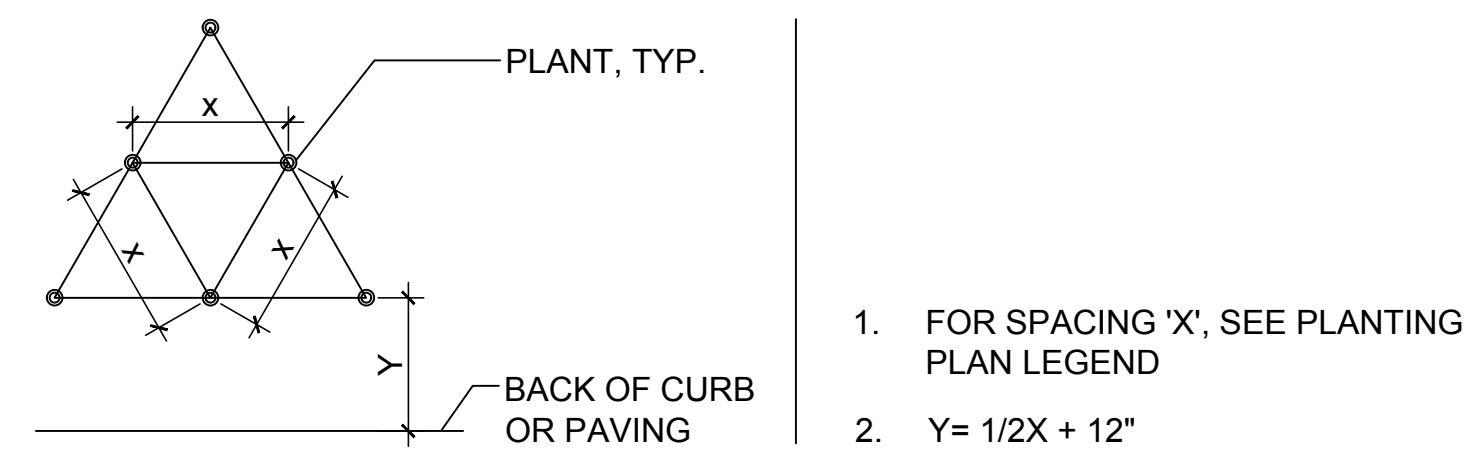


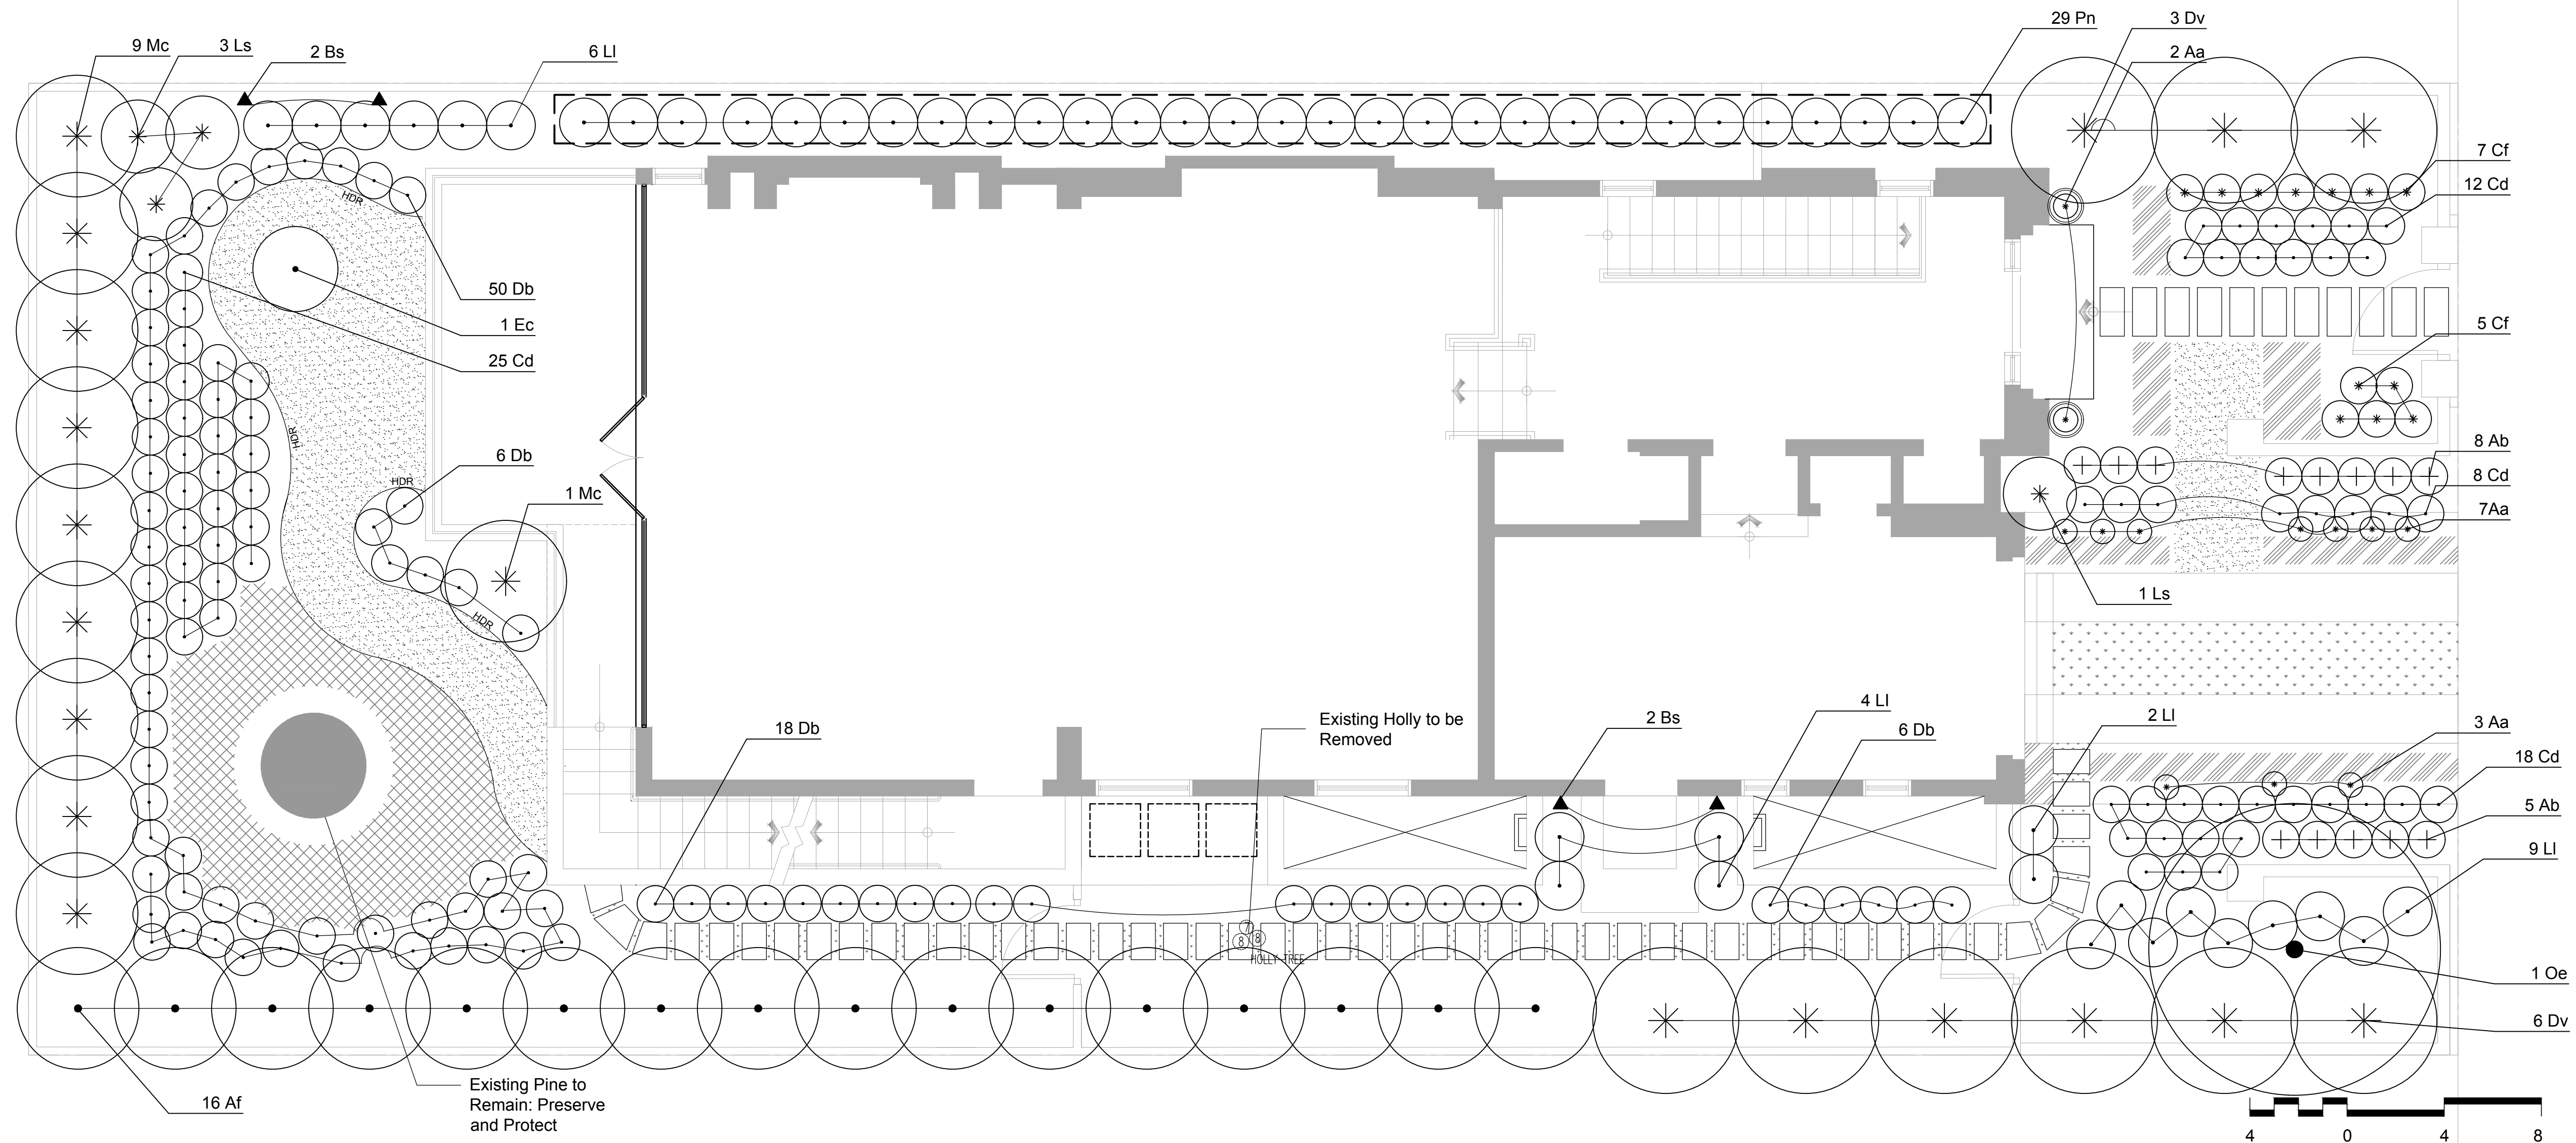

PLANT LEGEND

| *WUC CODE | BOTANICAL NAME | COMMON NAME | SIZE | CHARACTER |
|----------------------------|----------------|---|-----------------------------|-----------------------|
| Trees | | | | |
| M | Af | Afrocarpus gracilior | Fern Pine Tree | 24 Gal. Trim as Hedge |
| M | Oe | Olea europaea 'Wilsonii' | Fruitless Olive Tree | 15 Gal |
| Shrubs / Perennials | | | | |
| L | Aa | Agave attenuata 'Nova' | Foxtail Agave | 5 Gal. |
| L | Ab | Anigozanthos 'Big Red' | Big Red Kangaroo Paw | 5 Gal. |
| M | Db | Dianella 'BlueTopia' | Blue Flax Lily | 1 Gal. |
| L | Dv | Dodonaea viscosa | Hopbush | 5 Gal |
| L | Ec | Echium candicans | Pride of Madeira | 5 Gal. |
| L | Ls | Leucadendron 'Safari Sunset' | Conebush | 5 Gal. |
| L | LI | Lomandra longifolia 'Breeze' | Mat Rush | 1 Gal. |
| M | Mc | Myrica californica | Pacific Wax Myrtle | 15 Gal. |
| L | Pn | Phyllostachys nuda | Hedge Bamboo | 5 Gal. |
| Groundcovers | | | | |
| M | | Galium odoratum | Sweet Woodruff | 4" Pot 6" O.C. |
| L | | Echeveria secunda, Euphorbia tirucalli 'Sticks on Fire', Senecio mandraliscae | Succulent Mix | 1 Gal. 8" O.C. |
| L | | Thymus praecox 'Album' | White Mother-of-Thyme | Flat Plants touching |
| Grasses | | | | |
| M | Cf | Calamagrostis foliosa | Mendocino Reed Grass | 1 Gal. |
| M | Cd | Carex divulsa | Berkeley Sedge | 1 Gal. |
| Vines | | | | |
| L | Bs | Bougainvillea 'San Diego Red' | San Diego Red Bougainvillea | 5 Gal. |
| Other | | | | |
| | | Decomposed Granite (D.G.): California Gold - 3/8". Install with continuous metal edging on both sides. | | |
| | HDR | Headerboard: 1x6 Redwood Headerboard | | |
| | | Bamboo Root Barrier: 30" x 60 mil polypropylene rhizome barrier as available from the Bamboo Sourcing, Sebastopol, CA (707)823-5866, bamboosourcing.com. Plastic two-sided sealing tape as supplied the manufacturer. | | |

GROUNDCOVER SPACING AND PLANTING SETBACK DIAGRAM



*** WATER USE CATEGORY (WUC) KEY**

WUCOLS Region Applicable to this Project: REGION 1
 H = High; M = Moderate; L = Low; VL = Very Low; NL = Species Not Listed
 * from: Water Use Classification of Landscape Species, A Guide to the Water Needs of Landscape Plants (WUCOLS) Revised 2014, University of California Cooperative Extension, L.R. Costello, K.S. Jones

GENERAL NOTES

- Landscape Architect to approve plant material and layout BEFORE planting commences.
- Apply pre-emergent herbicide to all planting areas.
- Prepare, amend, and fertilize existing soil. Pre-mix amendments into soil before backfilling plant pits - do not mix inside pits. Break large clods into small pieces. Contractor is responsible for preparing the soil analysis and that the recommendations of the report are followed during soil preparation and planting.
- Soil Amendments:
 - A. Nitrogen Stabilized Organic Amendment: shall be mineralized and nitrogen stabilized bark or sawdust humus, with wetting agent and properly pulverized and shall have a minimum of 270 lbs. per cubic yard of amendment. Submit sample analysis for approval.
 - B. Gypsum: Agricultural Grade. Cal-Sul Pelletized Gypsum by North Pacific, Portland OR, or approved
 - C. Sulfur: granular degradable sulfur product, Tiger Organic 0-0-0-90 Sulfur by TigerSul.com, or approved equal.
- Plant shrubs per spacing detail.
- Mulch: Install a minimum of 3" of mulch at all planting areas. Mulch shall be recycled wood decorative mulch with biodegradable coloring. Pre-approved suppliers- Recology, Stockton CA; Republic Services, Milpitas CA (formerly BFI); CCL Organics, Benicia, CA; Z-Best Products, Gilroy CA. Mulch color shall be dark brown. Stabilized mulch and jute netting to be used on slopes 3:1 and greater.
- Compost: Compost min of 4 cubic yards per 1,000 sq. ft. of permeable area to a depth of 6".
- All new plants to be irrigated. Irrigation system to be point-source drip system, compliant with current MWEL standards.

MAWA / ETWU

WATER EFFICIENT LANDSCAPE WORKSHEET

Project Name: Witt Residence Status: Planning Calc By: JDL
 Project Number: 18.104 Date: 1/9/2019

Reference Evapotranspiration (Eto): 33.00

| Hydrozone #/Planting Description* | Plant Factor (PF) | Irrigation Method ^b s or d | Irrigation Efficiency (IE) ^c | ETAF (PF/IE) | Landscape Area (sq ft) | ETAF x Area | Estimated Total Water Use (ETWU) ^d |
|---|-------------------|---------------------------------------|---|--------------|------------------------|-------------|---|
| Regular Landscape Areas | | | | | | | |
| 1 Front Garden N | 0.5 | d | 0.81 | 0.62 | 103 | 63.58 | 1300.85 |
| 2 Front Garden S | 0.3 | d | 0.81 | 0.37 | 238 | 88.15 | 1803.51 |
| 3 Side Garden S | 0.4 | d | 0.81 | 0.49 | 116 | 57.28 | 1172.03 |
| 4 Back Garden S | 0.5 | d | 0.81 | 0.62 | 711 | 438.89 | 8979.67 |
| 5 Side Garden N | 0.2 | d | 0.81 | 0.25 | 118 | 29.14 | 596.12 |
| Totals (A) | | | | | 1286 (B) | 677.04 | 13852.18 |
| Special Landscape Areas | | | | | | | |
| 7 | | | | 1.00 | 0 | 0.00 | 0.00 |
| 8 | | | | 1.00 | 0 | 0.00 | 0.00 |
| Totals (C) | | | | | 0 (D) | 0.00 | 0.00 |
| ETWU Total (Gallons) | | | | | | 13852.18 | |
| Maximum Allowed Water Allowance (MAWA)* (Gallons) | | | | | | 14471.36 | |
| ETWU (Acre Feet) | | | | | | 0.043 | |
| MAWA (Acre Feet) | | | | | | 0.044 | |

*MAWA (Annual Gallons Allowed) = (Eto) (0.62) [(ETAF x LA) + ((1-ETAF) x SLA)] where 0.62 is a conversion factor that converts acre-inches per acre per year to gallons per square foot per year, LA is the total landscape area in square feet, SLA is the total special landscape area in square foot, and ETAF is .55 for residential areas and 0.45 for non-residential areas.

MWEL COMPLIANCE STATEMENT

I have complied with the criteria of the ordinance and applied them accordingly for the efficient use of water in the planting design plan.


Signed: *Simon Phillips* Name: Simon Phillips 4532 01-07-2019
 Date: Name: CLA# Date

| REVISION | No. |
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ARCHITECT



PROPOSED PLANTING PLAN

JOB NAME: Witt Residence
 Carmelo 2NW of 9th Street
 Carmel, By-The-Sea, CA
 APN: 010-269-005-000

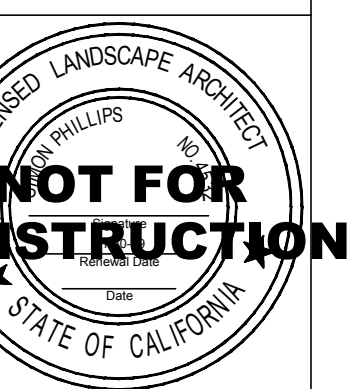DATE: 01/14/19
 SCALE: AS SHOWN
 DRAWN: JDL
 JOB NUMBER: 18104

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Agave attenuata 'Nova'



Anigozanthos 'Big Red'



Afrocarpus gracilior



Dodonaea viscosa



Dianella 'BlueTopia'



Echium candicans



Echeveria secunda



Euphorbia tirucalli 'Sticks on Fire'



Leucodendron 'Safari Sunset'



Lomandra longifolia 'Breeze'



Myrica californica



Olea europaea 'Wilsonii'



Phyllostachys nuda



Galium odoratum



Senecio mandraliscae



Thymus praecox 'Album'



Calamagrostis foliosa



Carex divulsa



Bougainvillea 'San Diego Red'

| REVISION | No. |
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| | |
| | |

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PROPOSED PLANT IMAGES

JOB NAME: Witt Residence
 Carmelo 2NW of 9th Street
 Carmel, By-The-Sea, CA
 APN: 010-269-005-000

| | |
|-------------|----------|
| DATE: | 01/14/19 |
| SCALE: | AS SHOWN |
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| JOB NUMBER: | 18104 |

NOT FOR CONSTRUCTION